



A. PARKING SPACE IS 9' - 0" WIDE AT NARROWEST POINT, TYPICAL. B. 15' - 0" DEEP COMPACT PARKING SPACE, TYPICAL. C. 20' - 0" DEEP PARKING SPACE, TYPICAL.

D1 ENLARGED COMPACT PARKING PLAN

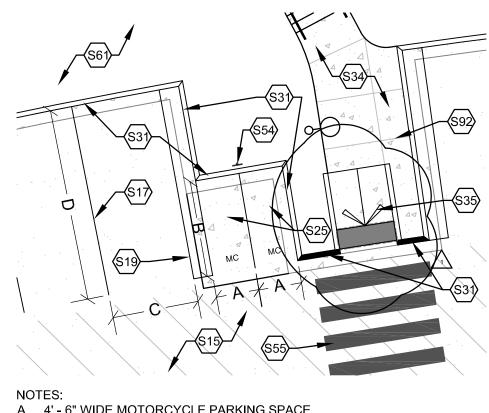

A. 4' - 6" WIDE MOTORCYCLE PARKING SPACE B. 10' - 0" DEEP MOTORCYCLE PARKING SPACE, TYPICAL. C. PARKING SPACE IS 9' - 0" WIDE AT NARROWEST POINT, TYPICAL. D. 20' - 0" DEEP PARKING SPACE, TYPICAL.

ENLARGED MOTORCYCLE PARKING PLAN

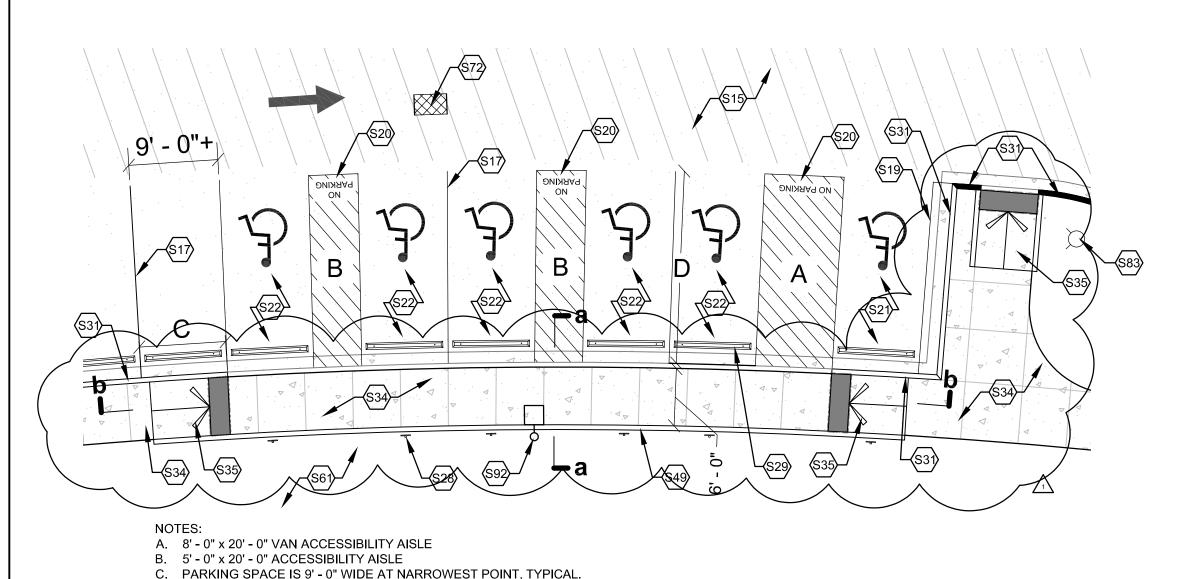


ENLARGED ACCESSIBLE PARKING PLAN

1" = 10' - 0"

D. 20' - 0" DEEP PARKING SPACE, TYPICAL.

E. SECTIONS A-A & B-B, SEE A3/AS-103 (THIS SHEET)

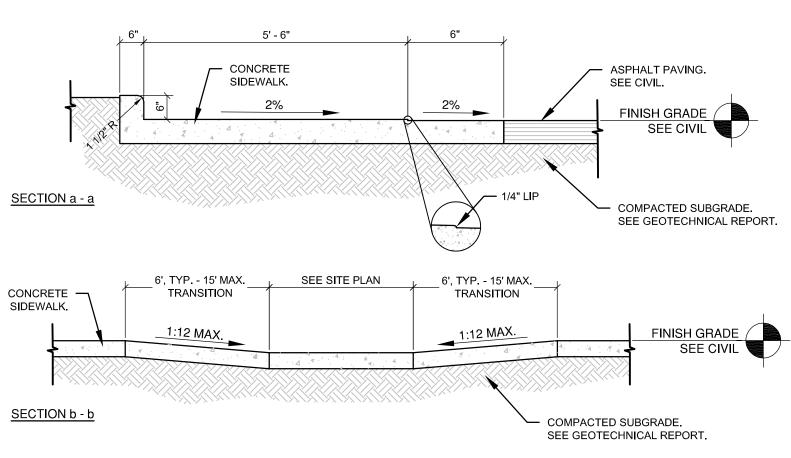

NOTE: 1. AVOID PLACING DRAINAGE STRUCTURES, TRAFFIC SIGNAL EQUIPMENT, JUNCTION BOXES OR OTHER OBSTRUCTIONS IN FRONT OF RAMP ACCESS AREAS. 2. RAMP SLOPES SHALL NOT BE STEEPER THAN 2%. THE TRANSITIONS SHALL HAVE A MAXIMUM SLOPE OF 1:12. 3. DETECTABLE WARNINGS SHALL BE ARMOR-TILE TACTILE SYSTEMS, CAST-IN-PLACE SYSTEMS, BRICK RED OR APPROVED EQUAL. INSTALLATION SHALL BE DONE IN ACCORDANCE WITH MANUFACTURERS RECOMMENDATIONS.

A3 ACCESSIBLE RAMP

#### **KEYED NOTES**

#### S15 ASPHALT PAVING, TYPICAL. S16 CONCRETE ISLAND. S17 PAINTED PARKING LOT 4" WIDE STRIPING, TYPICAL. PAINT SHALL BE TRAFFIC-RATED LATEX PAINT, COLOR: WHITE. S18 PAINTED PARKING LOT 10' - 0" LENGTH ARROWS AND 30" HEIGHT LETTERING, TYPICAL. PAINT SHALL BE TRAFFIC-RATED LATEX PAINT, COLOR: WHITE. S19 2' PAINTED BUFFER AT END OF PARKING AISLE, TYPICAL. ACCESSIBLE PAINTED ACCESS AISLE WITH BLUE DIAGONAL STRIPING AND CAPITALIZED WORDS "NO PARKING", LETTERING SHALL BE 12" HIGH AND 2" WIDE PLACED NEAREST THE DRIVING AISLE WHERE AN ADJACENT VEHICLE'S TIRES WOULD BE PLACED. ACCESSIBLE VAN PARKING SPACE WITH GROUND-MOUNTED SIGN. ACCESSIBLE PARKING SPACE WITH GROUND-MOUNTED SIGN. ACCESSIBLE DROP-OFF. INSTALL TRUNCATED DOME TO DESIGNATE

S24 COMPACT VEHICLE PARKING, TYPICAL. S25 MOTORCYCLE PARKING ON STANDARD-DUTY CONCRETE PAD WITH GROUND-MOUNTED SIGN.

STD. DWG. 2446 FOR DETECTABLE WARNING DEVICE DETAILS.

THRESHOLD BETWEEN CONCRETE SIDEWALK AND ASPHALT DRIVE,

RECESS TO FLUSH WITH SURFACE OF CONCRETE SIDEWALK. SEE COA

S26 (4) EV-READY SPACES. S27 FUTURE OWNER-PROVIDED EV STATIONS, SEE ELECTRICAL FOR REQUIREMENTS.

ACCESSIBILITY, TYPICAL, SIGN SHALL CONTAIN THE REQUIRED LANGUAGE "VIOLATORS ARE SUBJECT TO A FINE AND/OR TOWING" PER 66-7-352.4C NMSA 1978. S29 CONCRETE WHEELSTOP, TYPICAL WHERE GROUND-MOUNTED SIGNAGE AND EV CHARGING EQUIPMENT IS PRESENT, SEE SITE DETAILS.

| S28 | | 12" x 18" GROUND-MOUNTED ADA SIGN WITH INTERNATIONAL SYMBOL OF

CONCRETE CURB & GUTTER SYSTEM, TYPICAL, SEE SITE DETAILS & CIVIL. MOUNTABLE CURB AT PARKING ROW ENDS, TYPICAL. SEE COA STD. DWG. 2415B FOR MOUNTABLE ROLL CURB AND GUTTER DETAIL. S34 4" THICK STANDARD DUTY CONCRETE PAVEMENT WITH TURN DOWN EDGE AT ALL EXPOSED EDGES.

S35 ACCESSIBLE CURB RAMP. SEE COA STD. DWG. 2443 FOR PARALLEL CURB RAMP DETAILS. INSTALL TRUNCATED DOME IN ALL ADA RAMPS, RECESS TO FLUSH WITH SURFACE OF CONCRETE SIDEWALK. SEE COA STD. DWG. 2446 FOR DETECTABLE WARNING DEVICE DETAILS.

S38 | 6" TRAFFIC-RATED BOLLARD. CONCRETE HEADER CURB.

6" CONCRETE APRON 4,000 PSI 3/4" AGGREGATE WITH 6X6-10/10WWM OR EQUAL WITH 1/2" EXPANSION JOINT BETWEEN PAD AND APRON.

S52 | 6" MIN. CONCRETE SLAB 4,000 PSI 3/4" AGGREGATE WITH 6X6-10/10WWM

OR EQUAL, SLOPE TO DRAIN 1/8" PER FOOT. S54 GROUND-MOUNTED MOTORCYCLE PARKING SIGN.

PAINTED ACCESS AISLE, 1' - 6" WIDE x 12' - 0" LONG STRIPING, 3' - 0" O.C., CENTER-ALIGNED TO CENTER OF ACCESSIBLE CURB RAMP, TYPICAL.

PAINT SHALL BE TRAFFIC-RATED LATEX PAINT. COLOR: WHITE.

S61 LANDSCAPING, SEE LANDSCAPE.

S71 BACKFLOW PREVENTER IN HEATED ENCLOSURE, SEE CIVIL.

FIRE HYDRANT, 3' - 0" MINIMUM FROM BACK OF CURB AND EDGE OF SIDEWALK. SEE CIVIL.

#### **GENERAL NOTES**

COMPACTION AT ALL CONCRETE WORK SHALL COMPLY WITH REQUIREMENTS ON CIVIL DRAWINGS AND GEOTECHNICAL REPORT.

EXCEPTIONS.

A. A. SUB GRADE PREPARATION AND SOIL


- B. PROVIDE BROOM FINISH ON CONCRETE SIDEWALK, UNLESS NOTED OTHERWISE.
- C. VERIFY SIDEWALK LAYOUT WITH ARCHITECT PRIOR TO FORMING AND POURING CONCRETE. NO
- D. FOR INFORMATION ON UTILITIES SEE SITE SURVEY SHEET, CIVIL UTILITY PLANS, MECHANICAL.
- PLUMBING AND ELECTRICAL DRAWINGS. E. CONTRACTOR SHALL PAY FOR AND COORDINATE WITH LOCAL UTILITY COMPANIES FOR ALL UTILITY
- DISCONNECT, RECONNECT AND DEMO WORK. F. ALL SITE ELEMENTS INCLUDING BUT NOT LIMITED TO TREES, SHRUBS, GROUND COVER MATERIAL, ETC. THAT MUST BE REMOVED FROM THE SITE IN ORDER TO ACCOMPLISH NEW WORK SHALL BE REMOVED AT NO ADDITIONAL COST TO THE OWNER. CONTRACTOR SHALL VISIT SITE PRIOR TO BIDDING TO BECOME FAMILIAR WITH SITE FEATURES TO BE DEMOLISHED.
- G. CONTRACTOR SHALL BE RESPONSIBLE FOR SECURING AND PAYING FOR PERMIT FEES ASSOCIATED WITH ENVIRONMENTAL PROTECTION AGENCY AND REQUIREMENTS OF STORM WATER POLLUTION PREVENTION PLAN (SWPPP) COORDINATE WITH ALL REGULATORY AUTHORITIES
- REGARDING THIS ITEM. H. CONTRACTOR SHALL TAKE NECESSARY PRECAUTIONS TO PROTECT EXISTING SITE FEATURES, PLANTINGS, AND UTILITIES TO REMAIN. ANY DAMAGE TO EXISTING SITE FEATURES, PLANTINGS, AND UTILITIES TO REMAIN DUE TO

CONSTRUCTION OPERATIONS SHALL BE REPAIRED

ALL DOWNSPOUT, LAMBSTOUNGUE, ETC. THAT ROUTE ROOF WATER TO GRADE SHALL BE DISCHARGED IN A CONCRETE RUN DOWN, TRENCH GRATE, OR SPLASH BLOCK. SEE CIVIL. FIELD COORDINATE LOCATION OF DISCHARGE POINTS PRIOR TO FORMING AND INSTALLING CONCRETE. . FURNISH AND INSTALL CURB MARKING PAINT (RED

AT NO ADDITIONAL COST TO THE OWNER.


- FIRE LANE OR YELLOW DROP OFF LANE) ENTIRE LENGTH OF CURB AT BUILDING SIDE OF DROP OFF. COORDINATE WITH FIRE MARSHALL FOR LOCATION OF FIRE LANE MARKINGS.
- K. WHERE NEW CONCRETE PAVEMENT AND/OR CURBING IS SHOWN ADJACENT TO EXISTING, CONTRACTOR SHALL PROVIDE NEW CONCRETE PAVEMENT AND/OR CURBING UP TO AND FLUSH WITH EXISTING. LIMITS SHOWN ARE APPROXIMATE.
- CONTRACTOR SHALL FIELD VERIFY. REFER TO GEOTECHNICAL REPORT FOR ADDITIONAL REQUIREMENTS REGARDING NEW ASPHALT AND
- CONCRETE PAVEMENT. M. CONTRACTOR SHALL FIELD VERIFY ALL DIMENSIONS AND LAYOUT OF BOTH THE SITE AND BUILDING ELEMENTS. COORDINATE FIELD INFORMATION WITH THE ARCHITECT PRIOR TO ANY CONSTRUCTION ACTIVITY.

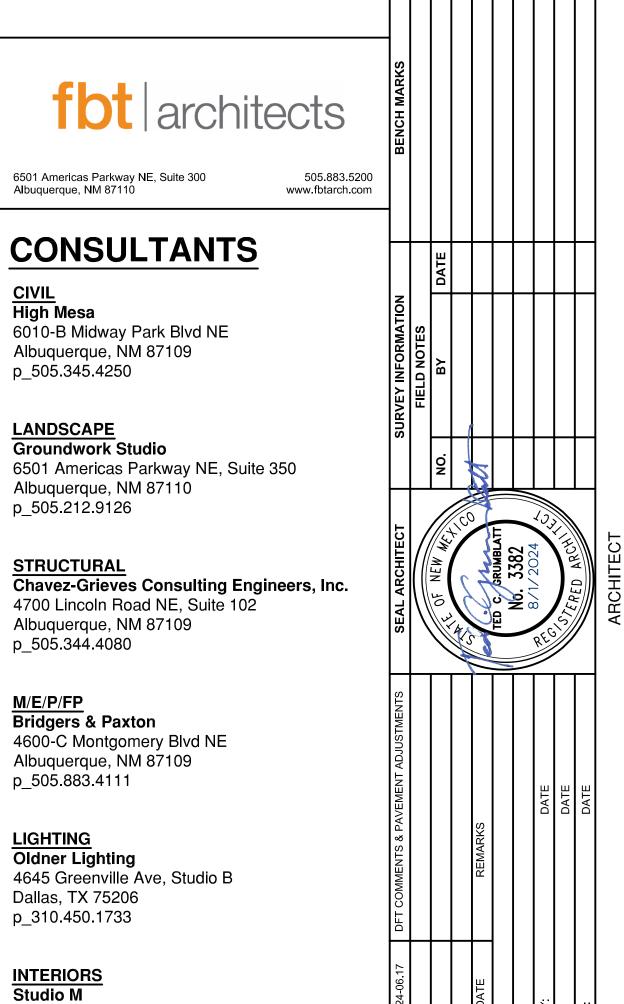

**DEVELOPMENT FACILITATION TEAM** 

PROJECT NUMBER: PR-2023-009382 APPLICATION NUMBER: SI-2024-00739

PROJECT NAME: City Multigenerational Center At 10751 Cibola Loop NW

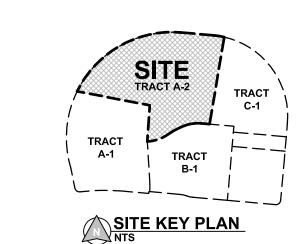

MULTIGENERATIONAL CENTER 10751 Cibola Loop NW Albuquerque, NM 87114

6501 Americas Parkway NE, Suite 302

COA CIBOLA LOOP

Albuquerque, NM 87110

p 505.243.9287

PROJECT TITLE:

**CONSTRUCTION DOCUMENTS** 


JUNE 12, 2024

DRAWING TITLE: ENLARGED PARKING PLANS

City Engineer Approval Design Review Committee 2024.04.30 City Project No. Zone Map No. Sheet AS-103 P7882.16 A-13-Z

CITY OF ALBUQUERQUE

0' 5' 10'

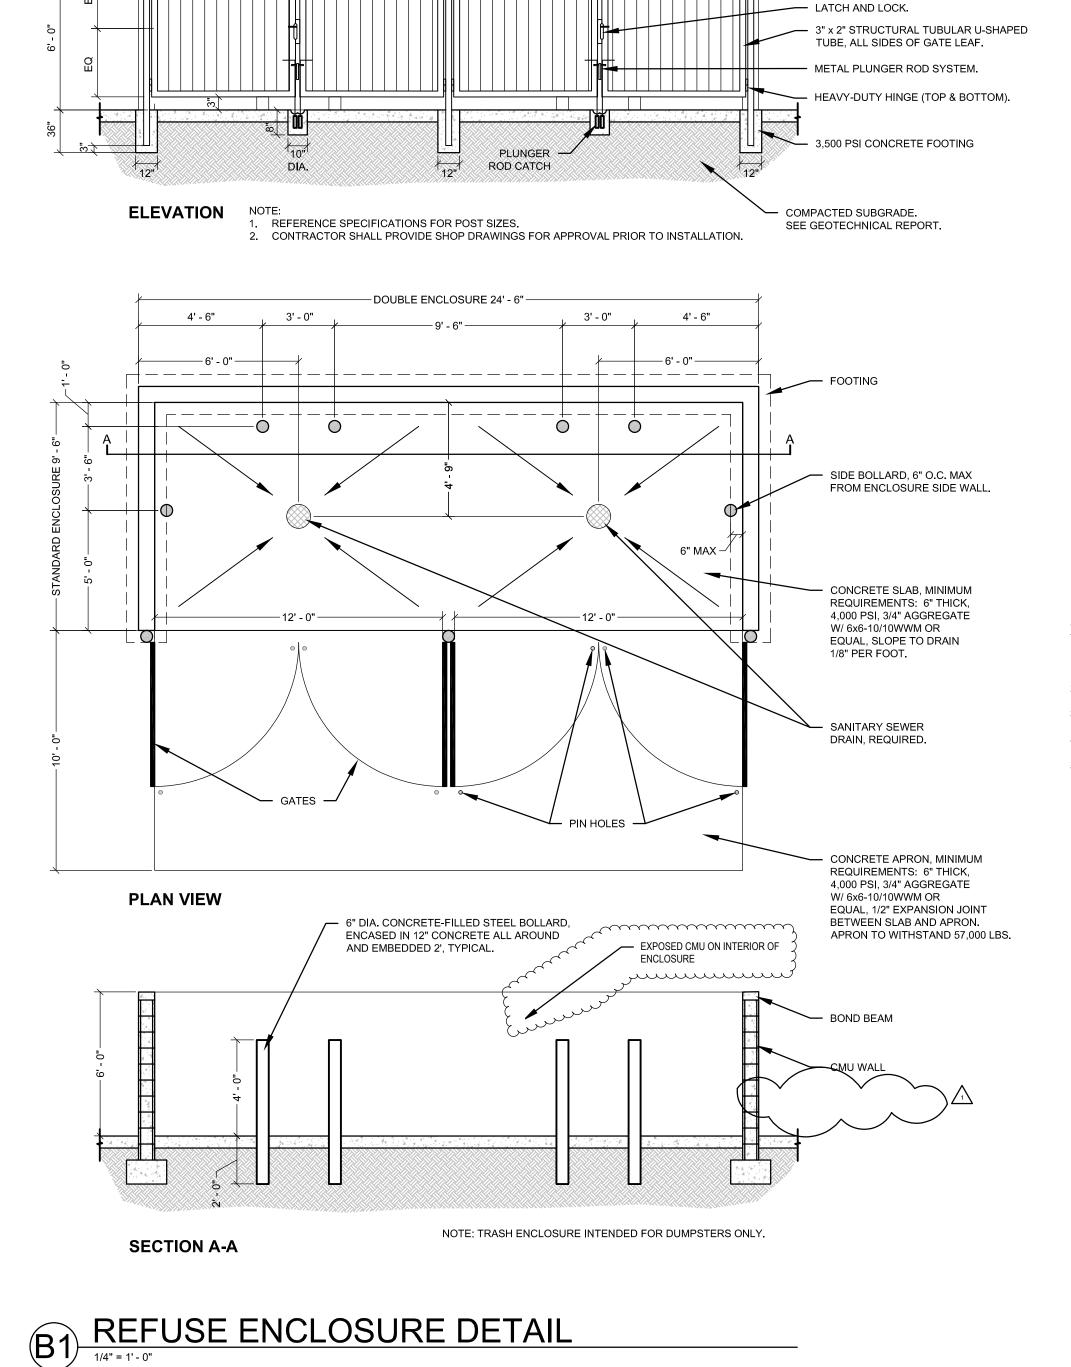


12' - 0" CLEAR

STEEL-TUBE POST WITH WELDED PLATE CAP.

VERTICAL ALUMINUM PLANK INFILL,

COLOR SELECTED BY ARCHITECT.

12' - 0" CLEAR

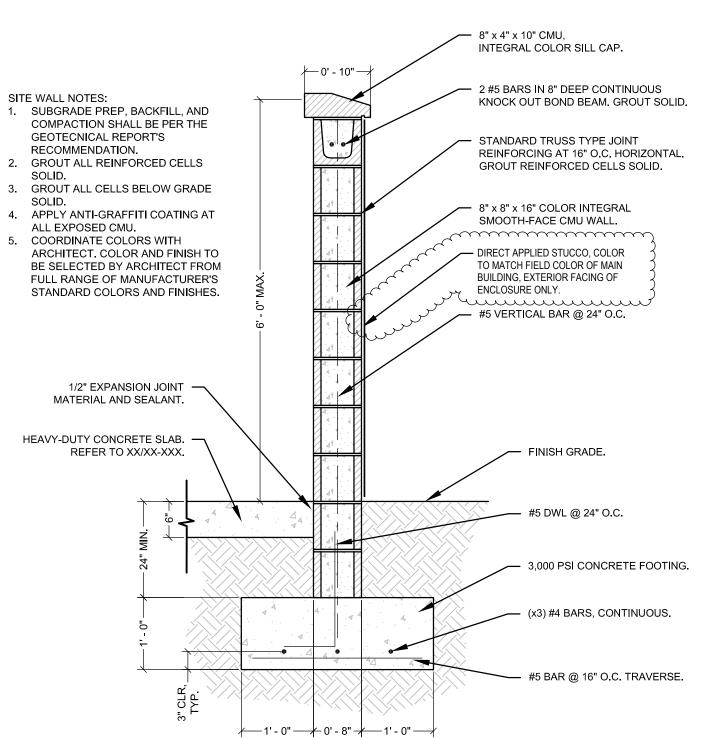

B3 SITE MASONRY WALL

ENLARGED REFUSE ENCLOSURE PLAN

1"= 10'- 0"



#### **KEYED NOTES**

- S15 ASPHALT PAVING, TYPICAL.
   S31 CONCRETE CURB & GUTTER SYSTEM, TYPICAL. SEE SITE DETAILS & CIVIL.
   S32 MOUNTABLE CURB AT PARKING ROW ENDS, TYPICAL. SEE COA STD. DWG.
- 2415B FOR MOUNTABLE ROLL CURB AND GUTTER DETAIL.

  S34 4" THICK STANDARD DUTY CONCRETE PAVEMENT WITH TURN DOWN EDGE AT ALL EXPOSED EDGES.
- S35 ACCESSIBLE CURB RAMP. SEE COA STD. DWG. 2443 FOR PARALLEL CURB RAMP DETAILS. INSTALL TRUNCATED DOME IN ALL ADA RAMPS, RECESS TO FLUSH WITH SURFACE OF CONCRETE SIDEWALK. SEE COA STD. DWG. 2446 FOR DETECTABLE WARNING DEVICE DETAILS.
- S38 6" TRAFFIC-RATED BOLLARD.

  S51 6" CONCRETE APRON 4,000 PSI 3/4" AGGREGATE WITH 6X6-10/10WWM OR
- EQUAL WITH 1/2" EXPANSION JOINT BETWEEN PAD AND APRON.
- 6" MIN. CONCRETE SLAB 4,000 PSI 3/4" AGGREGATE WITH 6X6-10/10WWM OR EQUAL, SLOPE TO DRAIN 1/8" PER FOOT.
- S61 LANDSCAPING, SEE LANDSCAPE.
- S65 REFUSE BIN BY OTHER, NIC.
- S66 REFUSE ENCLOSURE CMU WALL.S67 REFUSE ENCLOSURE SWING GATE.
- S68 RECYCLING BIN BY OTHER, NIC.
- S71 BACKFLOW PREVENTER IN HEATED ENCLOSURE, SEE CIVIL.
- S72 DRAIN INLET, SEE CIVIL.S74 SANITARY DRAIN, SEE CIVIL.
- S81 POST-INDICATOR VALVE (PIV), SEE CIVIL.
- S82 REMOTE FDC WITH GROUND-MOUNTED SIGN, SEE CIVIL.
- S92 SITE LIGHTING, SEE LIGHTING.

#### **GENERAL NOTES**

- A. A. SUB GRADE PREPARATION AND SOIL
  COMPACTION AT ALL CONCRETE WORK SHALL
  COMPLY WITH REQUIREMENTS ON CIVIL DRAWINGS
- AND GEOTECHNICAL REPORT.

  B. PROVIDE BROOM FINISH ON CONCRETE SIDEWALK,
  UNLESS NOTED OTHERWISE.
- C. VERIFY SIDEWALK LAYOUT WITH ARCHITECT PRIOR
  TO FORMING AND POURING CONCRETE. NO
  EXCEPTIONS.
- D. FOR INFORMATION ON UTILITIES SEE SITE SURVEY SHEET, CIVIL UTILITY PLANS, MECHANICAL, PLUMBING AND ELECTRICAL DRAWINGS.

E. CONTRACTOR SHALL PAY FOR AND COORDINATE

DISCONNECT, RECONNECT AND DEMO WORK.

F. ALL SITE ELEMENTS INCLUDING BUT NOT LIMITED TO TREES, SHRUBS, GROUND COVER MATERIAL, ETC. THAT MUST BE REMOVED FROM THE SITE IN ORDER TO ACCOMPLISH NEW WORK SHALL BE REMOVED AT NO ADDITIONAL COST TO THE OWNER.

CONTRACTOR SHALL VISIT SITE PRIOR TO BIDDING TO BECOME FAMILIAR WITH SITE FEATURES TO BE

WITH LOCAL UTILITY COMPANIES FOR ALL UTILITY

- DEMOLISHED.

  G. CONTRACTOR SHALL BE RESPONSIBLE FOR SECURING AND PAYING FOR PERMIT FEES ASSOCIATED WITH ENVIRONMENTAL PROTECTION AGENCY AND REQUIREMENTS OF STORM WATER POLLUTION PREVENTION PLAN (SWPPP) COORDINATE WITH ALL REGULATORY AUTHORITIES
- POLLUTION PREVENTION PLAN (SWPPP)
  COORDINATE WITH ALL REGULATORY AUTHORITIES
  REGARDING THIS ITEM.
  H. CONTRACTOR SHALL TAKE NECESSARY
  PRECAUTIONS TO PROTECT EXISTING SITE
  FEATURES, PLANTINGS, AND UTILITIES TO REMAIN.
  ANY DAMAGE TO EXISTING SITE FEATURES.

PLANTINGS, AND UTILITIES TO REMAIN DUE TO

- CONSTRUCTION OPERATIONS SHALL BE REPAIRED AT NO ADDITIONAL COST TO THE OWNER.

  I. ALL DOWNSPOUT, LAMBSTOUNGUE, ETC. THAT ROUTE ROOF WATER TO GRADE SHALL BE DISCHARGED IN A CONCRETE RUN DOWN, TRENCH GRATE, OR SPLASH BLOCK. SEE CIVIL. FIELD COORDINATE LOCATION OF DISCHARGE POINTS
- COORDINATE LOCATION OF DISCHARGE POINTS
  PRIOR TO FORMING AND INSTALLING CONCRETE.

  J. FURNISH AND INSTALL CURB MARKING PAINT (RED
  FIRE LANE OR YELLOW DROP OFF LANE) ENTIRE
  LENGTH OF CURB AT BUILDING SIDE OF DROP OFF.
  COORDINATE WITH FIRE MARSHALL FOR LOCATION
- OF FIRE LANE MARKINGS.

  K. WHERE NEW CONCRETE PAVEMENT AND/OR
  CURBING IS SHOWN ADJACENT TO EXISTING,
  CONTRACTOR SHALL PROVIDE NEW CONCRETE
  PAVEMENT AND/OR CURBING UP TO AND FLUSH
  WITH EXISTING. LIMITS SHOWN ARE APPROXIMATE.
  CONTRACTOR SHALL FIELD VERIFY.
- L. REFER TO GEOTECHNICAL REPORT FOR ADDITIONAL REQUIREMENTS REGARDING NEW ASPHALT AND
- CONCRETE PAVEMENT.

  M. CONTRACTOR SHALL FIELD VERIFY ALL DIMENSIONS AND LAYOUT OF BOTH THE SITE AND BUILDING ELEMENTS. COORDINATE FIELD INFORMATION WITH THE ARCHITECT PRIOR TO ANY CONSTRUCTION ACTIVITY.



6501 Americas Parkway NE, Suite 300 Albuquerque, NM 87110 505.883.5200 www.fbtarch.com

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p\_505.212.9126

p\_505.344.4080


LANDSCAPE
Groundwork Studio
6501 Americas Parkway NE, Suite 350
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STRUCTURAL
Chavez-Grieves Consulting Engineers, Inc.
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CITY OF ALBUQUERQUE

## COA CIBOLA LOOP MULTIGENERATIONAL CENTER

10751 Cibola Loop NW Albuquerque, NM 87114

DRAWING TITLE:

CONSTRUCTION DOCUMENTS

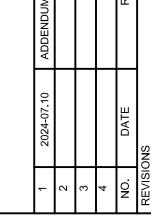JUNE 12, 2024


SHEET TITLE:
REFUSE/SOLID WASTE


**DEVELOPMENT FACILITATION TEAM** 


PROJECT NUMBER: PR-2023-009382
APPLICATION NUMBER: SI-2024-00739

PROJECT NAME: City Multigenerational Center At 10751 Cibola Loop NW

1" = 10' - 0" 0' 5' 10'

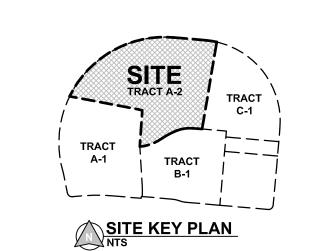

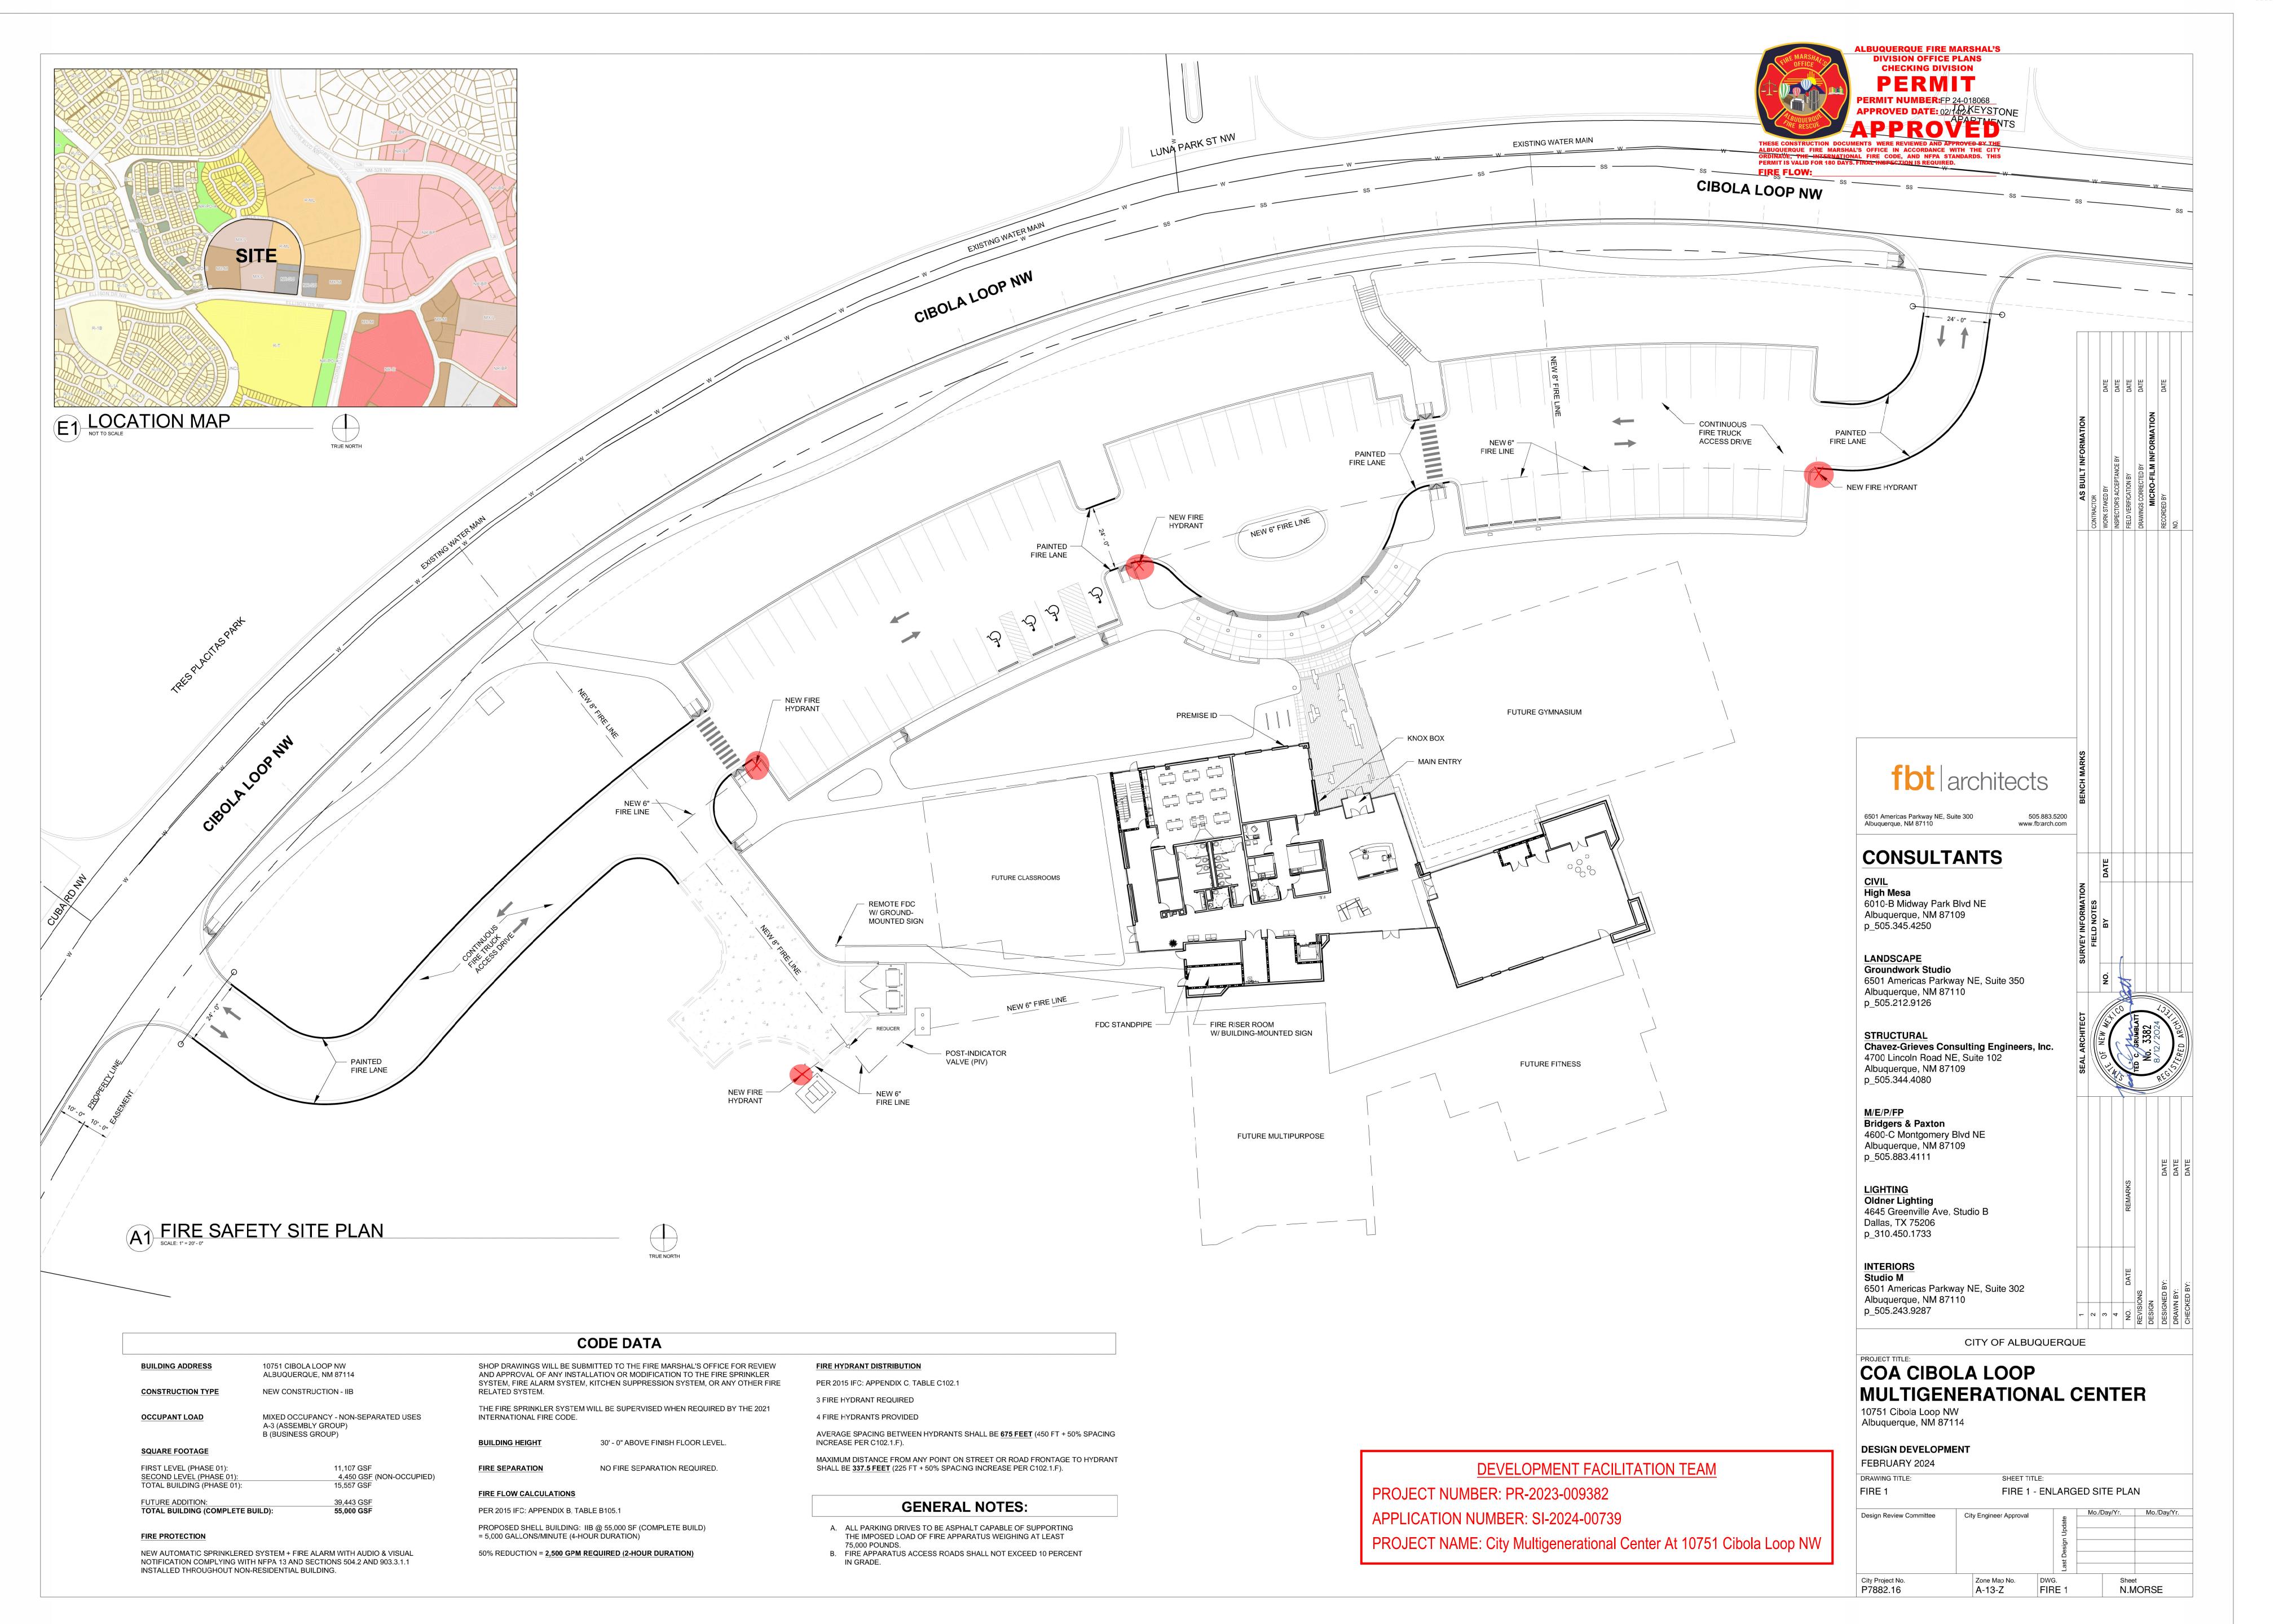


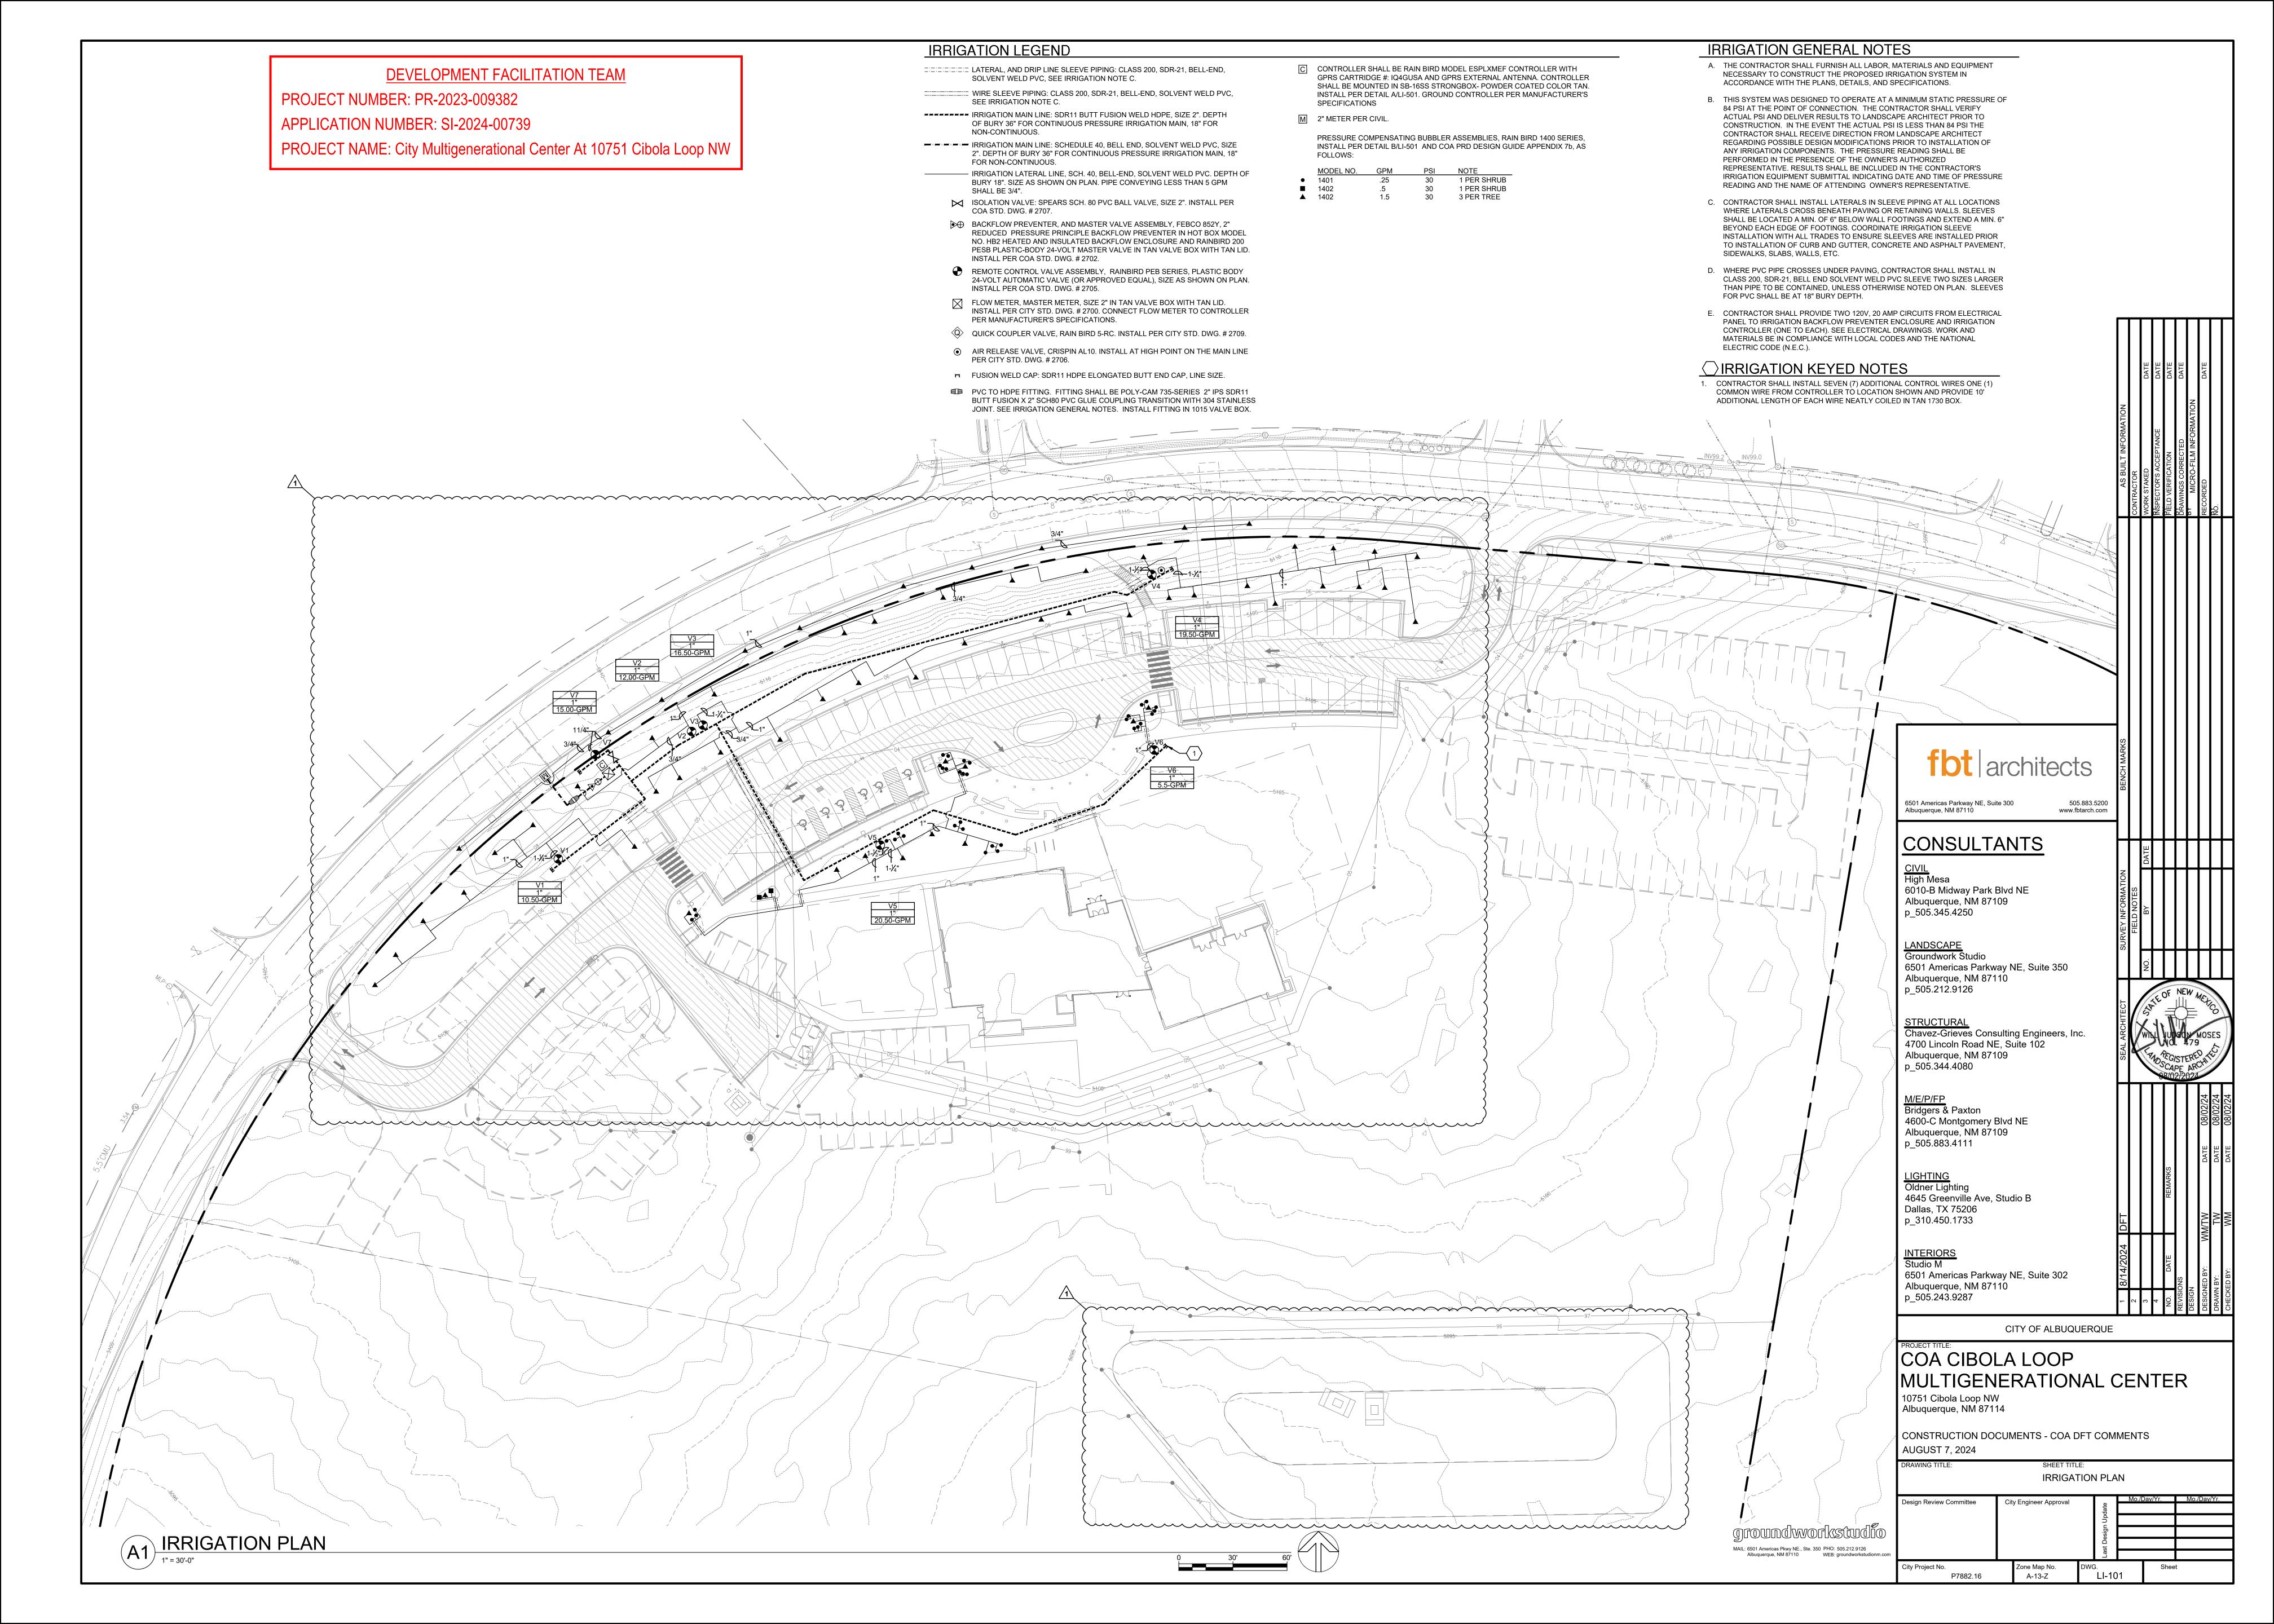



APPLICATION NUMBER: SI-2024-00739 PROJECT NAME: City Multigenerational Center At 10751 Cibola Loop NW fbt architects 6501 Americas Parkway NE, Suite 300 Albuquerque, NM 87110 505.883.5200 www.fbtarch.com BUBBLER, SEE IRRIGATION LEGEND. TOP OF BUBBLER SHALL BE FLUSH CONSULTANTS WITH TOP OF MULCH. LOCATE BUBBLER 12" FROM ROOT BALL OF TREE AND 8" FROM ROOT BALL OF CIVIL High Mesa 6010-B Midway Park Blvd NE Albuquerque, NM 87109 p\_505.345.4250 LANDSCAPE Groundwork Studio  $\frac{1}{2}$ " SCH. 80 PVC THREADED NIPPLE, LENGTH AS REQUIRED. 6501 Americas Parkway NE, Suite 350 Albuquerque, NM 87110 p\_505.212.9126 STRUCTURAL
Chavez-Grieves Consulting Engineers, Inc. 4700 Lincoln Road NE, Suite 102 Albuquerque, NM 87109 p\_505.344.4080 SCH. 40 PVC ELBOW, - LATERAL PIPE, SEE M/E/P/FP Bridgers & Paxton LINE SIZE SLIP X  $\frac{1}{2}$ " FPT IRRIGATION LEGEND. 4600-C Montgomery Blvd NE Albuquerque, NM 87109 **BUBBLER ASSEMBLY** p\_505.883.4111 LIGHTING Oldner Lighting 4645 Greenville Ave, Studio B Dallas, TX 75206 p\_310.450.1733 AUTOMATIC CONTROLLER IN PEDESTAL-ENCLOSURE., SEE IRRIGATION LEGEND. INSTALL PER MANUFACTURER'S INTERIORS Studio M SPECIFICATIONS 6501 Americas Parkway NE, Suite 302 3/4" RIGID PVC SWEEP ELL Albuquerque, NM 87110 FOR 120V POWER p\_505.243.9287 - 3/4" RIGID PVC SWEEP ELL — FOR GROUND WIRE RIGID PVC SWEEP ELL FOR 24V — CITY OF ALBUQUERQUE WIRE, SIZE AS REQUIRED. EXTEND 12" PAST CONCRETE PAD 1/2" X 6" ANCHOR BOLTS COA CIBOLA LOOP - 6" THICK 3,500 PSI CONCRETE
PAD WITH MED. BROOM FINISH.
EXTEND PAD MIN. 18" BEYOND
EACH SIDE OF ENCLOSURE, MULTIGENERATIONAL CENTER 10751 Cibola Loop NW Albuquerque, NM 87114 SLOPE TO DRAIN. CONSTRUCTION DOCUMENTS - COA DFT COMMENTS AUGUST 7, 2024 A PEDESTAL MOUNTED CONTROLLER
SCALE: N.T.S. IRRIGATION DETAILS Design Review Committee City Engineer Approval groundworkstudio MAIL: 6501 Americas Pkwy NE., Ste. 350 PHO: 505.212.9126 Albuquerque, NM 87110 WEB: groundworkstudionm.c Zone Map No. A-13-Z City Project No. wg. **LI-501** Sheet P7882.16


**DEVELOPMENT FACILITATION TEAM** 


PROJECT NUMBER: PR-2023-009382

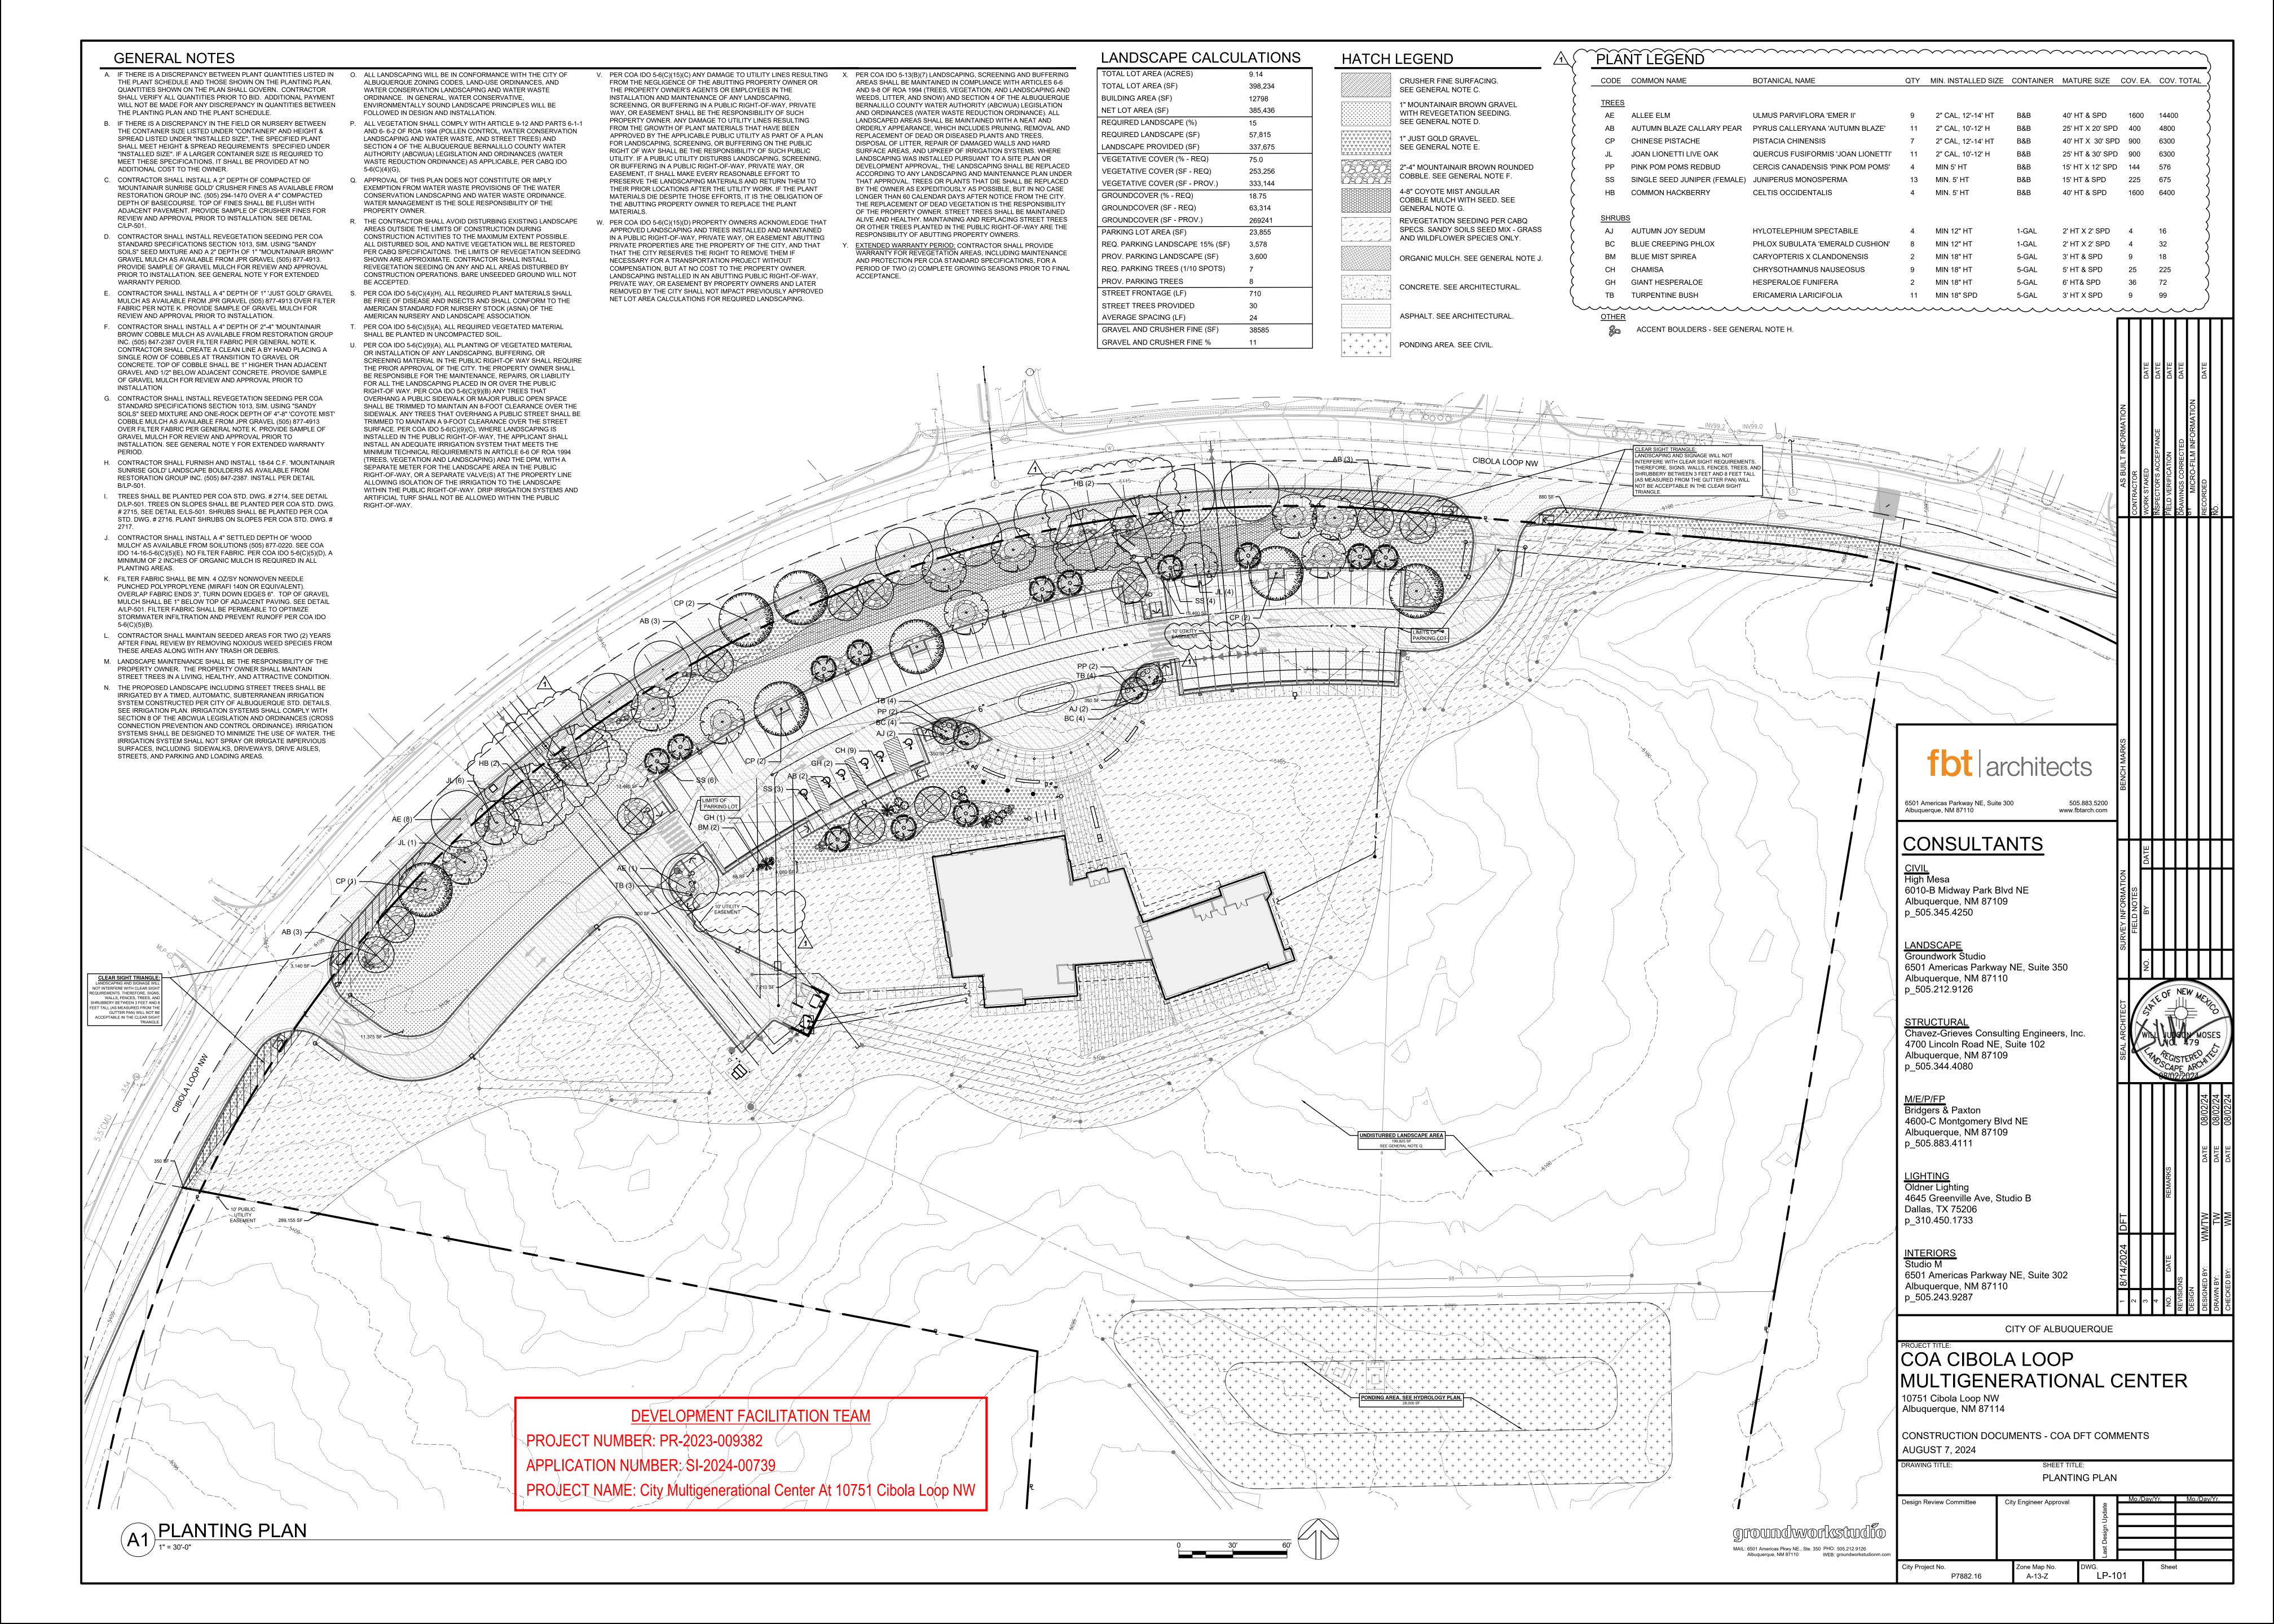


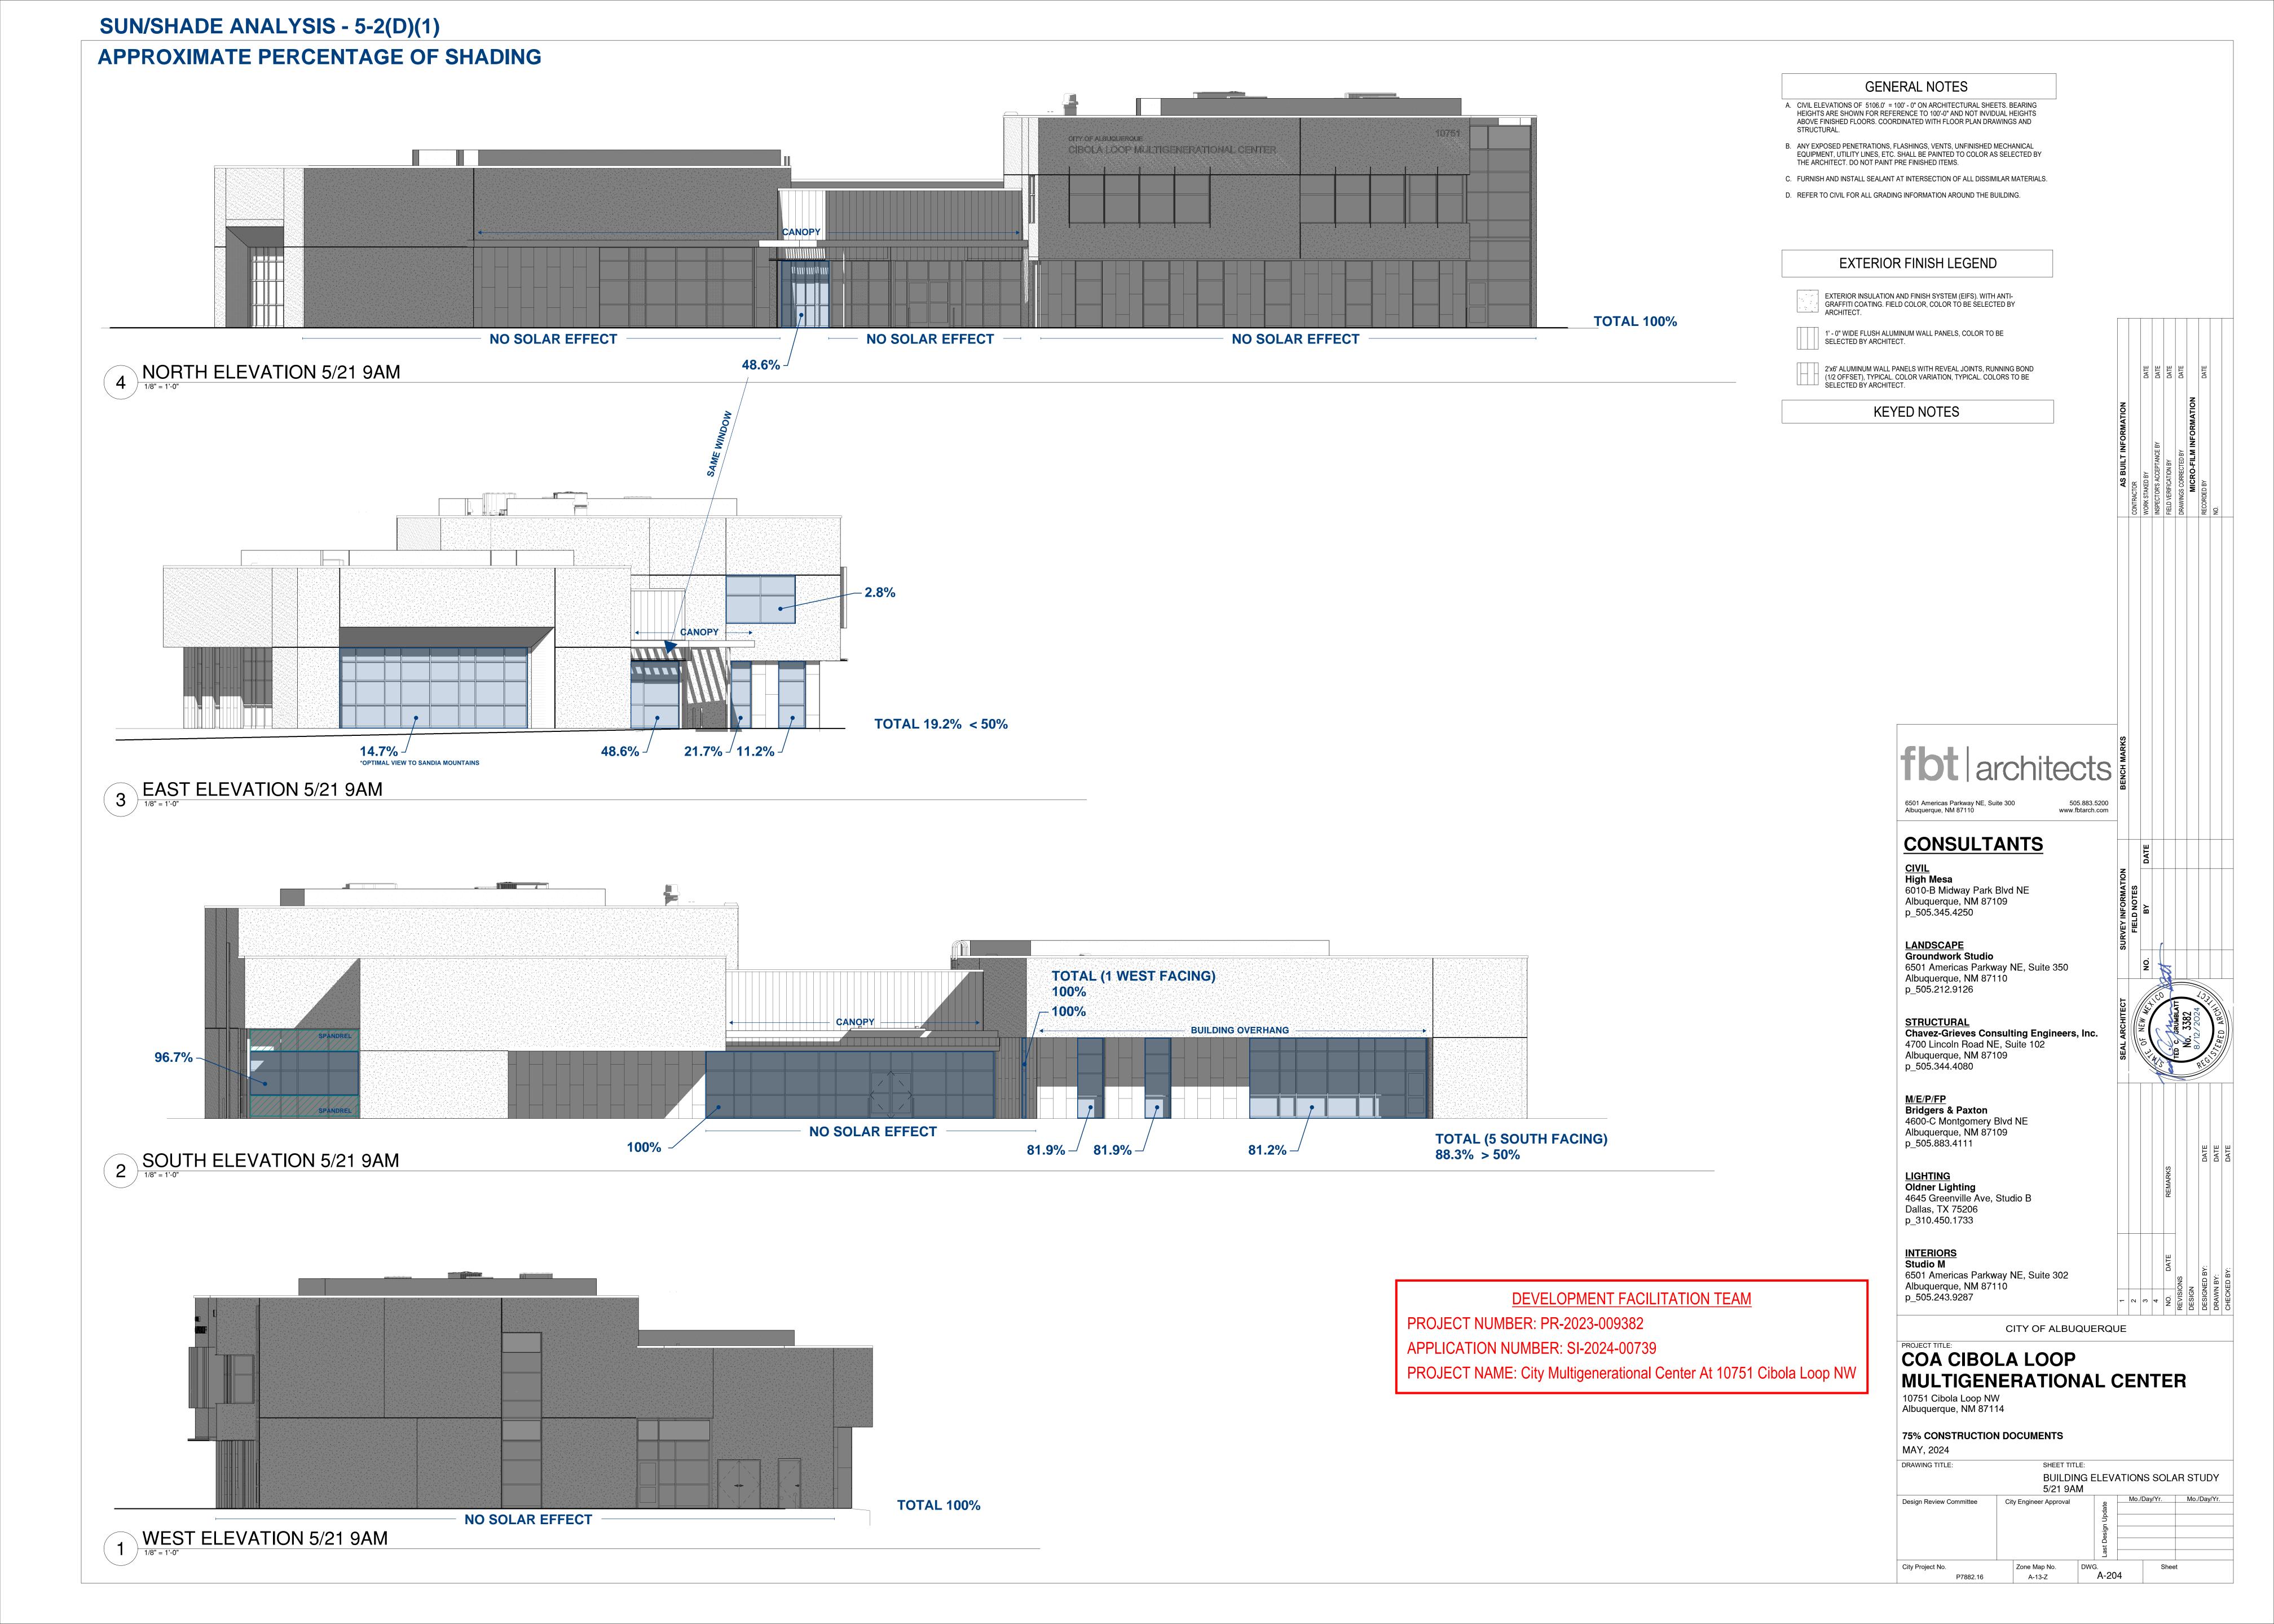

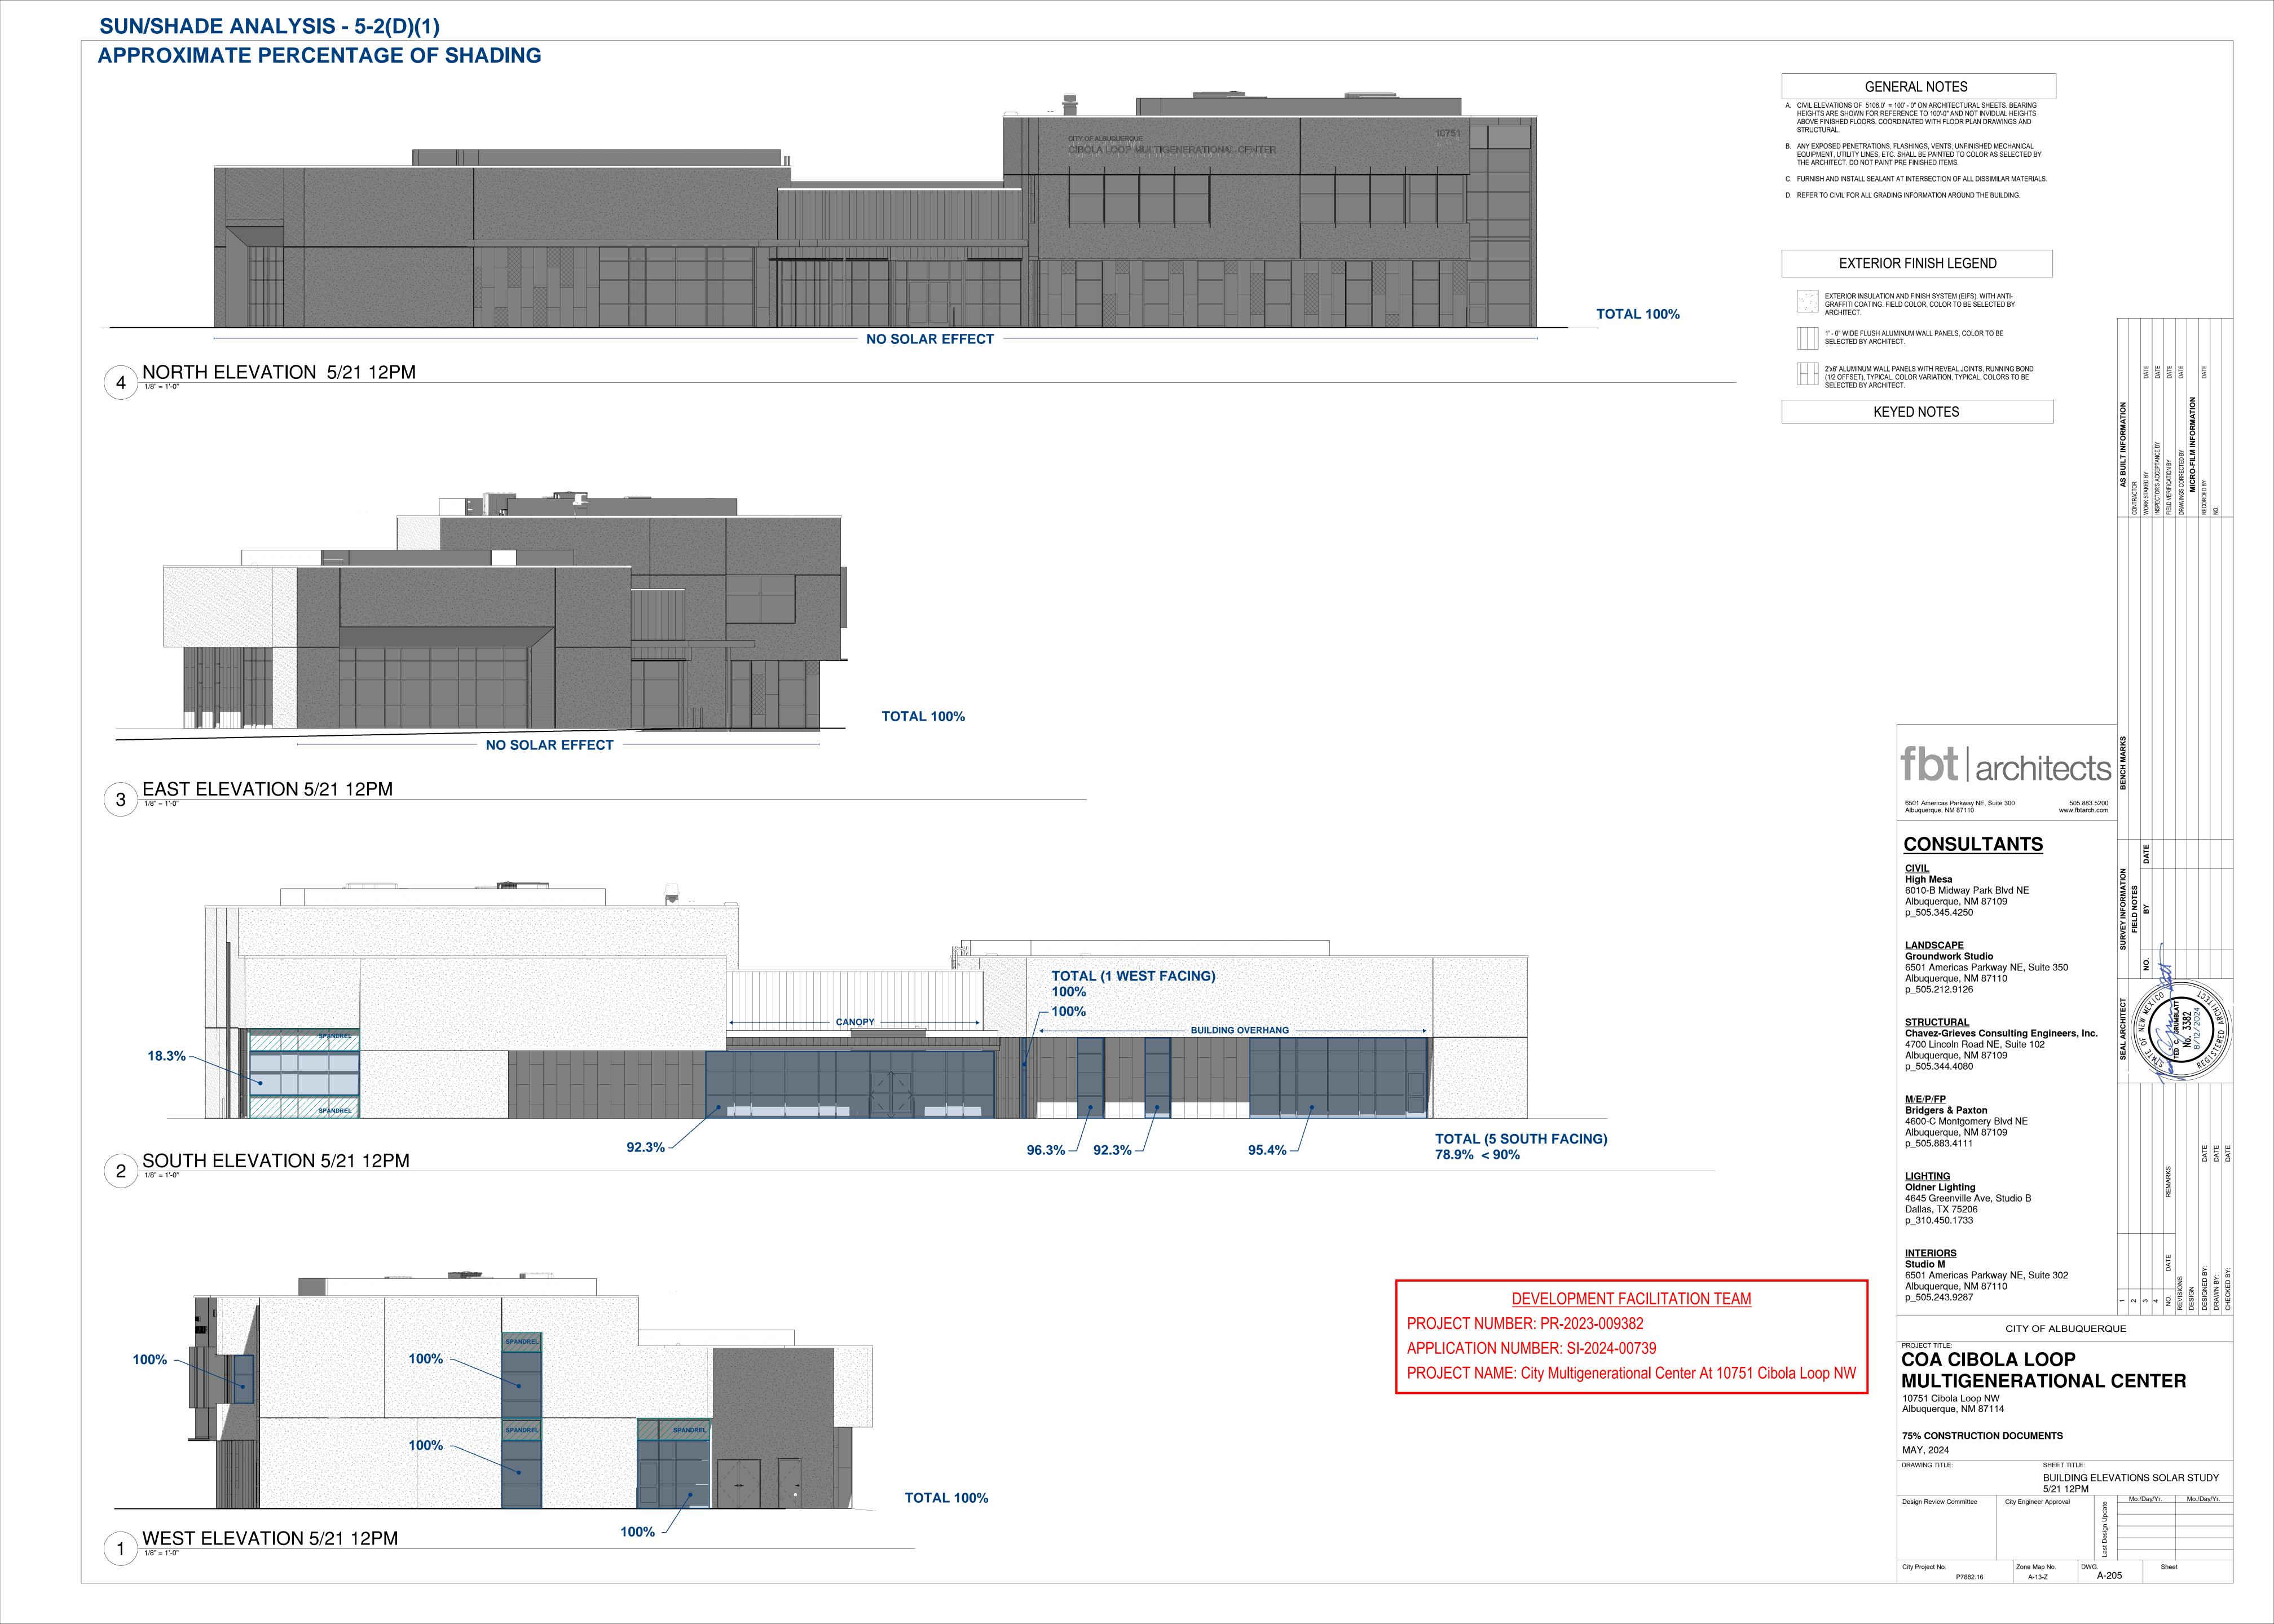

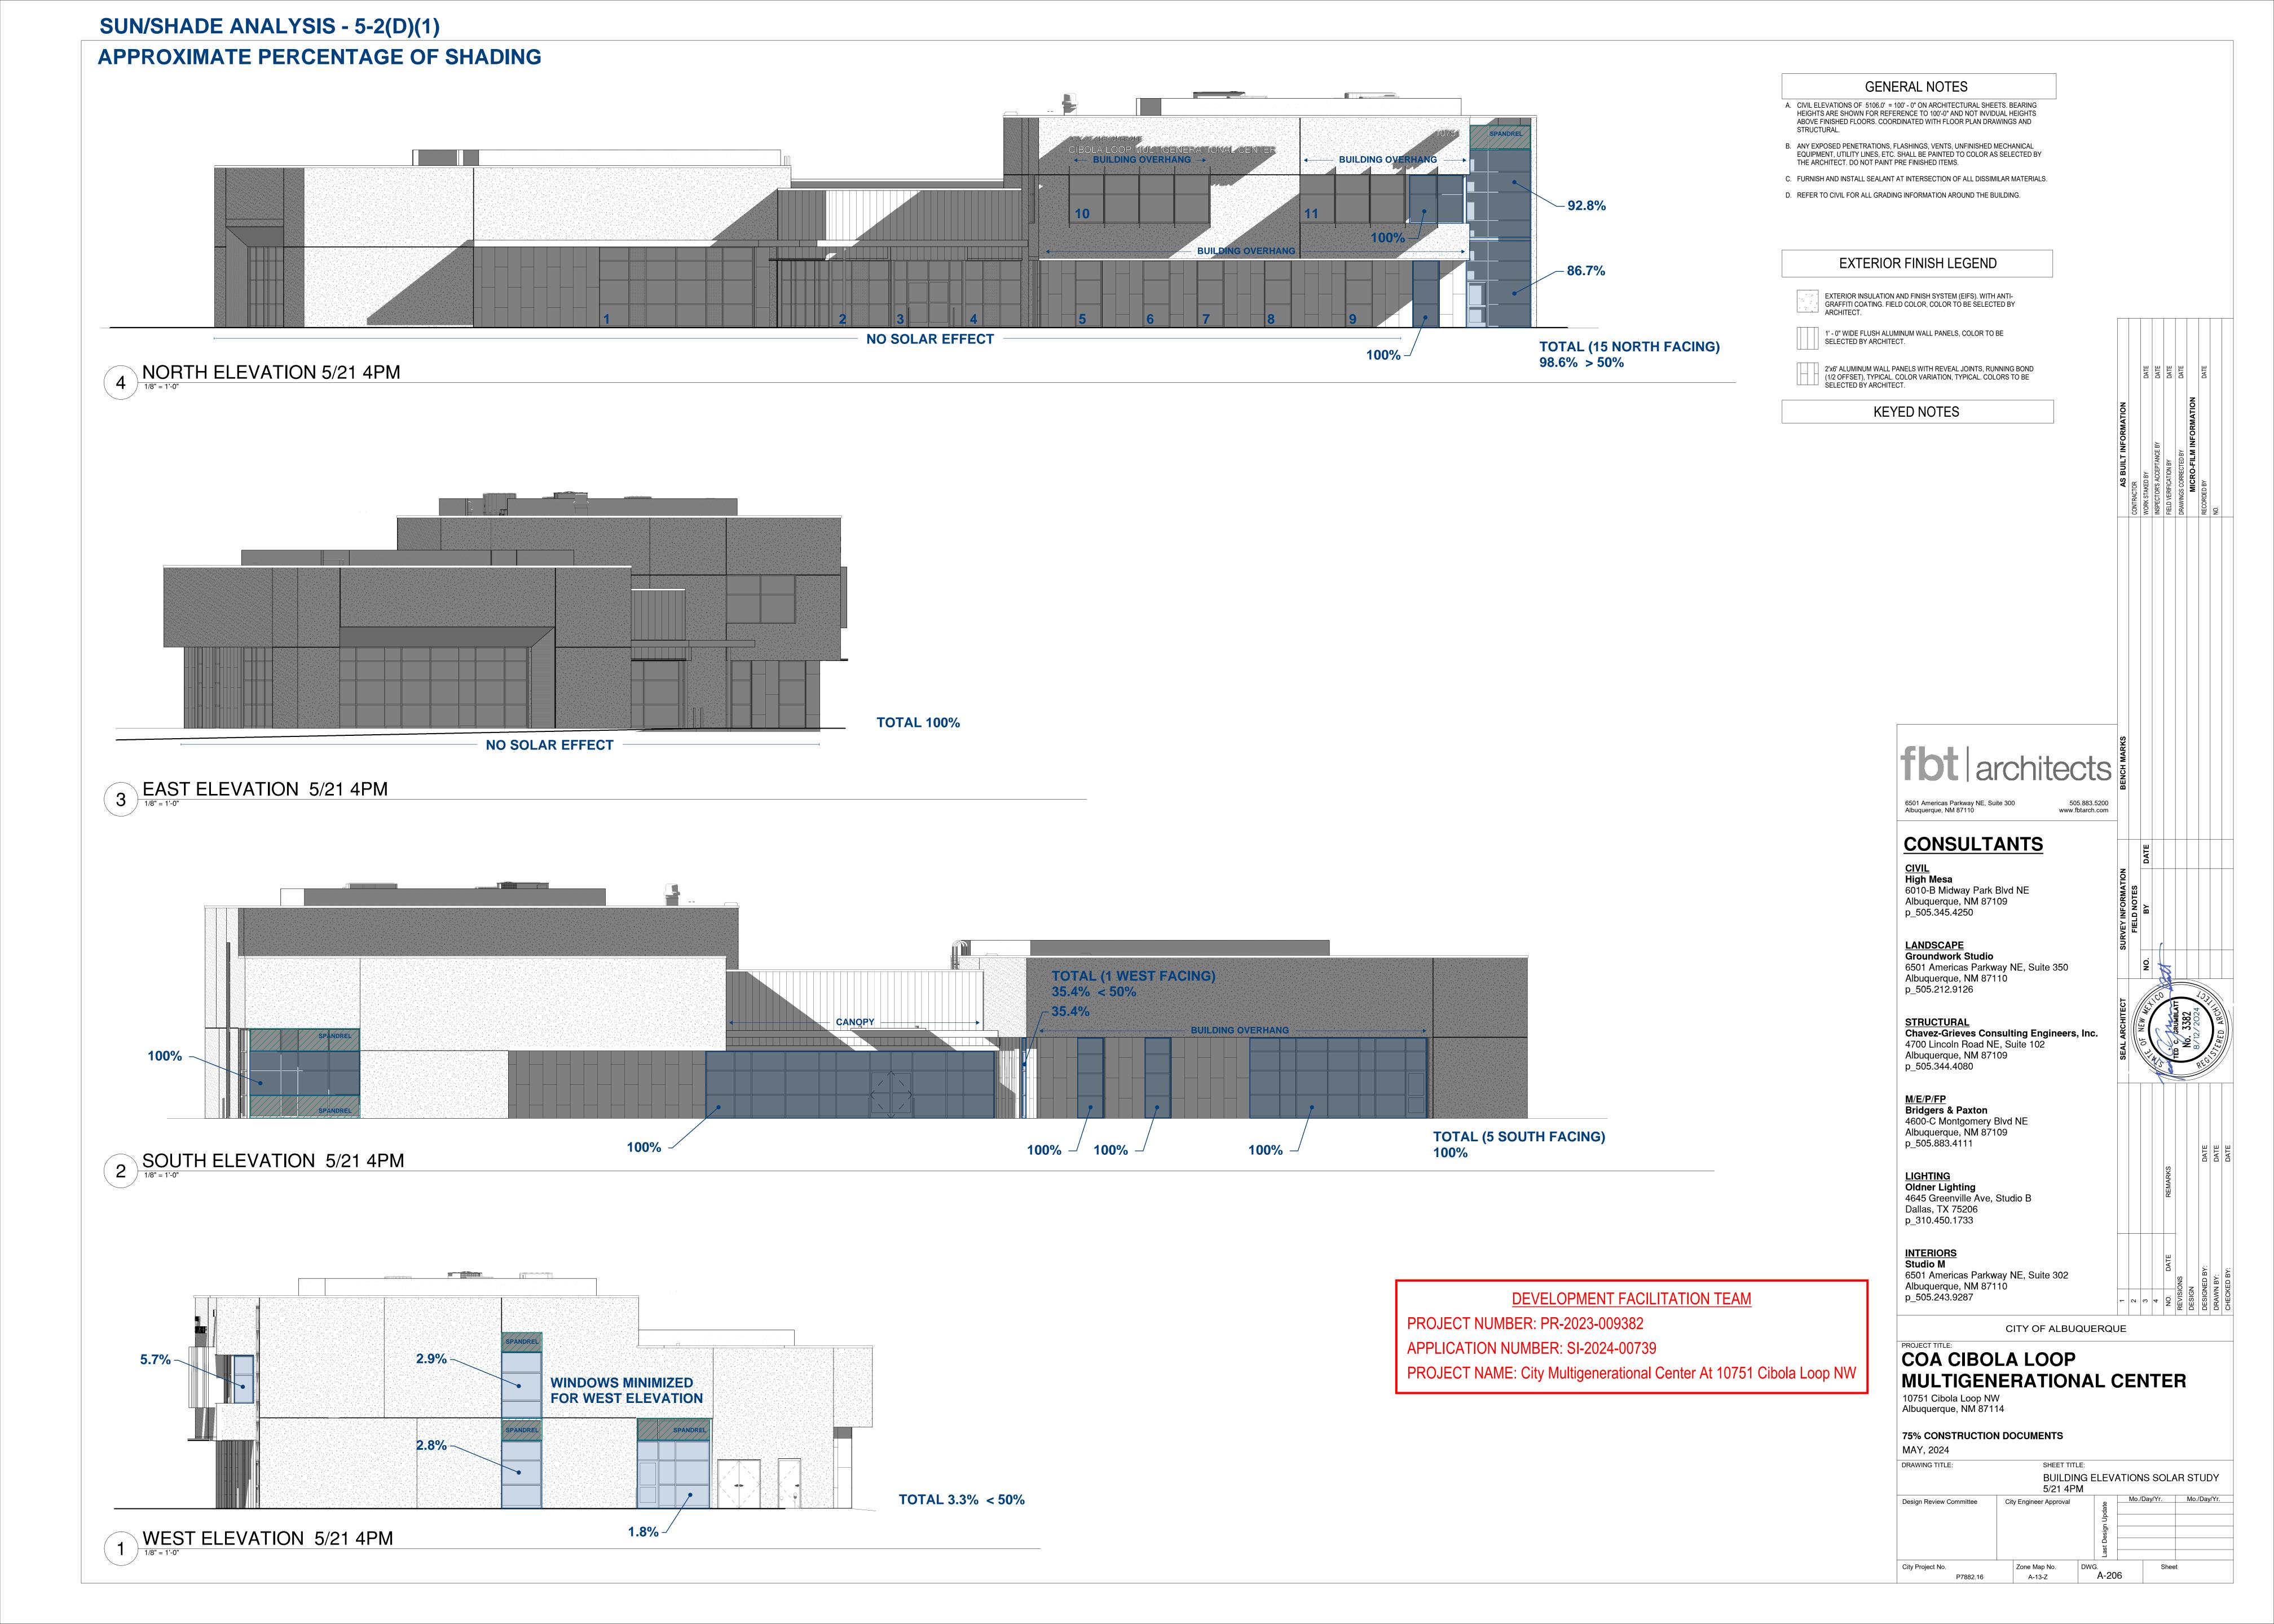

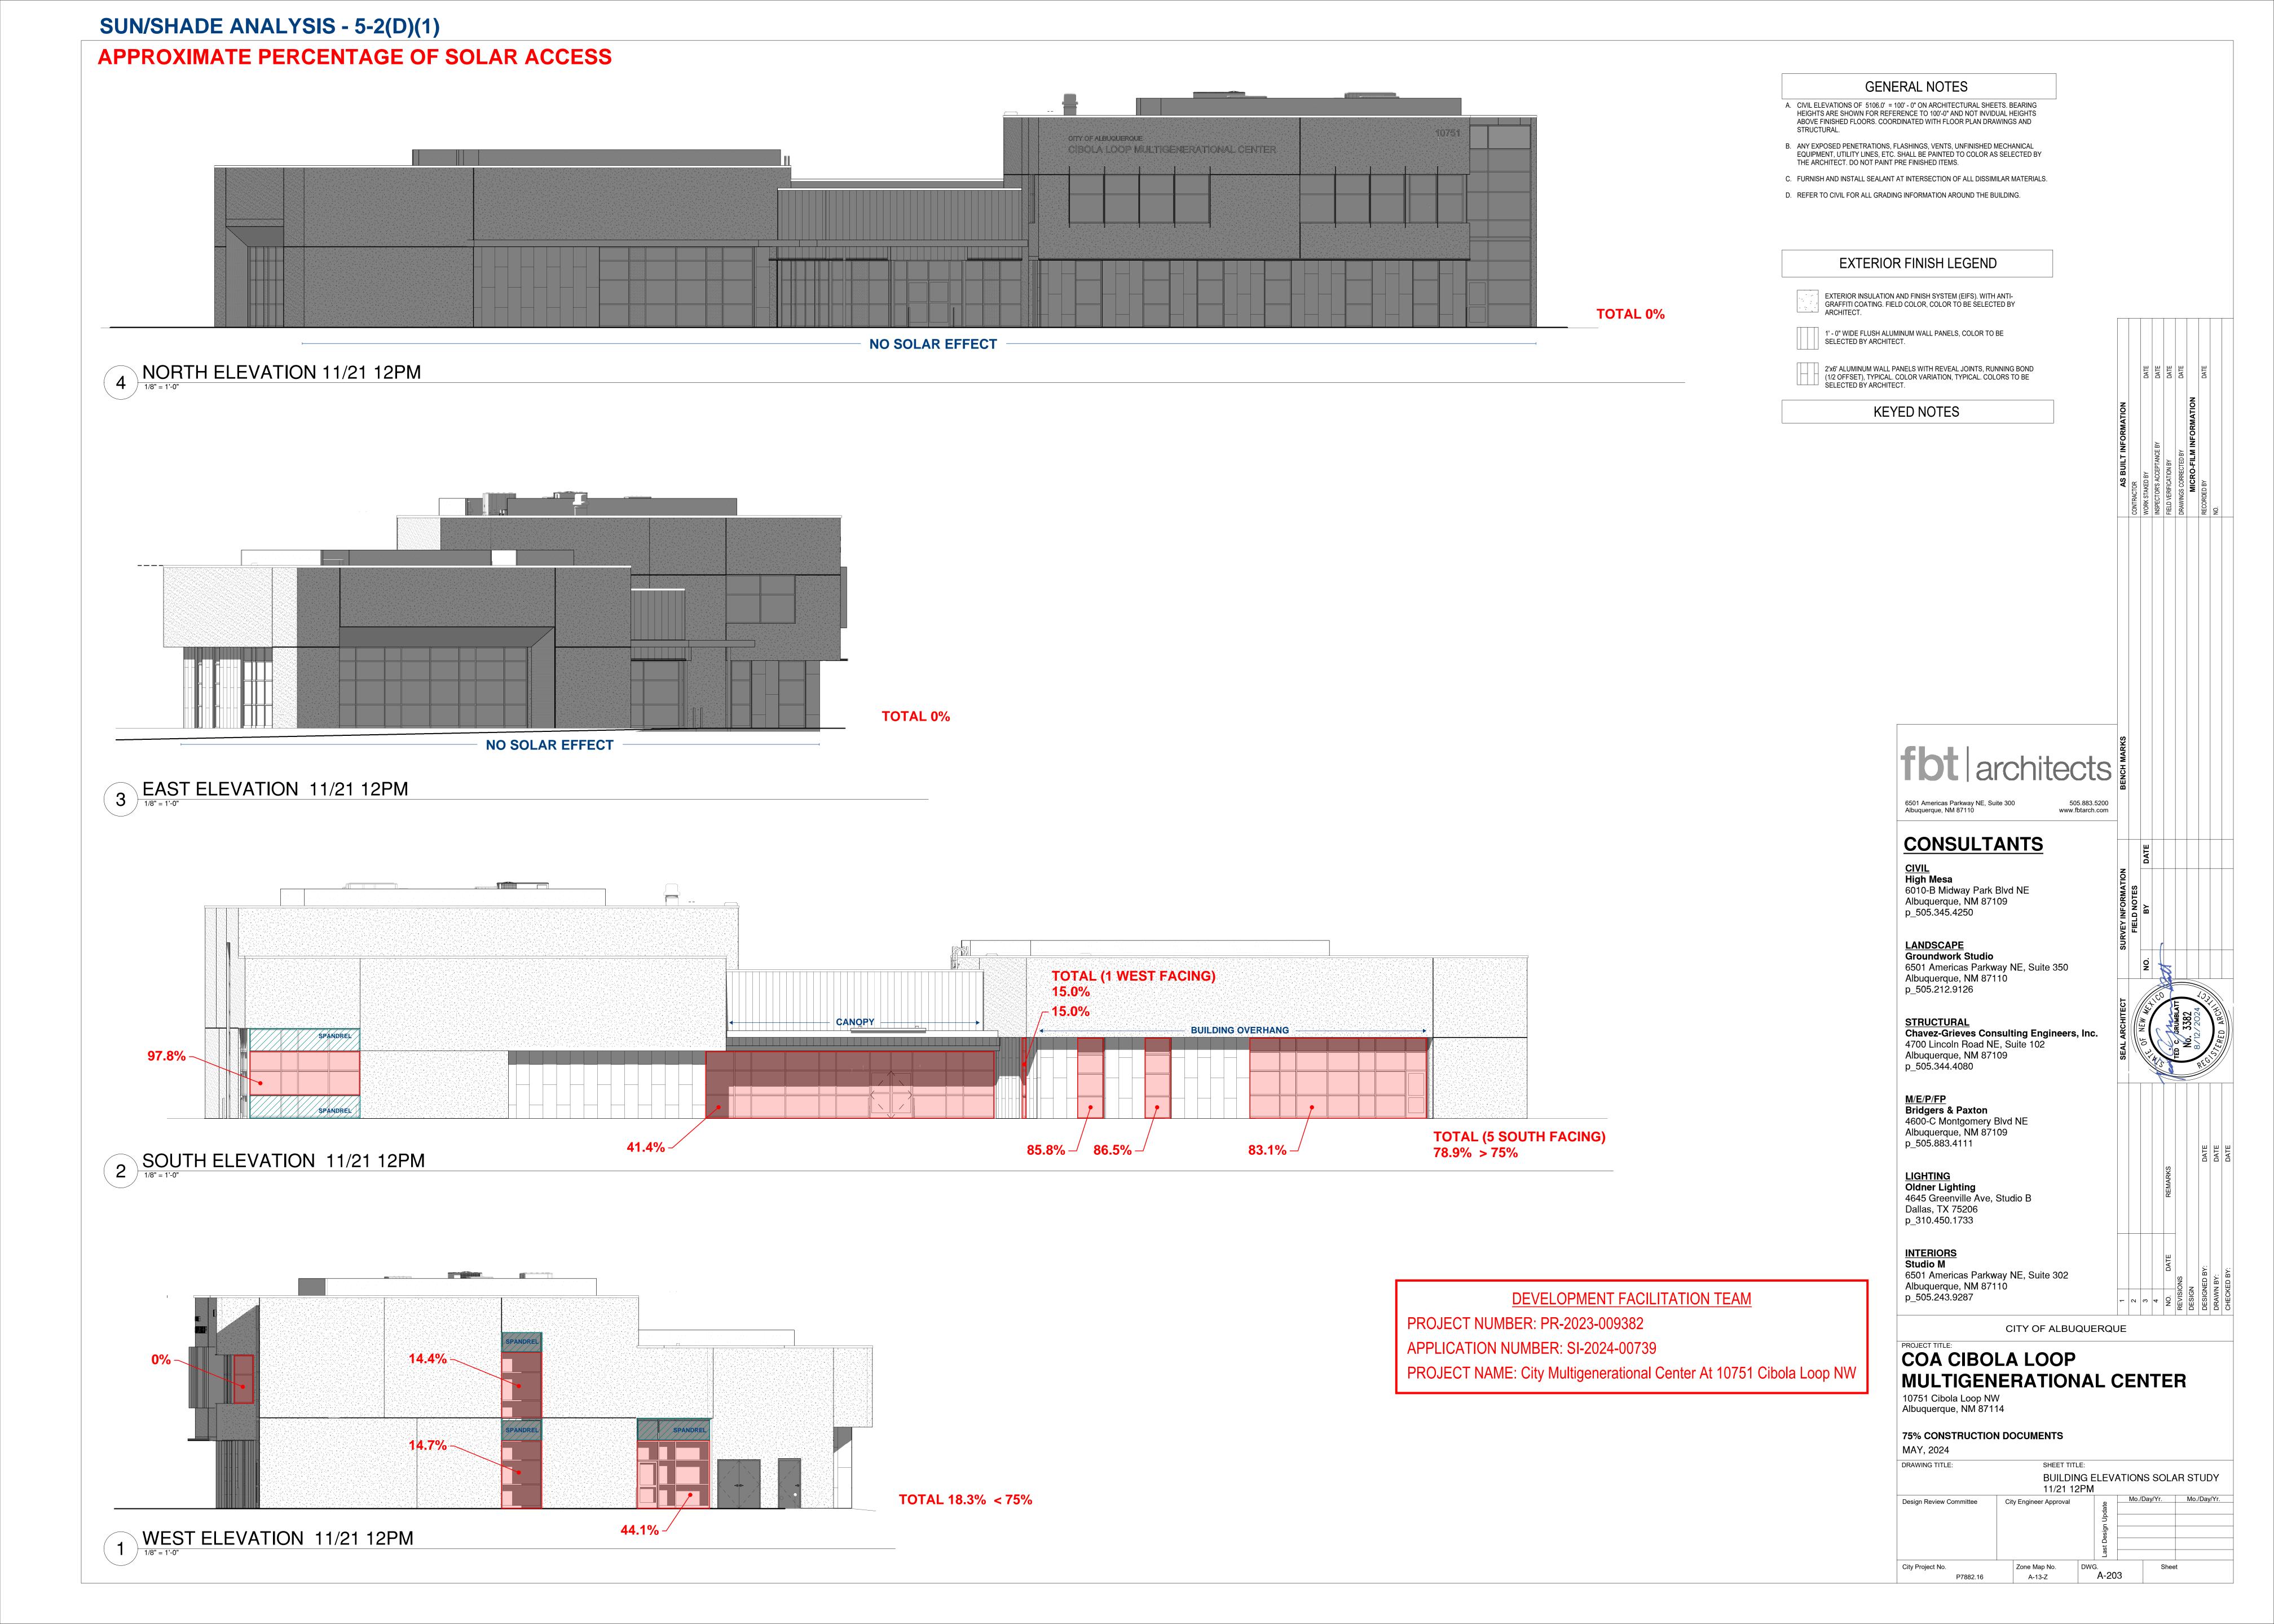

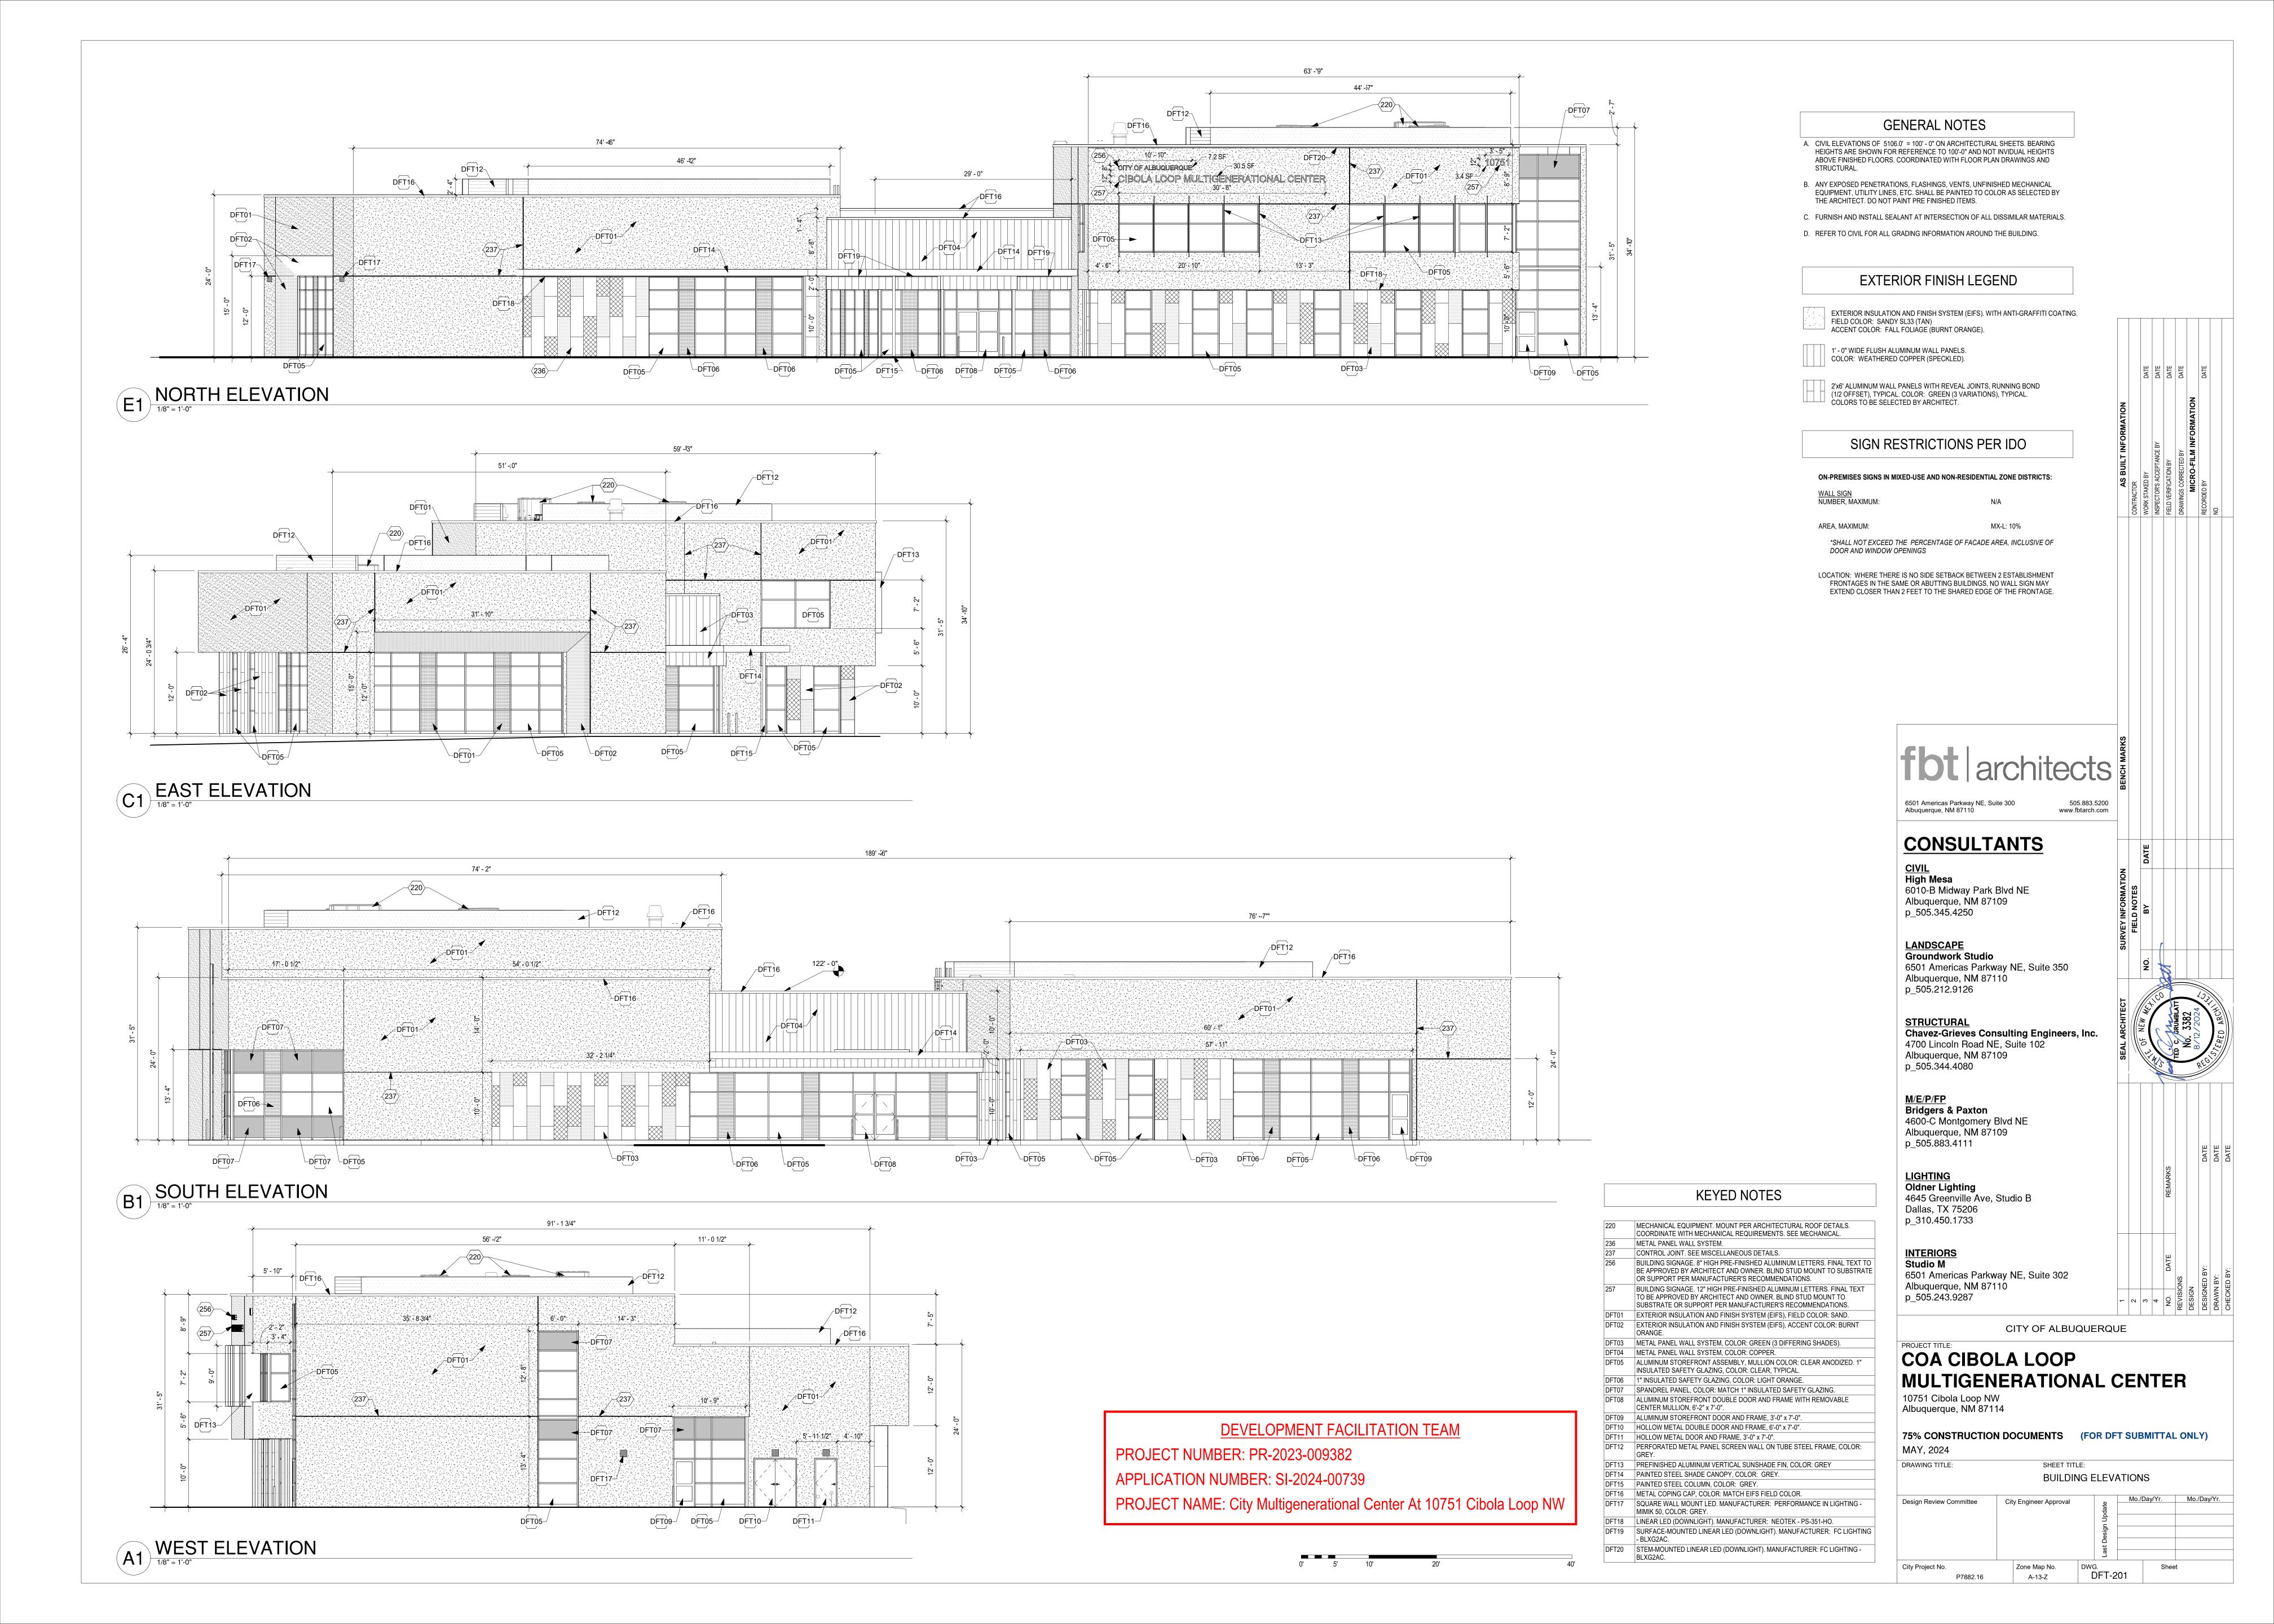

# 



- A. COORDINATE DUCT ROUTING AND EQUIPMENT INSTALLATION WITH STRUCTURAL PLANS, ARCHITECTURAL PLANS AND ELECTRICAL PLANS. GIVE SPECIAL ATTENTION TO STRUCTURAL BEAM ELEVATIONS, CEILING HEIGHTS, CABLE TRAYS, AND ROOF DRAIN LEADERS. SUBMIT 3D COORDINATION DRAWINGS FOR REVIEW PER SPECIFICATIONS 23 0500.
   B. ALL DUCT SIZES SHOWN ON THE DRAWING ARE NET INSIDE DIMENSIONS. SEE SPECIFICATION 230700 FOR INSULATION AND
- DIMENSIONS. SEE SPECIFICATION 230700 FOR INSULATION AND ACOUSTICAL LINING REQUIREMENTS.

  C. REFER TO SHEET M-501 FOR MECHANICAL DETAILS.

  D. CONTRACTOR SHALL PROVIDE COMPLETE HVAC MAINTENANCE FOR THE FIRST YEAR AFTER CERTIFICATE OF OCCUPANCY AND ARE

RESPONSIBLE FOR THE MAINTENANCE OF ALL INSTALLED HVAC UNITS FOR THE FIRST YEAR AFTER CERTIFICATE OF OCCUPANCY IS

ISSUED. REFER TO SPECIFICATION 23 0500.

**KEYED NOTES** 

 CONDENSING UNIT INSTALLED ON ROOF SKID PER DETAIL C2/M-501. ROUTE REFRIGERANT PIPING TO ROOF PENETRATION HOUSING PER DETAIL A3/M-501. PROVIDE REFRIGERANT PIPING AND ALL ACCESSORIES FOR A COMPLETE AND FUNCTIONAL SYSTEM PER

ROOF PENETRATION HOUSING PER DETAIL A3/M-501.
 ROOFTOP AIR HANDLING UNIT PER EQUIPMENT SCHEDULE. INSTALL

MANUFACTURER'S INSTALLATION MANUAL.

ON 24" HIGH ROOF CURB PER DETAIL C4/M-501.
4. ROOFTOP EXHAUST FAN PER EQUIPMENT SCHEDULE. INSTALL ON 24" HIGH ROOF CURB PER DETAIL B3/M-501.

5. 3"Ø WATER HEATER VENT AND COMBUSTION AIR PIPING. VENT PIPING MATERIAL SHALL BE STAINLESS STEEL DOUBLE-WALLED CATEGORY IV CONSTRUCTION. COMBUSTION AIR PIPING MATERIAL SHALL BE PVC SCHEDULE 40. SLOPE COMBUSTION AIR PIPING DOWN TOWARDS WATER HEATER PER MANUFACTURER'S INSTALLATION MANUAL. ALL JOINTS AND SEAMS MUST BE SEALED GAS TIGHT. INSTALL PER MANUFACTURER'S INSTALLATION MANUAL.

fbt architects

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1 2 3 4 DATE EVISIONS ESIGN

DATE DATE DATE

CITY OF ALBUQUERQUE

BRIDGERS & PAXTON 4600 C Montgomery Blvd. NE Albuquerque, NM 87109 505.883.4111 www.bpce.com

## COA CIBOLA LOOP MULTIGENERATIONAL CENTER

10751 Cibola Loop NW Albuquerque, NM 87114

CONSTRUCTION DOCUMENTS (FOR DFT SUBMITTAL ONLY)

June 07, 2024

DRAWING TITLE:

SHEET TITLE:

MECHANICAL ROOF PLAN

Design Review Committee

City Engineer Approval

P7882.16

City Engineer Approval

Design Review Committee

City Engineer Approval

Design Review Committee

Mo./Day/Yr. Mo./Day/Yr.

Mo./Day/Yr. Mo./Day/Yr.

Mo./Day/Yr.

Mo./Day/Yr.

Mo./Day/Yr.

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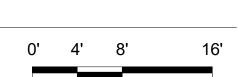
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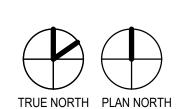
**DEVELOPMENT FACILITATION TEAM** 

PROJECT NUMBER: PR-2023-009382 APPLICATION NUMBER: SI-2024-00739

PROJECT NAME: City Multigenerational Center At 10751 Cibola Loop NW







	ROOFTOP AIR HANDLING UNIT (GAS/DX)																											
							SUPPLY FA	N		COOLIN	G PERFO	DRMANCE BAS	SE ON 95 DEGREE	AMBIE	NT TEM	<b>IPERAT</b>	ΓURE	GAS	HEAT EXCHANGER				FILTER			El	LECTRICA	AL
											EER	NET TOTAL	NET SENSIBLE	EAT	EAT	LAT	LAT			EAT	LAT	MINIMUM		OPERATING	1			
		TRANE					EXT. SP	FAN		NOMINAL	@	COOLING	COOLING	DB	WB	DB	WB	AT SEA LEVEL	AT ALTITUDE		DB	OUTSIDE		WEIGHT				
DIMENSIONS DATA	SYMBOL	MODEL NO.	TYPE	AREA SERVED	CFM	RPM	(IN. WC)	HP	DRIVE	(TONS)	AHRI	(MBH)	(MBH)	(°F)	(°F)	(°F)	(°F)	(MBH)	(MBH)	(°F)	(°F)	AIR (CFM)	TYPE	(LBS.)	V	PH   I	IZ M	ICA MOCP
53"W x 88"L x 51"T	RTU-1	YHJ102	VERTICAL SUPPLY/RETURN	113 MULTIPURPOSE	3650	1158	0.5	3	DIRECT	8.5	12.1	83.7	83.0	75	57	50	48	200	127.7	60	98	600	MERV 13	1300	460	3	30 7	25 30
53"W x 88"L x 51"T	RTU-2	YHJ072	VERTICAL SUPPLY/RETURN	113 MULTIPURPOSE	2280	861	0.5	3	DIRECT	6	12.1	62.9	57.9	79	60	51	49	150	95.7	55	101	550	MERV 13	1300	460	3	30	18 20
44"W x 70"L x 36"T	RTU-3	YHC048	VERTICAL SUPPLY/RETURN	1002 ENTRY LOBBY- SOUTH	1700	795	0.5	1	DIRECT	4	13.5	39.9	32.9	73	57	52	48	80	52.0	66	101	250	MERV 13	1100	460	3	30	11 15
53"W x 88"L x 51"T	RTU-4	YHJ072	VERTICAL SUPPLY/RETURN	1004/1005 CORRIDOR	2400	887	0.5	3	DIRECT	6	12.1	59.0	53.6	73	57	49	47	150	95.7	68	111	350	MERV 13	1300	460	3	30 ′	18 20
44"W x 70"L x 36"T	RTU-5	YHC060	VERTICAL SUPPLY/RETURN	1002 ENTRY LOBBY- NORTH	2000	891	0.5	1	DIRECT	5	12.8	49.4	47.1	77	56	52	45	130	83.9	63	112	300	MERV 13	1100	460	3	30 ′	12 15
44"W x 70"L x 36"T	RTU-6	YHC036	VERTICAL SUPPLY/RETURN	101 CLASSROOM	1080	738	0.5	.75	DIRECT	3	12.7	31.8	30.5	83	59	50	46	80	51.2	38	97	510	MERV 13	900	460	3	30 ′	10 15
44"W x 70"L x 36"T	RTU-7	YHC036	VERTICAL SUPPLY/RETURN	107 CLASSROOM	1060	738	0.5	.75	DIRECT	3	12.7	31.7	31.5	83	58	49	45	80	51.2	38	97	560	MERV 13	900	460	3	30	10 15
44"W x 70"L x 36"T	RTU-8	YHC036	VERTICAL SUPPLY/RETURN	102 ADMIN	1000	738	0.5	.75	DIRECT	3	12.7	31.8	30.5	79	59	50	46	80	51.2	50	97	310	MERV 13	900	460	3	30 ′	10 15

STANDARD ROOF CURB- MINUMUM 24" HIGH, INLET HOOD, STD REFRIG CONTROLS, FROSTAT AND CRANKCASE HEATER, PACKAGED LOW VOLT CONTROLS, 100% ECONOMIZER - DRY BULB, COMMUNICATIONS, STD. CONDENSOR COIL W/ HAIL GUARD, NON-POWERED CONVENIENCE OUTLET, STARTER/ DISCONNECT

													EXH	HAUST F	ANS							
	GREENHECK S.P. FAN MOTOR DATA INLET SOUND POWER BY OCTAVE BAND																OPERATING					
SYMBO	MODEL NO.	AREA SERVED	TYPE	CFM	(IN. WC)	<b>RPM</b>	BHP	HP	VOLT	PH	HZ F	LA   63	3 HZ 1	125 HZ 2	250 HZ	500 HZ	1000 HZ 2	000 HZ	4000 HZ	8000 HZ	WEIGHT (LBS	NOTES
EF-1	GB-120-5	MAIN RESTROOM GROUPS	CENTRIFUGAL DOWNBLAST	1270	0.8	1528	0.32	1/2	115	1	60 9	8.0	72	75	80	73	65	65	60	57	100	PROVIDE 120V MOTORIZED DAMPER. INSTALL ON 24" ROOF CURB. REFER TO DETAIL B3/M-501.

	INDOOR SPLIT SYSTEM SCHEDULE															
	MITSUBISHI RATED COOLING RATED HEATING SOUND															
	INDOOR MODEL			REFRIG	AIRFLOW		,	EAT DB	EAT WB	LEVEL					WEIGHT	
SYMBOL	NUMBER	AREA SERVED	TYPE	TYPE	(CFM)	(BTUH)	@ 17° F	(F)	(F)	(dBA)	EER/SEER	VOLT	PH	HZ	(LBS)	HEIGHT / WIDTH / DEPTH (IN)
AC-1	PKA-A36KA7	111 IT	HEAT PUMP	R-410A	920	36,000	22,400	80	67	49	10.8/18.8	208	1	60	46	46-1/16" X 11-5/8" X 14-3/8"
AC-2	PKA-A36KA7	108 ELECTRICAL	HEAT PUMP	R-410A	920	36,000	22,400	80	67	49	10.8/18.8	208	1	60	46	46-1/16" X 11-5/8" X 14-3/8"
AC-3	PKA-A18HA7	113A IT	HEAT PUMP	R-410A	425	18,000	11,300	80	67	43	9.9/18.5	208	1	60	30	35-3/8" X 9-13/16" X 11-5/8"
AC-4	PEAD-A36AA7	SECOND FLOOR SHELL	HEAT PUMP	R-410A	1200	36,000	20,800	80	67	42	12.0/19.1	208	1	60	86	55-1/8" X 28-7/8" X 9-7/8"

INDOOR UNIT SHALL BE ELECTRICALLY SERVED FROM THE OUTDOOR UNIT PER THE MANUFACTURER'S ELECTRICAL REQUIREMENTS AND DIAGRAMS. PROVIDE REFRIGERANT PIPING AND ALL ACCESSORIES FOR A COMPLETE AND FUNCTIONAL SYSTEM PER MANUFACTURER'S INSTALLATION MANUAL. PROVIDE WIRELESS T-STAT, CONDENSATE LIFT PUMP.

	OUTDOOR SPLIT SYSTEM SCHEDULE																	
	MITSUBISHI RATED COMPRESSOR DATA ELECTRICAL DATA												SOUND					
	OUTDOOR		INDOOR UNIT		CAPACITY	AMBIENT		REFRIG.	MAX PIPING	LIQUID	SUCTION					<b>POWER</b>	WEIGHT	
SYMBOL	MODEL NUMBER	LOCATION	SERVED	TYPE	(BTUH)	DB (F)	TYPE	TYPE	LENGTH	SIZE	SIZE	VOLTS P	HZ	MCA	MOP	(dBA)	(LBS)	WIDTH X DEPTH X HEIGHT (IN.)
CU-1	PUZ-A36NKA7	ROOF	AC-1	HEAT PUMP	36,000	95	INVERTOR	R-410A	165'	3/8"	5/8"	208 1	60	25	31	52	215	41-5/16" X 14-3/16" X 52-11/16"
CU-2	PUZ-A36NKA7	ROOF	AC-2	HEAT PUMP	36,000	95	INVERTOR	R-410A	165'	3/8"	5/8"	208 1	60	25	31	52	215	41-5/16" X 14-3/16" X 52-11/16"
CU-3	PUZ-A18NKA7	ROOF	AC-3	HEAT PUMP	18,000	95	INVERTOR	R-410A	100'	1/4"	1/2"	208 1	60	11	28	46	100	34-1/4" X 11-13/16" X 24-13/16"
CU-4	PUZ-A36NKA7	ROOF	AC-4	HEAT PUMP	36,000	95	INVERTOR	R-410A	165'	3/8"	5/8"	208 1	60	25	31	52	215	41-5/16" X 14-3/16" X 52-11/16"

INDOOR UNIT SHALL BE ELECTRICALLY SERVED FROM THE OUTDOOR UNIT PER THE MANUFACTURER'S ELECTRICAL REQUIREMENTS AND DIAGRAMS. PROVIDE REFRIGERANT PIPING AND ALL ACCESSORIES FOR A COMPLETE AND FUNCTIONAL SYSTEM PER MANUFACTURER'S INSTALLATION MANUAL. PROVIDE WIND BAFFLE LOW AMBIENT KIT.
PROVIDE HAIL GUARD, FILTER SCREEN AND TRACK MOUNT SYSTEM BY AIR SOLUTIONS. INSTALL PER MANUFACTURER'S INSTALLATION MANUAL.

							ELECTRIC	UNIT H	EATER	S				
			AIRFLOW	TEMP. RISE	HEATING	MOTOR	MOTOR				MCA		WEIGHT	
SYMBOL	TRANE MODEL NO.	LOCATION	(CFM)	(°F)	(KW)	HP	RPM	V	PH	HZ	(A)	MOP	(LBS.)	NOTES
EUH-1	UHEC-031CACA	109 FIRE RISER	400	26	3	1/125	1550	277	1	60	11.9	15	30	PROVIDE HANGING BRACKET AND WALL MOUNTED THERMOSTAT
EUH-2	UHEC-031CACA	110 MECHANICAL	400	26	3	1/125	1550	277	1	60	11.9	15	30	PROVIDE HANGING BRACKET AND WALL MOUNTED THERMOSTAT
EUH-3	UHEC-031CACA	112 STORAGE	400	26	3	1/125	1550	277	1	60	11.9	15	30	PROVIDE HANGING BRACKET AND WALL MOUNTED THERMOSTAT

					ELECTRIC CEILING HEATER														
			AIRFLOW		HEATING	EL	<b>LECTRI</b>	CAL DA	ATA	WEIGHT									
SYMBOL	QMARK MODEL NO.	LOCATION	(CFM)	BTU/H	(KW)	V	PH	HZ	AMPS	(LBS.)	NOTES								
ECH-1	EFF3007	1001 VESTIBULE	150	10,239	3	277	1	60	10.8	25	PROVIDE BUILT-IN THERMOSTAT. INSTALL PER MANUFACTURER'S INSTALLATION MANUAL MAINTAINING ALL MANUFACTURER'S REQUIRED CLEARANCES								

		PIPE PENETR	ATION HOUSING	
SYMBOL	THE VAULT MODEL NO.	LOCATION	UNITS SERVED	NOTES
PH-1	"AW" SERIES	SECOND FLOOR ROOF	CU-1. CU-2, CU-4	INSTALL PER DETAIL A3/M-501.
PH-2	"AW" SERIES	MULTIPURPOSE ROOF	CU-3	INSTALL PER DETAIL A3/M-501.

COORDINATE MODEL SIZE WITH NUMBER OF EXIT SEALS NEEDED. INSTALL PER MANUFACTURER'S INSTALLATION MANUAL.

CONTRACTOR SHALL PROVIDE COMPLETE HVAC MAINTENANCE FOR THE FIRST YEAR AFTER CERTIFICATE OF OCCUPANCY AND ARE RESPONSIBLE FOR THE MAINTENANCE OF ALL INSTALLED HVAC UNITS FOR THE FIRST YEAR AFTER CERTIFICATE OF OCCUPANCY IS ISSUED. REFER TO SPECIFICATION 23 0500.

ALL SELECTIONS ARE BASED ON

DEVELOPMENT FACILITATION TEAM

PROJECT NUMBER: PR-2023-009382

APPLICATION NUMBER: SI-2024-00739

PROJECT NAME: City Multigenerational Center At 10751 Cibola Loop NW

				GRILLES A	AND DIFFUSER	RS			
SYMBOL	MANUFACTURER & MODEL NO.	TYPE	FRAME STYLE	FACE DIMENSIONS (INCH)	NECK DIMENSIONS (INCH)	CFM RANGE	T.P. (IN. W.G.)	MAX NC	NOTES
	PRICE SCDA, TYPE 3	SUPPLY DIFFUSER	LAY-IN CEILING	12x12, 24x24	6	40-130	0.02-0.06	24	
SD-1	PRICE SCDA, TYPE 3	SUPPLY DIFFUSER	LAY-IN CEILING	12x12, 24x24	8	131-230	0.02-0.06	28	
3D-1	PRICE SCDA, TYPE 3	SUPPLY DIFFUSER	LAY-IN CEILING	24x24	10	231-330	0.03-0.06	30	
	PRICE SCDA, TYPE 3	SUPPLY DIFFUSER	LAY-IN CEILING	24x24	12	331-430	0.03-0.06	30	
	PRICE SCDA, TYPE 1	SUPPLY DIFFUSER	FIXED CEILING	12x12, 24x24	6	40-130	0.02-0.09	30	PROVIDE OBD
SD-2	PRICE SCDA, TYPE 1	SUPPLY DIFFUSER	FIXED CEILING	12x12, 24x24	8	131-230	0.02-0.09	30	PROVIDE OBD
3D-Z	PRICE SCDA, TYPE 1	SUPPLY DIFFUSER	FIXED CEILING	24x24	10	231-330	0.02-0.08	30	PROVIDE OBD
	PRICE SCDA, TYPE 1	SUPPLY DIFFUSER	FIXED CEILING	24x24	12	331-430	0.02-0.08	30	PROVIDE OBD
	PRICE RCDA	ROUND SUPPLY	FIXED CEILING	13	6	40-130	0.02-0.09	30	
SD-3	PRICE RCDA	ROUND SUPPLY	FIXED CEILING	18	8	131-230	0.02-0.09	30	
30-3	PRICE RCDA	ROUND SUPPLY	FIXED CEILING	22	10	231-330	0.02-0.08	30	
	PRICE RCDA	ROUND SUPPLY	FIXED CEILING	27	12	331-430	0.02-0.08	30	
SR-1	PRICE 520	SIDEWALL SUPPLY	FLAT MARGIN	SEE PLAN	SEE PLANS	SEE PLANS	0.03-0.06	26	
SR-2	PRICE SDGE	DUCT SUPPLY	DUCT MOUNTED	SEE PLAN	SEE PLANS	SEE PLANS	0.03-0.06	26	PROVIDE AIR SCOOP
LSD-1	PRICE SDBI 100	LINEAR SUPPLY	TYPE 14 FRAME	4' LONG	10	SEE PLANS	0.03-0.06	30	4 SLOT, 1" SLOT, PROVIDE INSULATED PLENUM
LSD-2	PRICE SDBI 100	LINEAR SUPPLY	TYPE 2 FRAME	4' LONG	10	SEE PLANS	0.03-0.06	30	4 SLOT, 1" SLOT, PROVIDE INSULATED PLENUM
LSD-3	PRICE SDBI 75	LINEAR SUPPLY	TYPE 14 FRAME	3' LONG	8	SEE PLANS	0.03-0.06	30	3 SLOT, 3/4" SLOT, PROVIDE INSULATED PLENUM WITH CABLE OPERATED DAMPER, PRICE MODEL VCR85C.
LSD-4	PRICE SDBI 100	LINEAR SUPPLY	TYPE 2 FRAME	5' LONG	10	SEE PLANS	0.03-0.06	30	4 SLOT, 1" SLOT, PROVIDE INSULATED PLENUM WITH CABL OPERATED DAMPER, PRICE MODEL VCR85C.
LSD-5	PRICE SDBI 100	LINEAR SUPPLY	TYPE 14 FRAME	4' LONG	10	SEE PLANS	0.03-0.06	30	4 SLOT, 1" SLOT, PROVIDE INSULATED PLENUM WITH CABL OPERATED DAMPER, PRICE MODEL VCR85C.
LSD-6	PRICE SDBI 100	LINEAR SUPPLY	TYPE 2 FRAME	4' LONG	10	SEE PLANS	0.03-0.06	30	4 SLOT, 1" SLOT, PROVIDE INSULATED PLENUM WITH CABL OPERATED DAMPER, PRICE MODEL VCR85C.
RG-1	PRICE 80	RETURN GRILLE	LAY-IN CEILING	24x24, 24x12, 12x12	SEE PLANS	-	N/A	N/A	
RG-2	PRICE 80	RETURN GRILLE	FIXED CEILING	24x24, 24x12, 12x12	SEE PLANS	-	N/A	N/A	
RG-3	PRICE 530	RETURN GRILLE	SIDEWALL	SEE PLAN	SEE PLANS	-	N/A	N/A	
EG-1	PRICE 80	EXHAUST GRILLE	LAY-IN CEILING	24x24, 24x12, 12x12	SEE PLANS	SEE PLANS	0.01-0.08	25	
EG-2	PRICE 80	EXHAUST GRILLE	FIXED CEILING	24x24, 24x12, 12x12	SEE PLANS	SEE PLANS	0.01-0.08	25	
EG-3	PRICE 530	EXHAUST GRILLE	SIDEWALL	SEE PLAN	N/A	SEE PLANS	0.01-0.08	25	PROVIDE OBD

<b>fbt architects</b> 6501 Americas Parkway NE, Suite 300 Albuquerque, NM 87110  505.883.5200 www.fbtarch.com	BENCH MARKS									
CIVIL High Mesa 6010-B Midway Park Blvd NE Albuquerque, NM 87109 p_505.345.4250	SURVEY INFORMATION	FIELD NOTES	BY DATE							
LANDSCAPE Groundwork Studio 6501 Americas Parkway NE, Suite 350 Albuquerque, NM 87110 p_505.212.9126  STRUCTURAL Chavez-Grieves Consulting Engineers, Inc.	ENGINEER		ON.	/ ~	IR IN	M E	15)		# ( ) ( ) ( ) ( ) ( ) ( ) ( ) ( ) ( ) (	
4700 Lincoln Road NE, Suite 102 Albuquerque, NM 87109 p_505.344.4080  M/E/P/FP Bridgers & Paxton 4600-C Montgomery Blvd NE Albuquerque, NM 87109 p_505.883.4111	SEAL	18	lug	Display Da 200 110	gitally self-like distribution of the control of th	signed siti	L E	WG!		
LIGHTING Oldner Lighting 4600 C Montgomery Blvd. NE Albuquerque, NM 87109 505.883.4111 www.bpce.com  LIGHTING Oldner Lighting 4645 Greenville Ave, Studio B Dallas, TX 75206 p_310.450.1733					REMARKS			DATE	DATE	DATE
INTERIORS Studio M 6501 Americas Parkway NE, Suite 302 Albuquerque, NM 87110 p_505.243.9287	1	2	3	4	IO. DATE	VISIONS	SIGN	SIGNED BY:	AWN BY:	ECKED BY:

CITY OF ALBUQUERQUE

MULTIGENERATIONAL CENTER

CONSTRUCTION DOCUMENTS (FOR DFT SUBMITTAL ONLY)

City Engineer Approval

Zone Map No.

A-13-Z

SHEET TITLE:

MECHANICAL SCHEDULES

DWG. M-701

Mo./Day/Yr. Mo./Day/Yr.

Sheet

PROJECT TITLE:

June 07, 2024

Design Review Committee

P7882.16

DRAWING TITLE:

City Project No.

10751 Cibola Loop NW Albuquerque, NM 87114

COA CIBOLA LOOP