





DEVELOPMENT FACILITATION TEAM (DFT) APPLICATIONS

Effective 11/16/2023

Please check the appropriate box(es) and retaine of application.	fer to supplemental	forms for submittal requ	irements. All fees must be paid at the		
MISCELLANEOUS APPLICATION	NS .	☐ Extension of Infrastructure	re List or IIA (Form S3)		
Site Plan Administrative DFT (Forms SP & P2)		PRE-APPLICATIONS			
☐ Final EPC Sign-off for Master Development/Site Plant	ans - EPC (Form P2)	☐ Sketch Plat Review and 0	Comment (Form S3)		
☐ Infrastructure List or Amendment to Infrastructure L	ist (Form S3)	☐ Sketch Plan Review and	Comment (Form S3)		
☐ Temporary Deferral of S/W (Form S3)			APPEAL		
☐ Extension of IIA: Temp. Def. of S/W (Form S3)		☐ Decision of Site Plan Adn	ninistrative DFT (Form A)		
BRIEF DESCRIPTION OF REQUEST					
Proposed site improvements for a ne accessory drive-thru on the endcap.					
APPLICATION INFORMATION					
Applicant/Owner: Tracy D. Knapp, V.P. of Developmen	t, Alvarado Developmen	t, LLC	Phone: 678-458-9013		
Address: 5654 Greenwood Village Plaza Blvd.		_	Email: TDKnapp@TeamARN.com		
City: Greenwood Village		State: CO	Zip: 80111		
Professional/Agent (if any): MRV Architects, Inc.		Phone: 224-318-2140			
Address: 5105 Tollview Drive, Suite 201			Email: davids@mrvarch.com		
City: Rolling Meadows		State: L			
Proprietary Interest in Site:		List all owners:			
SITE INFORMATION (Accuracy of the existing legal	I description is crucia				
Lot or Tract No.: 1D		Block:	Unit:		
Subdivision/Addition: Town of Astrico Grant, Projected Section 3			UPC Code: 100905515936920328		
Zone Atlas Page(s): M9	Existing Zoning: NR- # of Proposed Lots: 1	<u> </u>	Proposed Zoning NR-C Total Area of Site (Acres): 1.51		
# of Existing Lots: LOCATION OF PROPERTY BY STREETS	# of Proposed Lots.		Total Area of Site (Acies). 1,51		
Site Address/Street: 1115 Snow Vista Blvd.	Between: Cogo D	d. / De Vargas R	and: Benavides Rd.		
CASE HISTORY (List any current or prior project a					
CASE MISTORY (List any current of prior project a	no case number(s) un	at may be televant to your t			
I certify that the information) have included here and	sent in the required no	tice was complete, true, and a	accurate to the extent of my knowledge.		
Signature: ///			Date: 9/27/2024		
Printed Name: Tracy D. Knapp ☐ Applicant or ☐ Agent					

FORM P2 Page 1 of 3

FORM P2: SITE PLAN ADMINISTRATIVE – Development Facilitation Team (DFT) as of 12/25/2022 _ SITE PLAN ADMINISTRATIVE – DFT

A Single PDF file of the complete application including all documents being submitted must be emailed to PLNDRS@cabq.gov. Zipped files or those over 9 MB cannot be delivered via email, in which case the PDF must be provided to City Staff using other online resources such as Dropbox or FTP. The PDF shall be organized in the number order below. Divide the PDF with a title sheet for each of the three documentation sections in **bold** below.

CITE	n i /	 $D \cap C$	UMF	
NII E				

1) DFT Application form completed, signed, and dated
2) Form P2 with all the submittal items checked/marked
3) Form SP with signatures from Hydrology, Transportation, and ABCWUA
4) Zone Atlas map with the entire site clearly outlined and labeled
5) Site Plan and related drawings (include a Site Plan key of the sheets submitted)
6) Copy of the original approved Site Plan or Master Development Plan (for amendments to or Extensions of the Site Plan)
7) Infrastructure List, if required for building of public infrastructure
8) Sensitive Lands Site Analysis for new site design in accordance with IDO Section 5-2(C) (The Sensitive Lands Site Analysis form can be obtained online at): <pre>https://documents.cabq.gov/planning/development-review-board/Sensitive_lands_analysis_form.pdf</pre>
9) Responses to climatic and geographic responsive design considerations (Recommended to promote sustainability, but not required. The Climatic and Geographic Responsiveness form can be obtained online at): https://documents.cabq.gov/planning/IDO/SubmittalFormIDO5-2(D)ClimaticGeographic Responsiveness.pdf
SUPPORTIVE DOCUMENTATION
10) Completed Site Plan Checklist
11) Letter of authorization from the property owner if application is submitted by an agent
12) Justification letter describing and justifying the request per the criteria in IDO Section 16-6-5(G)(3)
13) Explanation and justification of requested deviations, if any, in accordance with IDO Section 14- 16-6-4(P). Note: If requesting more than allowed by deviation, a Variance – ZHE or Waiver –DHO will be required, as applicable
14) Sites 5 acres or greater: Archaeological Certificate in accordance with IDO Section 14-16-6-5(A) (not required for Extension)

15) Landfill disclosure statement per IDO Section 14-16-6-4(S)(5)(d)(2)(d) if site is within a designated landfill buffer zone 16) Architectural Review Committee approval letter if the site is located within a Master Development Plan area or a Framework Plan area **PUBLIC NOTICE DOCUMENTATION** ____ 17) Sign Posting Agreement _____ 18) Proof of a Pre-Submittal Neighborhood Meeting per IDO 6-4(C)(1)(b) for new building or multiple new buildings that include a total of more than 100 multi-family residential dwelling units or more than 50,000 square feet of non-residential development Office of Neighborhood Coordination neighborhood meeting inquiry response __ Proof of email with read receipt OR Certified Letter offering meeting to applicable associations __ Completed neighborhood meeting request form(s) If a meeting was requested or held, copy of sign-in sheet and meeting notes 19) Required Content of Notice at Submittal per IDO Section 14-16-6-4(K)(1) (not required for an extension) Office of Neighborhood Coordination notice inquiry response

___ Completed notification form(s), proof of additional information provided in accordance with

Proof of emailed notice to affected Neighborhood Association representatives

IDO Section 6-4(K)(1)(b)

FORM P2

Page 2 of 3

FORM P2 Page **3** of **3**


_ FINAL SIGN-OFF FOR MASTER DEVELOPMENT PLANS AND SITE PLANS — EPC

A Single PDF file of the complete application including all documents being submitted must be emailed to PLNDRS@cabq.gov prior to making a submittal. Zipped files or those over 9 MB cannot be delivered via email, in which case the PDF must be provided to City Staff using other online resources such as Dropbox or FTP. The PDF shall be organized in the number order below.


1) DFT Application form completed, signed, and dated
2) Form P2 with all the submittal items checked/marked
3) Zone Atlas map with the entire site clearly outlined and labeled
4) Site Plan and related drawings
5) Infrastructure List, if require
6) Copy of EPC Notice of Decision and letter explaining how each EPC condition has been met
7) Letter of authorization from the property owner if application is submitted by an agent
8) Solid Waste Department signature on Site Plan
9) Signed Form DRWS Drainage Report, Grading and Drainage Plan, and Water & Sewer Availability Statement filing information
10) Approved Grading and Drainage Plan
11) Copy of Site Plan with Fire Marshal's stamp, i.e. "Fire 1" plan (not required for Master Development Plans)


	Blvd. SW Albuquerque, NM 87121
Request Description: Proposed site improvements for	for new tenant building with Taco Bell quick-service restaurant with accessory drive-thru at endcap.
□ <u>Hydrology:</u>	
 Sensitive Lands Analysis (5-2(C)) Grading and Drainage Plan AMAFCA Bernalillo County NMDOT MRGCD Hydrology Department 	Approved X NA X Approved NA Approved X NA Approved X NA Approved X NA Approved X NA 7/8/2024 Date
□ <u>Transportation:</u>	
 Traffic Circulations Layout (TCL) Traffic Impact Study (TIS) Neighborhood Impact Analysis (NIA) Bernalillo County MRCOG NMDOT MRGCD Emet Umyo Transportation Department 	X Approved NA Approved X NA 7/9/2024 Date NA
□ Albuquerque Bernalillo County Wa	ater Utility Authority (ABCWUA):
 Request for Availability submitted? Availability Statement/Serviceability L Note: Commitment for service is requ 	
ABCWUA	Date
 □ Infrastructure Improvements Agreement □ Solid Waste Department Signature on the □ Fire Marshall Signature on the Plan 	· , · ·

^{*} Prior to Final Site Plan approval submittals (include a copy of the recorded IIA)

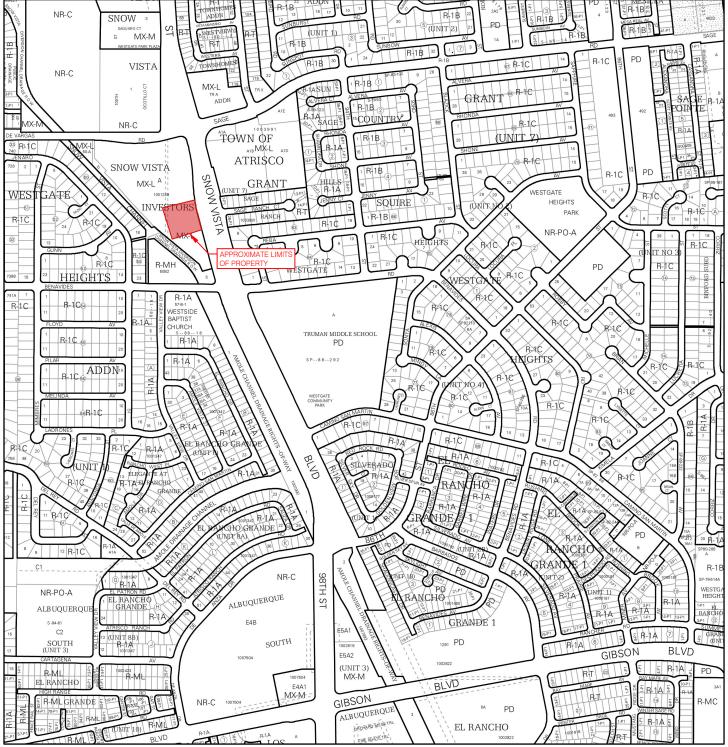

For more details about the Integrated Development Ordinance visit: http://www.cabq.gov/planning/codes-policies-regulations/integrated-development-ordinance

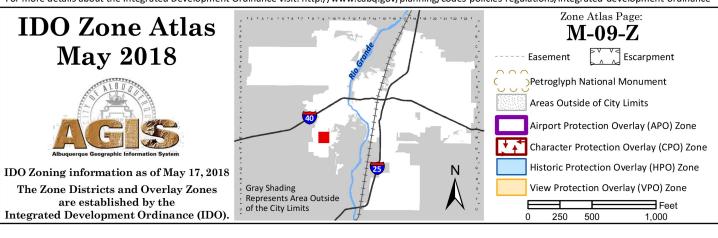

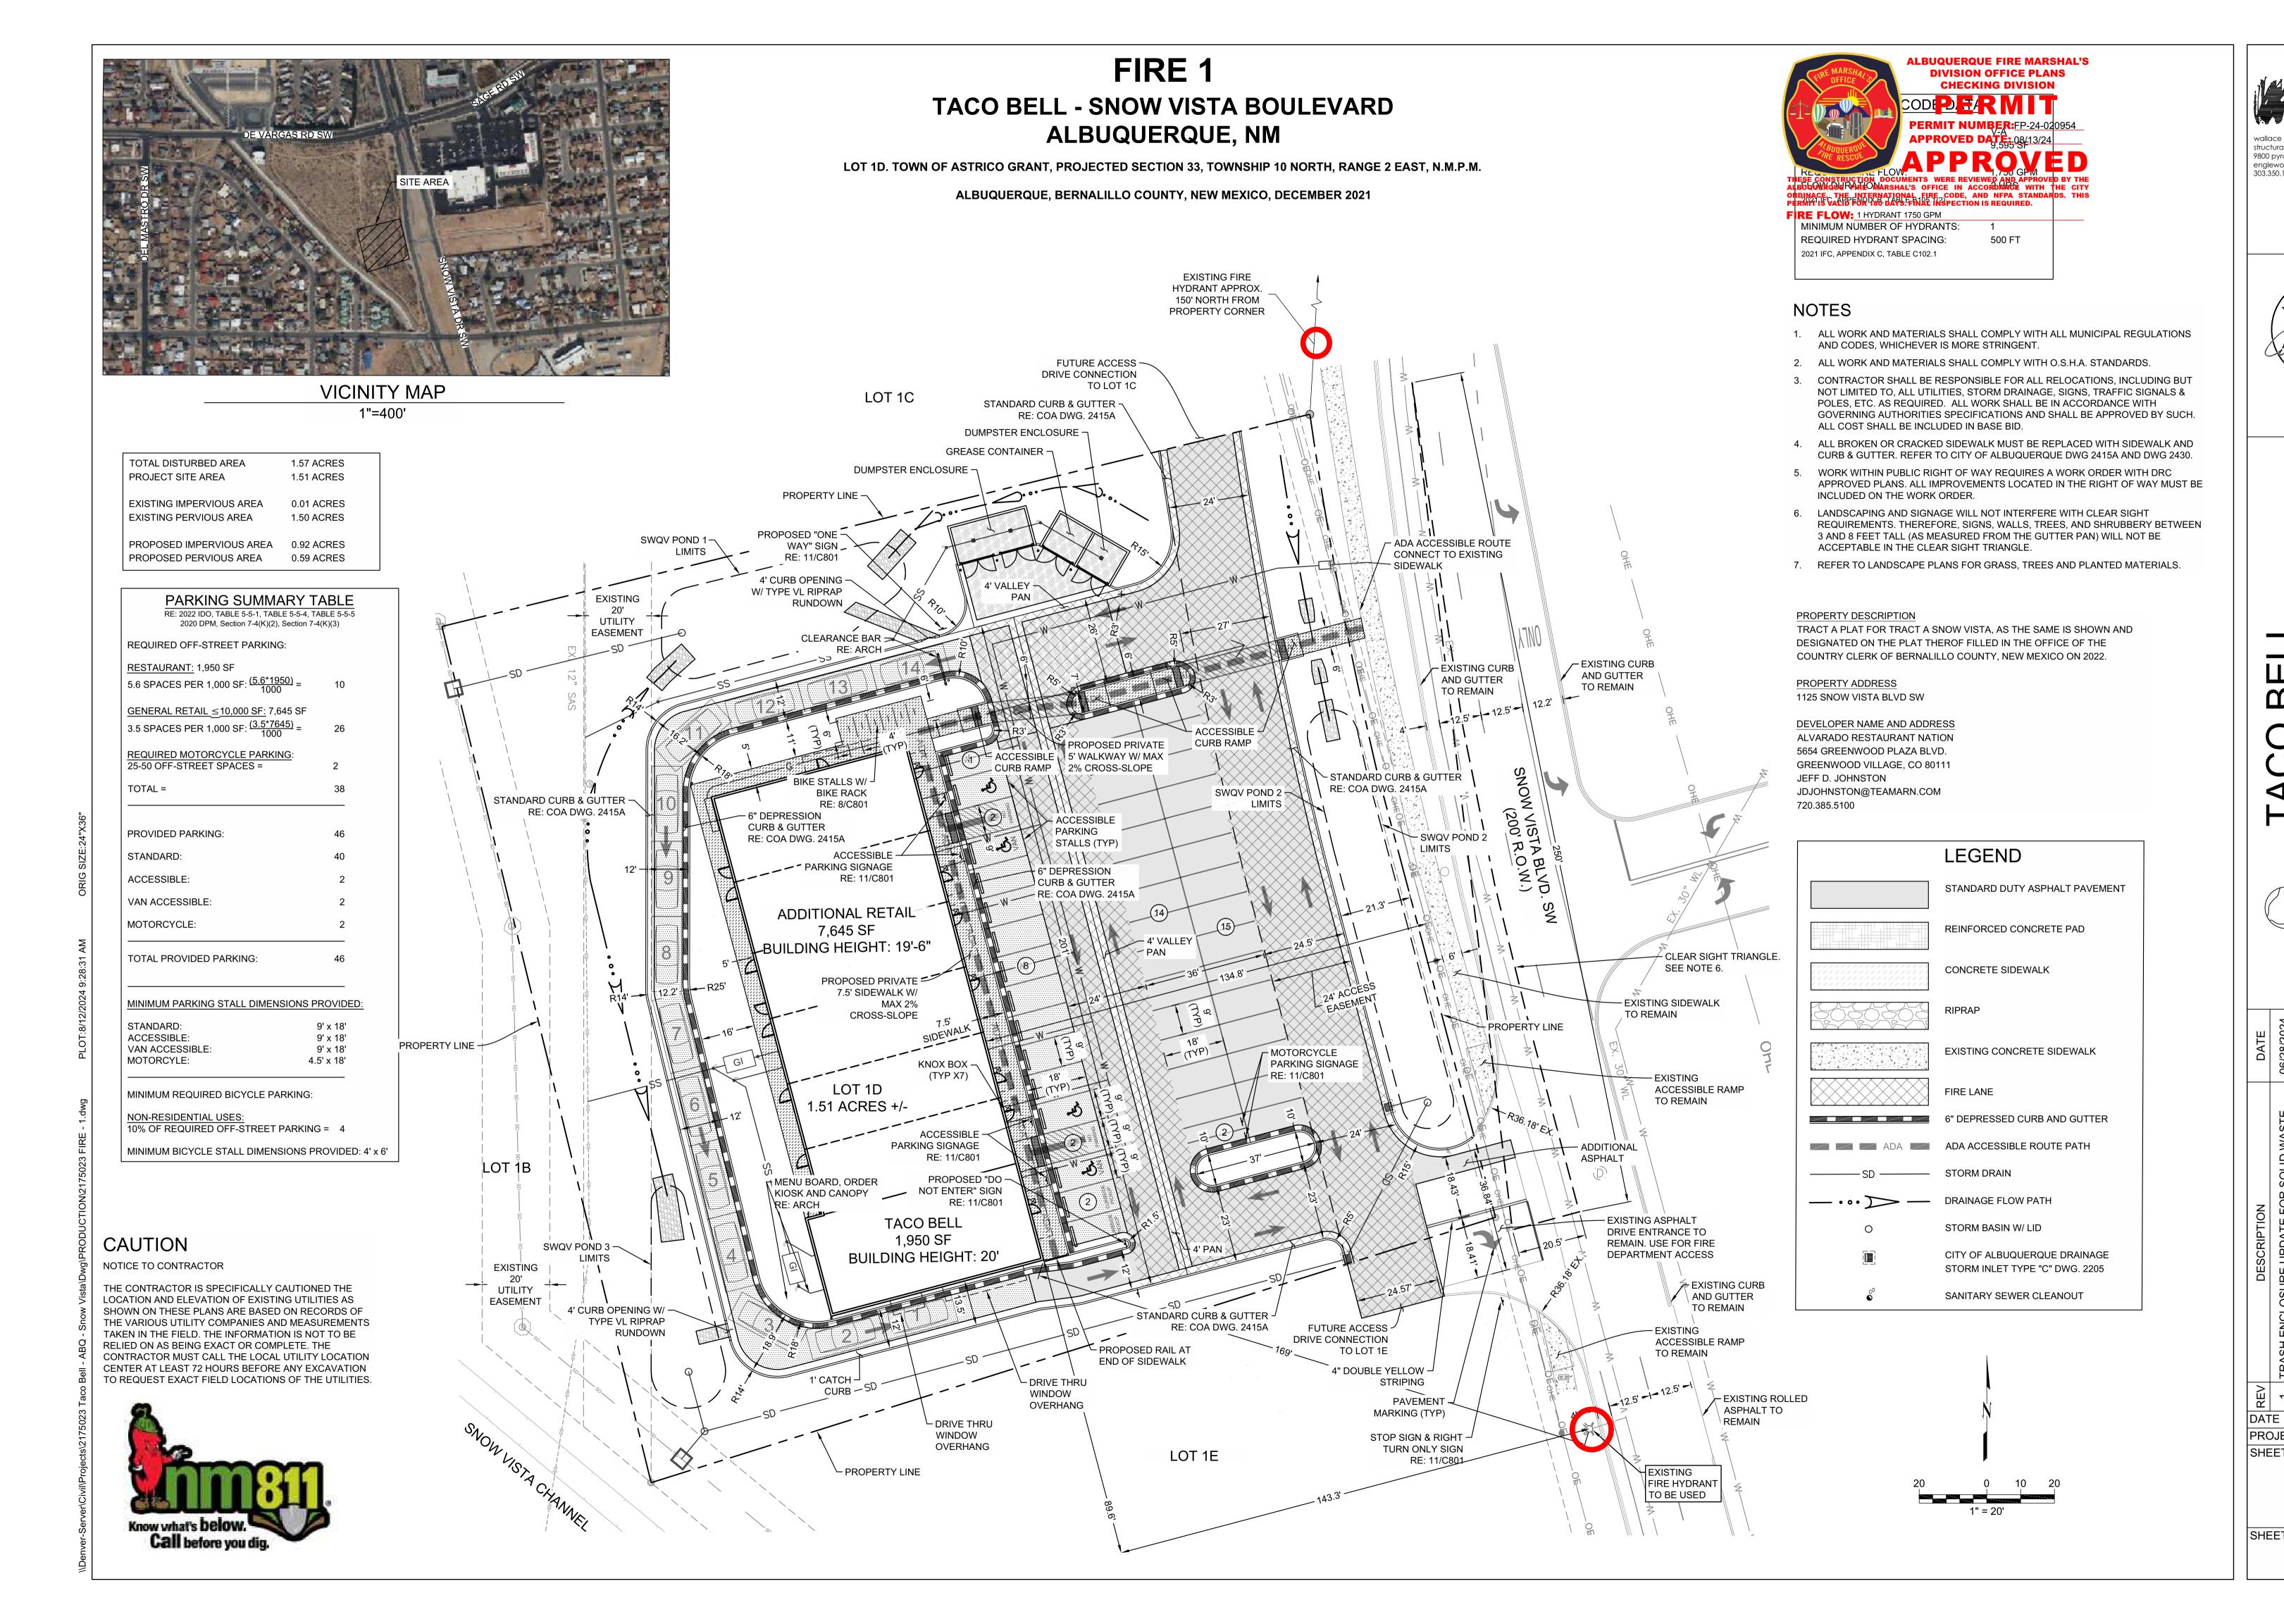



wallace design collective, pc structural civil landscape survey 9800 pyramid court, suite 350 englewood, co 80112

structural civil landscape survey 9800 pyramid court, suite 350 englewood, co 80112 303.350.1690 800.364.5858



08/12/2024

ACC BELL
TH & SAGE

DESCRIPTION
OSURE UPDATE FOR SOLID WASTE
06/28/2

08/12/2024

PROJECT NO. 2175023.03
SHEET NAME

FIRE 1

F100

Call before you dig

ACCESSIBLE RAMP

TO REMAIN

structural · civil · landscape · survey 9800 pyramid court, suite 350 englewood, co 80112 303.350.1690 · 800.364.5858



07/23/2024 PROJECT NO. 2175023.03

TRAFFIC **CIRCULATION** LAYOUT

TACO BELL - SNOW VISTA BOULEVARD ALBUQUERQUE, NM

LOT 1D. TOWN OF ASTRICO GRANT, PROJECTED SECTION 33, TOWNSHIP 10 NORTH, RANGE 2 EAST, N.M.P.M.

ALBUQUERQUE, BERNALILLO COUNTY, NEW MEXICO, DECEMBER 2021

DESIGNATED ON THE PLAT THEROF FILLED IN THE OFFICE OF THE COUNTRY CLERK OF BERNALILLO COUNTY, NEW MEXICO ON 2022.

TRACT A PLAT FOR TRACT A SNOW VISTA, AS THE SAME IS SHOWN AND

DEVELOPER NAME AND ADDRESS
ALVARADO RESTAURANT NATION
5654 GREENWOOD PLAZA BLVD.
GREENWOOD VILLAGE, CO 80111

GREENWOOD VILLAGE, CO 80111
JEFF D. JOHNSTON
JDJOHNSTON@TEAMARN.COM
720.385.5100

PROPERTY DESCRIPTION

PROPERTY ADDRESS

1125 SNOW VISTA BLVD SW

GRADING ELEVATION ABBREVIATIONS

FF FINISHED FLOOR

FG FINAL GRADE

FL FLOW LINE

TS TOP OF SIDEWALK

GL GUTTER LINE

TG TOP OF GRATE

TP TOP OF PAVEMENT

HP HIGH POINT

LP LOW POINT

TOTAL DISTURBED AREA	1.57 ACRES
PROJECT SITE AREA	1.51 ACRES
EXISTING IMPERVIOUS AREA	0.01 ACRES
EXISTING PERVIOUS AREA	1.50 ACRES
PROPOSED IMPERVIOUS AREA	0.92 ACRES
PROPOSED PERVIOUS AREA	0.59 ACRES

TG 5148.73


CAUTION

NOTICE TO CONTRACTOR

THE CONTRACTOR IS SPECIFICALLY CAUTIONED THE LOCATION AND ELEVATION OF EXISTING UTILITIES AS SHOWN ON THESE PLANS ARE BASED ON RECORDS OF THE VARIOUS UTILITY COMPANIES AND MEASUREMENTS TAKEN IN THE FIELD. THE INFORMATION IS NOT TO BE RELIED ON AS BEING EXACT OR COMPLETE. THE CONTRACTOR MUST CALL THE LOCAL UTILITY LOCATION CENTER AT LEAST 72 HOURS BEFORE ANY EXCAVATION



Call before you dig

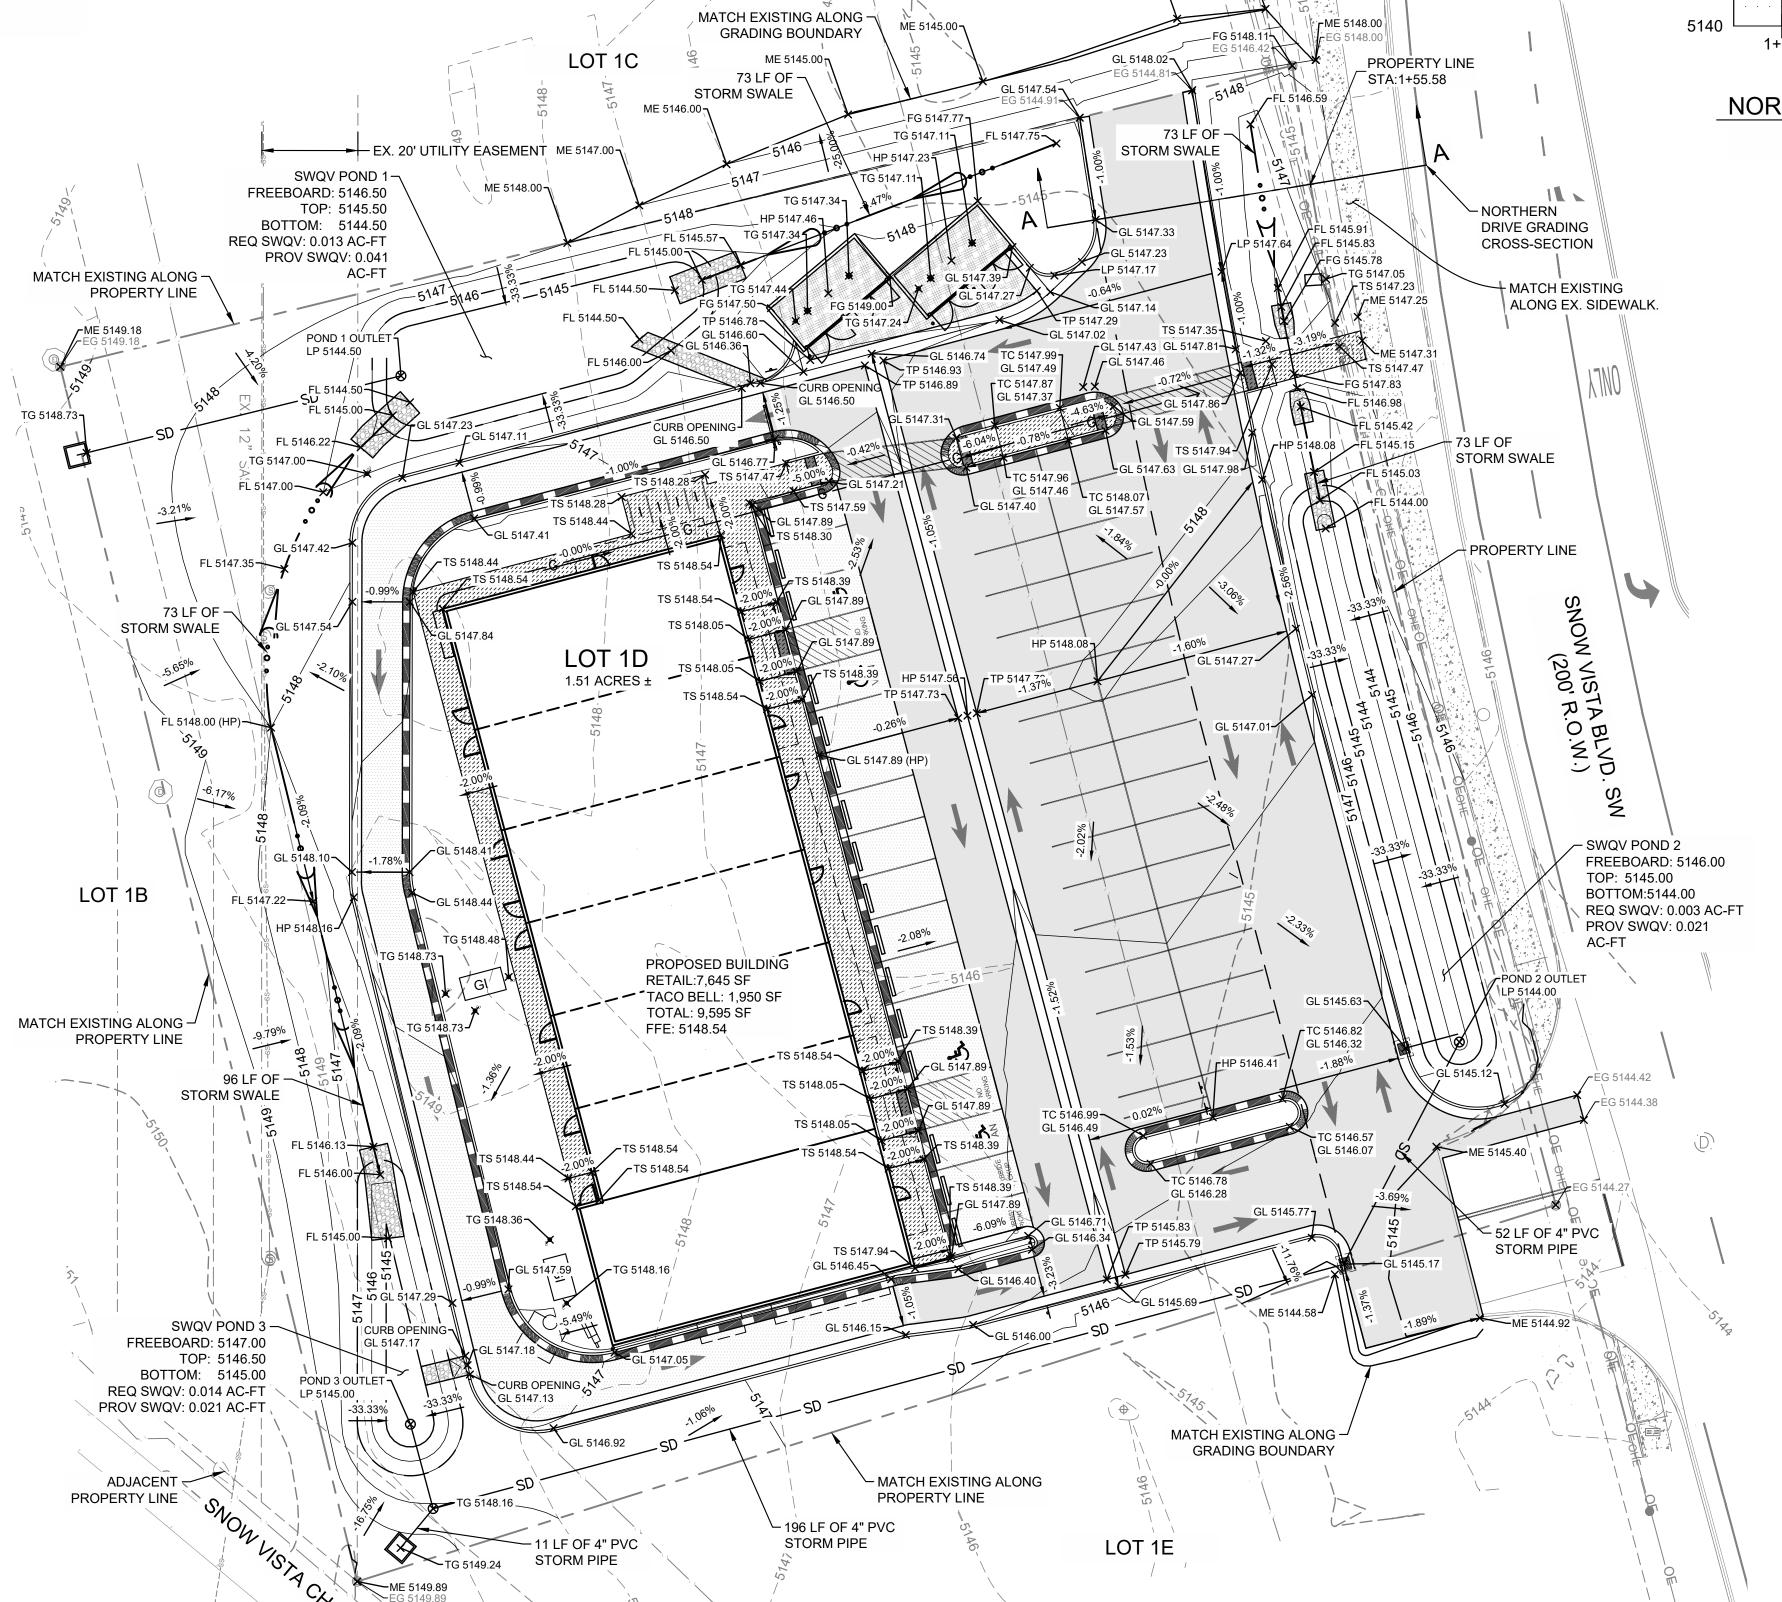

City of Albuquerque
Planning Department
Development Review Services
HYDROLOGY SECTION


PRELIMINARY APPROVED

DATE: 06/24/2024

BY: 06/24/2024

BY: M09D012D

THESE PLANS AND/OR REPORT ARE
CONCEPTUAL ONLY. MORE INFORMATION MAY
BE NEEDED IN THEM AND SUBMITTED TO
HYDROLOGY FOR BUILDING PERMIT APPROVAL.

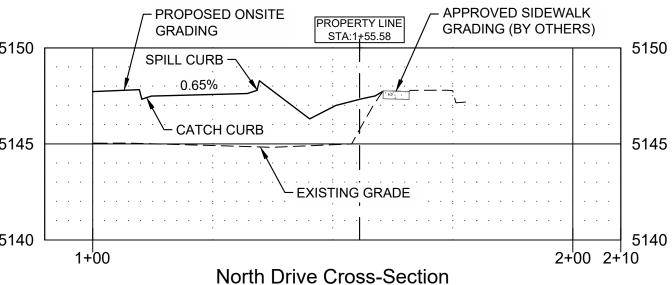

NORTHERN DRIVE - GRADING CROSS-SECTION HORIZONTAL SCALE: 1"=20' VERTICAL SCALE: 1"=5'

GRADING NO

- 1. SPOT ELEVATIONS SHOWN ARE TO GUTTER FLOW LINE. ADD 0.5' FOR TOP OF CURB FLEVATIONS
- 2. SITE GRADING SHALL NOT PROCEED UNTIL EROSION CONTROL MEASURES HAVE BEEN INSTALLED & INSPECTED AND APPROVED BY LOCAL AUTHORITIES.

CAUTION: IF THIS SHEET IS NOT 24"x36" IT IS A REDUCED PRINT

- 3. ALL CUT OR FILL SLOPES SHALL BE 3:1 OR FLATTER UNLESS OTHERWISE NOTED.
- 4. EXISTING DRAINAGE STRUCTURES TO BE INSPECTED AND REPAIRED AS NEEDED, AND EXISTING PIPES ARE TO BE CLEANED OUT TO REMOVE ALL SILT AND DEBRIS.
- 5. IF ANY EXISTING STRUCTURES TO REMAIN ARE DAMAGED DURING CONSTRUCTION IT SHALL BE THE CONTRACTORS RESPONSIBILITY TO REPAIR OR REPLACE THE EXISTING STRUCTURE AS NECESSARY.
- 6. ALL STORM PIPE ENTERING STRUCTURES SHALL BE GROUTED TO ASSURE CONNECTION AT STRUCTURE IS WATER TIGHT.
- 7. CONTRACTOR SHALL ASSURE POSITIVE DRAINAGE AWAY FROM BUILDINGS AND
- STRUCTURES FOR ALL GRASSED AND PAVED AREAS.

 8. CONSTRUCTION SHALL COMPLY WITH ALL APPLICABLE GOVERNING CODES AND BE
- CONSTRUCTED TO THE SAME.


 CONTRACTOR IS RESPONSIBLE FOR TEMPORARY ACCESS ROADS AND SHALL MAINTAIN POSITIVE DRAINAGE OF ENTIRE SITE THROUGHOUT CONSTRUCTION AND AVOID
- POSITIVE DRAINAGE OF ENTIRE SITE THROUGHOUT CONSTRUCTION AND AVOID PONDING OR RUTTING. TEMPORARY DEWATERING, INCLUDING PUMPING, MAY BE REQUIRED AND SHALL BE INCLUDED IN THE SCOPE OF WORK.
- 10. SIDEWALKS SHALL HAVE MAX 2% CROSS SLOPE.


GRADING PLAN DESCRIPTION

EXISTING SITE GRADES GENERALLY SLOPE FROM NORTHWEST TO THE SOUTHERN CORNER OF THE OVERALL SUBDIVISION.

PROPOSED SITE GRADING SHALL TIE-IN WITH THE PROPOSED SIDEWALK FRONTAGE ALONG SNOW VISTA BLVD SW AND THE WESTERN SIDE OF THE LOT.


THE GRADING SHALL ALLOW FOR FUTURE LOT DEVELOPMENT TO THE NORTH AND SOUTH OF OUR SITE THAT FACILITATES DRAINAGE TOWARDS THE SOUTH OUTFALL, AN EXISTING 42" RCP.

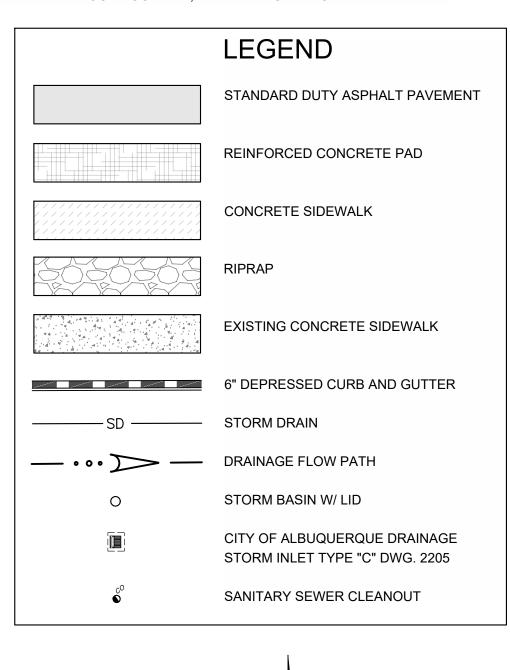

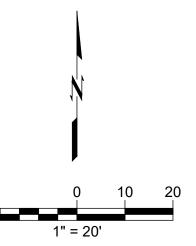




englewood, co 80112 303.350.1690 · 800.364.5858

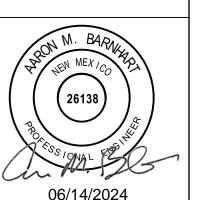


SO BELL

R SAGE


WVISTA BLVD SW
OUFROUF NM

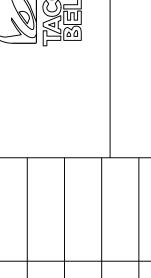

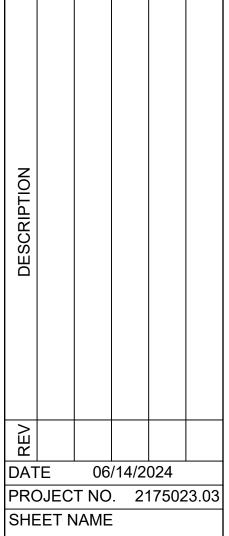

GRADING AND

DRAINAGE PLAN

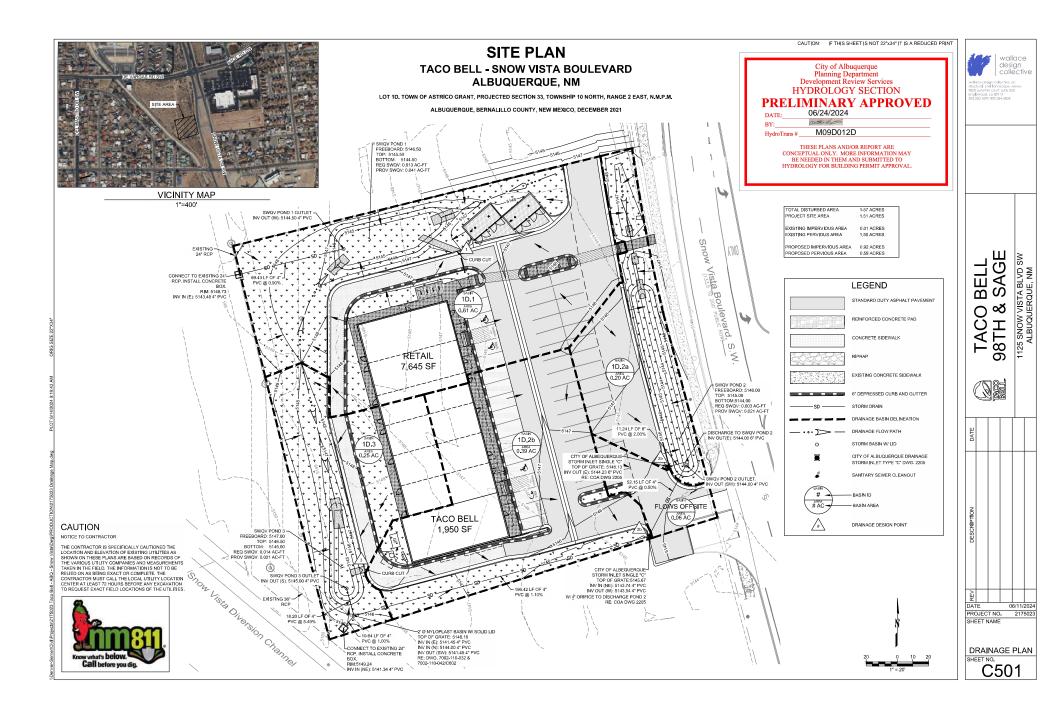

PROPERTY LINE

Call before you dig

RE: 11/C801

ACCESSIBLE RAMP

EXISTING

TO REMAIN



structural·civil·landscape·survey 9800 pyramid court, suite 350 englewood, co 80112 303.350.1690 · 800.364.5858



06/14/2024

DATE 06/14/2024 PROJECT NO. 2175023.03

SHEET NAME TRAFFIC CIRCULATION


LAYOUT SHEET NO.


TRAFFIC CIRCULATION LAYOUT

TACO BELL - SNOW VISTA BOULEVARD ALBUQUERQUE, NM


LOT 1D. TOWN OF ASTRICO GRANT, PROJECTED SECTION 33, TOWNSHIP 10 NORTH, RANGE 2 EAST, N.M.P.M.

ALBUQUERQUE, BERNALILLO COUNTY, NEW MEXICO, DECEMBER 2021

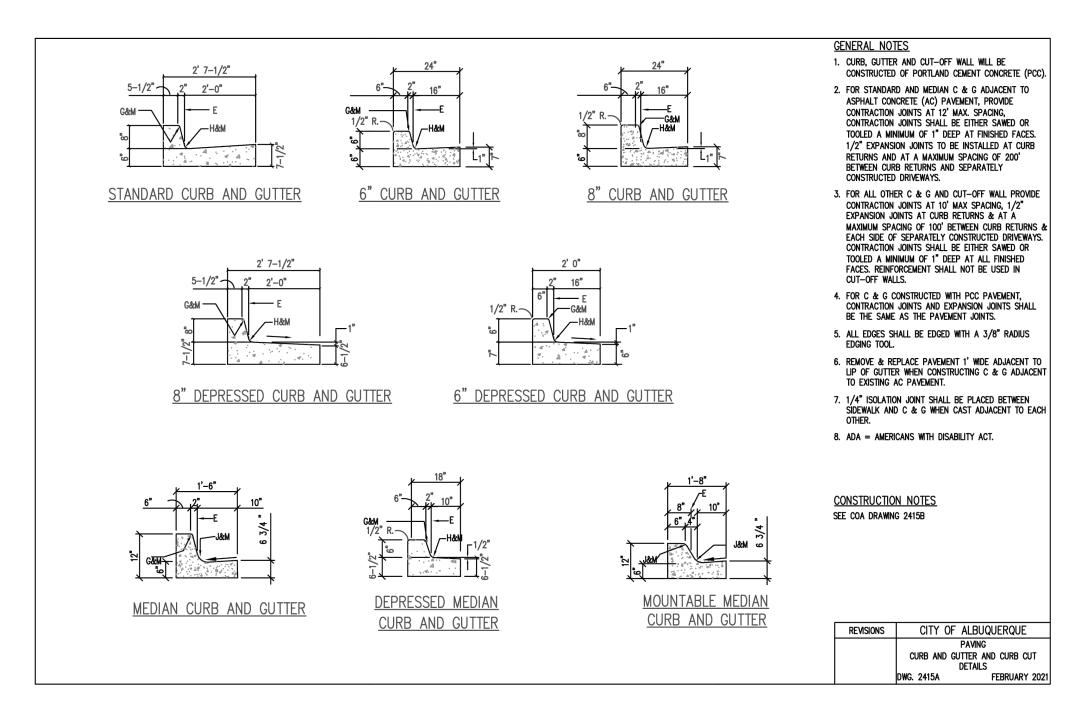

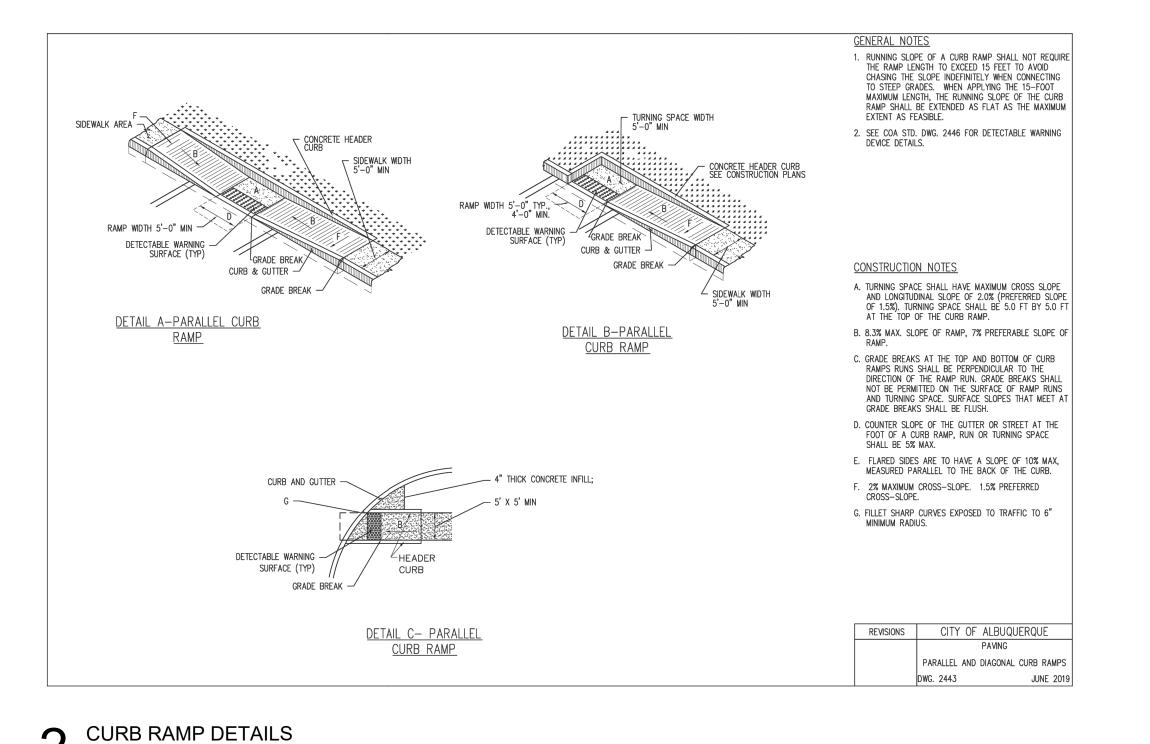




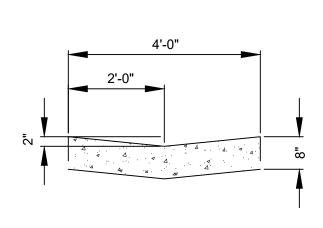


3 4' VALLEY PAN SCALE: NTS

CURB AND GUTTER


SCALE: NTS

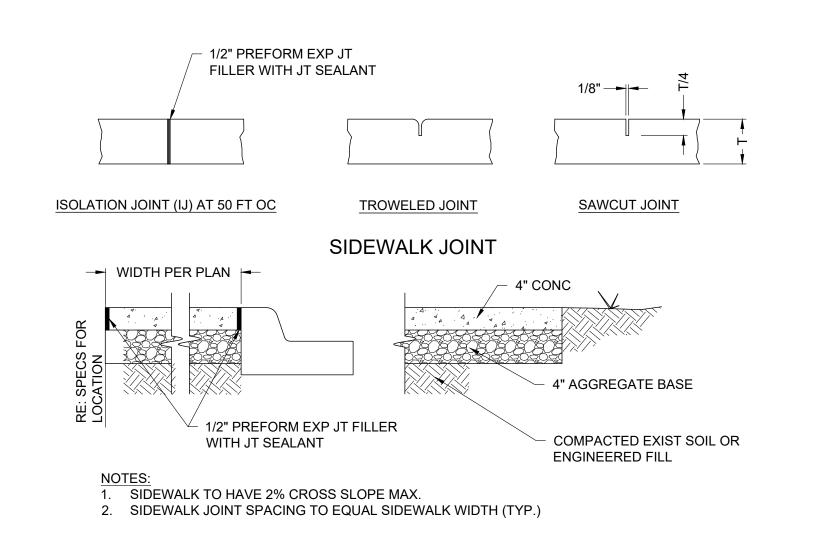




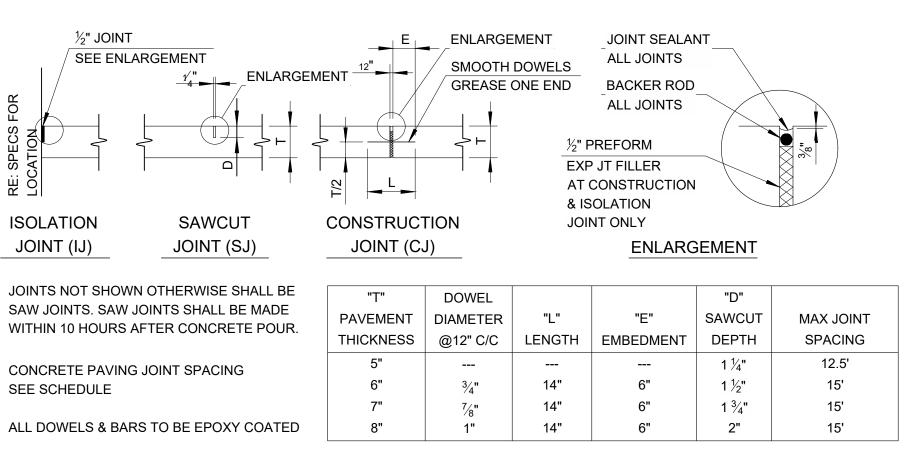



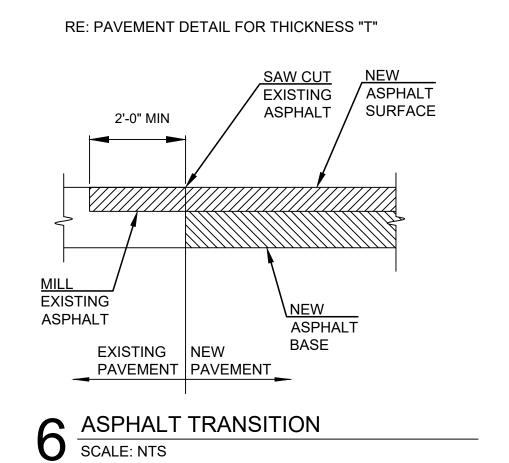

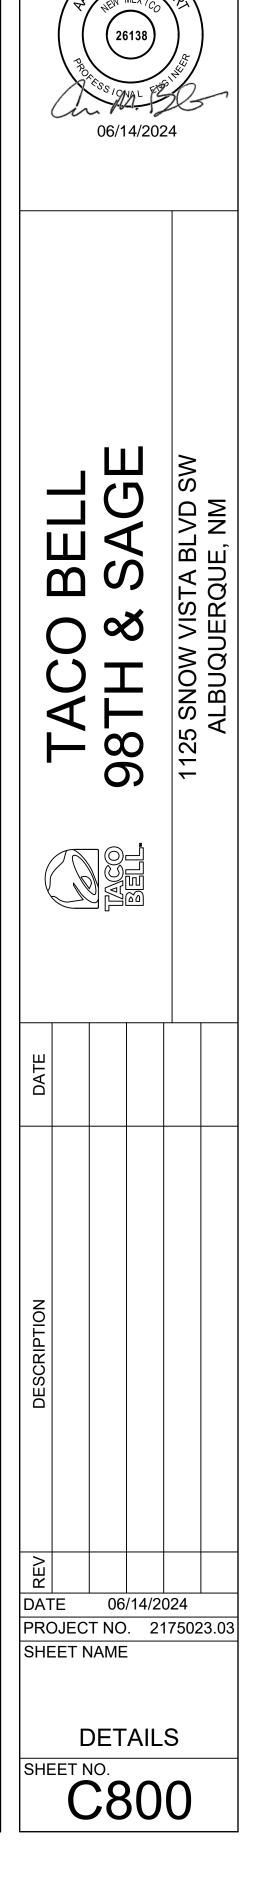

wallace design


wallace design collective, pc structural·civil·landscape·survey 9800 pyramid court, suite 350 englewood, co 80112 303.350.1690·800.364.5858


TRAFFIC CIRCULATION LAYOUT


TACO BELL - SNOW VISTA BOULEVARD ALBUQUERQUE, NM

LOT 1D. TOWN OF ASTRICO GRANT, PROJECTED SECTION 33, TOWNSHIP 10 NORTH, RANGE 2 EAST, N.M.P.M.

ALBUQUERQUE, BERNALILLO COUNTY, NEW MEXICO, DECEMBER 2021

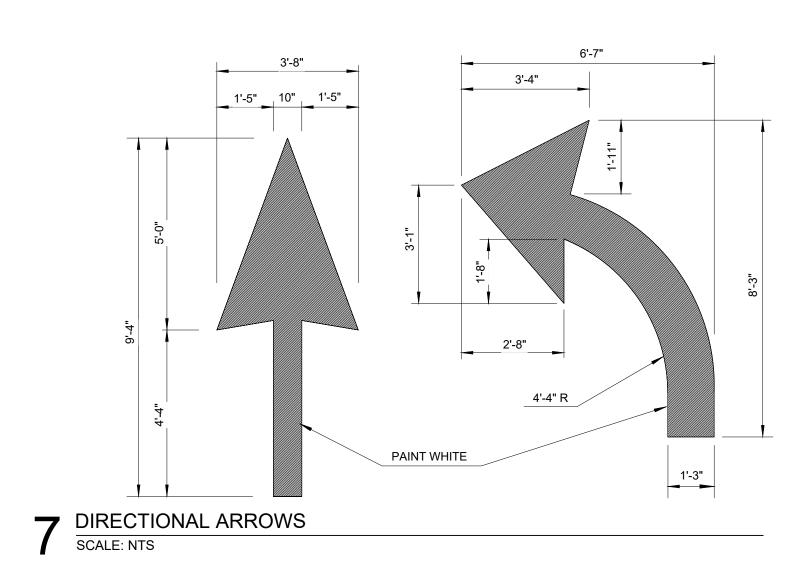


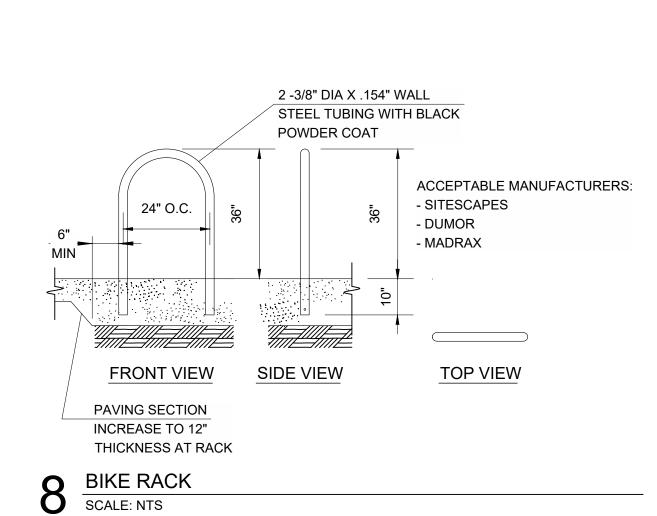


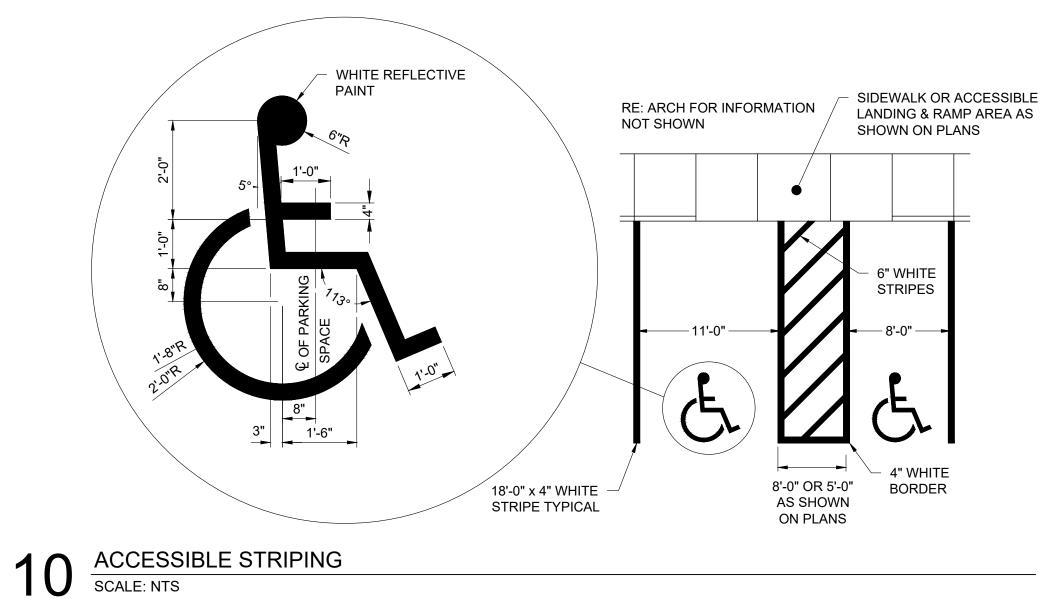

ONLY

MUTCD R3-5R

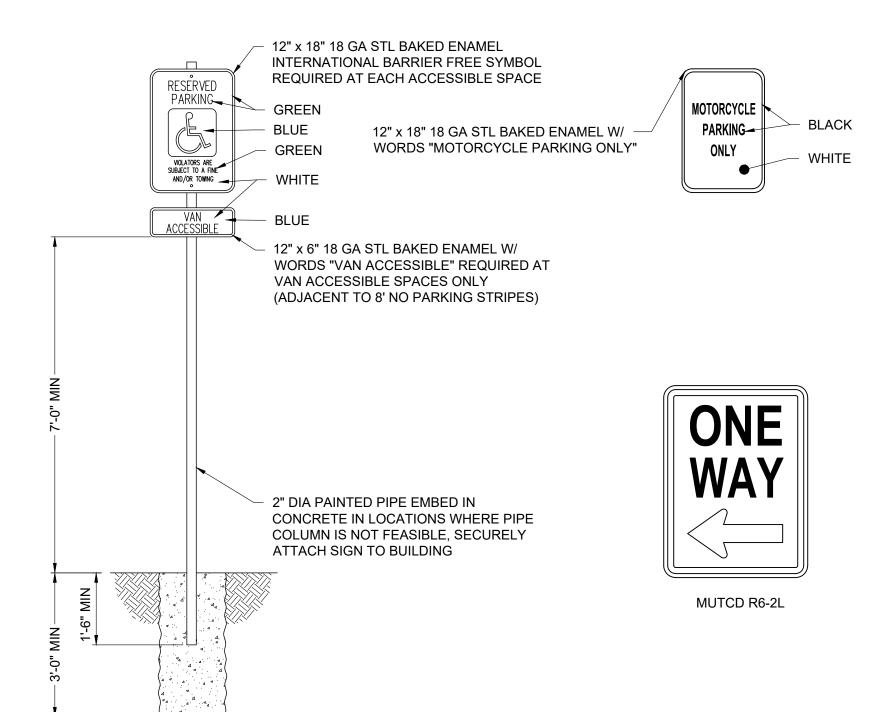


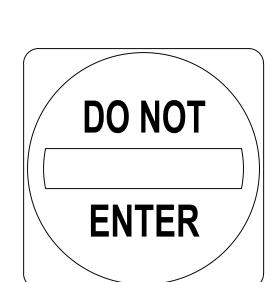

MUTCD R1-1


MUTCD R5-1


ADA/ MOTORCYCLE/ STOP/ ONE WAY/ DO NOT ENTER / RIGHT ONLY SIGN DETAILS SCALE: NTS

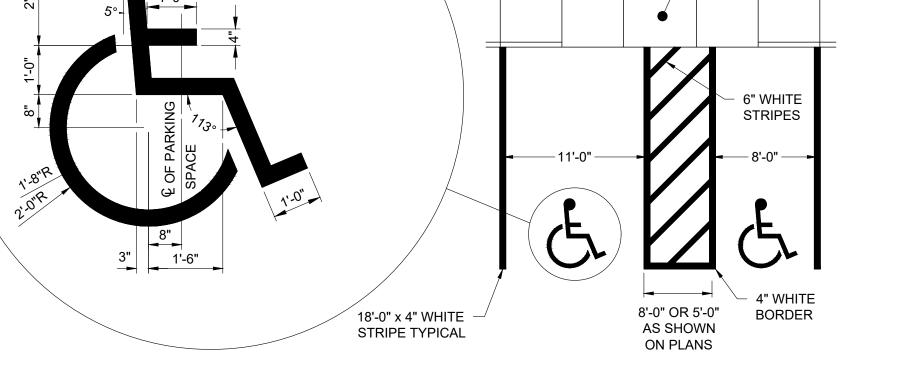


TRAFFIC CIRCULATION LAYOUT APPROVED Sertil A. Kanbar 6/18/2024

TRAFFIC CIRCULATION **DETAILS 2**

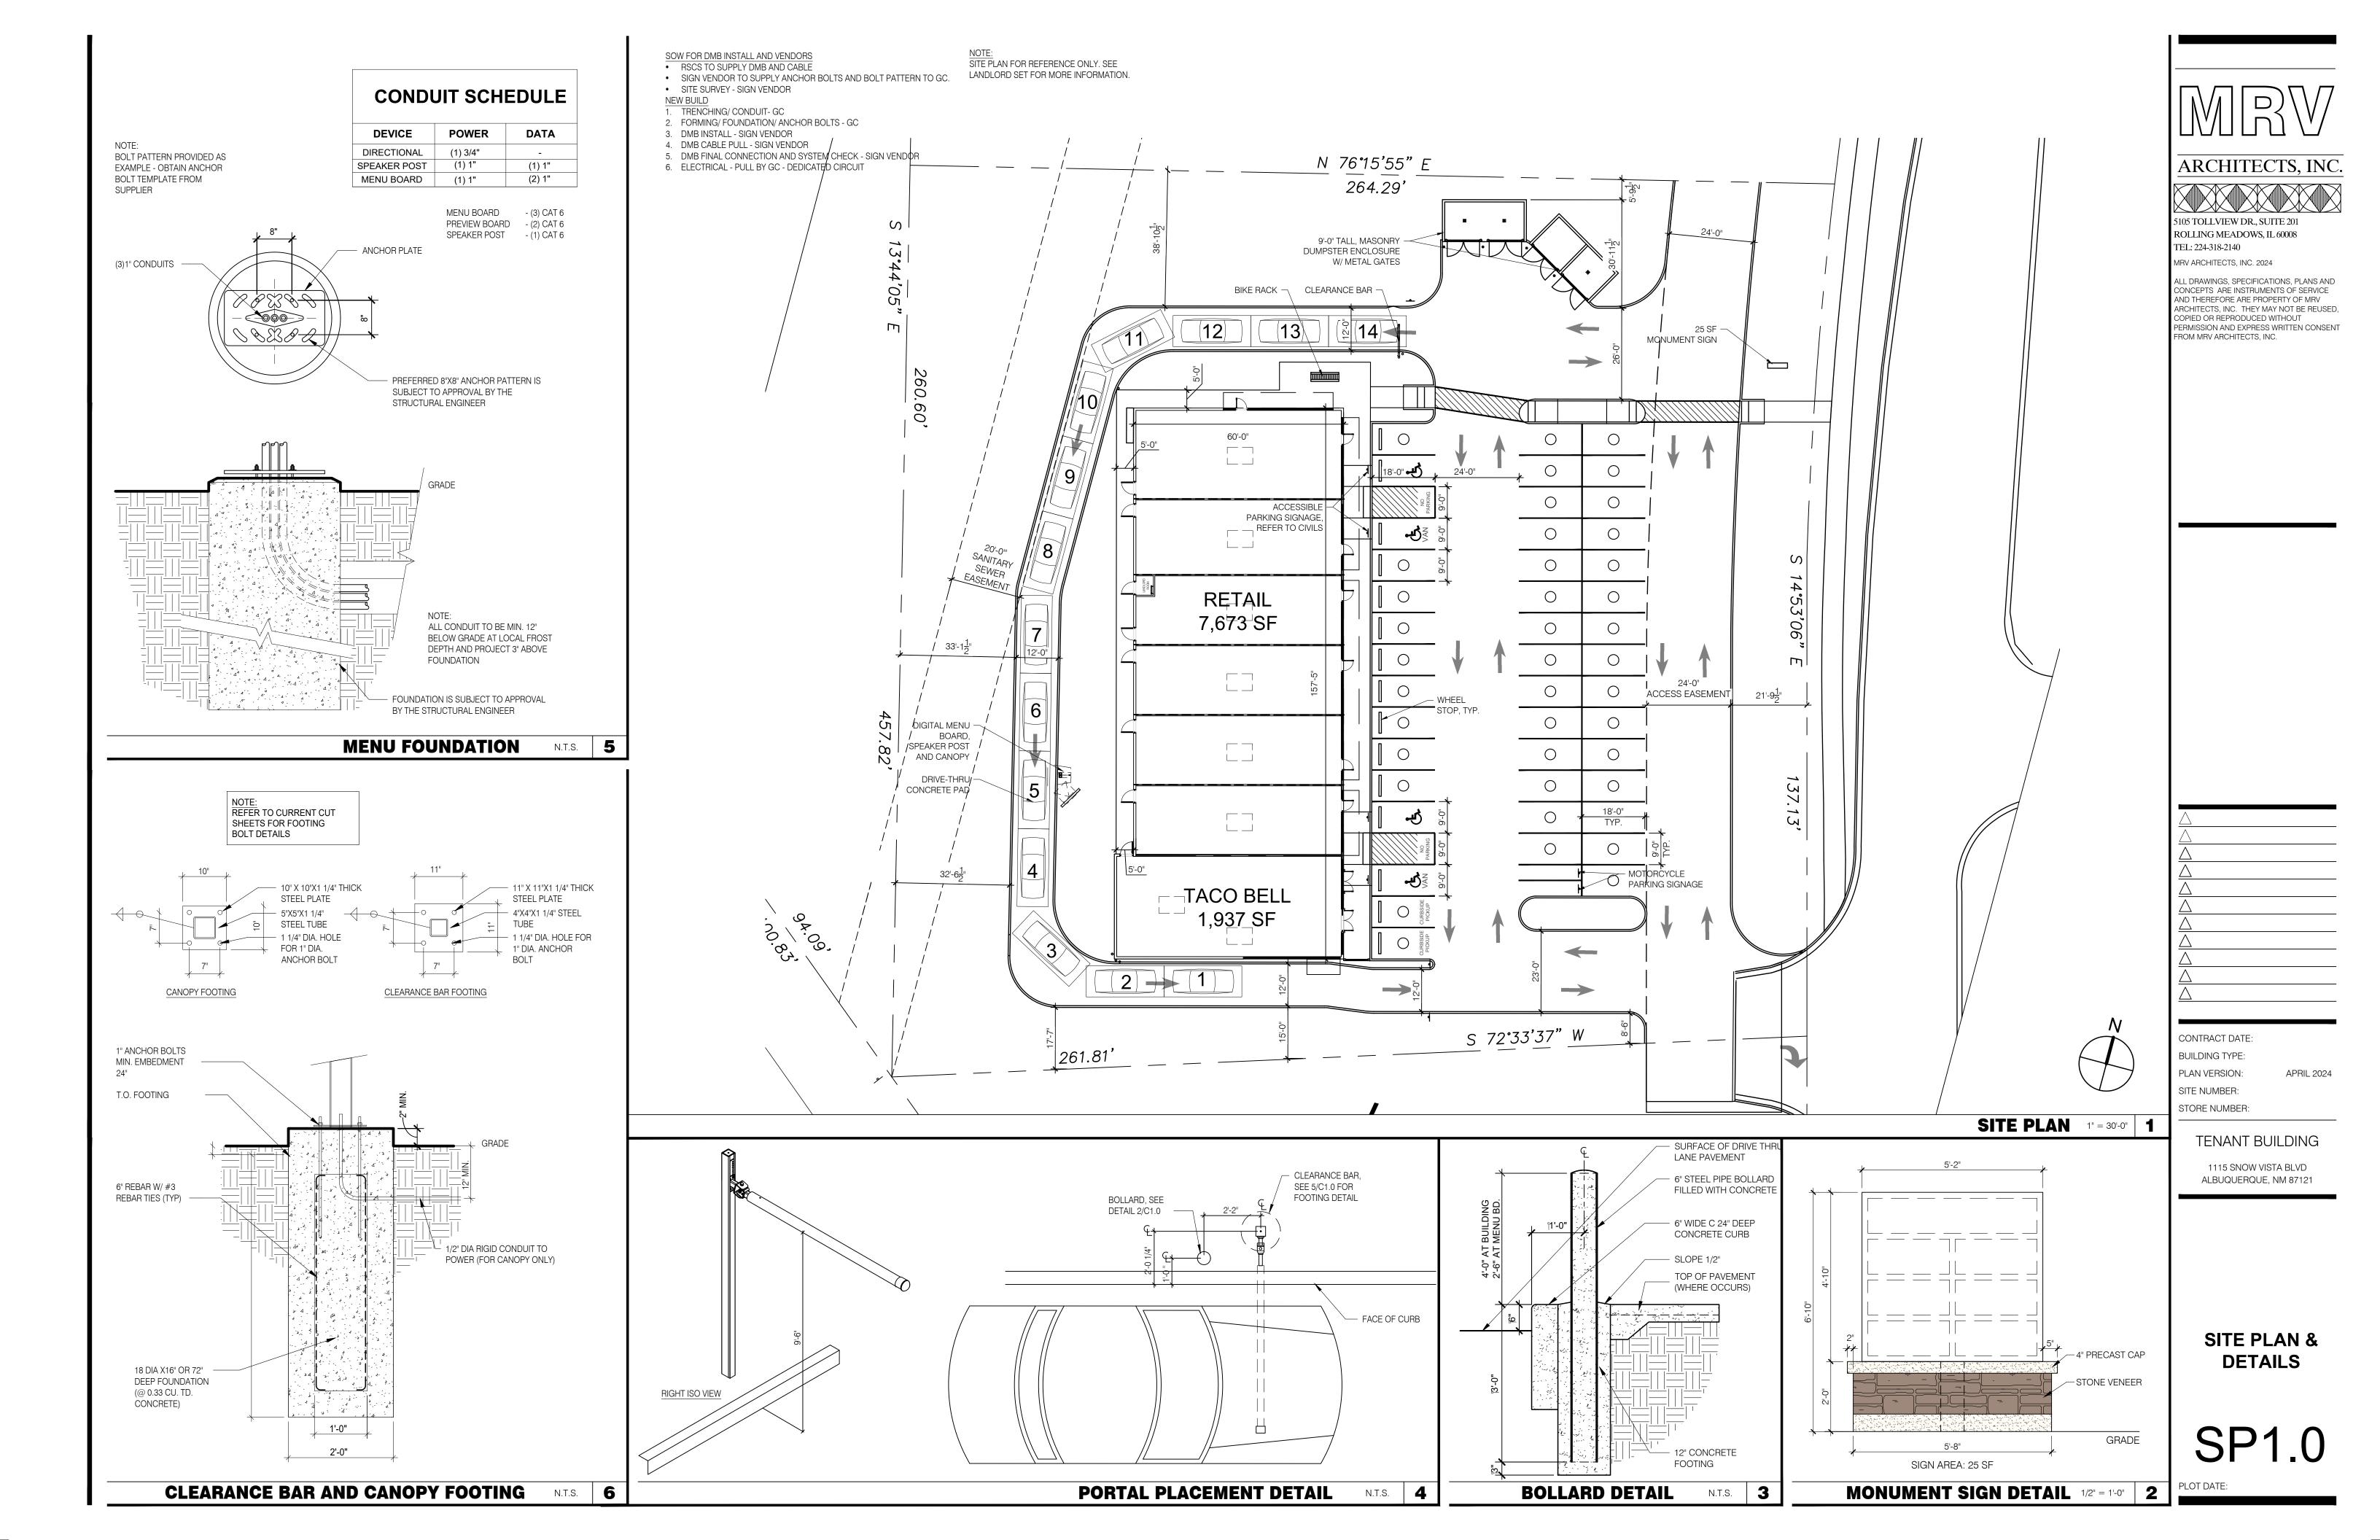

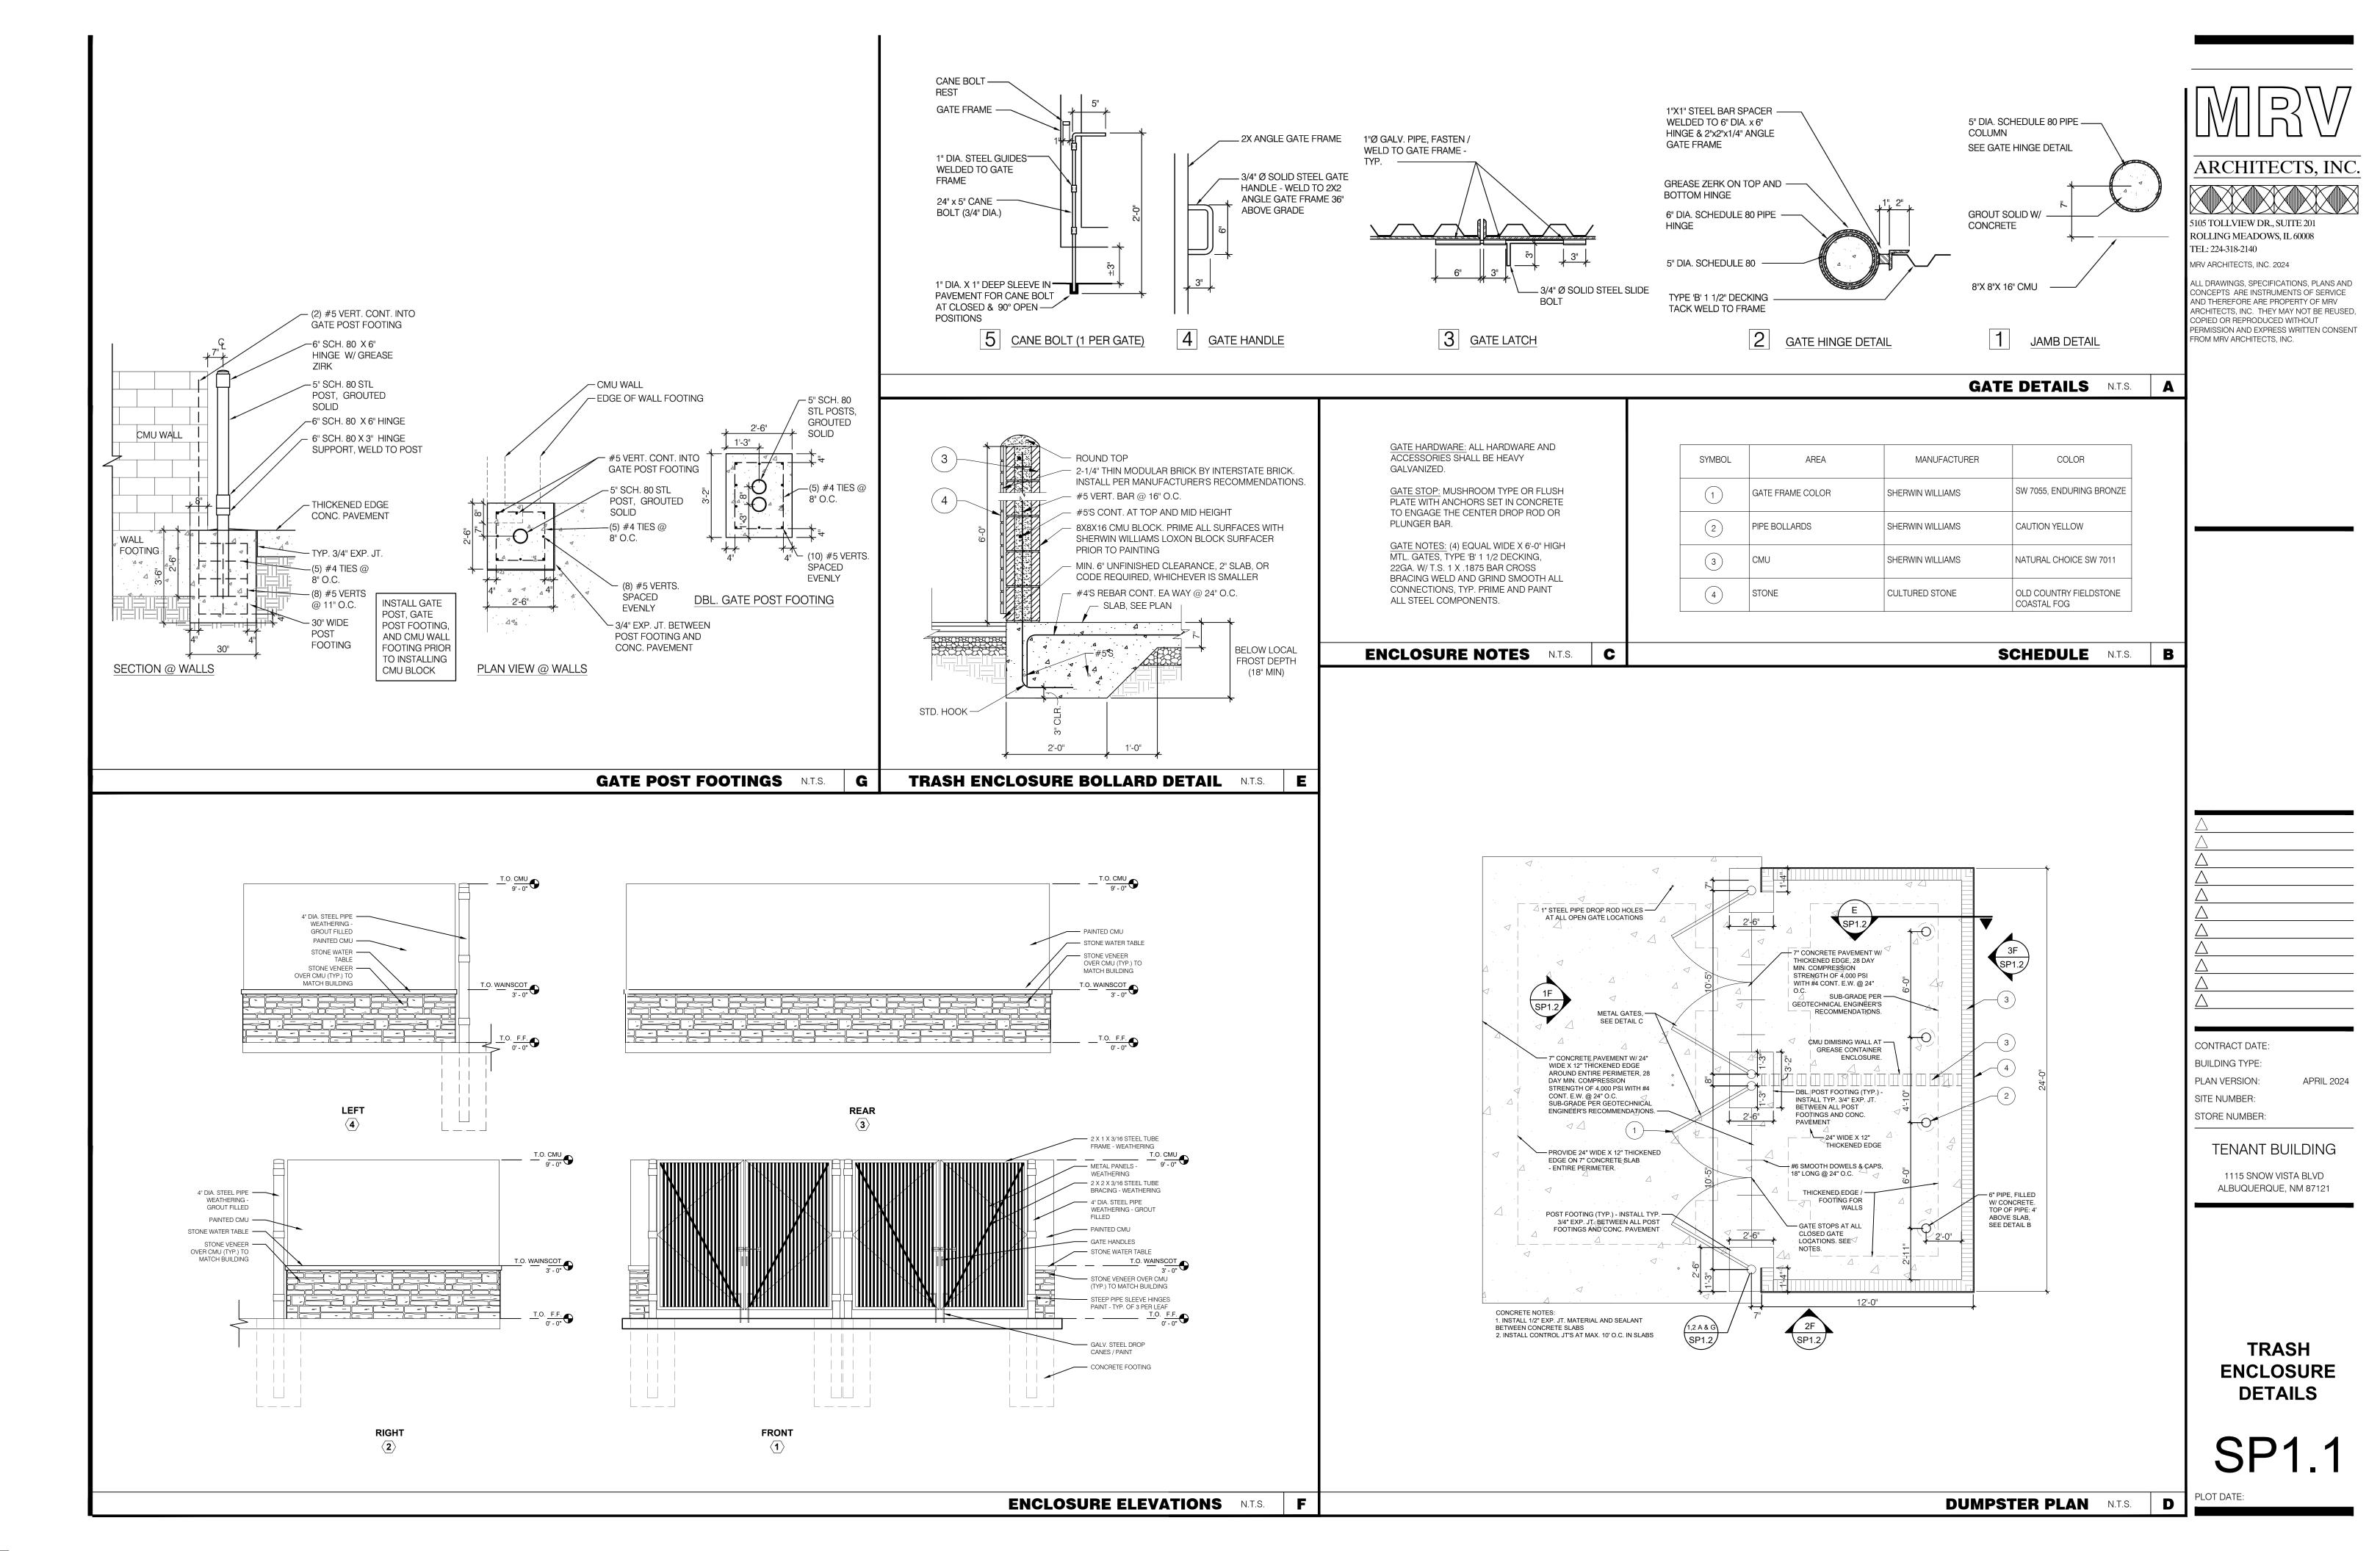

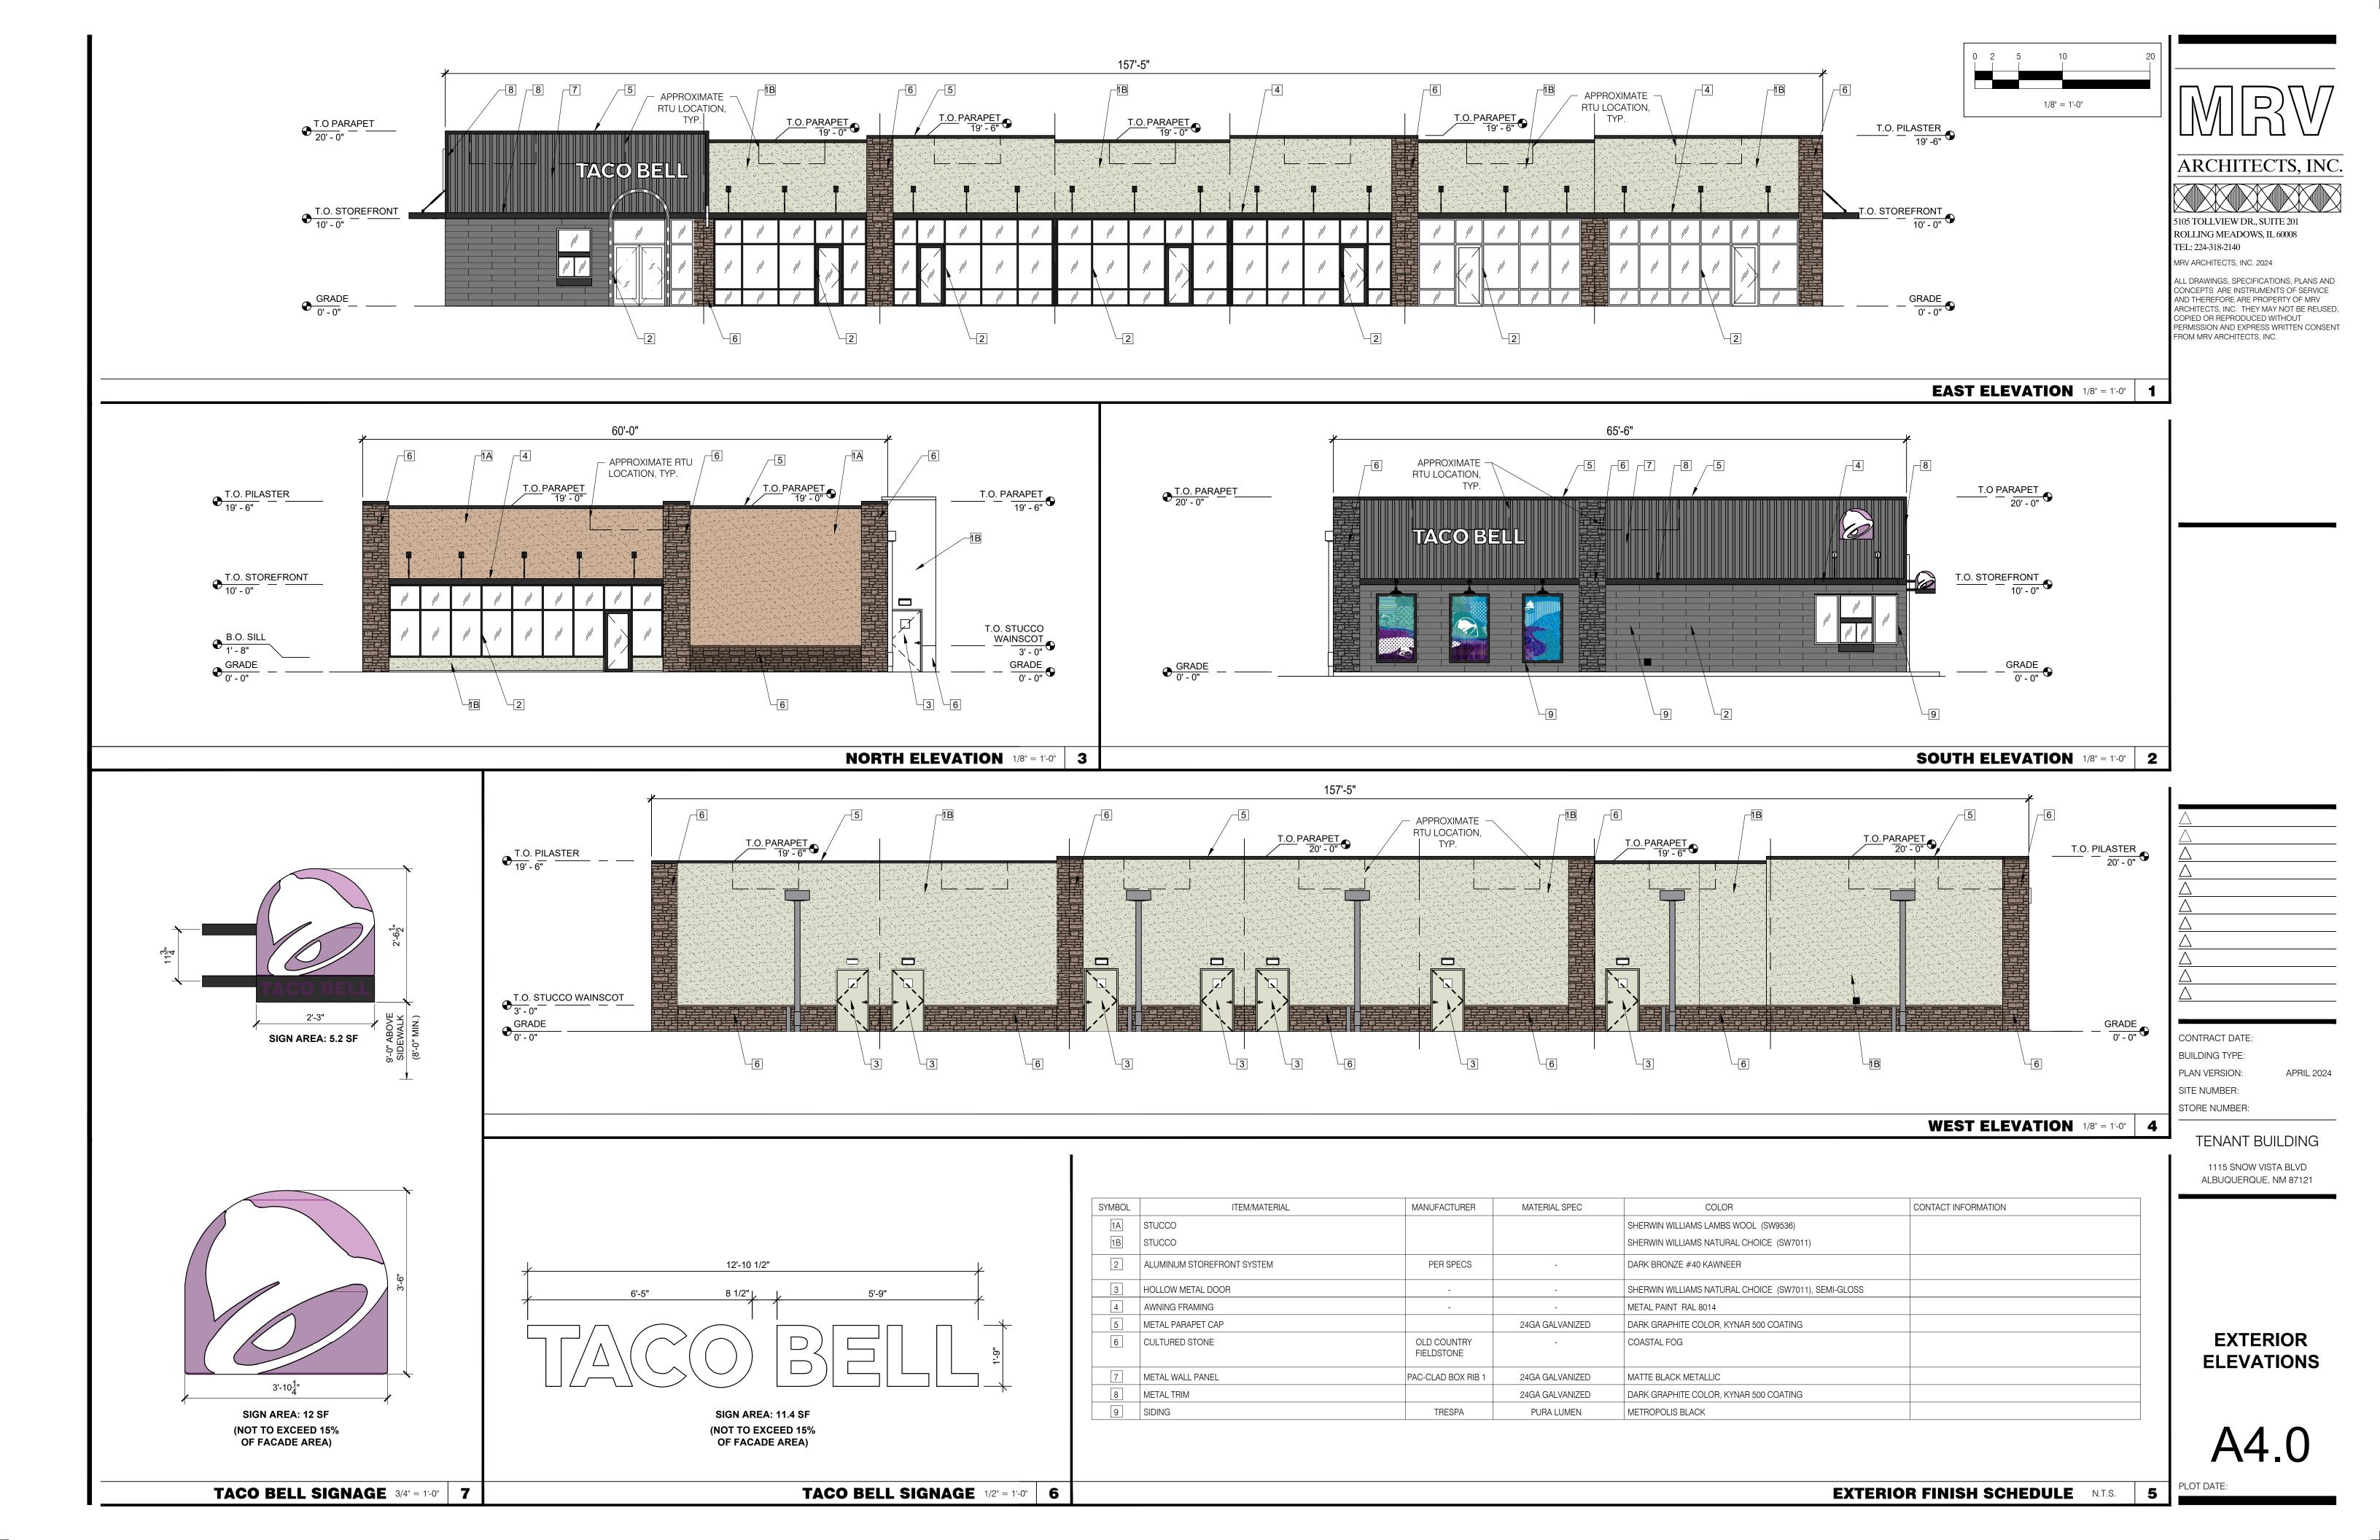

TACO BELL & RETAIL

1115 SNOW VISTA BLVD.

ALBUQUERQUE, NM

APRIL 25, 2024

ACCUSERV LIGHTING & EQUIPMENT 877-707-7378

DESIGNED BY: JOHN BUJAKE jbujake@accu-serv.com


QUOTATIONS BY: AARON HAMPTON ahampton@accu-serv.com

Calculation Summary					
Label	Avg	Max	Min	Avg/Min	Max/Min
EXTENDED	2.70	9.2	0.0	N.A.	N.A.
PARKING LOT & DRIVE-THRU SURFACE	5.87	9.2	2.7	2.17	3.41

LIGHT LEVELS ARE MAINTAINED FOOT-CANDLES, INITIAL LEVELS ARE SLIGHTLY HIGHER

Lumina	ire Sch	nedule							
Symbol	. Qty	Label	Arrangement	Luminaire	LLF	CCT	Luminaire	Mounting	Description
				Lumens			Watts	Height	
<u>—</u>] 1	A	SINGLE	34830	0.900	4000K	269	27.5	VP-2-320L-255-4K7-4F-UNV-A-DBT / SES-25-40-01-F-B4-DBT
<u>-</u>	3	В	SINGLE	39566	0.900	4000K	321	27.5	VP-2-320L-315-4K7-4W-UNV-A-DBT / SES-25-40-01-F-B4-DBT
<u>—</u>] 1	С	Single	43479	0.900	4000K	321	27.5	VP-2-320L-315-4K7-5QW-UNV-A-DBT / SES-25-40-01-F-B4-DBT
	2	D	Back-Back	43479	0.900	4000K	321	27.5	(2) VP-2-320L-315-4K7-5QW-UNV-A-DBT / SES-25-40-01-F-B4-DBT

POLES ARE 25'-0" ON 2'-6" BASES

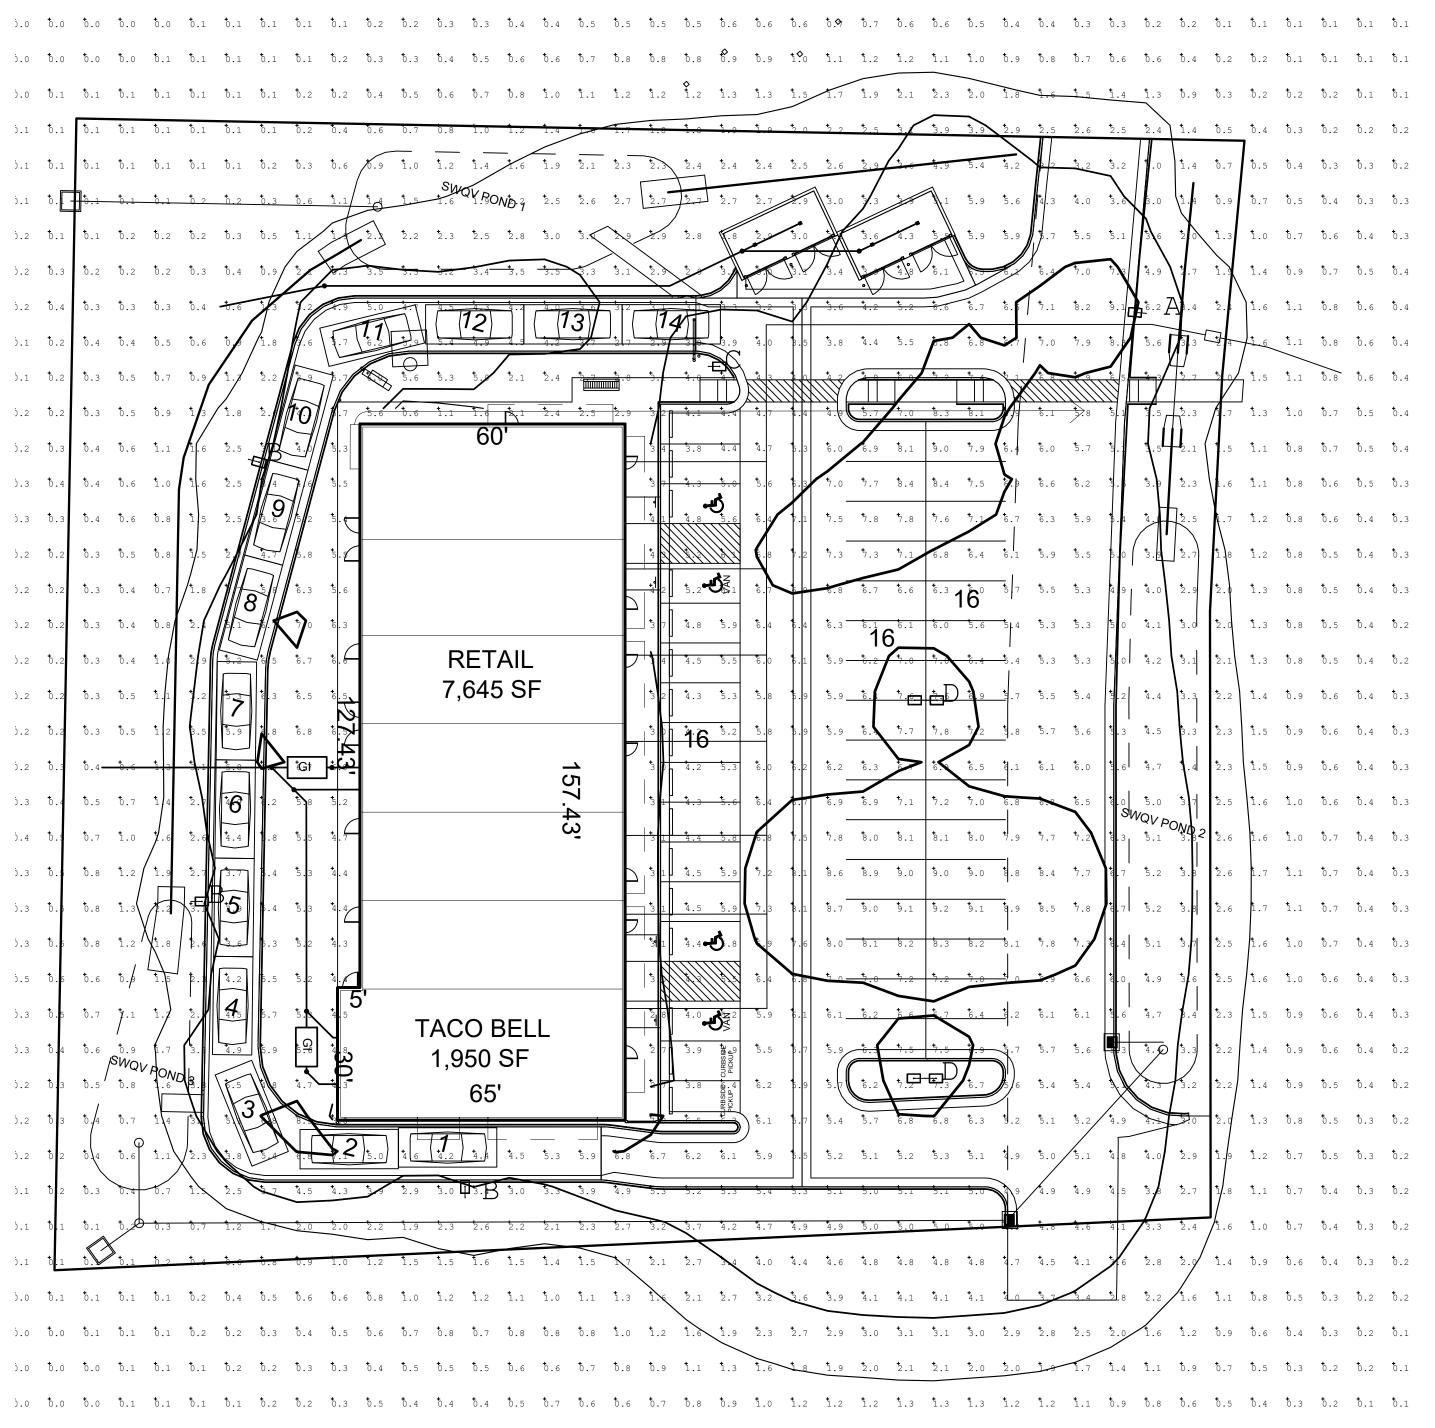

5.0 5.0 5.0 5.1 5.1 5.1 5.1 5.2 5.2 5.3 5.4 5.3 5.3 5.3 5.3 5.4 5.6 5.5 5.5 5.5 5.5 5.6 5.7 5.7 5.8 5.8 5.8 5.8 5.8 5.7 5.7 5.6 5.5 5.4 5.3 5.3 5.2 5.2 5.1 5.1

MRV

ARCHITECTS, INC

5105 TOLLVIEW DR., SUITE 201 ROLLING MEADOWS, IL 60008 TEL: 224-318-2140

RV ARCHITECTS, INC. 2024

ALL DRAWINGS, SPECIFICATIONS, PLANS AND CONCEPTS ARE INSTRUMENTS OF SERVICE AND THEREFORE ARE PROPERTY OF MRV ARCHITECTS, INC. THEY MAY NOT BE REUSED, COPIED OR REPRODUCED WITHOUT PERMISSION AND EXPRESS WRITTEN CONSENT FROM MRV ARCHITECTS, INC.

CONTRACT DATE:
BUILDING TYPE:

PLAN VERSION: SITE NUMBER:

TENANT BUILDING

1115 SNOW VISTA BLVD ALBUQUERQUE, NM 87121

PHOTOMETRIC PLAN

SP2.0

PHOTOMETRIC DATA 2 PHOTOMETRIC PLAN N.T.S.

PARKING SUMMARY	TARLE
RE: 2022 IDO, TABLE 5-5-1, TABLE 5-5-	
2020 DPM, Section 7-4(K)(2), Section	•
	(,(-)
REQUIRED OFF-STREET PARKING:	
RESTAURANT: 1,950 SF	
5.6 SPACES PER 1,000 SF: (5.6*1950) =	10
1000	10
CENEDAL DETAIL ~ 10 000 SE: 7 645 SI	E
GENERAL RETAIL ≤ 10,000 SF: 7,645 SI	
3.5 SPACES PER 1,000 SF: $\frac{(3.5*7645)}{1000}$ =	26
1000	
REQUIRED MOTORCYCLE PARKING:	
25-50 OFF-STREET SPACES =	2
TOTAL =	38
PROVIDED PARKING:	46
THOUSE TARRING.	40
STANDARD:	40
ACCESSIBLE:	2
VAN ACCESSIBLE:	2
MOTORCYCLE:	2
INIOTORCTCLE.	2
TOTAL PROVIDED PARKING:	46
MINIMUM PARKING STALL DIMENSION	S PROVIDED:
STANDARD:	9' x 18'
ACCESSIBLE:	9' x 18'
VAN ACCESSIBLE:	9' x 18'
MOTORCYLE:	4.5' x 18'
MINIMUM REQUIRED BICYCLE PARKIN	G.
BIOTOLL FARMING	O .
NON-RESIDENTIAL USES:	
10% OF REQUIRED OFF-STREET PARK	(ING = 4
MINIMUM BICYCLE STALL DIMENSIONS	S PROVIDED: 4' x 6
•	

CAUTION

NOTICE TO CONTRACTOR

THE CONTRACTOR IS SPECIFICALLY CAUTIONED THE LOCATION AND ELEVATION OF EXISTING UTILITIES AS SHOWN ON THESE PLANS ARE BASED ON RECORDS OF THE VARIOUS UTILITY COMPANIES AND MEASUREMENTS TAKEN IN THE FIELD. THE INFORMATION IS NOT TO BE RELIED ON AS BEING EXACT OR COMPLETE. THE CONTRACTOR MUST CALL THE LOCAL UTILITY LOCATION CENTER AT LEAST 72 HOURS BEFORE ANY EXCAVATION TO REQUEST EXACT FIELD LOCATIONS OF THE UTILITIES.



DE VARGAS RD SW

SITE AREA

PARTY DE VARGAS RD SW

VICINITY MAP 1"=400'

PROPERTY DESCRIPTION

TRACT A PLAT FOR TRACT A SNOW VISTA, AS THE SAME IS SHOWN AND DESIGNATED ON THE PLAT THEROF FILLED IN THE OFFICE OF THE COUNTRY CLERK OF BERNALILLO COUNTY, NEW MEXICO IN 2022.

PROPERTY ADDRESS
1125 SNOW VISTA BLVD SW

ABBREVIATIONS

BUILDING LINE CENTERLINE

(M) MEASURED DATA

(R) RECORD DATA

BC BACK OF CURB

EG EXISTING GRADE

FF FINISHED FLOOR

FG FINISHED GRADE

FL FLOWLINE

GL GUTTER LINE

HP HIGH POINT

LF LINEAR FEET

ME MATCH EXISTING

RW RIGHT-OF-WAY

SF SQUARE FEET

TBK TOP OF BANK

TC TOP OF CURB

TG TOP OF GRATE

TOE TOE OF BANK

TR TOP OF RIM

TW TOP OF WALL

TP TOP OF PAVEMEN

TS TOP OF SIDEWALK

SY SQUARE YARDS

LP LOW POINT

INV INVERT

LEGEND

5555 5555
X X X
FO ————————————————————————————————————

LINETYPES

CENTERLINE
SILT FENCE
LIMITS OF CONSTRUCTION
PROPOSED MAJOR CONTOUR
PROPOSED MINOR CONTOUR
EXISTING MAJOR CONTOUR
EXISTING MINOR CONTOUR
EXISTING MINOR CONTOUR

EASEMENT
FENCE
PROPERTY LINE
LOT LINE
BUILDING SETBACK
FIBER OPTIC
OVERHEAD COMMUNICATION
UNDERGROUND COMMUNICATION
OVERHEAD ELECTRIC
UNDERGROUND ELECTRIC
NATURAL GAS
SEWER FORCE MAIN
SANITARY SEWER MAIN
SANITARY SEWER SERVICE
DRAINAGE AREA MAIOR

SANITARY SEWER SERVIO DRAINAGE AREA, MAJOR DRAINAGE AREA, MINOR DRAINAGE FLOW PATH STORM DRAINAGE PIPE FIRE LINE WATER LINE

■ ELECTRIC BOX ELECTRIC METER ELECTRIC TRANSFORMER A/C UNIT © ELECTRIC MANHOLE GAS METER ₩ GAS VALVE OIL/GAS WELLHEAD OVENT PIPE PIPELINE MARKER © COMMUNICATION PEDESTAL © COMMUNICATION MANHOLE ● SEWER CLEAN-OUT SANITARY SEWER MANHOLE •_{DS} DOWNSPOUT •_{RD} ROOF DRAIN STORM DRAIN MANHOLE FIRE HYDRANT IRRIGATION CONTROL VALVE SHUT-OFF VALVE SPRINKLER HEAD °wм WATER METER ₩ WATER VALVE

O^{YH} YARD HYDRANT PBO PIPE BOLLARD ◆ BENCHMARK

MAILBOX

POTHOLESIGN

& ACCESSIBLE PARKING

MONITORING WELL

20 0 10

CAUTION: IF THIS SHEET IS NOT 22"x34" IT IS A REDUCED PRINT

DEVELOPER
ALVARADO RESTAURANT NATION
5654 GREENWOOD PLAZA BLVD.
GREENWOOD VILLAGE, CO 80111
TRACY D. KNAPP
TDKNAPP@TEAMARN.COM
678-458-9013

ARCHITECT MRV ARCHITECTS, INC. 5105 TOLLVIEW DR, SUITE 201 ROLLING MEADOWS, IL 60008 MARIO VALENTINI MARIOV@MRVARCH.COM 224-318-2140

CIVIL ENGINEER
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ARLIN.VANCUREN@WALLACE.DESIGN
918.806.7441


wallace design collective, pc structural·civil·landscape·survey 9800 pyramid court, suite 350 englewood, co 80112 303.350.1690·800.364.5858

IACO BELL 8TH & SAGE



DATE				
DESCRIPTION				
REV				
DAT			8/21/	
)JEC	T NO	217	502
SHE	EET N	IAME		

COVER SHEET SHEET NO.

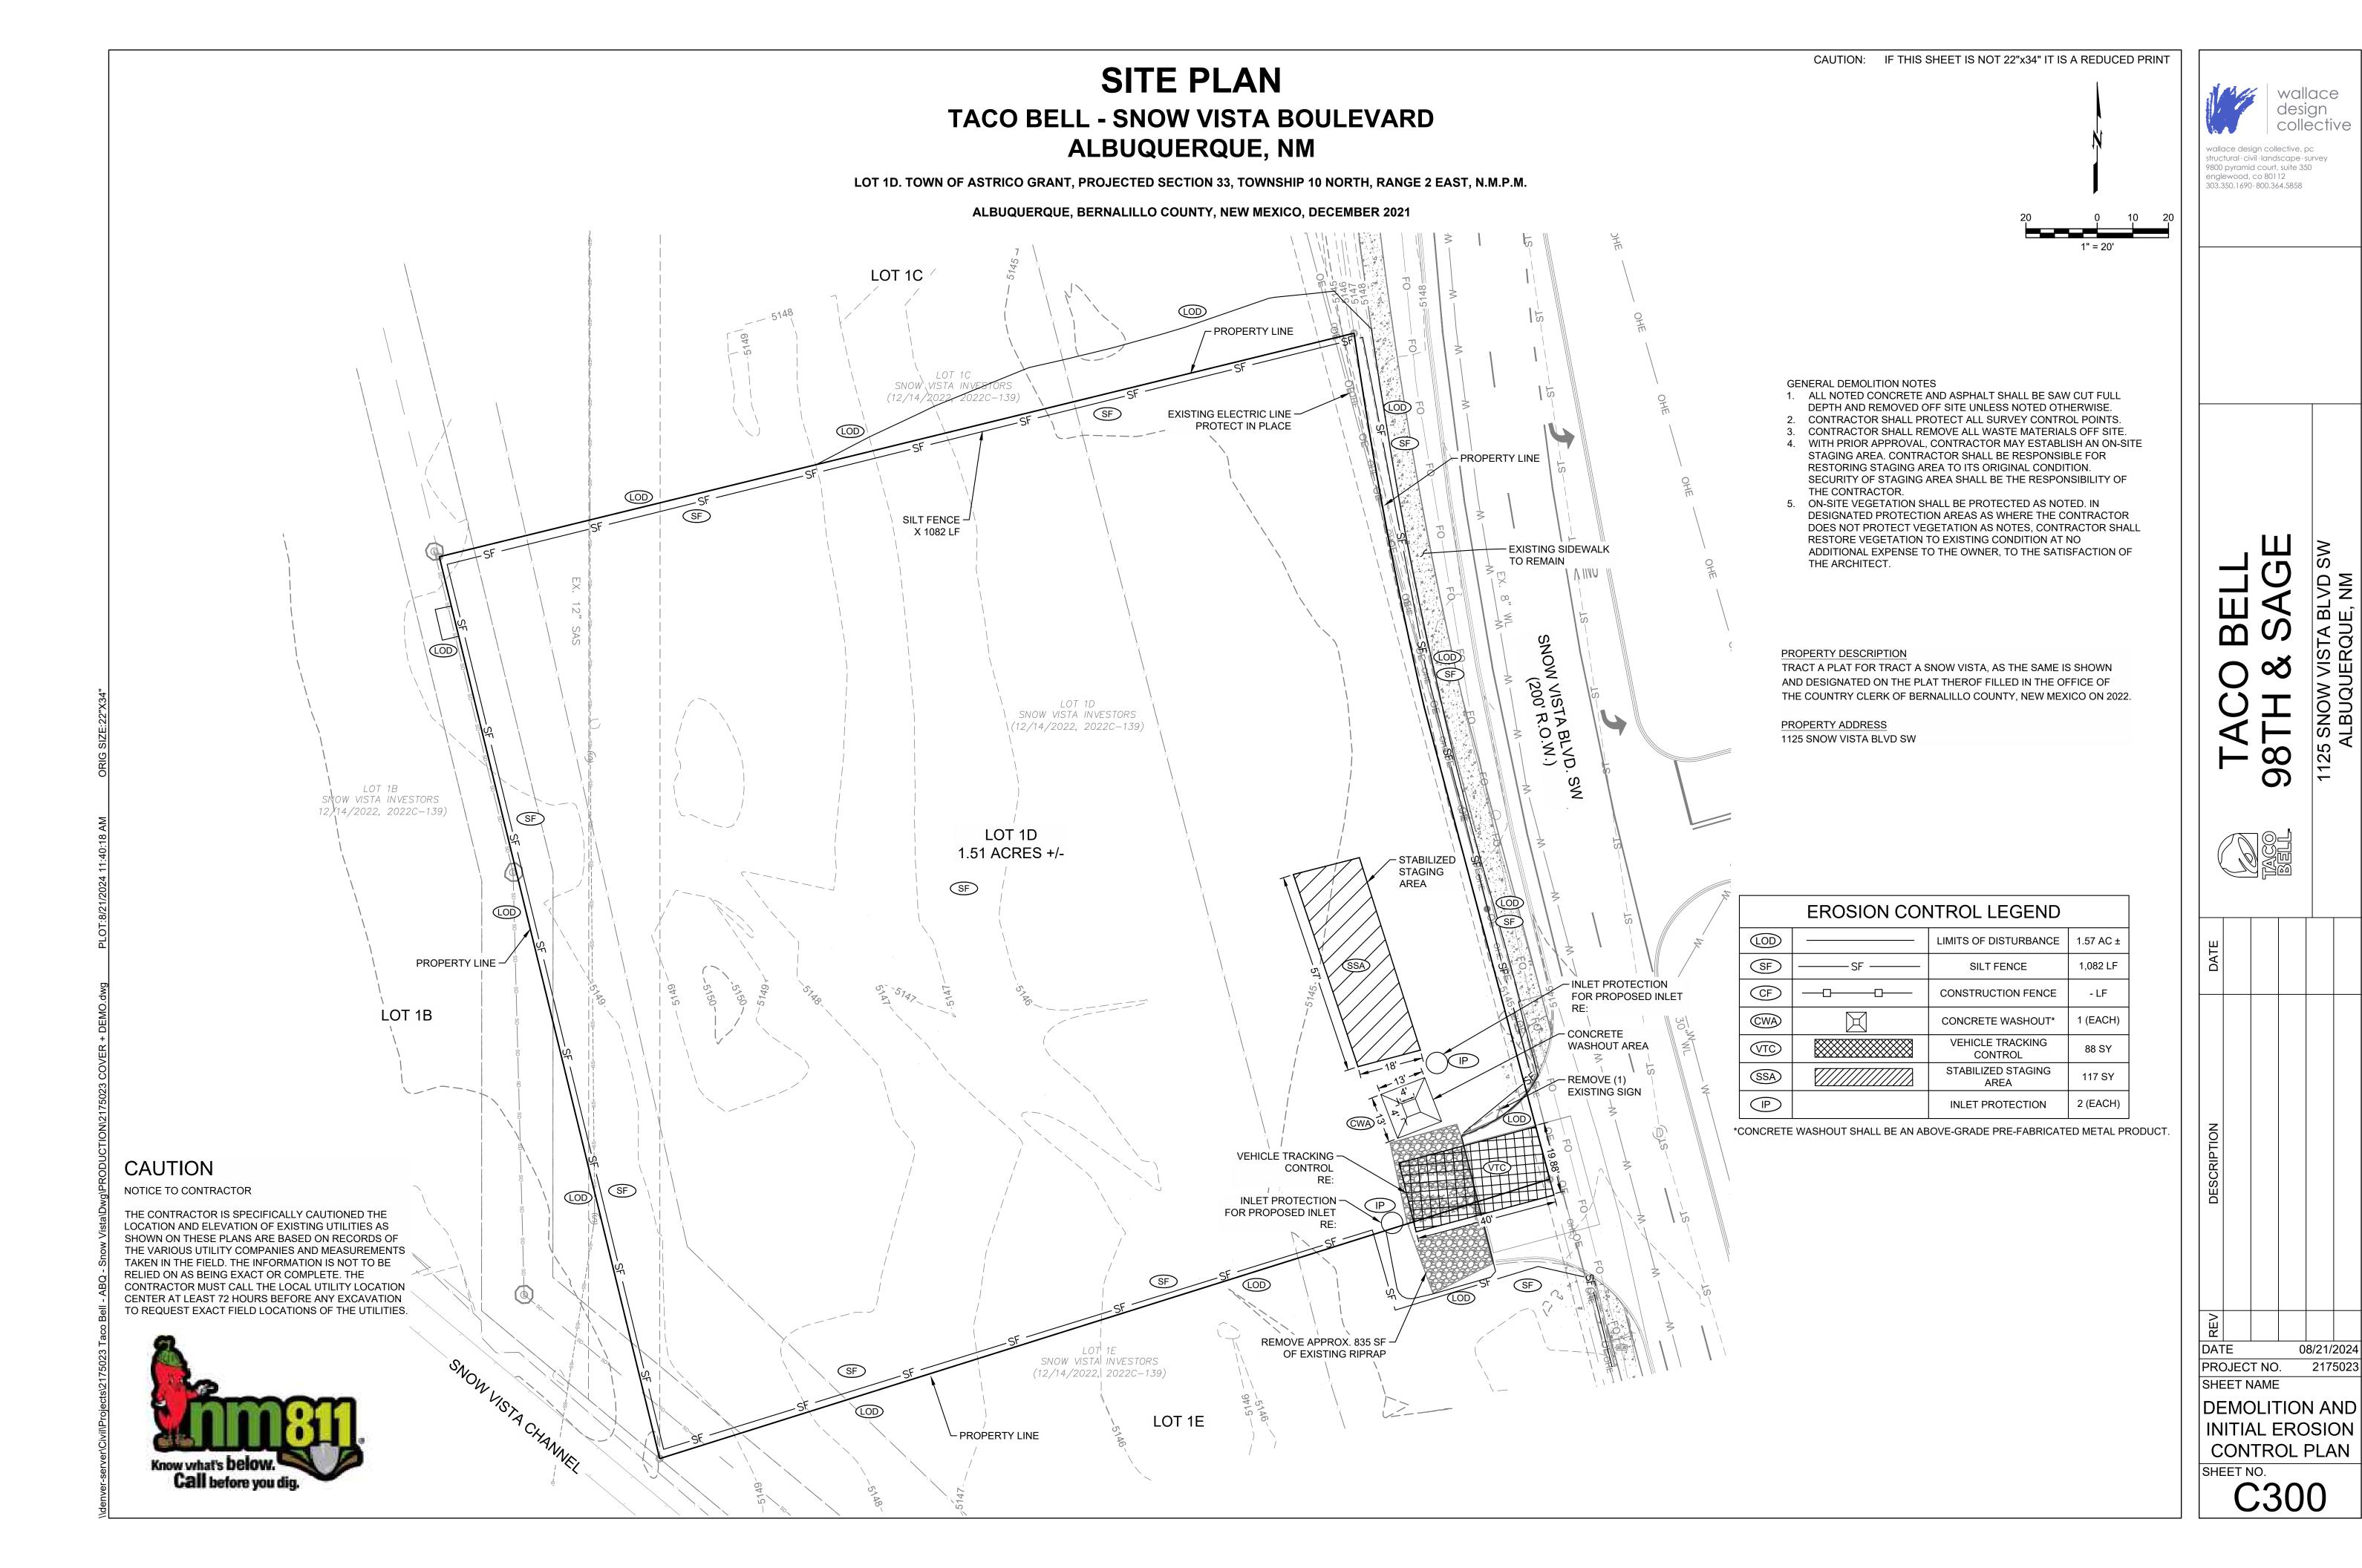

CAUTION: IF THIS SHEET IS NOT 22"x34" IT IS A REDUCED PRINT SITE PLAN PROPERTY DESCRIPTION TRACT A PLAT FOR TRACT A SNOW VISTA, AS THE SAME IS SHOWN AND DESIGNATED ON THE PLAT THEROF FILLED IN TACO BELL - SNOW VISTA BOULEVARD THE OFFICE OF THE COUNTRY CLERK OF BERNALILLO COUNTY, NEW MEXICO ON 2022. ALBUQUERQUE, NM PROPERTY ADDRESS 1125 SNOW VISTA BLVD SW LOT 1D. TOWN OF ASTRICO GRANT, PROJECTED SECTION 33, TOWNSHIP 10 NORTH, RANGE 2 EAST, N.M.P.M. ALBUQUERQUE, BERNALILLO COUNTY, NEW MEXICO, DECEMBER 2021 LOT 1C INSTALL RIPRAP RUNDOWN -GENERAL DEMOLITION NOTES **BEGIN ELEV:5146.00** ALL NOTED CONCRETE AND ASPHALT SHALL BE SAW CUT FULL END ELEV: 5144.50 DEPTH AND REMOVED OFF SITE UNLESS NOTED OTHERWISE. TYPE VL, 88 CF CONTRACTOR SHALL PROTECT ALL SURVEY CONTROL POINTS. 6'(W) X 12'(L) X 1'(D) CONTRACTOR SHALL REMOVE ALL WASTE MATERIALS OFF SITE. PROPERTY LINE WITH PRIOR APPROVAL, CONTRACTOR MAY ESTABLISH AN ON-SITE INSTALL RIPRAP RUNDOWN -STAGING AREA. CONTRACTOR SHALL BE RESPONSIBLE FOR BEGIN ELEV:5147.00 RESTORING STAGING AREA TO ITS ORIGINAL CONDITION. END ELEV: 5144.50 - INSTALL RIPRAP PAD SECURITY OF STAGING AREA SHALL BE THE RESPONSIBILITY OF TYPE VL,117 CF -INSTALL RIPRAP RUNDOWN -TOP ELEV:5147.00 THE CONTRACTOR. 4.5'(W) X 26'(L) X 1'(D) **BEGIN ELEV:5146.50** BOTTOM ELEV: 5145.82 ON-SITE VEGETATION SHALL BE PROTECTED AS NOTED. IN END ELEV: 5144.50 TYPE VL, 28 CF DESIGNATED PROTECTION AREAS AS WHERE THE CONTRACTOR TYPE VL, 84 CF 4'(W) X 7'(L) X 1'(D) DOES NOT PROTECT VEGETATION AS NOTES, CONTRACTOR SHALL 6'(W) X 14'(L) X 1'(D) RESTORE VEGETATION TO EXISTING CONDITION AT NO ADDITIONAL EXPENSE TO THE OWNER, TO THE SATISFACTION OF INSTALL RIPRAP PAD THE ARCHITECT. TOP ELEV:5146.50 BOTTOM ELEV: 5145.50 TYPE VL, 28 CF 4'(W) X 7'(L) X 1'(D) - INSTALL RIPRAP RUNDOWN BEGIN ELEV:5146.00 END ELEV: 5144.00 **EROSION CONTROL LEGEND** TYPE VL, 48 CF 4'(W) X 12'(L) X 1'(D) LOD LIMITS OF DISTURBANCE | 1.51 AC ± SNOW VISTA BLVD. SF 1 (EACH) SILT FENCE PERMANENT SEEDING & (PS/M) 0.59 AC ± MULCHING 1,842 SY **ASPHALT PAVEMENT CONCRETE PAVEMENT** 1,244 SY W/ VALLEY PANS, CURB, GUTTER CONCRETE SIDEWALK 300 SY LOT 1B LOT 1D **LEGEND** 1.51 ACRES +/-PS/M LANDSCAPE AREA *** * * *** PROPERTY LINE -BUILDING FF 5148.54 STANDARD DUTY ASPHALT PAVEMENT RE: GEOTECH STABILIZED STANDARD DUTY CONCRETE PAVEMENT STAGING RE: GEOTECH AREA REMOVE INLET REINFORCED CONCRETE PAD PROTECTION RE: ARCH CONCRETI CONCRETE SIDEWALK RE: 3/C600 RIPRAP PS/M - INSTALL RIPRAP RUNDOWN (REFER TO PLAN LABELS) REMOVE INLET BEGIN ELEV:5147.17 REMOVE PROTECTION END ELEV: 5145.00 **VEHICLE** NSTALL RIPRAP RUNDOWN EXISTING CONCRETE SIDEWALK TYPE VL, 40 CF **BEGIN ELEV:5146.50 TRACKING** CAUTION 4'(W) X 10'(L) X 1'(D) END ELEV: 5145.00 TYPE VL, 140 CF NOTICE TO CONTRACTOR 7'(W) X 20'(L) X 1'(D) — • • • DRAINAGE FLOW PATH THE CONTRACTOR IS SPECIFICALLY CAUTIONED THE LOCATION AND ELEVATION OF EXISTING UTILITIES AS SHOWN ON THESE PLANS ARE BASED ON RECORDS OF THE VARIOUS UTILITY COMPANIES AND MEASUREMENTS TAKEN IN THE FIELD. THE INFORMATION IS NOT TO BE RELIED ON AS BEING EXACT OR COMPLETE. THE CONTRACTOR MUST CALL THE LOCAL UTILITY LOCATION CENTER AT LEAST 72 HOURS BEFORE ANY EXCAVATION TO REQUEST EXACT FIELD LOCATIONS OF THE UTILITIES. DATE LOT 1E PROPERTY LINE


wallace design collective wallace design collective structural·civil·landscape·survey 9800 pyramid court, suite 350

wallace design collective, pc structural·civil·landscape·survey 9800 pyramid court, suite 350 englewood, co 80112 303.350.1690·800.364.5858

TH & SAGE

DATE 08/21/2024
PROJECT NO. 2175023
SHEET NAME

FINAL EROSION
CONTROL PLAN
SHEET NO.

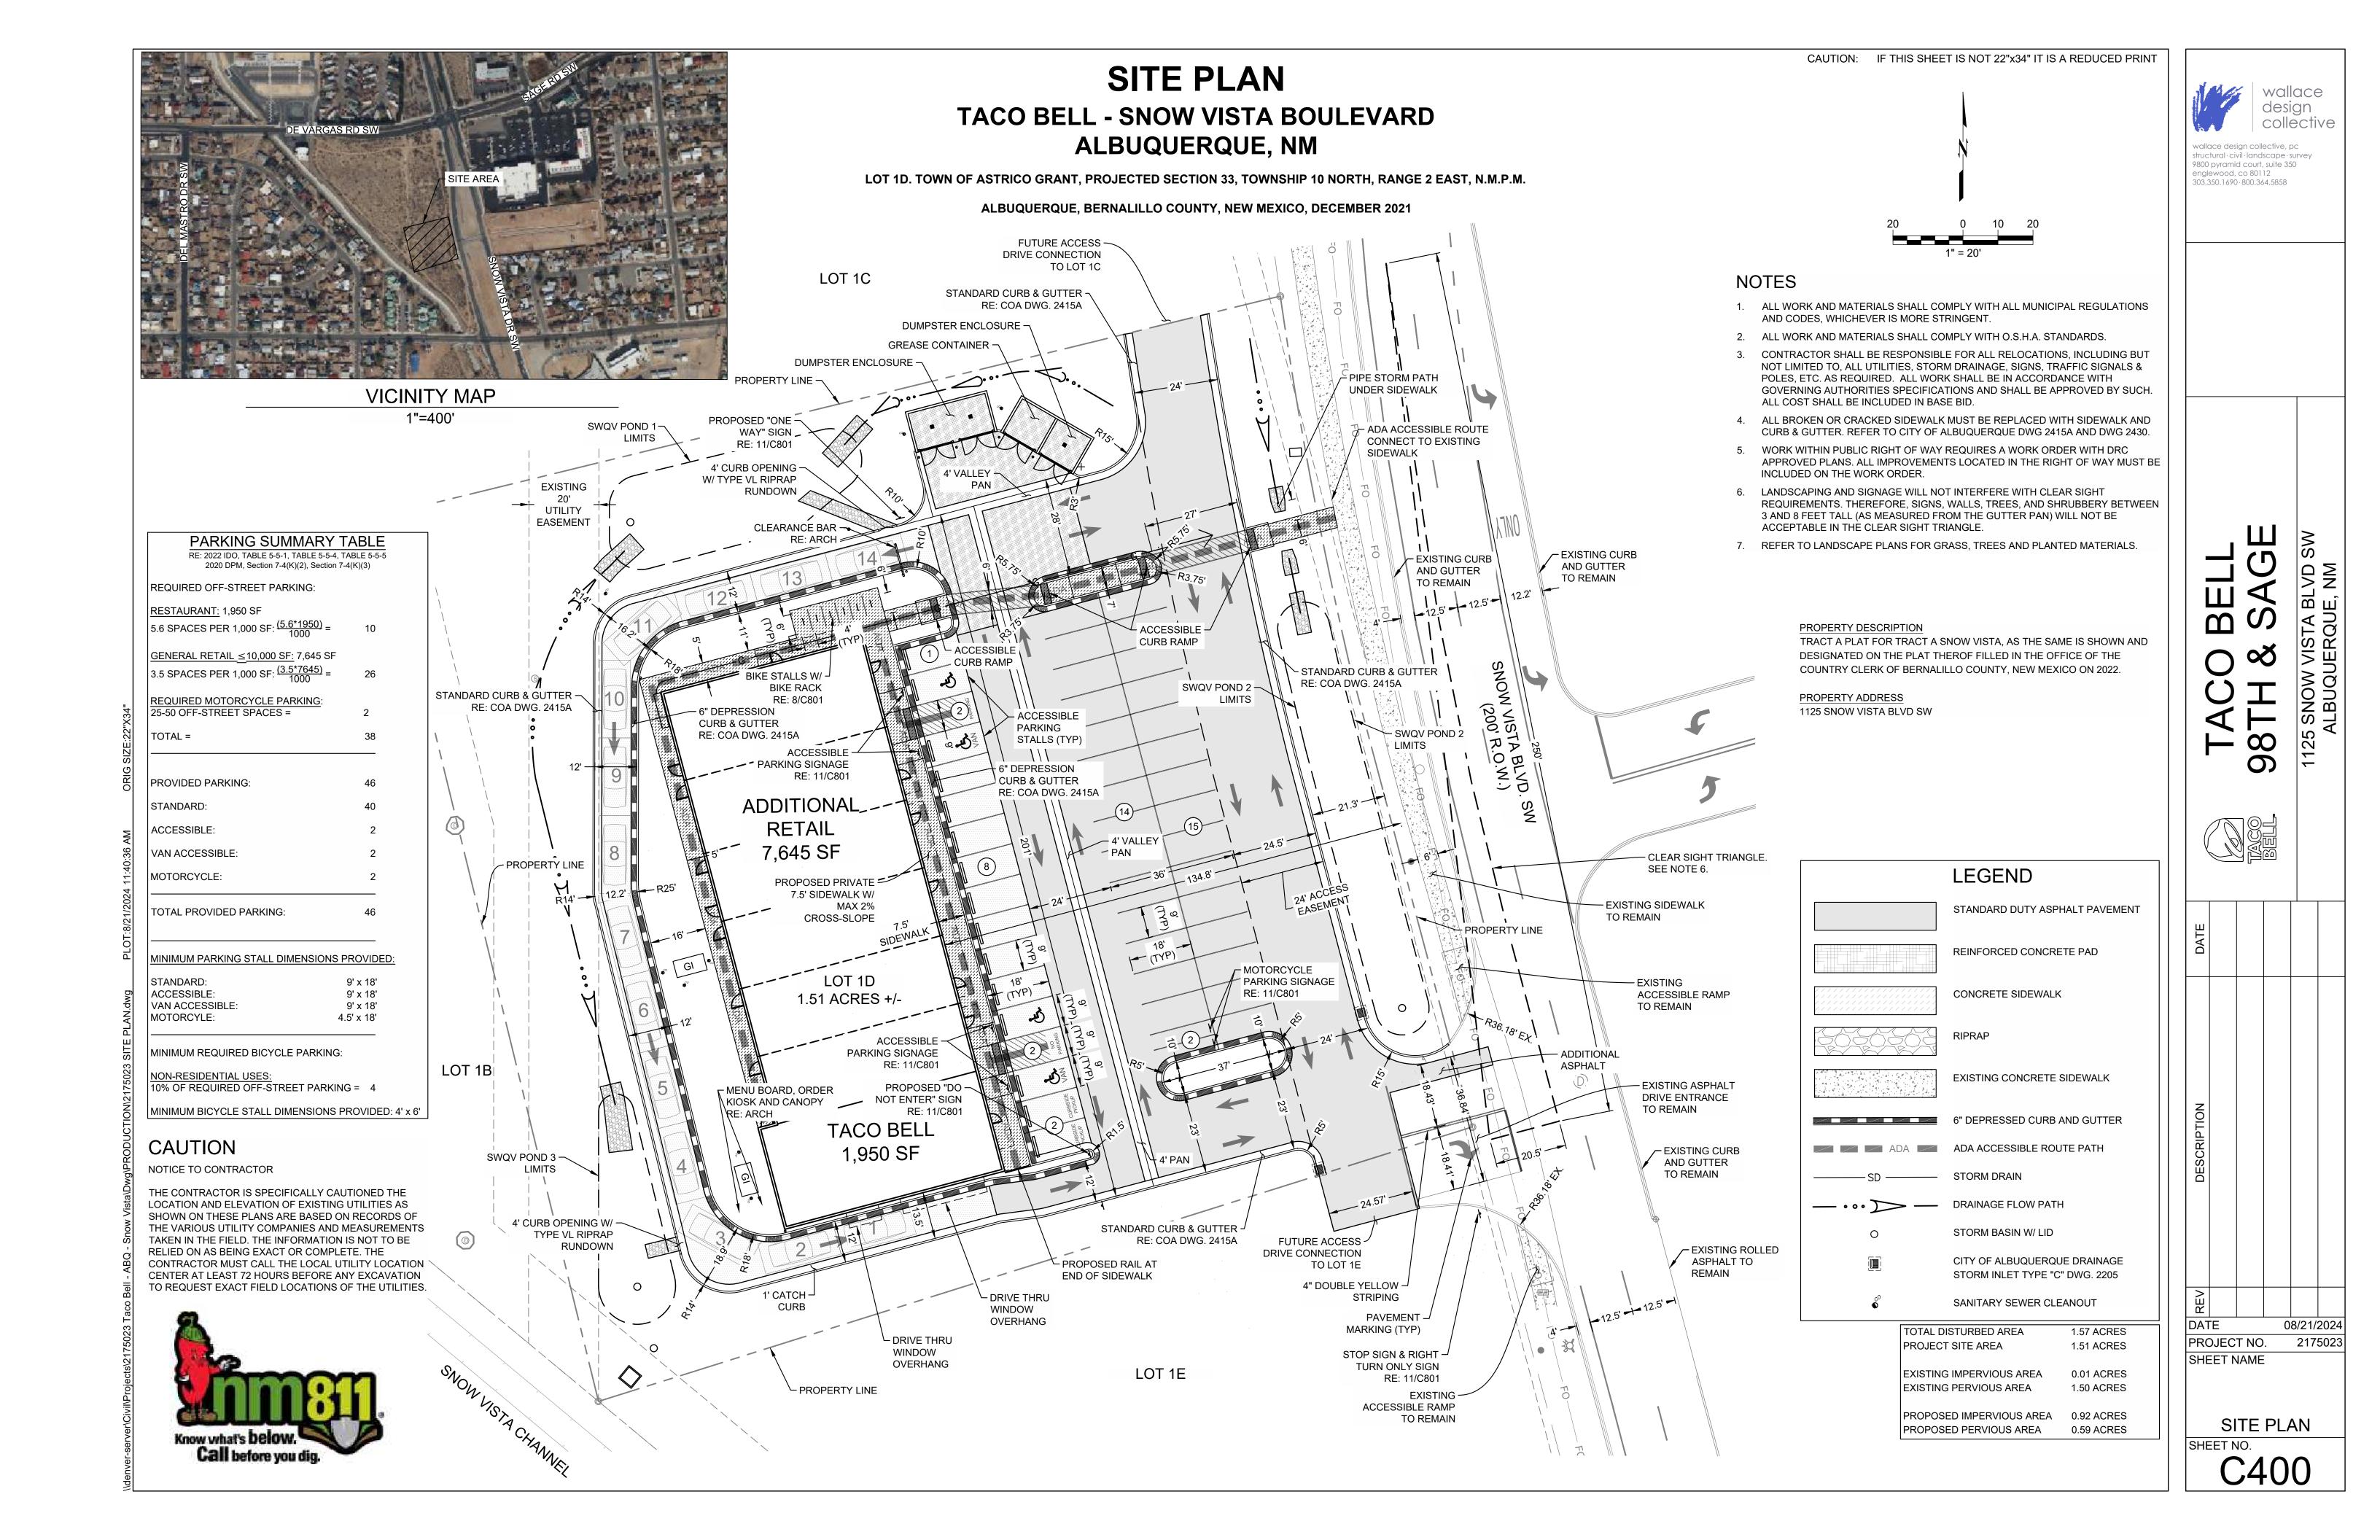



S BELL & SAGE

0

DATE 08/21/2024

GRADING PLAN

2175023

PROJECT NO.

SHEET NAME



08/21/2024

2175023

PROJECT NO.

SHEET NAME

SHEET NO.


DRAINAGE PLAN





TACO BELL - SNOW VISTA BOULEVARD ALBUQUERQUE, NM

LOT 1D. TOWN OF ASTRICO GRANT, PROJECTED SECTION 33, TOWNSHIP 10 NORTH, RANGE 2 EAST, N.M.P.M.

ALBUQUERQUE, BERNALILLO COUNTY, NEW MEXICO, DECEMBER 2021

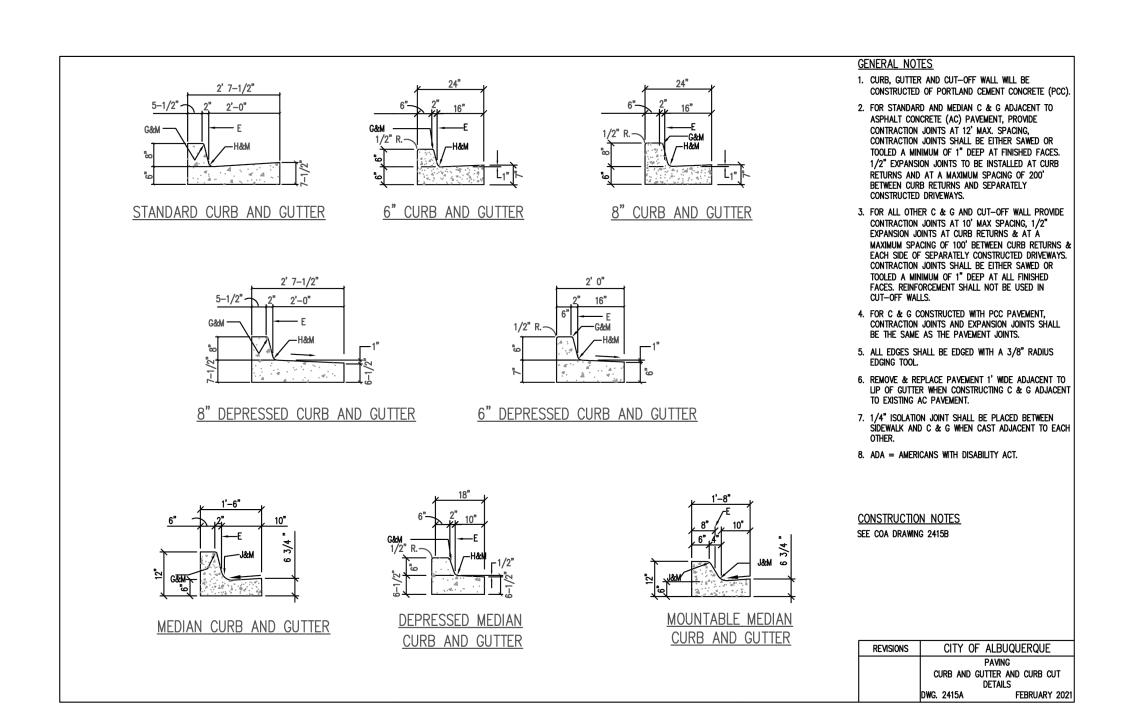

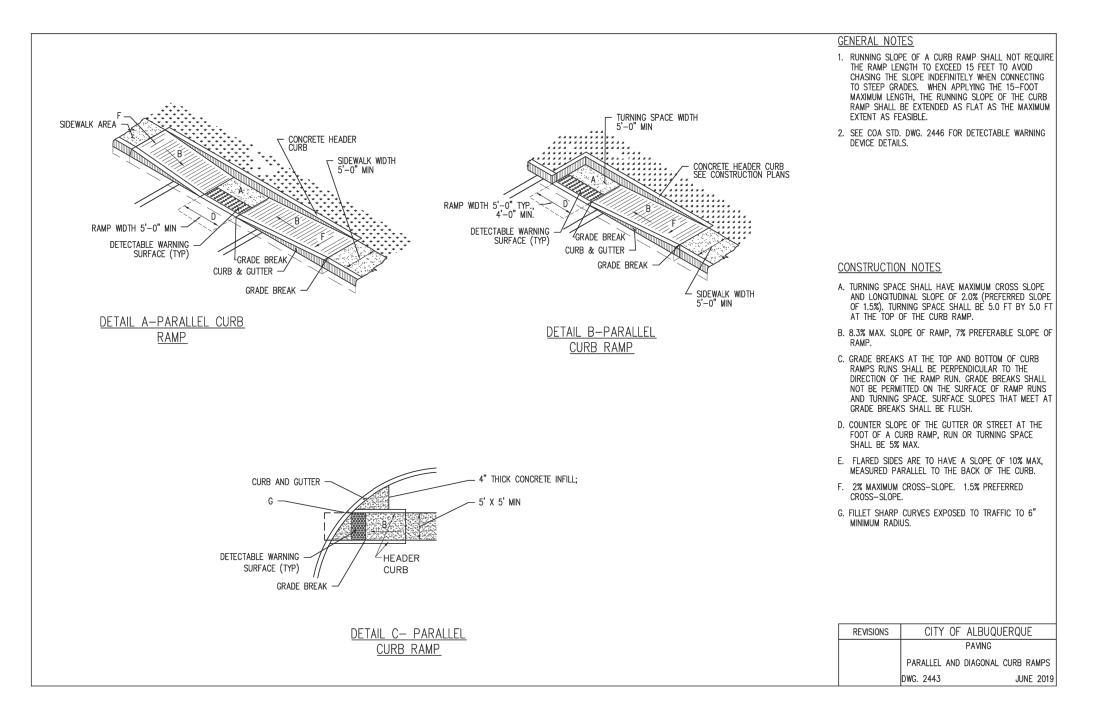

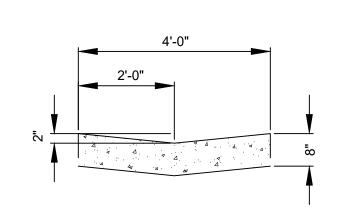



CURB RAMP DETAILS SCALE: NTS

 $\frac{1}{2}$ " JOINT

4' VALLEY PAN SCALE: NTS

CURB AND GUTTER SCALE: NTS

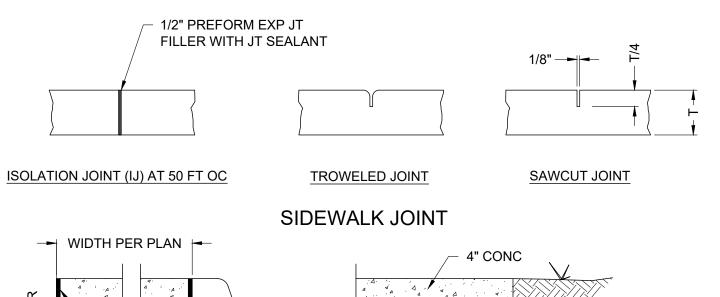

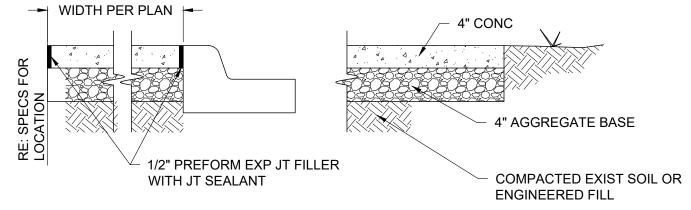

1. SIDEWALK TO HAVE 2% CROSS SLOPE MAX. 2. SIDEWALK JOINT SPACING TO EQUAL SIDEWALK WIDTH (TYP.)

SEE ENLARGEMENT ALL JOINTS **SMOOTH DOWELS** ENLARGEMENT GREASE ONE END BACKER ROD ALL JOINTS ½" PREFORM EXP JT FILLER AT CONSTRUCTION & ISOLATION ISOLATION SAWCUT CONSTRUCTION JOINT ONLY JOINT (IJ) JOINT (SJ) JOINT (CJ) **ENLARGEMENT** JOINTS NOT SHOWN OTHERWISE SHALL BE "D" DOWEL SAW JOINTS. SAW JOINTS SHALL BE MADE PAVEMENT DIAMETER "E" SAWCUT MAX JOINT WITHIN 10 HOURS AFTER CONCRETE POUR. THICKNESS | @12" C/C LENGTH **EMBEDMENT** DEPTH SPACING CONCRETE PAVING JOINT SPACING 14" 1 ½" SEE SCHEDULE 1 ³/₄"

ENLARGEMENT

JOINT SEALANT

12.5'

15'

15'

SAW CUT EXISTING ASPHALT SURFACE **ASPHALT** 2'-0" MIN **EXISTING ASPHALT ASPHALT** BASE EXISTING NEW PAVEMENT PAVEMENT

RE: PAVEMENT DETAIL FOR THICKNESS "T"

5 CONCRESCALE: NTS CONCRETE JOINT DETAIL


ALL DOWELS & BARS TO BE EPOXY COATED

SIDEWALK SCALE: NTS

ASPHALT TRANSITION SCALE: NTS

wallace collective allace design collective, pc tructural · civil · landscape · survey 9800 pyramid court, suite 350 englewood, co 80112 303.350.1690 · 800.364.5858


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DETAILS

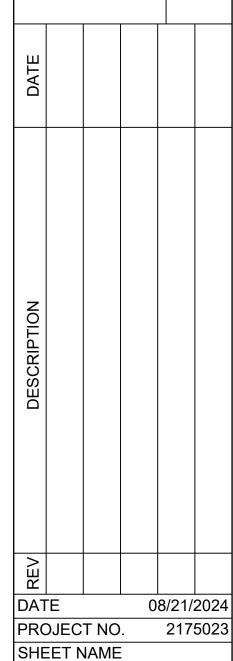TACO BELL - SNOW VISTA BOULEVARD ALBUQUERQUE, NM

LOT 1D. TOWN OF ASTRICO GRANT, PROJECTED SECTION 33, TOWNSHIP 10 NORTH, RANGE 2 EAST, N.M.P.M.



3'-8"
1'-5"
10"
1'-5"
10"
1'-5"
2'-8"

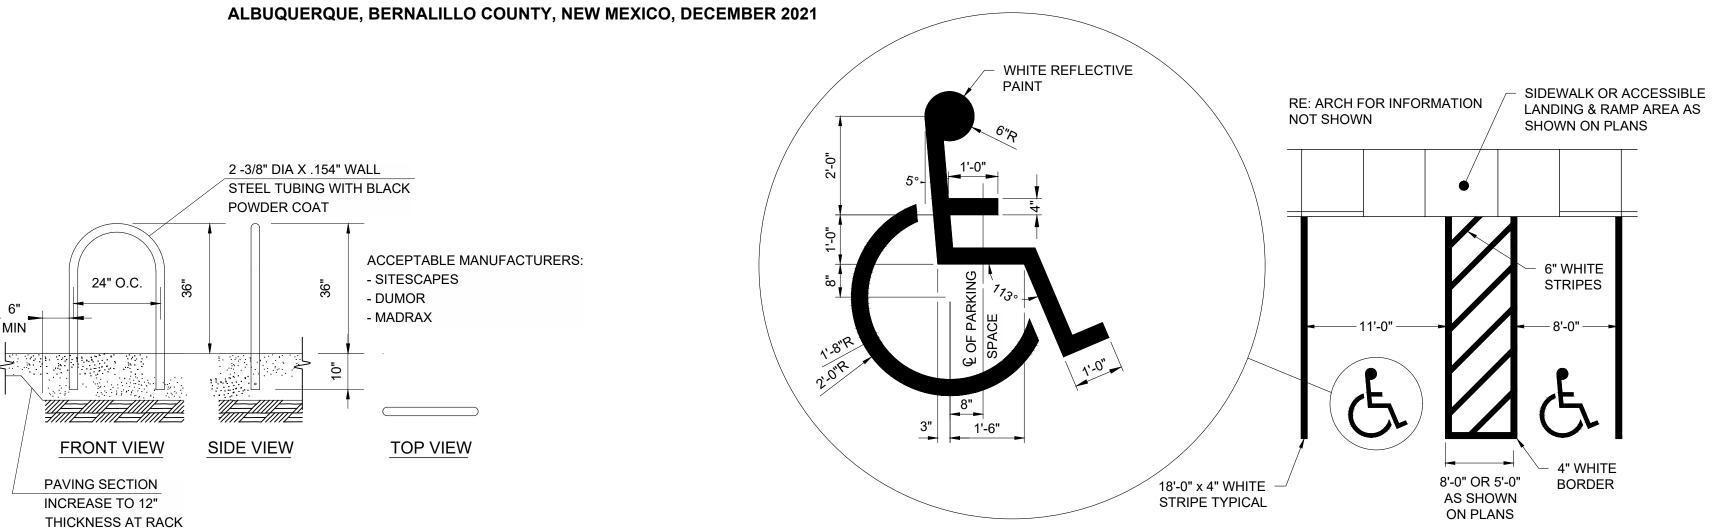
PAINT WHITE

1'-3"

8 BIKE RACK
SCALE: NTS

ACCESSIBLE STRIPING

SCALE: NTS

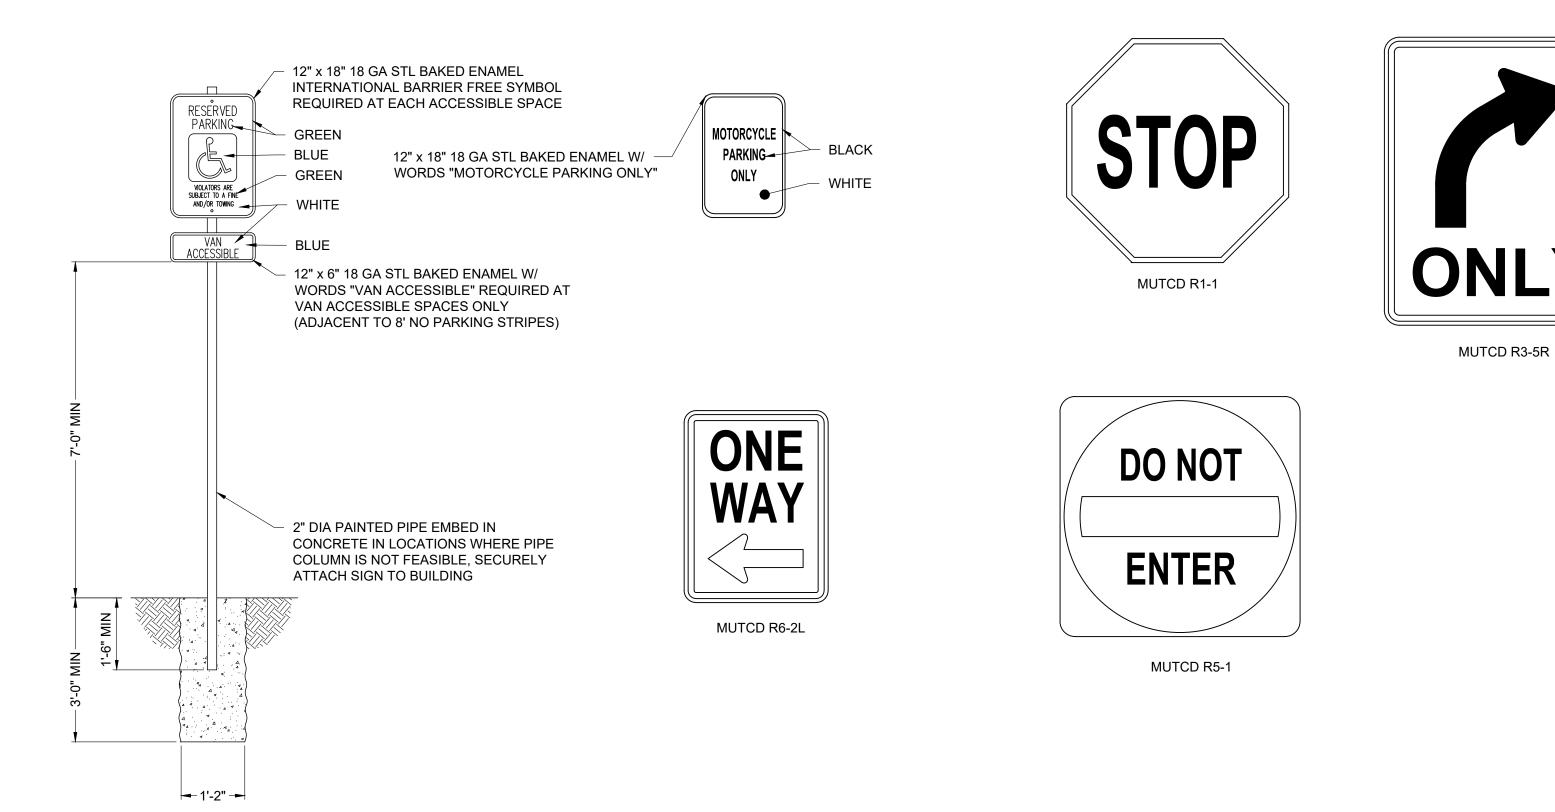

ADA/ MOTORCYCLE/ STOP/ ONE WAY/ DO NOT ENTER / RIGHT ONLY SIGN DETAILS

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TACO BELL 98TH & SAGE 1125 SNOW VISTA BLVD SW

DATE 08/21/2024
PROJECT NO. 2175023
SHEET NAME

SCALE: NTS

SCALE: NTS


DETAILS SHEET NO.


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TACO BELL - SNOW VISTA BOULEVARD ALBUQUERQUE, NM


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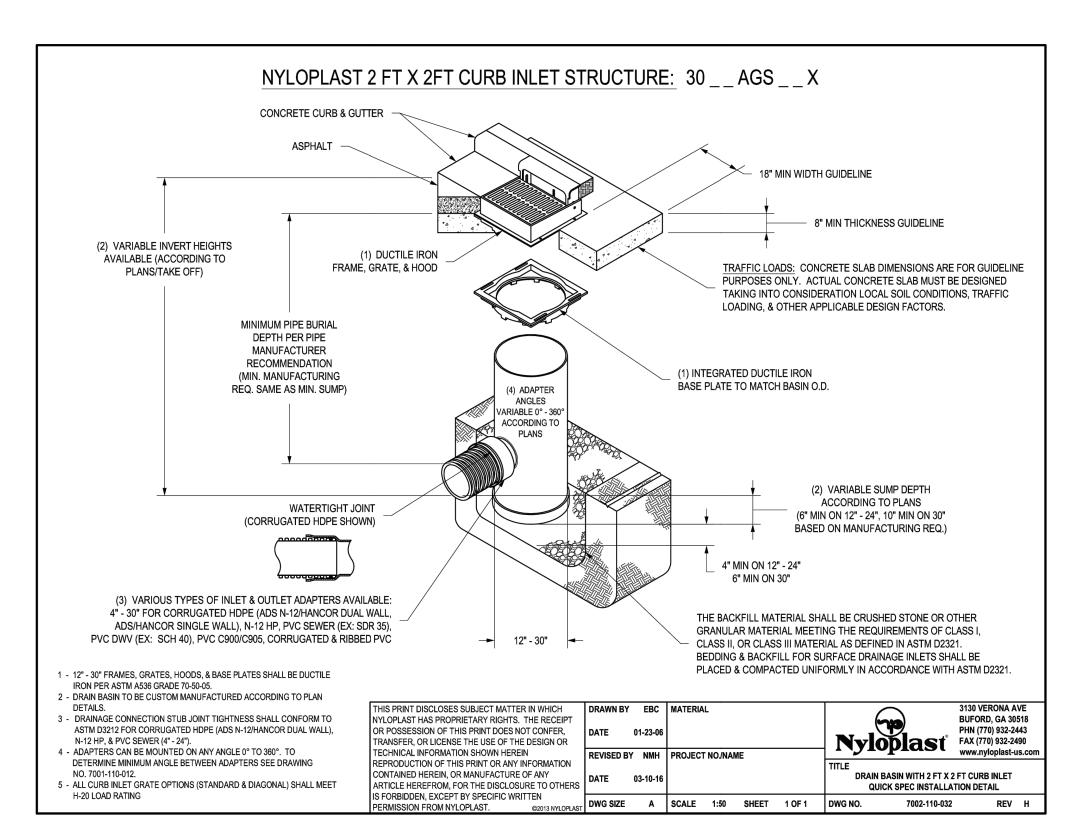
ALBUQUERQUE, BERNALILLO COUNTY, NEW MEXICO, DECEMBER 2021




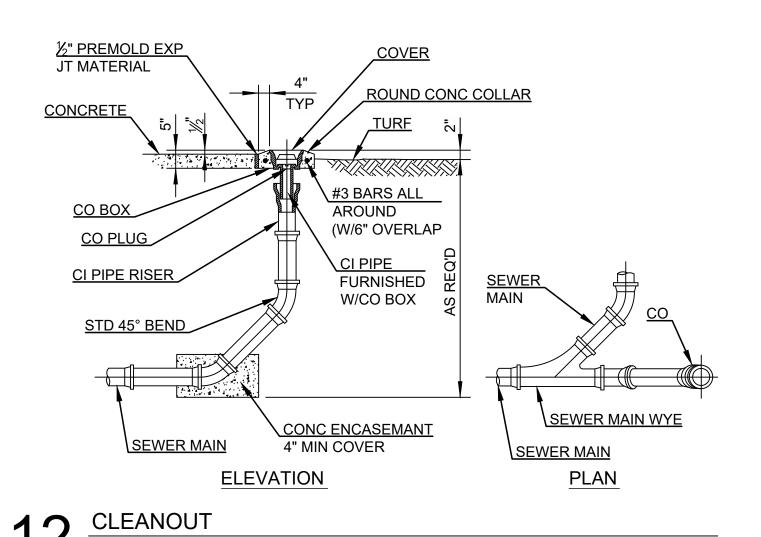


DOWNSPOUT TO STORMDRAIN CONNECTION

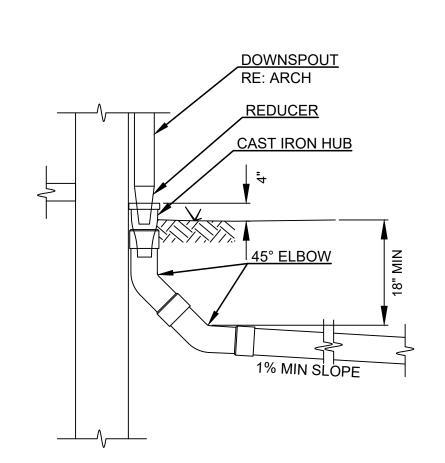

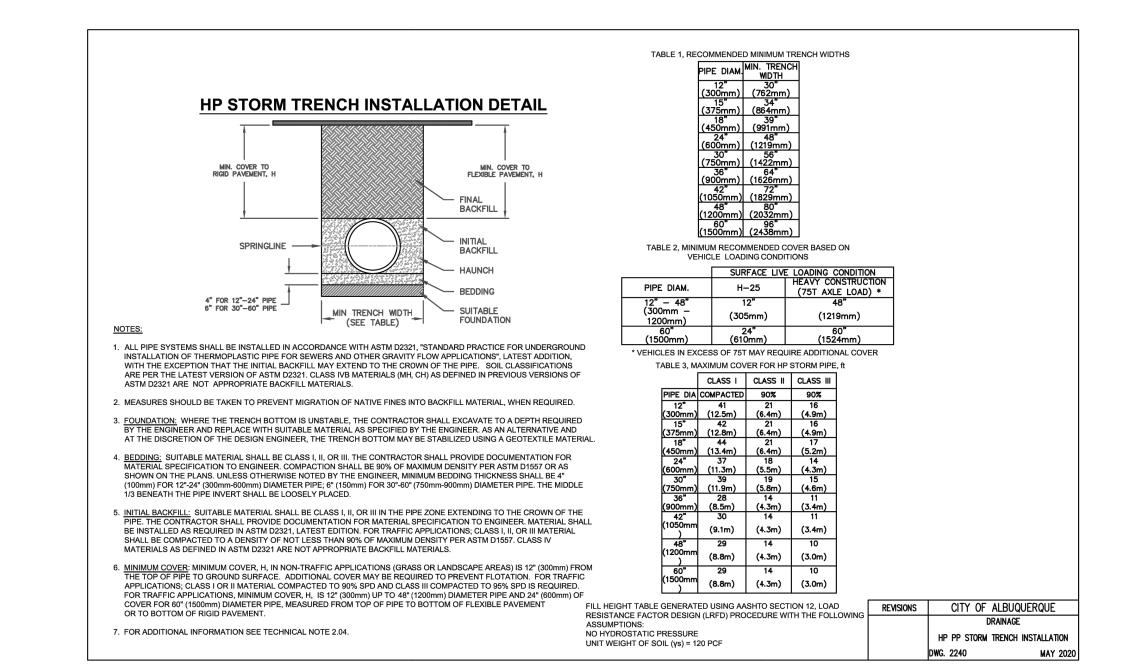

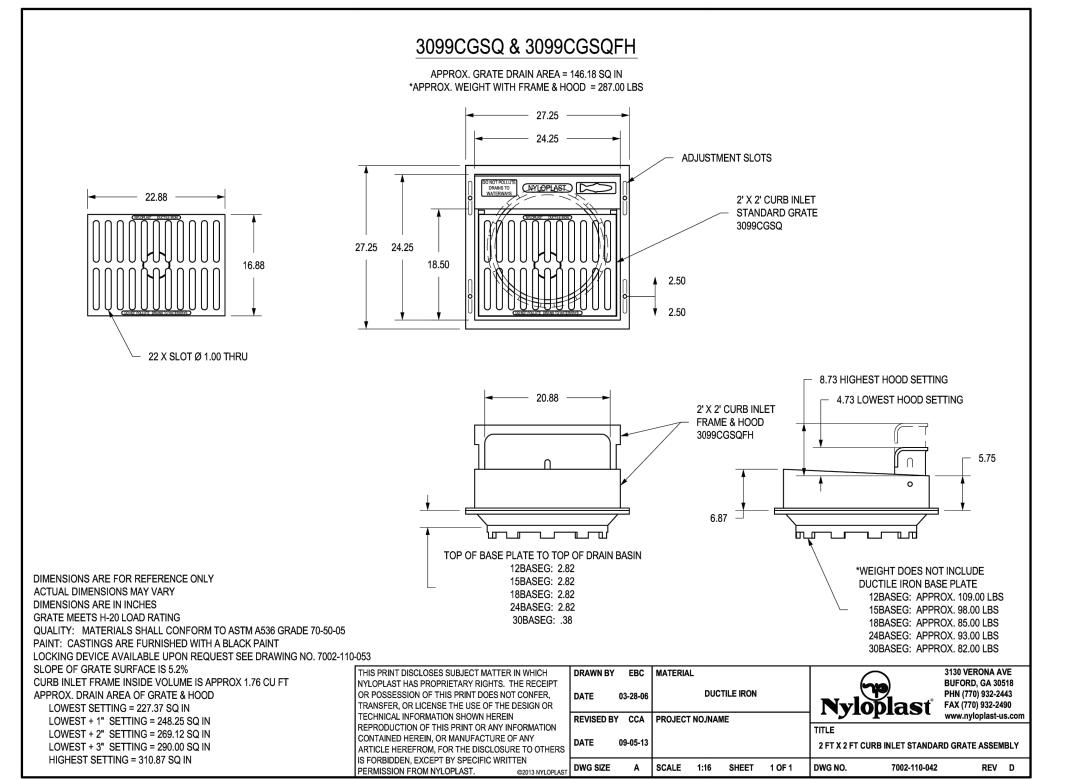



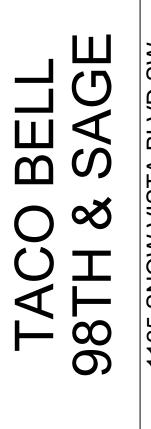


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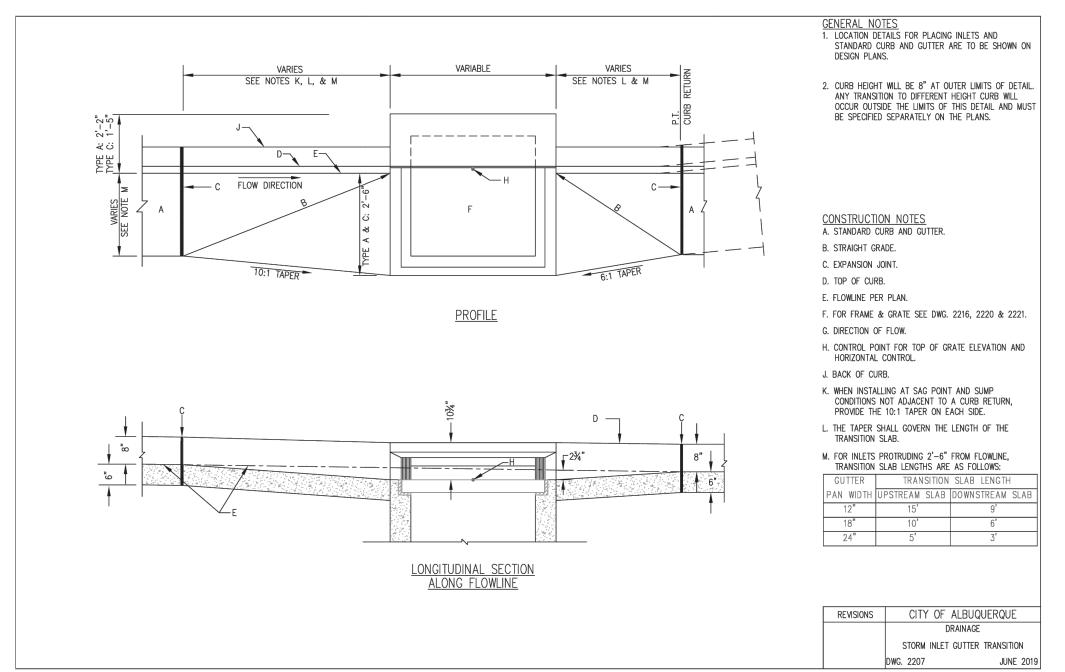
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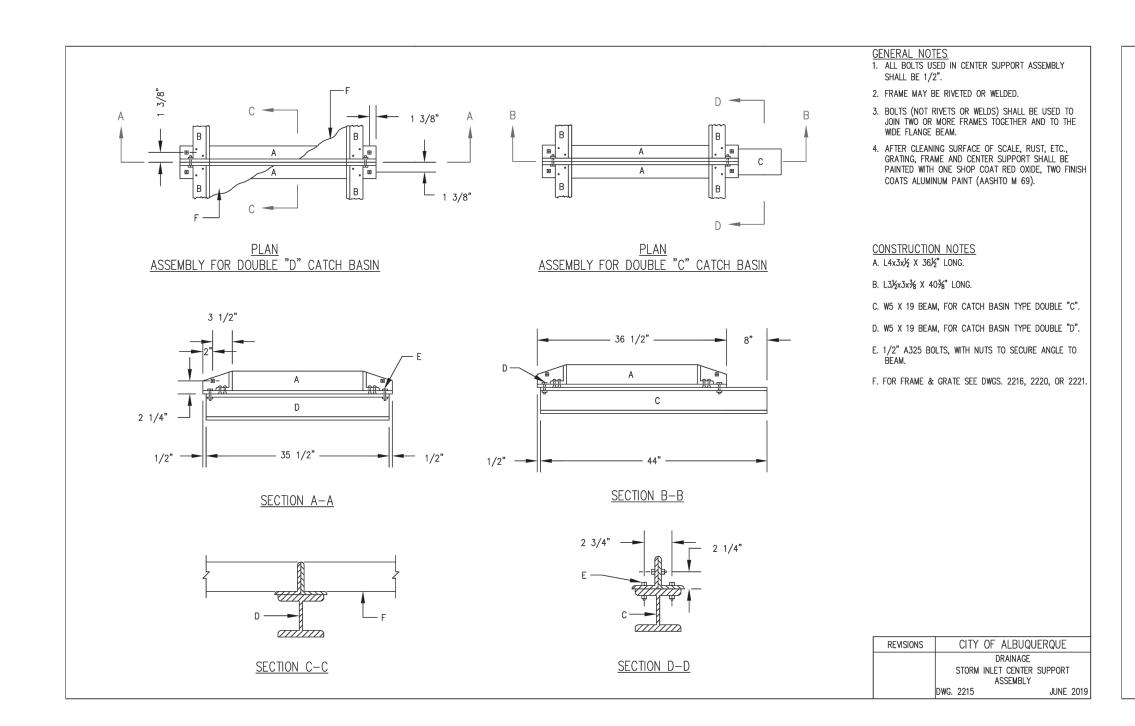
TACO BELL - SNOW VISTA BOULEVARD ALBUQUERQUE, NM


LOT 1D. TOWN OF ASTRICO GRANT, PROJECTED SECTION 33, TOWNSHIP 10 NORTH, RANGE 2 EAST, N.M.P.M.

ALBUQUERQUE, BERNALILLO COUNTY, NEW MEXICO, DECEMBER 2021





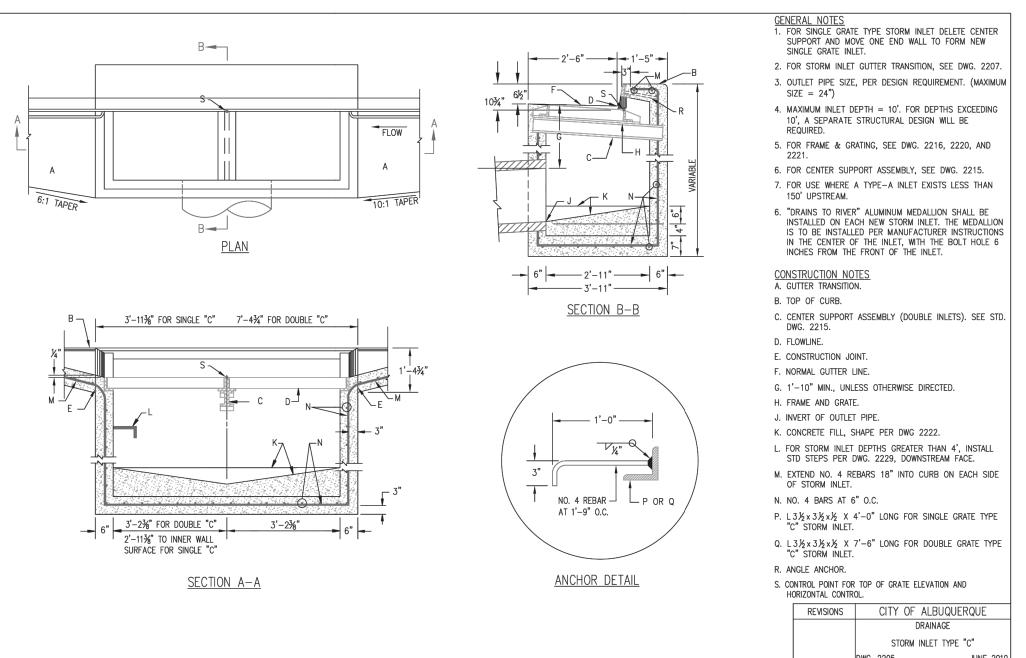

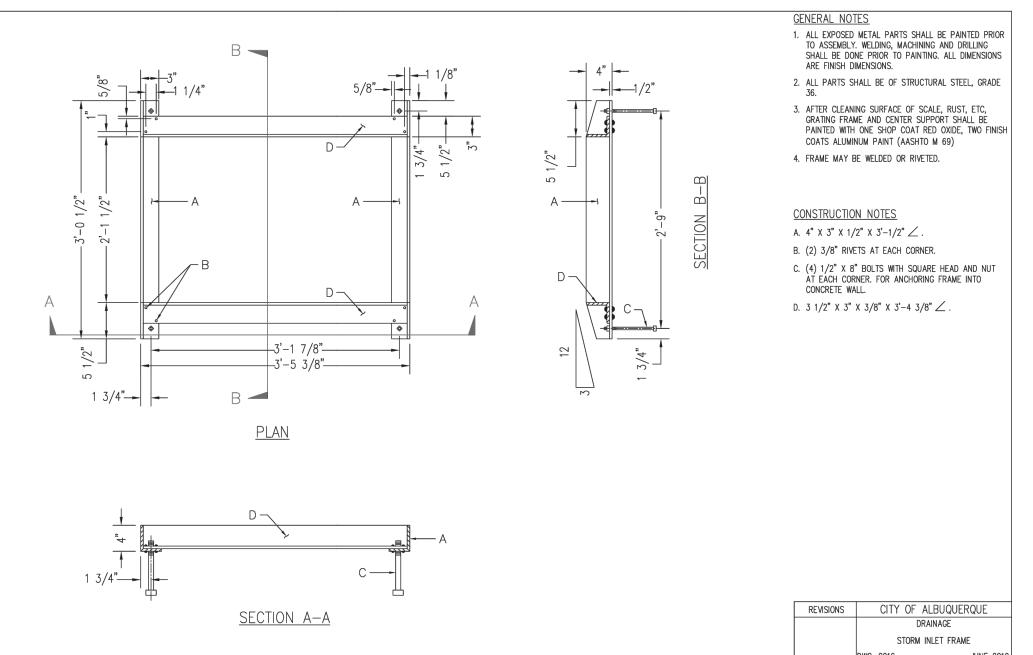



98TH & SAGE


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PROJECT NO. 2175023						
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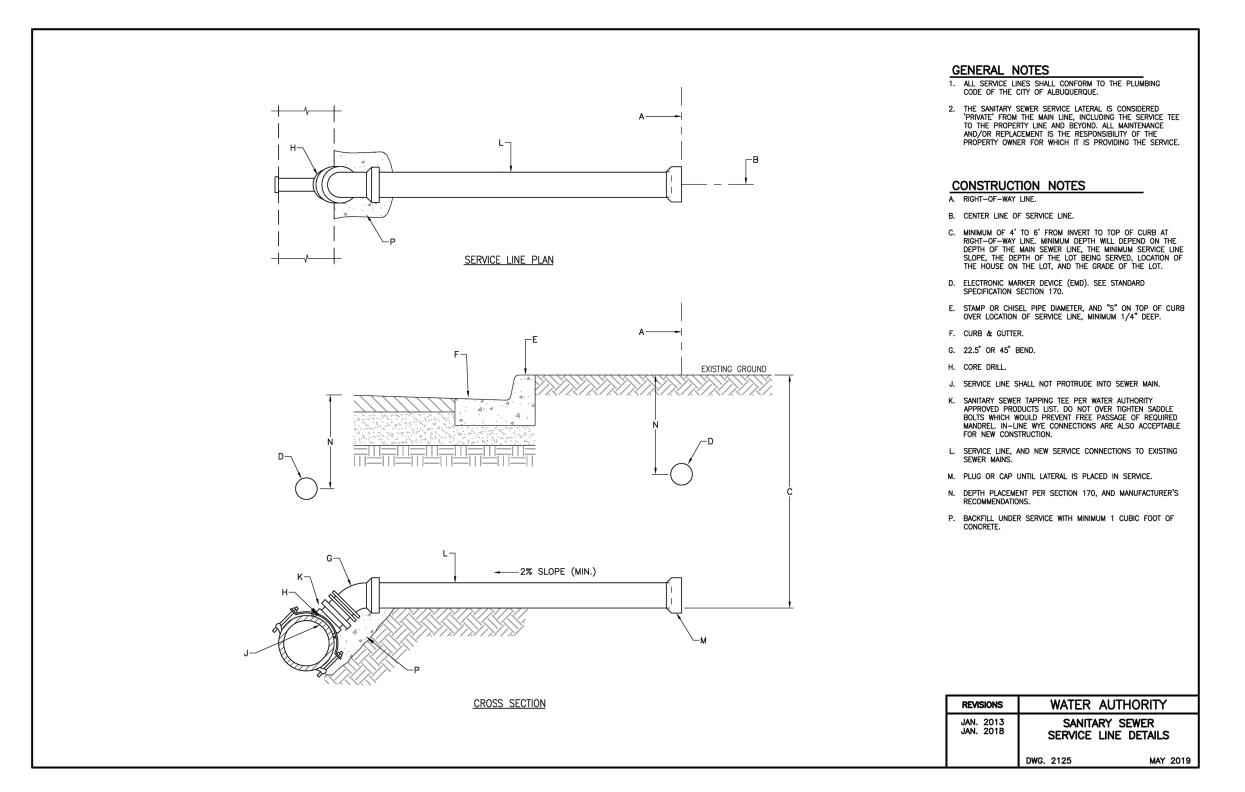
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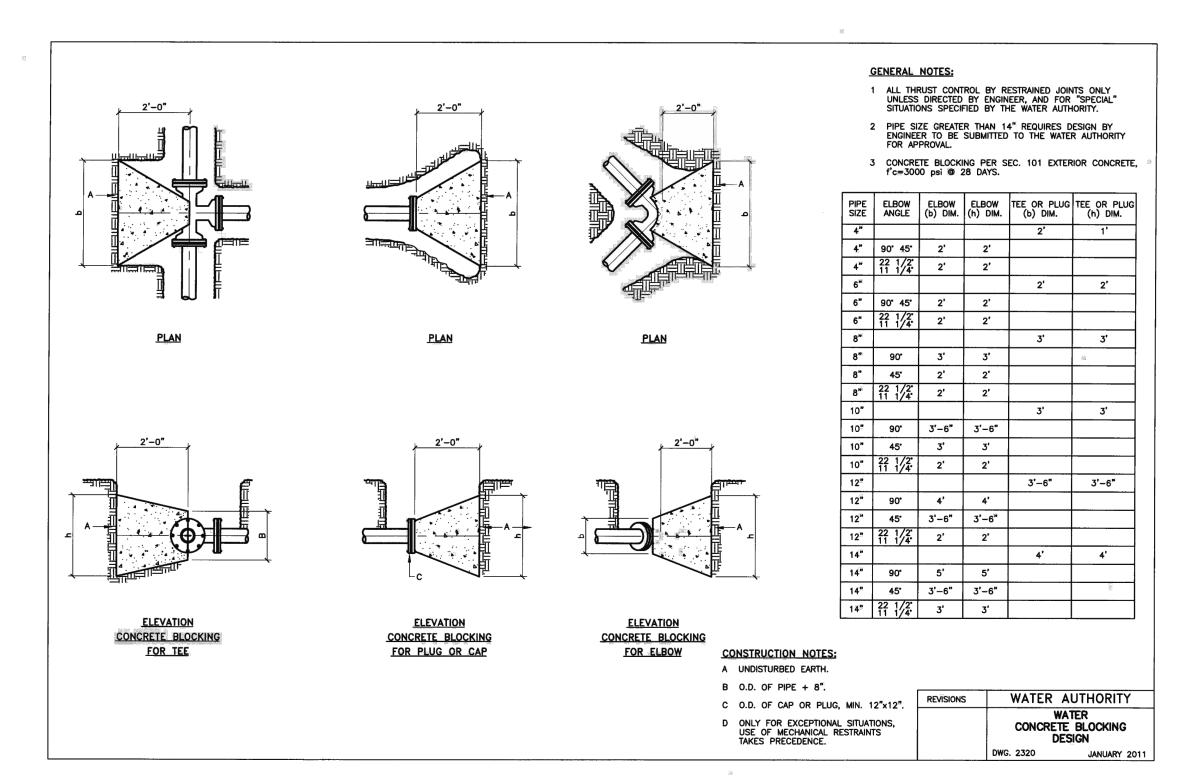
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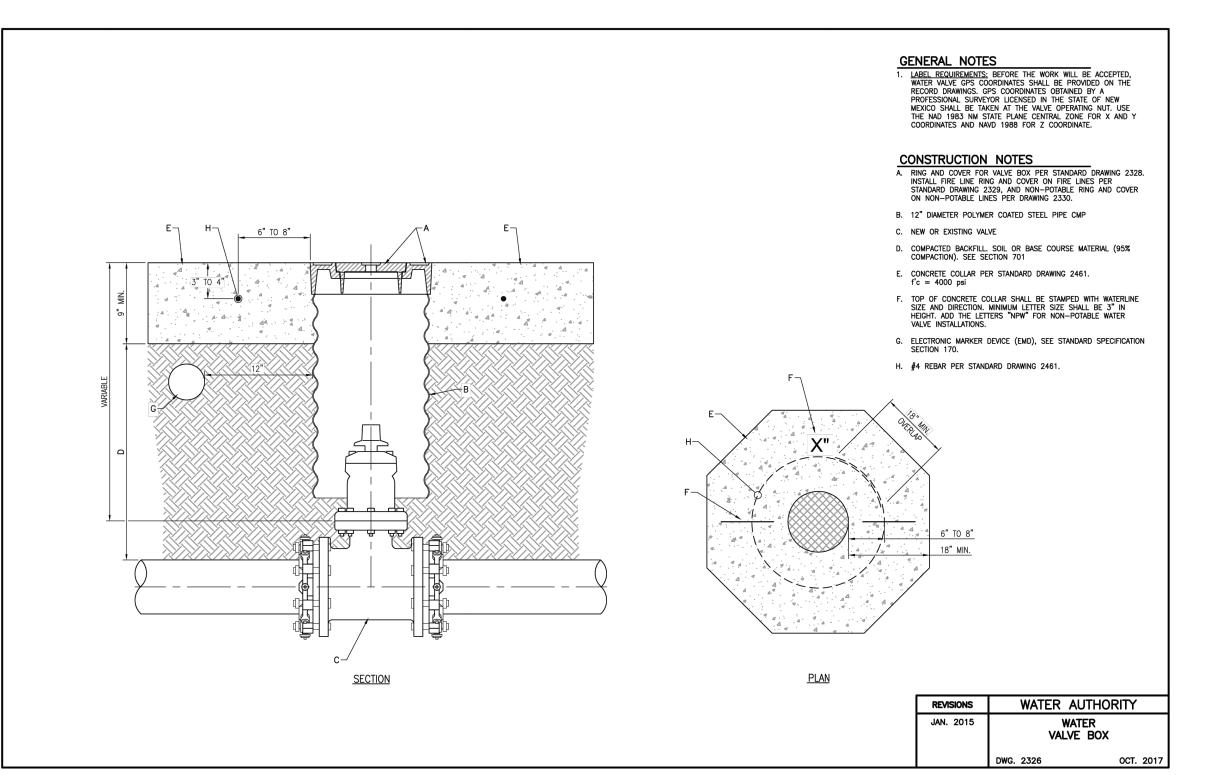
LOT 1D. TOWN OF ASTRICO GRANT, PROJECTED SECTION 33, TOWNSHIP 10 NORTH, RANGE 2 EAST, N.M.P.M.

ALBUQUERQUE, BERNALILLO COUNTY, NEW MEXICO, DECEMBER 2021







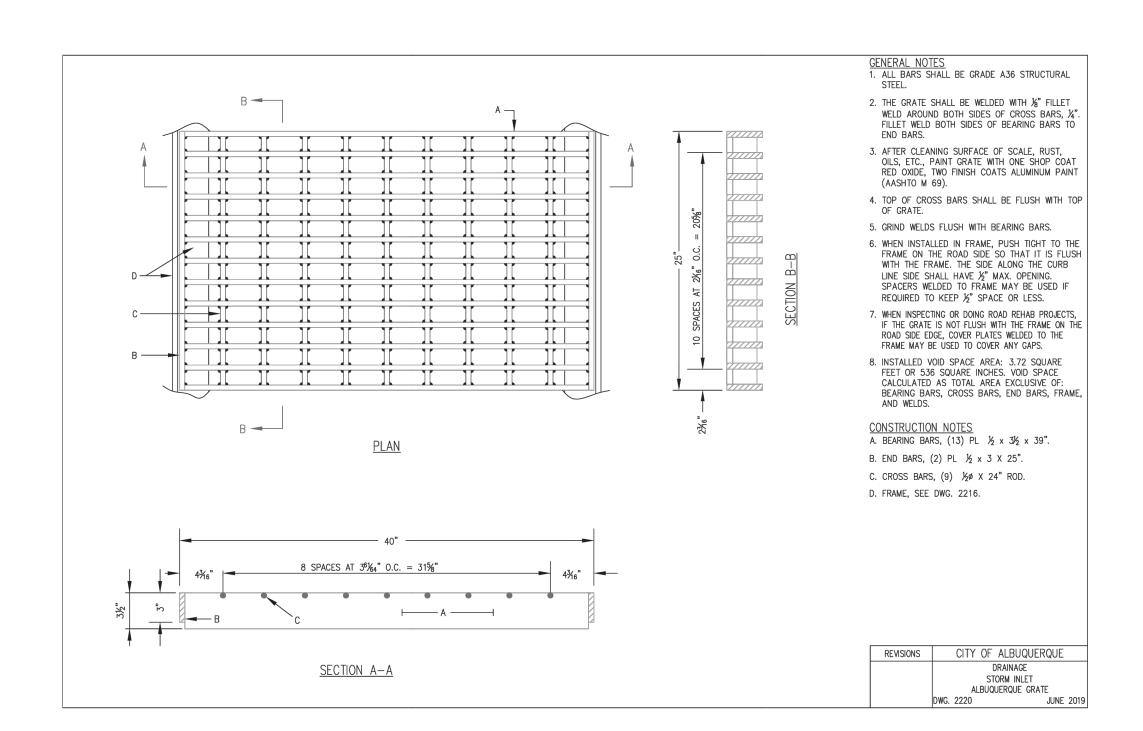



1 ACO BELL 98TH & SAGE

DATE					
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REV					
DATE 08/21/2024					
PROJECT NO. 2175023					
SHEET NAME					

DETAILS


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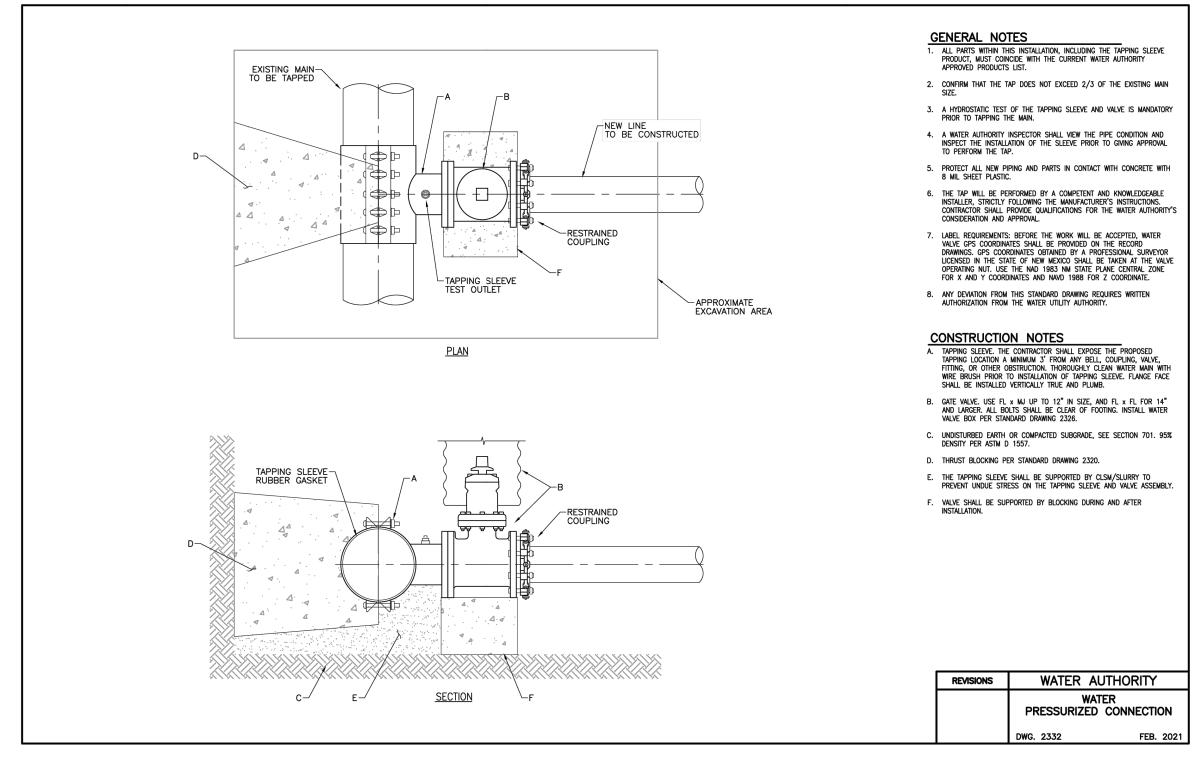
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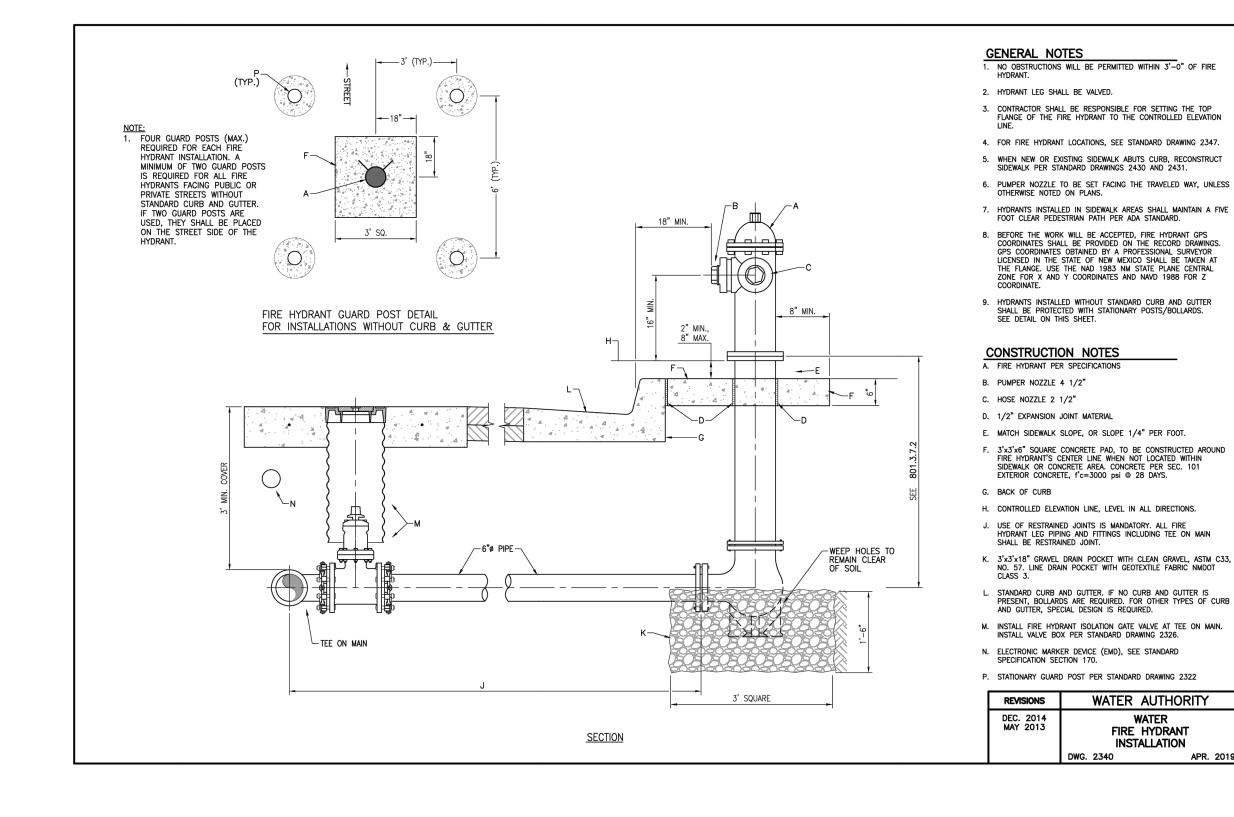
ALBUQUERQUE, BERNALILLO COUNTY, NEW MEXICO, DECEMBER 2021


FIRE HYDRANT

INSTALLATION






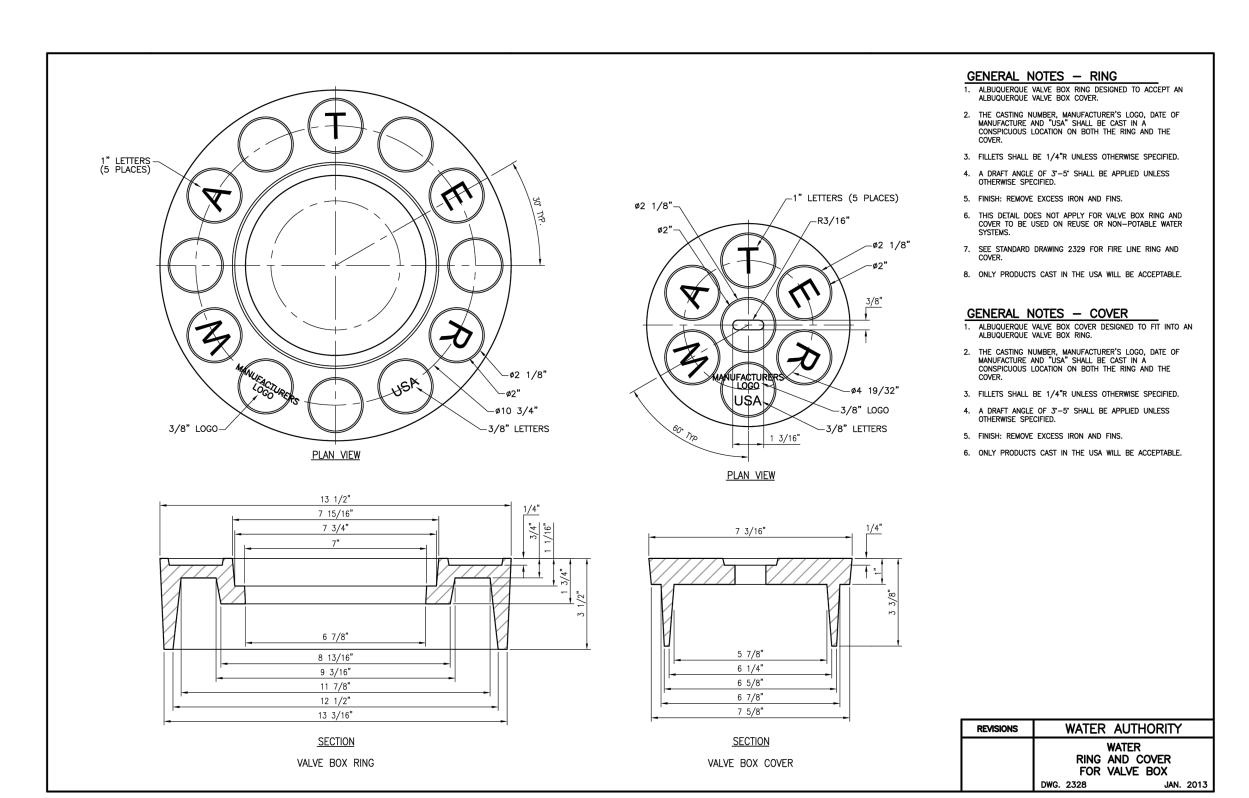

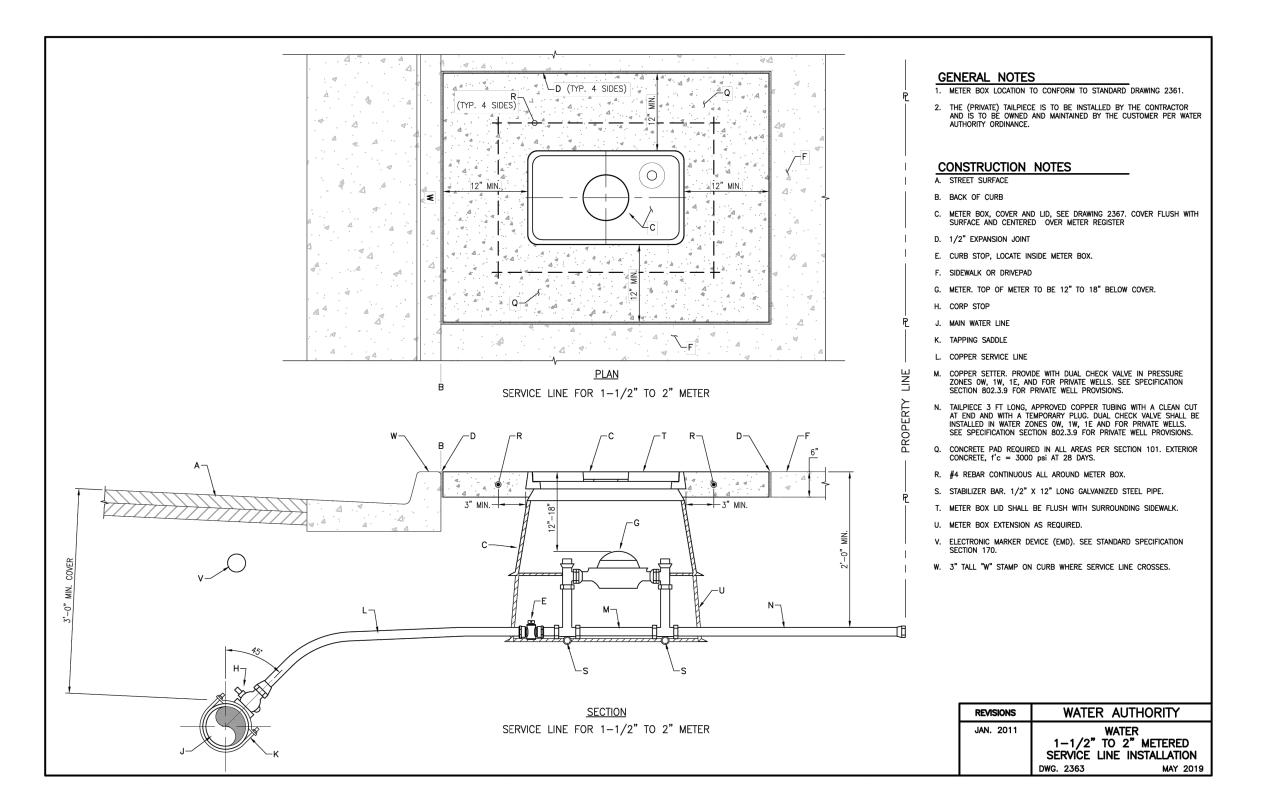



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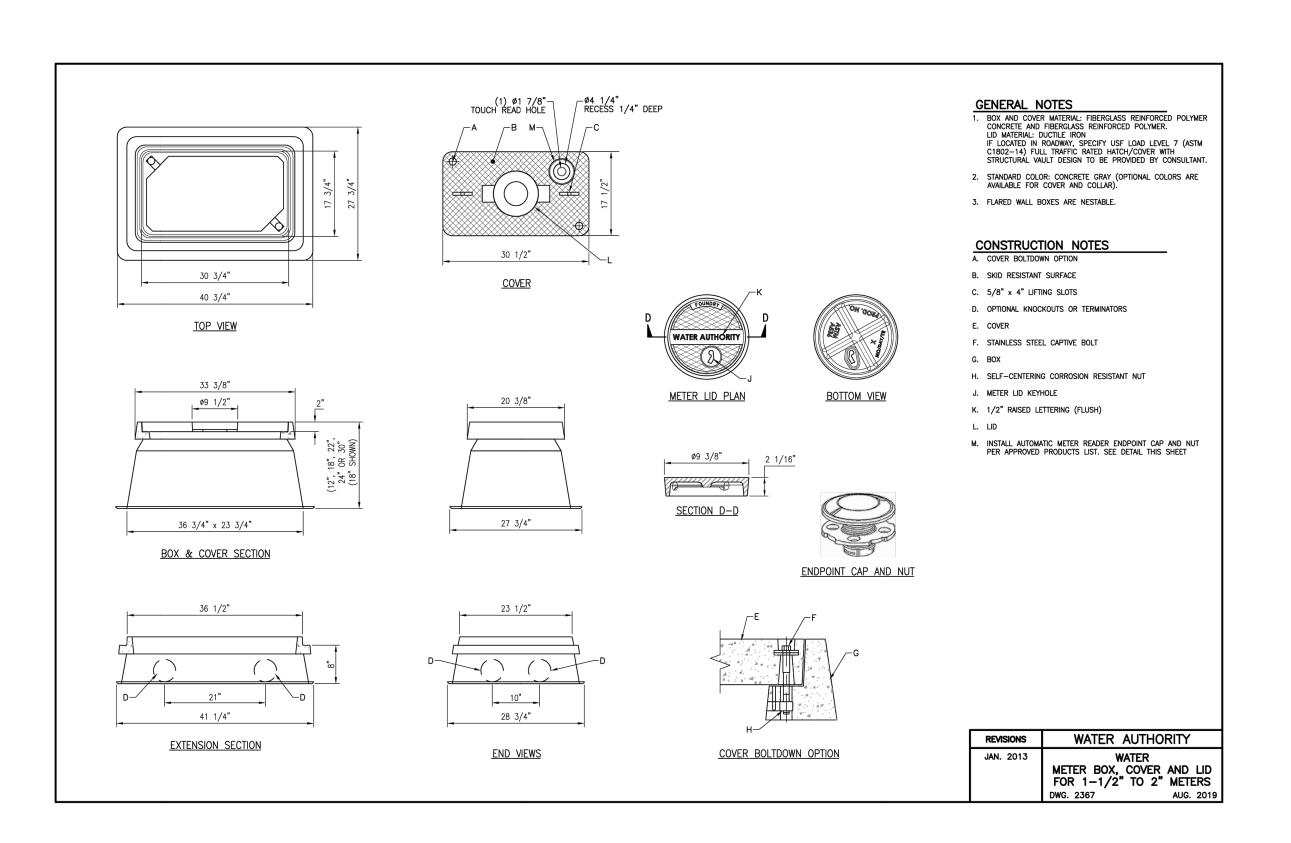


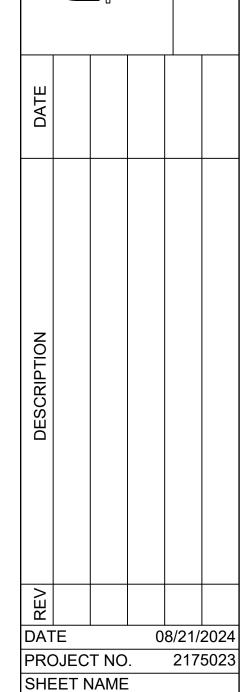DETAILS SHEET NO.

TACO BELL - SNOW VISTA BOULEVARD ALBUQUERQUE, NM

LOT 1D. TOWN OF ASTRICO GRANT, PROJECTED SECTION 33, TOWNSHIP 10 NORTH, RANGE 2 EAST, N.M.P.M.

ALBUQUERQUE, BERNALILLO COUNTY, NEW MEXICO, DECEMBER 2021





98TH & SAGE

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PROJECT NO. 217502					
SHEET NAME					

DETAILS

TACO BELL - SNOW VISTA BOULEVARD ALBUQUERQUE, NM

LOT 1D. TOWN OF ASTRICO GRANT, PROJECTED SECTION 33, TOWNSHIP 10 NORTH, RANGE 2 EAST, N.M.P.M.

ALBUQUERQUE, BERNALILLO COUNTY, NEW MEXICO, DECEMBER 2021

National Pollutant Discharge Elimination System Manual Appendix A2 – Erosion Control

August 2012

Channel Protection

Temporary Stabilization

Waste Management

Housekeeping Practice

Targeted Constituents

Oil and Grease

Significant

Floatable Materials

Construction Wastes

Unknown or Questionable

(SEED)

Seeding – Temporary/Vegetation	Applications		
DESCRIPTION	Perimeter Control		
As a BMP, temporary seeding/vegetation is used to establish a	✓ Slope Protection		
temporary vegetative cover on disturbed areas by seeding with	✓ Sediment Trapping		
appropriate rapidly growing annual vegetation, annual grasses,	✓ Channel Protection		

be permanently stabilized within an acceptable period of time. Temporary seeding will also reduce problems associated with mud and dust from construction activities on bare, unprotected

small grains, or legumes. This short-term vegetative area will

reduce erosion and sedimentation on disturbed areas that will not

PRIMARY USE Temporary seeding should be considered for disturbed areas that will not be permanently stabilized or have work performed thereon for a period of 21 days or more. Such areas include denuded areas, soil stockpiles, dikes, berms, temporary embankments, excavation slopes, etc. As a temporary control, vegetation is used to stabilize stockpiles and barren areas that are inactive for long periods of time. As a permanent control, grasses and other vegetation provide good protection for the soil, along with some filtering for overland runoff. Subjected to acceptable runoff velocities, vegetation can provide a good method of permanent storm water management, as well as a visual amenity to the site.

Other BMPs may be required to assist in the establishment of

vegetation. These other techniques include erosion control matting; swales and dikes to direct flow around newly seeded

areas; and proper grading to limit runoff velocities during **APPLICATIONS**

Planting should take place when conditions are most favorable for growth (as long as the planting does not interfere with the schedule of other activities and/or regulatory requirements). Before seeding, other erosion control practices such as dikes, basins, and surface runoff-control measures (e.g., interceptor dikes and swales, etc.) should be installed. Temporary bale barriers and silt fences may have to be placed/replaced after seeding operations, since they may get in the way of the machinery. However, use common sense to coordinate operations to maximize the effectiveness of the erosion control measures. Temporary seeding may not be an effective practice in arid and semi-arid regions where the climate prevents fast plant establishment. In those areas, or when seasonal planting restrictions prohibit, temporary mulching may be better for the

National Pollutant Discharge Elimination System Manual

Conservation Service (NRCS) rules.

Surface Preparation

for utility and site development construction.

Plant Selection, Fertilization and Seeding

For further information, refer to Section 632 of Standard Specifications for Highway and Bridge Construction (New Mexico State Highway and Transportation Department [NMSHTD] 2000).

Seeding – Temporary/Vegetation (continued)

A2-3

All seeded areas should be covered with mulch to provide protection from the weather. Frequent inspections are necessary to check that conditions for growth are good. If the plants do not grow quickly or thick enough to prevent erosion, the area should be reseeded as soon as possible. Temporary seed selection should take into account the season and location. Specific seed mixes can usually be found in the construction plans. The plans and specifications should reflect

temporary seeding locations, quantities, and pay items. For suggested seed types, see Appendix D, Guidance on Seed Selection and Seeding of Temporary Vegetation on

Native grasses should not be used for temporary seeding. Irrigation or a temporary watering facility should be provided. Seed should be selected in accordance with local Natural Resources

Vegetative techniques can and should apply to every construction project, with few exceptions.

• Interim or final grading must be completed prior to seeding, minimizing all steep slopes. Install all necessary erosion structures such as dikes, swales, diversions, etc., prior to

• Groove or furrow slopes steeper than 3:1 on the contour line before seeding.

Provide 4-6 inches of topsoil over rock, gravel, or otherwise unsuitable soils.

• Use only high quality, U.S. Department of Agriculture (USDA)-certified seed.

Fertilizer shall be applied according to the manufacturer's recommendation with proper spreader equipment. Typical application rate for 10-10-10 grade fertilizer is

If hydro-seeding is used, do not mix seed and fertilizer more than 30 minutes before

• Evenly apply seed using cyclone seeder, seed drill, cultipacker, or hydroseeder.

• Use an appropriate species or species mixture adapted to local climate, soil conditions, and season. Consult with the local NRCS office or local County Extension Service as necessary for selection of proper species and application techniques in the area. Seeding rate should be in accordance with recommendations by the NRCS or Engineering Extension Service.

Seedbed should be well pulverized, loose, and uniform.

700-1000 lb/acre. DO NOT OVER APPLY FERTILIZER.

Provide adequate water to aid in establishment of vegetation.

• Use appropriate mulching techniques where necessary.

Vegetation effectively reduces erosion in swales, stockpiles, berms, mild to medium slopes, and along roadways. Vegetative strips can provide some protection when used as a perimeter control

National Pollutant Discharge Elimination System Manual Appendix A4 – Sediment Control

August 2012

Applications

✓ Slope Protection

Sediment Trapping

Channel Protection

Toxic Materials

Oil and Grease

✓ Significant

✓ Floatable Materials

Construction Wastes

Unknown or Questionab

Silt Fence

Temporary Stabilization Permanent Stabilization Waste Management Housekeeping Practices **Targeted Constituents**

DESCRIPTION A silt fence consists of geotextile fabric supported by backing stretched between posts, with the lower edge securely embedded in soil downstream of disturbed areas. Intercepts runoff in the form of sheet flow and provides filtration, sedimentation, and velocity PRIMARY USE Silt fences are used as perimeter control downstream of disturbed

areas, and for non-concentrated sheet-flow conditions. **APPLICATIONS** Silt fences provide an economical way to mitigate overflow, non-concentrated flows, and as a perimeter control device. Best with coarse to silty soil types and to control wind erosion on sandy

LIMITATIONS Minor ponding will likely occur at the upstream side of the silt fence, resulting in minor localized flooding. Fences that are constructed in swales or low areas subject to

concentrated flow may be overtopped, resulting in failure of the filter fence. Silt fences subject to areas of concentrated flow (waterways with flows >1 cfs) are not acceptable. Silt fence can interfere with construction operations; therefore, planning of access routes onto the site is critical. Silt fence can fail structurally under heavy storm flows, creating maintenance problems and reducing the effectiveness of the

MAINTENANCE REQUIREMENTS Inspections should be made on a weekly basis, especially after large storm events. If the fabric becomes clogged, it should be cleaned or, if necessary, replaced Sediment should be removed when it reaches approximately one-

National Pollutant Discharge Elimination System Manual

Silt Fence (continued)

A4-5

FILTER FABRIC MATERIAL. USE STAPLES OR WIRE RINGS TO ATTACH FABRIC TO WIRE. BURY BOTTCM OF FILTER MATERIAL IN 6"x6"TRENCH FILTER FABRIC MATERIAL-FABRIC ANCHORAGE TRENCH, BACKFILLED WITH TAMPED NATURAL SOIL. 6"X 6" MIN.

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National Pollutant Discharge Elimination System Manual Appendix A5 – Good Housekeeping/Materials Management

August 2012

Applications

Sediment Trapping

Channel Protection

Temporary Stabilization

Permanent Stabilization

Waste Management

Oil and Grease

Significant

Floatable Materials

Construction Wastes

Unknown or Questionable

Housekeeping Practices

Perimeter Control Slope Protection

Stabilized Construction Entrance/Exit

Targeted Constituents A stabilized construction entrance consists of a pad of crushed stone, recycled concrete, or other rock-like material on top of a geotextile filter cloth, which is used to facilitate the washdown and removal of sediment and other debris from construction Toxic Materials equipment prior to exiting the site. During the construction phase

of a project, regular street sweeping should be performed to remove debris carried from the site. PRIMARY USE Stabilized construction entrances are used to reduce offsite sediment tracking from trucks and construction equipment, and

for sites where considerable truck traffic occurs each day. They also reduce the need to clean adjacent pavement as often, and help route site traffic through a single point. **APPLICATIONS**

As a part to the erosion-control plan required for sites larger than five acres, and recommended for all construction sites. Selection of the construction entrance location is critical. To be


effective, it must be used exclusively. Stabilized entrances are rather expensive, considering that they must be installed in combination with one or more other sediment control techniques. It may be more cost effective, however, than labor-intensive street cleaning

MAINTENANCE REQUIREMENTS Inspections should be made on a regular basis and after large

storm events in order to ascertain whether or not sediment and pollution are being effectively detained on site. When sediment has substantially clogged the void area between the rocks, the aggregate mat must be washed down or replaced. Periodic re-grading and top dressing with additional stone must be done to keep the efficiency of the entrance from diminishing.

A5-19

National Pollutant Discharge Elimination System Manual

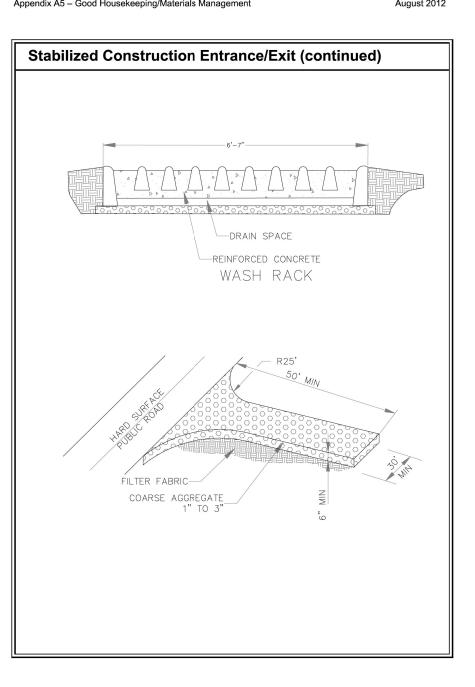

STABILIZED CONSTRUCTION ENTRANCE/EXIT SCALE: NTS


SEEDING SCALE: NTS

01C11R.DOC

SCALE: NTS

allace design collective, pc tructural·civil·landscape·survey 9800 pyramid court, suite 350 englewood, co 80112 303.350.1690 · 800.364.5858

wallace

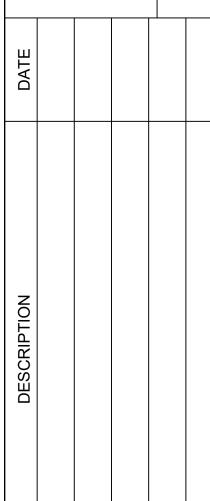

DATE 08/21/2024 PROJECT NO. 2175023 SHEET NAME **EROSION**

REV

CONTROL **DETAILS**

CODE	QTY	BOTANICAL / COMMON NAME	SIZE	CONTAINER	HEIGHT	SPACING
TREES						
ACE SNS	5	Acer negundo 'Sensation' Sensation Box Elder	2" Cal.	B&B	8` Ht.	As Shown
CEL OCC	4	Celtis occidentalis Common Hackberry	2" Cal.	B&B	8` Ht.	As Shown
GYM DIO	12	Gymnocladus dioica 'Espresso' Kentucky Coffeetree	2" Cal.	B&B	8` Ht.	As Shown
EVERGRE	ENI TOE	IE C				-1
JUN GRA	10	Juniperus scopulorum 'Gray Gleam' Gray Gleam Juniper	6` Ht.	Container		As Shown
ORNAMEI	NTAI TE	REFS	•	•	•	•
ACE GRN	4	Acer tataricum 'GarAnn' TM Hot Wings Tatarian Maple Multi-stem, min. of 2 trunks	2" Cal.	B&B	6` Ht.	As Shown
CHI BUR	11	Chilopsis linearis 'Burgundy' Burgundy Desert Willow	1.5" Cal.	B&B	6` Ht.	As Shown
CODE	QTY	BOTANICAL / COMMON NAME	SIZE	CONTAINER	HEIGHT/SPREAD	SPACING
SHRUBS						
CER LIN	29	Cercocarpus ledifolius intricatus Little-leaf Mountain Mahogany	5 gal.	Container	3` Ht.	As Shown
CHR NAU	49	Chrysothamnus nauseosus nauseosus Dwarf Blue Rabbitbrush	5 gal.	Container	2` Ht.	As Shown
FAL PAR	36	Fallugia paradoxa Apache Plume	5 gal.	Container	2` Ht.	As Shown
PRU PAW	31	Prunus besseyi 'P011S' TM Pawnee Buttes Sand Cherry	5 gal.	Container	3` W.	As Shown
RHA IND	81	Rhaphiolepis indica Indian Hawthorn	5 gal.	Container	2` Ht.	As Shown
YUC GLA	50	Yucca glauca Soapweed	1 gal.	Container	10" Ht.	As Shown
GRASSES	<u> </u>		·	•		,
	3	Bouteloua gracilis 'Blonde Ambition' Blonde Ambition Blue Grama	1 gal.	Container		As Shown
BOO BLO	11	Muhlenbergia capillaris Pink Muhly Grass	1 gal.	Container		As Shown
BOU BLO MUH CAP		•		•	•	•
MUH CAP	AI S					
	ALS 25	Agastache cana Texas Hummingbird Mint	1 gal.	Container		As Shown

H: HEIGHT, CP: CALIPER, C: CONTAINER, MT: MULT-TRUNK, FTG: FULL TO GROUND

- I. O.C.: INDICATES APPROXIMATE SPACING TO BE EQUAL ON CENTER. SHALL BE CONSIDERED GENERAL GUIDELINE ONLY AND MAY BE MODIFIED TO SUIT ON-SITE CONDITIONS.
- 2. $\,$ MATCHED: SIZE AND OTHER PHYSICAL CHARACTERISTICS TO BE SIMILAR. ALL DIMENSIONS TO BE WITHIN 5% RANGE.
- . QUANTITIES ON PLANT LIST ARE FOR CONVENIENCE ONLY. CONTRACTOR IS RESPONSIBLE FOR ALL PLANTS SHOWN ON PLANTING PLANS AND COVERAGE OF ALL AREAS DELINEATED. WHEN DISCREPANCIES OCCUR BETWEEN PLANT LIST AND PLANTING PLANS, THE PLANS ARE TO SUPERSEDE THE PLANT LIST.
- 4. 4" CALIPER TREES AND LARGER TO BE LIMBED 6' MINIMUM TO FIRST BRANCH WITH NO VISIBLE PRUNING MARKS ALLOWED UNLESS OTHERWISE NOTED.
- 5. ALL TREES TO HAVE A SINGLE CENTRAL LEADER UNLESS OTHERWISE NOTED.

LANDSCAPE REQUIREMENTS

REQUIRED: MINIMUM REQUIRED NET LANDSCAPED AREA = 9,851 SF (15%)

PROVIDED: LANDSCAPED AREA = 26,566 SF (40%)

REQUIRED: ALL PARKING SPACES WITHIN 100' OF A TREE PROVIDED: ALL PARKING SPACES ARE WITHIN 100' OF A TREE

REQUIRED: ONE (1) TREE PER 10 PARKING SPACES (51 SPACES = 5 TREES) PROVIDED: 5 TREES

REQUIRED: 1 STREET TREE PER EVERY 25 LINEAR FEET OF LANDSCAPE FRONTAGE (244 LF = 10 TREES)

PROVIDED: 10 TREES ALONG THE FRONTAGE OF SNOW VISTA

REQUIRED:TREE CANOPIES AND GROUND-LEVEL PLANTS SHALL COVER A MINIMUM OF 75% OF THE TOTAL LANDSCAPED AREA.

OF THE REQUIRED VEGETATIVE COVER, A MINIMUM OF 25% SHALL BE GROUND-LEVEL PLANTS PROVIDED: TOTAL LANDSCAPE AREA: (26,566 SF - 5,145 SF WATER/SEWER EASEMENT) = 21,421 SF

TREE CANOPY: 13,034 SF, SHRUB COVERAGE 3,205 SF TOTAL COVERAGE: 16,239 SF

PROVIDED: (16,239/21,421) = 76% OF LANDSCAPE AREA WITH PLANT MATERIAL COVERAGE

PROVIDED: (3,205 / 9,851) = 33% OF SHRUB COVERAGE

REQUIRED: GRAVEL OR CRUSHER FINES AS A GROUND COVER IS LIMITED TO A MAXIMUM OF 75% OF LANDSCAPED AREA PROVIDED: LANDSCAPE AREA = 26,566 SF, GRAVEL AREA = 15,841 SF: 60%

CAUTION

NOTICE TO CONTRACTOR

THE CONTRACTOR IS SPECIFICALLY CAUTIONED THE LOCATION AND ELEVATION OF EXISTING UTILITIES AS SHOWN ON THESE PLANS ARE BASED ON RECORDS OF THE VARIOUS UTILITY COMPANIES AND MEASUREMENTS TAKEN IN THE FIELD. THE INFORMATION IS NOT TO BE RELIED ON AS BEING EXACT OR COMPLETE. THE CONTRACTOR MUST CALL THE LOCAL UTILITY LOCATION CENTER AT LEAST 72 HOURS BEFORE ANY EXCAVATION




PLANTING NOTES

- 1. CONTRACTOR TO ASCERTAIN LOCATION AND DEPTH OF ALL UTILITIES PRIOR TO EXCAVATION AND BE RESPONSIBLE FOR DAMAGE RESULTING FROM PLANTING OPERATIONS. REPAIRS SHALL BE MADE AT NO COST TO THE OWNER.
- 2. ALL UNDERGROUND UTILITIES MAY NOT BE SHOWN ON THE SURVEY. CONTACT THE LOCAL UTILITY
- LOCATION SERVICES PRIOR TO COMMENCING CONSTRUCTION OPERATIONS. 3. FINISH GRADE FOR SHRUB, GROUND COVER, AND LAWN AREAS SHALL BE HELD 1" BELOW TOP OF
- ADJACENT PAVEMENT AND CURBS UNLESS OTHERWISE NOTED ON DRAWINGS. 4. FIELD STAKE LOCATIONS OF PROPOSED TREES FOR REVIEW AND APPROVAL BY OWNER'S
- REPRESENTATIVE PRIOR TO DELIVERY OF TREES.
- 5. BOULDERS TO BE NATIVE, WEATHERED, FIELD-COLLECTED STONES WITH NO SUBSTANTIAL SCARS AND SHALL HAVE SIGNIFICANT COVERAGE OF LICHENS AND/OR MOSS. DIMENSIONS OF BOULDERS SHALL RANGE FROM .5 TONS TO 2 TONS, WITH 50% OF THE BOULDERS BEING ONE TON OR OVER. BOULDERS TO BE PARTIALLY BURIED TO SIMULATE A NATURAL CONDITION. DEPTH OF BOULDERS TO BE BURIED TO AVERAGE 1/3 OF HEIGHT OR AS NEEDED TO SIMULATE A NATURAL CONDITION. LOCATION AND ORIENTATION OF BOULDERS TO BE APPROVED BY THE OWNER'S REPRESENTATIVE. PLACED BOULDERS TO BE PROTECTED FROM DAMAGE FROM CONSTRUCTION OPERATIONS.
- 6. ALL VEGETATED MATERIAL SHALL BE PLANTED IN UNCOMPACTED SOIL.
- 7. BY SUBMITTING A BID, THE CONTRACTOR ACKNOWLEDGES HAVING VISITED THE SITE AND BECOME FAMILIAR WITH THE CONDITIONS RELATED TO THE INSTALLATION OF SITE IMPROVEMENTS.

SITE PLAN


TACO BELL - SNOW VISTA BOULEVARD ALBUQUERQUE, NM

LOT 1D. TOWN OF ASTRICO GRANT, PROJECTED SECTION 33, TOWNSHIP 10 NORTH, RANGE 2 EAST, N.M.P.M.

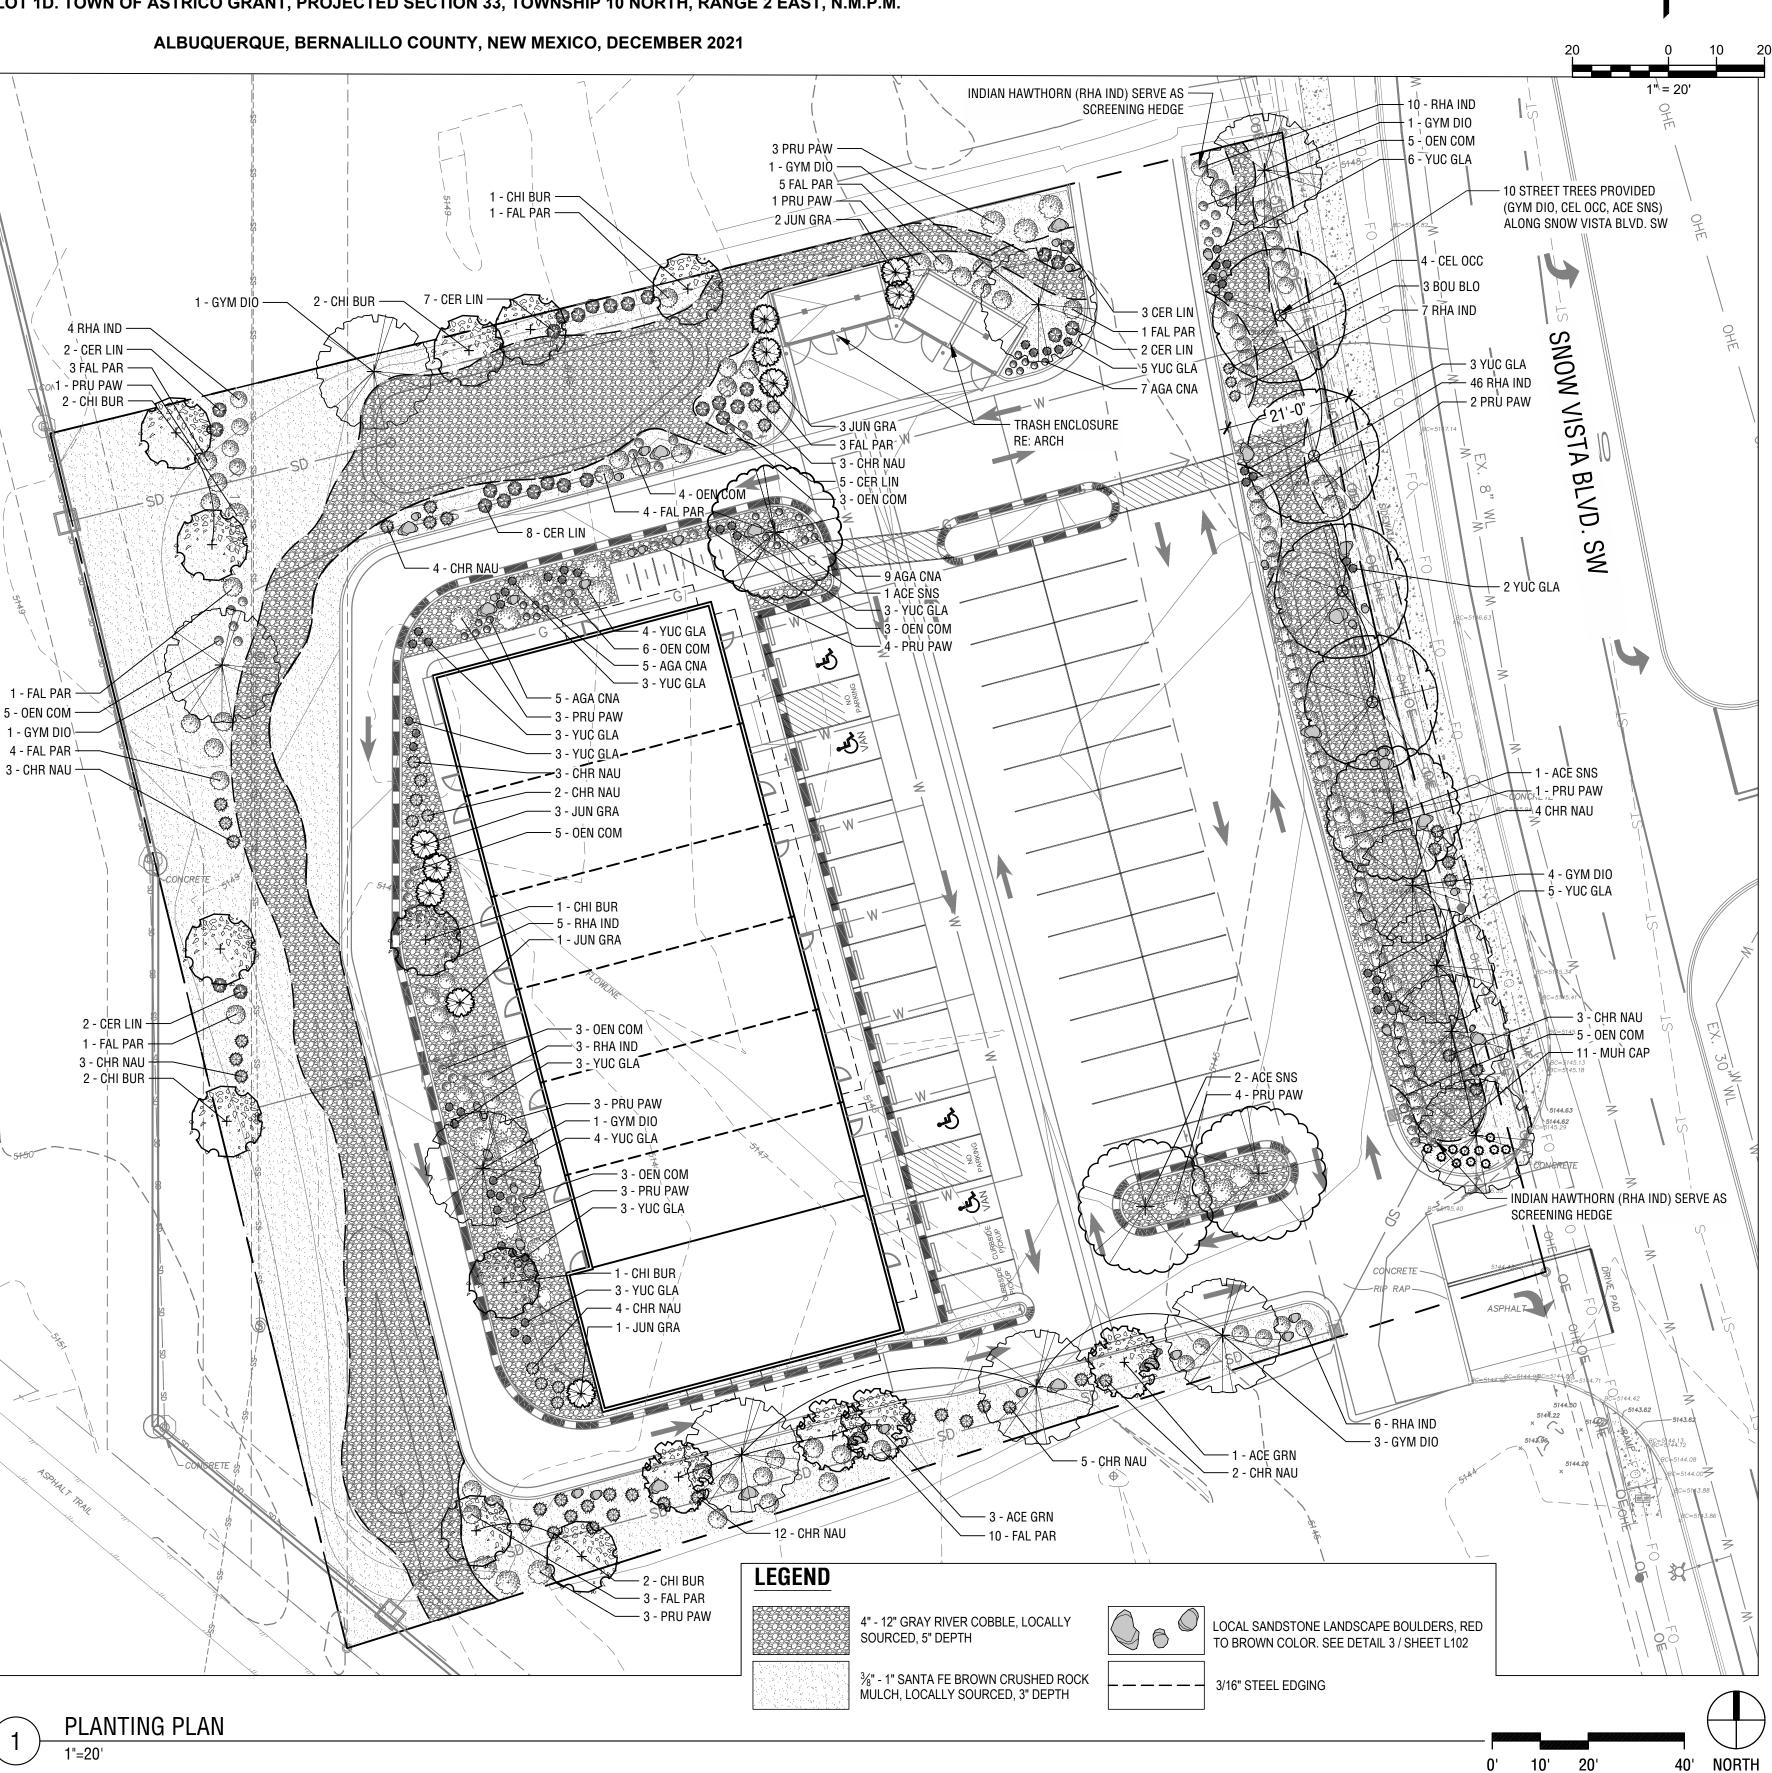



CAUTION: IF THIS SHEET IS NOT 22"x34" IT IS A REDUCED PRINT

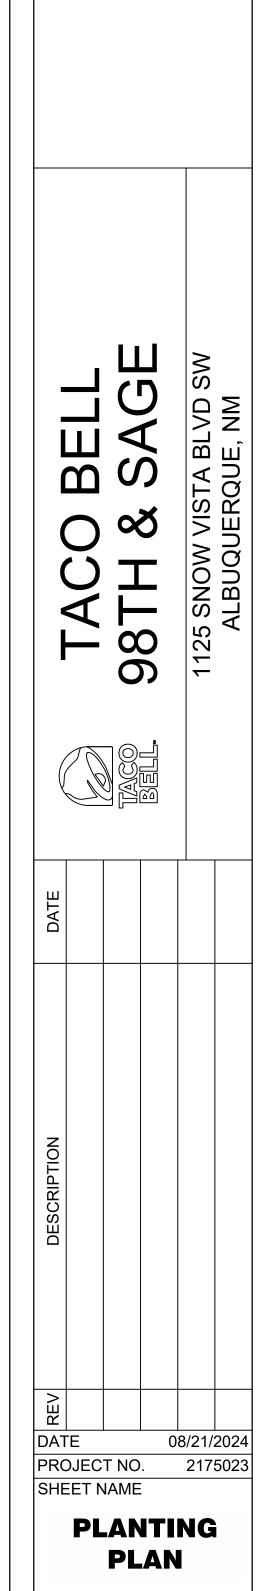



CONTRACTOR MUST CALL THE LOCAL UTILITY LOCATION

SITE PLAN

TACO BELL - SNOW VISTA BOULEVARD ALBUQUERQUE, NM

LOT 1D. TOWN OF ASTRICO GRANT, PROJECTED SECTION 33, TOWNSHIP 10 NORTH, RANGE 2 EAST, N.M.P.M.

ALBUQUERQUE, BERNALILLO COUNTY, NEW MEXICO, DECEMBER 2021

LANDSCAPE GRADING & TOPSOIL

1. TOPSOIL: REUSE FROM STOCKPILE AND PROVIDE NEW TOPSOIL AS NEEDED.


2. IMPORTED TOPSOIL: FRIABLE LOAM, TYPICAL OF CULTIVATED TOPSOILS LOCALLY; FREE OF SUBSOIL, ROOTS, GRASS, EXCESSIVE AMOUNT OF WEEDS, STONE, AND FOREIGN MATTER: ACIDITY RANGE (PH) OF 6.0 TO 7.0: CONTAINING A MINIMUM OF 2 PERCENT AND A MAXIMUM OF 5 PERCENT ORGANIC MATTER. TOPSOIL SHALL NOT BE DELIVERED OR USED FOR PLANTING WHILE IN A FROZEN OR MUDDY CONDITION. TOPSOIL SHALL CONFORM TO THE FOLLOWING GRAIN SIZE DISTRIBUTION FOR MATERIAL PASSING THE #10

	PERCENT PASSI					
U.S.SIEVE SIZE NUM	MBER MINIMUM	MAXIMUM				
10	100					
18	85	100				
35	70	95				
60	50	85				
140	36	63				
270	32	52				
0.002MM	3	8				

- 3. SUBMIT SOURCE AND ANALYSIS OF TOPSOIL FOR BACKFILL. TEST TO BE PERFORMED BY ACCREDITED SOILS LABORATORY. SUBMITS SOILS TEST AND RECOMMENDATIONS FOR AMENDMENTS INCLUDING ADJUSTING SOIL pH TO A VALUE BETWEEN 6.0 AND 7.0.
- 4. ELIMINATE UNEVEN AREAS AND LOW SPOTS. REMOVE DEBRIS, ROOTS, BRANCHES, STONES, IN EXCESS OF 1 INCH IN SIZE. REMOVE SUB-GRADE CONTAMINATED WITH PETROLEUM PRODUCTS.
- 5. SCARIFY SUB-GRADE TO DEPTH OF 6 INCHES WHERE TOPSOIL IS SCHEDULED. REMOVE DEBRIS THAT IS BROUGHT TO THE SURFACE IN EXCESS OF 1 INCH IN SIZE.
- REVIEW SUB-GRADE SCARIFICATION WITH OWNER'S REPRESENTATIVE PRIOR TO COMMENCING PLACEMENT OF TOPSOIL.
- USE TOPSOIL IN RELATIVELY DRY STATE. PLACE DURING DRY WEATHER.
- 8. FINE GRADE TOPSOIL OR PLANTING MIX ELIMINATING ROUGH OR LOW AREAS. MAINTAIN LEVELS, PROFILES, AND CONTOURS OF SUB-GRADE.
- 9. REMOVE STONE, ROOTS, GRASS, WEEDS, DEBRIS, AND FOREIGN MATERIAL WHILE SPREADING.
- 10. MANUALLY SPREAD TOPSOIL OR PLANTING MIX AROUND TREES, PLANTS, AND STRUCTURES, TO PREVENT DAMAGE
- 11. LIGHTLY COMPACT PLACED TOPSOIL.
- 12. REMOVE SURPLUS SUBSOIL AND TOPSOIL FROM SITE.
- LEAVE STOCKPILE AREA AND SITE CLEAN AND RAKED, READY TO RECEIVE LANDSCAPING.
- 14. TOP OF TOPSOIL OR PLANTING MIX TOLERANCES: PLUS OR MINUS 1/2 INCH.
- 15. REQUIRED TOPSOIL DEPTH FOR LANDSCAPE AREAS:
 - A. LAWN AREAS: 6 INCHES MINIMUM TOPSOIL.
 - B. PLANTING BEDS (SHRUBS, GROUNDCOVER, ETC.): 12 INCHES MINIMUM TOPSOIL

PLANTING

- 1. WORK REQUIRED IN THIS SECTION TO BE PERFORMED BY EXPERIENCED PERSONNEL UNDER DIRECTION OF A SKILLED FOREMAN
- 2. CONTRACTOR SHALL LOCATE ALL MATERIALS AND BE RESPONSIBLE FOR CONFORMANCE WITH REQUIREMENTS OF THIS SECTION. ALL PLANTS NOT MEETING REQUIREMENTS SHALL BE REJECTED.
- 3. ALL TREES TO BE REVIEWED BY OWNER'S REPRESENTATIVE PRIOR TO PLANTING
- A. TREES WILL BE REVIEWED AT LOCAL GROWING OR NURSERY BY OWNER'S REPRESENTATIVE AND APPROVED BEFORE DELIVERING TO THE SITE. CONTRACTOR SHALL SCHEDULE REVIEW OF PLANT MATERIAL IN SUCH A MANNER THAT NO SINGLE REVIEW PERIOD WILL EXCEED ONE WORKING DAY WITH A MAXIMUM OF TWO REVIEW PERIODS. CONTRACTOR SHALL BE RESPONSIBLE FOR NOTIFICATION AND COORDINATION WITH ALL PARTIES PRIOR TO SCHEDULING.
- 4. ALL PLANT MATERIAL SHALL BE TRUE TO NAME, IN GOOD HEALTH, FREE OF DISEASE AND INSECTS, EXCELLENT IN FORM AND IN CONFORMANCE WITH ANSI Z60. SPECIES AND SIZE IDENTIFIED ON PLANT LIST. ALL PLANTER MATERIALS TO BE NURSERY GROWN.
- 5. B&B PLANTS TO BE MOVED WITH SOLID BALLS WRAPPED IN BURLAP. PLANTS TO BE LIFTED ONLY BY BALL OR CONTAINER
- 6. DELIVER PLANT MATERIALS IMMEDIATELY PRIOR TO PLACEMENT. KEEP PLANT MATERIALS NOT IMMEDIATELY INSTALLED MOIST AND PROTECT FROM FREEZING BY COVERING BALL OR CONTAINER WITH MULCH. ANY PLANTS NOT PLANTED WITHIN 2 DAYS OF DELIVERY ARE TO BE HEELED-IN IN A VERTICAL POSITION, ROOT BALLS FULLY ENCOMPASSED BY MULCH AND A TEMPORARY WATERING SYSTEM INSTALLED.
- 7. WARRANT ALL PLANTS TO BE LIVING, HEALTHY SPECIMENS FOR A PERIOD OF ONE YEAR COMMENCING UPON DATE OF SUBSTANTIAL COMPLETION. WARRANTY PERIOD SHALL TERMINATE ONLY IF PLANTS HAVE BEEN IN FULL LEAF FOR 30 DAYS AT END OF WARRANTY PERIOD. TERMINATION OF WARRANTY PERIOD SHALL BE EXTENDED AS NECESSARY TO COMPLY. ALL MATERIALS TO BE IN VIGOROUS CONDITION AT END OF WARRANTY PERIOD.
- 8. IMMEDIATELY REMOVE DEAD PLANTS AND PLANTS NOT IN A VIGOROUS CONDITION AND REPLACE AS SOON AS WEATHER CONDITIONS PERMIT. EACH REPLACEMENT SHALL BE COVERED WITH ONE YEAR WARRANTY COMMENCING AT TIME OF PLANTING. REPLACEMENTS TO MATCH ADJACENT PLANTS OF THE SAME SPECIES IN SIZE AND FORM.
- CONTRACTOR TO BEGIN MAINTENANCE OF PLANT MATERIAL IMMEDIATELY AFTER PLANTING AND CONTINUE UNTIL DATE OF SUBSTANTIAL COMPLETION.
- 10. MAINTENANCE SHALL INCLUDE MEASURES NECESSARY TO ESTABLISH AND MAINTAIN PLANTS IN A VIGOROUS AND HEALTHY GROWING CONDITION. INCLUDE THE FOLLOWING: A. CULTIVATION AND WEEDING OF PLANT BEDS AND TREE PITS. WHEN HERBICIDES ARE USED FOR WEED CONTROL, APPLY IN ACCORDANCE WITH MANUFACTURER'S
 - INSTRUCTIONS. REMEDY DAMAGE RESULTING FROM USE OF HERBICIDES. B. WATERING SUFFICIENT TO MAINTAIN OPTIMUM MOISTURE LEVEL.
 - C. PRUNING. INCLUDING REMOVAL OF DEAD OR BROKEN BRANCHES. AND TREATMENT OF PRUNE WOUNDS.
 - D. DISEASE AND INSECT CONTROL.
 - E. MAINTAINING PLANTS IN AN UPRIGHT, PLUMB POSITION, AND REPAIR OF SETTLING.
 - F. MAINTENANCE OF WRAPPINGS, GUYS, TURNBUCKLES AND STAKES. ADJUST TURNBUCKLES OR OTHERWISE KEEP
- G. GUY WIRES TIGHT. REPAIR OR REPLACE ACCESSORIES WHEN REQUIRED.
- 11. MULCH: DOUBLE GROUND HARDWOOD BARK MULCH EQUAL TO THAT PRODUCED BY FOSTER BROTHERS, WOOD PRODUCTS INC. www.fosterbros.com. SUBMIT TYPE AND SOURCE FOR APPROVAL BY OWNER'S REPRESENTATIVE.
- 12. FERTILIZER: OSMOCOTE SLOW RELEASE 18-6-12
- 13. SOIL ACIDIFIER: EQUAL TO TIGER 90 CR ORGANIC SULPHUR 0-0-0-90
- 14. COMPOST: BACK TO EARTH COMPOSTED COTTON BURRS AS SUPPLIED BY SOIL MENDER PRODUCTS, LP www.soilmender.com
- 15. METAL EDGING: 3/16 INCH x 4 INCH STEEL LANDSCAPE EDGING WITH STEEL STAKES AS MANUFACTURED BY COL-MET, 3333 MILLER PARK SOUTH, GARLAND, TEXAS 75042, PHONE 972/494-3900, WWW.COLMET.COM. EDGING TO BE SET VERTICAL WITH TOP EDGE 1 INCH ABOVE FINISHED GRADE.
- 16. WRAPPING MATERIALS: HEAVY PAPER MANUFACTURED FOR TREE WRAPPING PURPOSE.
- 17. GREEN METAL FENCE POSTS (3 PER TREE) 8 FOOT HEIGHT.
- 18. HARDWARE (CABLES, WIRE, EYE BOLTS, AND TURNBUCKLES): NONCORROSIVE; OF SUFFICIENT STRENGTH TO WITHSTAND WIND PRESSURE.
- 19. TIE STRAPS: SOFT POLYPROPYLENE MATERIAL EQUAL TO ARBORTIE, BY DEEP ROOT PARTNERS, L.P., 31 LANGSTON ST., SUITE 4, SAN FRANCISCO, CA, 94103, 1-800-277-7668.
- 20. REMOVE ALL WEEDS AND GRASSES FROM PLANTING BEDS. BERMUDA GRASS, IF PRESENT, TO BE EXTERMINATED BY APPROVED MEANS OR ALL SOIL REMOVED TO 6 INCH DEPTH AND REPLACED WITH TOPSOIL FREE OF BERMUDA GRASS.
- 21. STAKE TREE LOCATIONS AND PLACE SHRUBS, VINES, AND GROUND COVERS FOR REVIEW AND FINAL ORIENTATION BY OWNER'S REPRESENTATIVE PRIOR TO INSTALLATION. 22. OUTLINE BED EDGES FOR APPROVAL BY OWNER'S REPRESENTATIVE.
- 23. EXCAVATE FOR PLANT MATERIALS. TREE PITS SHALL BE 8' IN DIAMETER. CIRCLE TO BE CENTERED ON TREE AND TRUE IN FORM. SLOPE CUT EDGE TO 6" DEPTH AND BOTTOM OF PIT TO DEPTH REQUIRED TO ACCOMMODATE TREE ROOTBALL. SHRUB PITS SHALL BE 12 INCHES GREATER IN DIAMETER THAN ROOT BALL. TOPSOIL FROM EXCAVATION MAY BE RETAINED FOR BACKFILL IF IT IS FRIABLE AND FREE OF ROCK AND CLODS GREATER THAN 2" IN DIA. REMOVE ALL SUBSOIL, ROCK, AND DEBRIS FROM SITE.
- 24. SET TREES WITH TOP OF ROOT BALL 3 INCHES ABOVE SURROUNDING GRADE, AND OTHER PLANT MATERIALS 1 INCHES ABOVE SURROUNDING GRADE, AFTER SETTLEMENT.
- 25. REMOVE CONTAINERS FROM CONTAINER-GROWN STOCK. SET PLANTS IN CENTER OF PITS AND BACKFILL WITH TOPSOIL IN 6 INCH LAYERS. PULL AWAY ROPES, WIRES, ETC. FROM
- 26. REMOVE ANY SOIL FROM THE TOP OF THE ROOTBALL, TO THE LEVEL OF THE ROOT FLARE.
- 27. THOROUGHLY WATER SOIL WHEN THE HOLE IS HALF FULL, AND AGAIN WHEN FULL

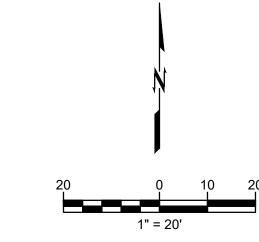


- 28. APPLY 1/2 POUND FERTILIZER EVENLY OVER CULTIVATED AREA AROUND EACH TREE AND 1 POUND PER 100 SQUARE FEET TO SHRUB AND GROUND COVER
- 29. AFTER PLANTING TREES. FORM A 3' DIAMETER RIDGE OF TOPSOIL AROUND EDGE OF EXCAVATION TO RETAIN WATER.

IRRIGATION

- IRRIGATION SYSTEM TO BE ELECTRIC SOLENOID CONTROLLED UNDERGROUND SPRINKLER SYSTEM CONSISTING OF PVC PLASTIC PIPE AND FITTINGS. WITH FIXED SPRAY AND VARIABLE ARC ROTARY POP-UP HEADS IN A MULTI-STATION FLECTRIC CONTROL SYSTEM PROGRAMMED AS APPROVED BY OWNER'S REPRESENTATIVE.
- 2. SUBMIT THE IRRIGATION DESIGN FOR REVIEW AND APPROVAL BY OWNER'S REPRESENTATIVE NO LESS THAN TWO WEEKS PRIOR TO COMMENCING INSTALLATION OPERATIONS. THE DESIGN SHALL INCLUDE THE PIPING LAYOUT, LOCATION AND COVERAGE OF SPRINKLER HEADS, NOZZLE SIZES AND TYPES, PLANT AND LANDSCAPING FEATURES, SITE STRUCTURES, LIST OF FITTINGS TO BE USED, AND CONTROL SYSTEM AND WIRING DIAGRAMS AND DATA; AND SHALI NOTE WATER PRESSURE AT THE PROJECT SITE.
- 3. UPON COMPLETION AND FINAL REVIEW OF SYSTEM BY OWNER'S REPRESENTATIVE, CONTRACTOR SHALL PROVIDE AS-BUILT DRAWINGS (REPRODUCIBLES) OF COMPLETED FACILITIES AS INSTALLED. DRAWINGS SHALL BE PROVIDED TO ARCHITECT IN A) ELECTRONIC FORM (AUTOCAD 2010 FORMAT) B) THREE (3) COPIES OF THE AS-BUILT DRAWING IN BLUELINE OR PHOTOCOPY FORM. AS-BUILT DRAWING SHALL SHOW THE MEASURED DISTANCE FROM EASILY IDENTIFIED, FIXED LOCATIONS TO ISOLATION VALVES, ELECTRIC CONTROL VALVES, MANUAL DRAIN VALVES AND WIRE SPLICES. TWO DIMENSIONS FROM FIXED POINTS PER LOCATION ARE REQUIRED.
- 4. UPON COMPLETION AND FINAL REVIEW OF SYSTEM BY OWNER'S REPRESENTATIVE, CONTRACTOR SHALL PROVIDE THREE (3) BINDERS CONTAINING MANUFACTURER'S INSTALLATION. OPERATION AND MAINTENANCE INSTRUCTIONS AS WELL AS A PARTS BREAKDOWN AND CATALOG FOR EACH PIECE OF EQUIPMENT INSTALLED ON THE PROJECT. AS A MINIMUM THE BINDERS SHALL INCLUDE INFORMATION FOR THE IRRIGATION CONTROLLER, BOOSTER PUMP, BACKFLOW PREVENTER, PRESSURE REGULATORS, ISOLATION VALVES, ELECTRIC CONTROL VALVES, DRAIN VALVES, AIR RELIEF VALVES, ALL SPRAY AND ROTARY SPRINKLER HEADS, RAIN AND FREEZE AND MOISTURE SENSORS.
- 5. IRRIGATION CONTRACTOR TO PROVIDE A RECOMMENDED SCHEDULE FOR RUN TIMES AND FREQUENCY OF WATERING FOR THE FIRST TWO WEEKS, THE FIRST
- TWO MONTHS, AND THE FIRST TWELVE MONTHS (INCLUDING ALL SEASONAL CHANGE REQUIREMENTS) AFTER COMPLETION OF ENTIRE SYSTEM. 6. CONTRACTOR TO INSTRUCT OWNER'S PERSONNEL IN OPERATION AND MAINTENANCE OF ENTIRE SYSTEM INCLUDING ADJUSTING OF SPRINKLER HEADS
- 7. CONTRACTOR TO INSPECT IRRIGATION SYSTEM AT TWO AND FOUR WEEKS AFTER DATE OF SUBSTANTIAL COMPLETION AND MAKE NECESSARY ADJUSTMENTS
- 8. ENTIRE IRRIGATION SYSTEM TO BE UNCONDITIONALLY GUARANTEED AGAINST DEFECTS IN MATERIAL AND WORKMANSHIP, INCLUDING REPAIR OF SETTLING OF BACKFILLED AREAS BELOW GRADE AND ADJUSTING HEADS TO PROPER LEVEL FOR A PERIOD OF ONE YEAR FROM DATE OF SUBSTANTIAL COMPLETION.
- ALL MINOR ADJUSTMENTS, ANY DEFECTIVE ELECTRICAL CONTROL VALVES, SPRINKLER HEADS OR OTHER WORKING PARTS SHALL BE REPAIRED OR REPLACED WITHOUT COST TO THE OWNER FOR A PERIOD OF ONE YEAR FROM THE DATE OF SUBSTANTIAL COMPLETION.
- 10. ALL DAMAGE BY OTHERS DURING THE ONE-YEAR GUARANTEE PERIOD WILL BE OWNER'S RESPONSIBILITY
- 11. ALL MATERIALS TO BE INCORPORATED IN THIS SECTION BE NEW AND OF THE BEST QUALITY MEETING.
- 12. ACCEPTABLE PRODUCT MANUFACTURERS: A. RAINBIRD
- B. WEATHER-MATIC
- C. HUNTER
- 13. MAINLINE PIPING TYPE & SIZE: AS INDICATED ON PLANS
- 14. MAINLINE PIPING DEPTH: **18"** MINIMUM DEPTH
- 15. LATERAL PIPING TYPE & SIZE: ALL LATERAL PIPES, DOWNSTREAM OF THE CONTROL VALVES, SHALL BE HAVE SOLVENT WELD JOINTS AND SHALL MEET THE LATEST REQUIREMENTS OF ASTM D 2241 STANDARD SPECIFICATION FOR POLY (VINYL CHLORIDE) / (PVC) PLASTIC PIPE WITH STANDARD DIMENSION RATIO (SDR) OF 21 AND A PRESSURE RATING (PR) OF 200 PSI.
- 16. LATERAL PIPING DEPTH: 12" MINIMUM DEPTH.
- 17. LOW FLOW DRIP PIPING TYPE & FITTINGS: RAINBIRD OR EQUAL.
- 18. LOW FLOW DRIP PIPING DEPTH: BELOW MULCH LAYER OR AS SPECIFIED BY MANUFACTURER
- 19. ALL PIPING TO HAVE MAXIMUM VELOCITIES OF FIVE FEET PER SECOND.
- 20. ALL 1/2" INLET SPRAY HEADS SHALL BE CONNECTED TO THE IRRIGATION PIPING UTILIZING 1/2" THICK WALLED POLYETHYLENE TUBING (RAIN BIRD MODEL SPX-100) AND APPROPRIATE INSERT FITTINGS (RAIN BIRD MODELS SBE-050, SBE-075, SBA-050, SBA-075). SUFFICIENT LENGTHS OF FLEXIBLE PIPE SHALL BE USED TO FORM A SWEEPING ARC TO ENSURE THAT SPRAY HEADS ARE SUPPORTED PROPERLY AND ALLOW FOR VERTICAL ADJUSTMENT AND MOVEMENT DURING SERVICE.
- 21. SWING JOINTS: EQUAL TO PREFABRICATED SCH. 80 PVCBY SPEARS. FOR USE ON GEAR-DRIVEN ROTARY HEADS, QUICK-COUPLING VALVES, AND GROUND LEVEL POP-UP IMPACT DRIVEN HEADS
- 22. ZONE VALVES: RAINBIRD PEB OR EQUAL
- 23. WHERE POSSIBLE, LOCATION OF ZONE & OTHER VALVES TO BE IN GROUNDCOVER OR LOW PLANTING BEDS. VALVES INSTALLED IN TURF AREAS TO BE OUTSIDE NATURAL WALKWAYS AND PATHS.
- 24. VALVE BOXES FOR ZONE VALVES: EQUAL TO CARSON INDUSTRIES MODEL 1419 WITH 1419-6X EXTENSIONS.
- 25. VALVE BOXES TO BE SET WITH COVER FLUSH WITH FINISH GRADE WITH EARTH FILL CAREFULLY TAMPED AROUND EACH VALVE BOX.
- 26. VALVE BOXES SHALL BE SUPPORTED BY BLOCKING BELOW IN SUCH THAT ANY SURFACE LOADS ON THE VALVE BOX ARE NOT TRANSMITTED TO PIPING OR
- 27. VALVE BOXES SHALL HAVE 12" BY 12" BY 8" MINIMUM DEPTH WASHED GRAVEL SUMP TO ALLOW WATER TO DRAIN AWAY FROM VALVES.
- 28. VALVE BOXES SHALL BE CENTERED ON THE VALVES.
- 29. ZONE VALVE BOXES TO BE PLACED PARALLEL TO NEARBY CURBS, WALKS, WALL, BUILDINGS, ETC.
- 30. ABOVE GRADE BACKFLOW PREVENTERS TO BE IN FIBERGLASS ENCLOSURE EQUAL TO "HOT BOX" MANUFACTURED BY NORTHEAST FLORIDA ENTERPRISES, INC 1/800-736-0238. PLACE ON CONCRETE SLAB AND ANCHOR WITH 4 BOLTS. SIZE TO FIT BACKFLOW PREVENTER. PROVIDE ELECTRICAL CONNECTION FOR HEATER CABLE AS RECOMMENDED BY ENCLOSURE MANUFACTURER.
- 31. WIRE FOR COMMUNICATION BETWEEN THE CONTROLLER AND DECODERS SHALL BE 14-2 GAUGE MAXI-CABLE AS REQUIRED FOR THE DECODER SYSTEM.
- 32. ENVIRONMENTAL SENSORS TO BE EQUAL TO RAINBIRD WR2 RAIN/FREEZE SENSOR. MOUNT SENSOR AT INCONSPICUOUS LOCATION APPROVED BY OWNER'S REPRESENTATIVE USING MANUFACTURER'S RECOMMENDATIONS.
- 33. CONTRACTOR SHALL PROVIDE A BOOSTER PUMP TO INCREASE THE WATER PRESSURE WHERE NECESSARY TO PROVIDE DESIGNED PRESSURE. THE FINAL BOOSTER PUMP STATION DESIGN CRITERIA WILL DEPEND ON THE DESIGN REQUIREMENTS FOR PROJECT AS WELL AS THE STATIC WATER PRESSURE AT THE TIME OF PROJECT CONSTRUCTION. CONTRACTOR SHALL CONSULT WITH OWNER OR HIS REPRESENTATIVE BEFORE ORDERING THE BOOSTER PUMP.
- 34. INSTALL AUTOMATIC DRAIN VALVES AT ALL LOW SECTIONS OF LATERAL PIPING (LINES DOWNSTREAM FROM VALVES) TO ENSURE COMPLETE DRAINAGE OF SYSTEM WHEN NOT IN USE. WRAP EACH VALVE WITH APPROVED FILTER FABRIC. MINIMUM OF TWO DRAINS PER ZONE
- 35. UPON COMPLETION OF THE IRRIGATION SYSTEM INSTALLATION INCLUDING ALL PRESSURE TESTS, CONTRACTOR SHALL CONDUCT A PERFORMANCE TEST OF THE COMPLETE SYSTEM TO INSURE THAT ALL COMPONENTS ARE FUNCTIONING PROPERLY. PERFORMANCE TEST SHALL CONSIST OF OPERATING THE SYSTEM THROUGH A COMPLETE IRRIGATION CYCLE PER DAY FOR TWO (2) CONSECUTIVE DAYS. CONTRACTOR SHALL BE AT THE SITE TO MONITOR THE PERFORMANCE TESTS AND MAKE ANY ADJUSTMENTS AND CORRECTIONS AS NEEDED DURING THE TESTING PERIOD.






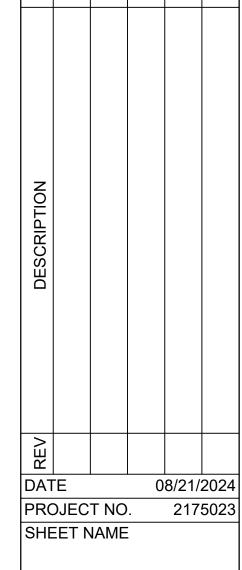

LANDSCAPE **SPECIFICATIONS**


- 1. REFER TO LANDSCAPE PLANS FOR LOCATIONS AND EDGE CONDITIONS.
- 2. CONTRACTOR TO REMOVE ALL ROPE, BURLAP, AND TOP HOLDING RINGS FROM TOP OF ROOTBALL. 3. EXCAVATED SOIL MAY BE USED FOR BACKFILL IF IT IS FRIABLE AND FREE OF ROCKS AND CLODS OVER 2"
- DIAMETER. PROVIDE ADDITIONAL TOPSOIL IF NEEDED FOR TOPSOIL/COMPOST MIX AT SURFACE.
- 4. COMPOST TO BE EQUAL TO BACK TO EARTH COMPOSTED COTTON BURS AND BE INCORPORATED INTO UPPER 6" OF BACKFILL BY APPROVED MEANS AT THE RATE OF 8 CUBIC FEET (4-2CF BAGS) FOR EACH TREE.
- 5. TIE STRAP TO BE EQUAL TO (ARBORTIE) AS SUPPLIED BY DEEPROOT www.deeproot.com CONTRACTOR TO USE (ARBORKNOT) TIE METHOD TO PRODE EXPANDING, GIRDLE FREE ATTACHMENT TO TREE.

TYPICAL TREE PLANTING

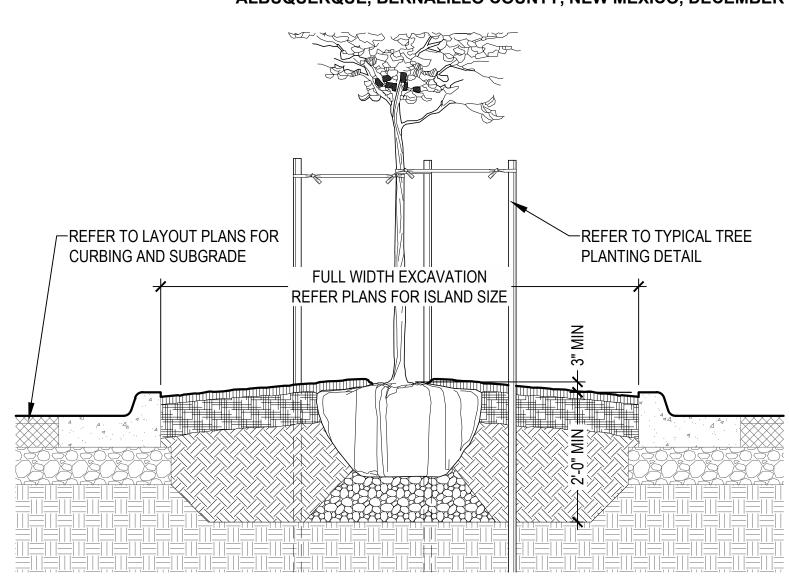

- 1. REFER TO LANDSCAPE PLANS FOR LOCATIONS AND EDGE CONDITIONS.
- 2. REFER TO TYPICAL TREE PLANTING DETAIL FOR MULCH, SOIL, COMPOST, GUYING, ETC.
- 3. CENTER OF PARKING LOT ISLAND TO BE MOUNDED WITH TOP OF ROOTBALL / BASE OF ROOT FLARE ABOVE ADJACENT CURB 3" MINIMUM - OR - 3% SLOPE, WHICH EVER IS GREATER.
- 4. EXCAVATION FOR PLANTING IN PARKING LOT ISLANDS TO BE 2'-0" MINIMUM WITH SOIL BACKFILL EXTENDING 6" MINIMUM BELOW TREE ROOTBALL WITH COMPACTED WASHED AGGREGATE FOR SUPPORT AS SHOWN.

TREE PLANTING IN PARKING LOT ISLAND

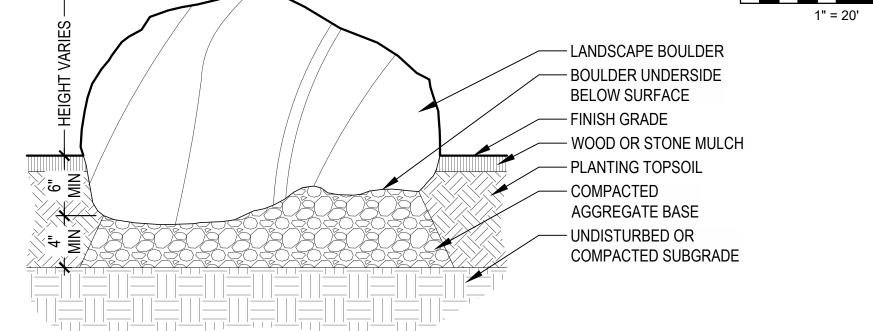

CAUTION: IF THIS SHEET IS NOT 22"x34" IT IS A REDUCED PRINT

- 1. REFER TO LANDSCAPE PLANS FOR LOCATIONS AND EDGE CONDITIONS.
- 2. REFER TO CIVIL PLANS FOR SITE GRADING.
- 3. FOR CLARITY, FINISH GRADE TO BE CONSIDERED TOP OF TOPSOIL / BOTTOM OF RIVER ROCK.
- 4. BOULDERS TO BE NATIVE, WEATHERED, FIELD-COLLECTED SANDSTONE WITH NO SUBSTANTIAL SCARS AND SHALL HAVE SIGNIFICANT COVERAGE OF LICHENS AND/OR MOSS.
- 5. LANDSCAPE BOULDERS TO HAVE CHARACTER AND FACE ON ALL VISIBLE SIDES. OWNER'S REPRESENTATIVE TO APPROVE BOULDER SAMPLE PRIOR TO PLACEMENT.
- 6. BOULDERS SHOULD RANGE IN SIZE FROM 2'-4'L X 18"-30" W X 18"-30" H.
- 7. BOULDERS TO BE PARTIALLY BURIED TO SIMULATE A NATURAL CONDITION AS SHOWN. DEPTH OF
- BOULDERS TO BE BURIED TO AVERAGE 1/4 OF HEIGHT OR AS NEEDED TO SIMULATE A NATURAL CONDITION.
- 8. CONTRACTOR TO SUBMIT IMAGES OF BOULDERS INTENDED FOR USE ON PROJECT FOR REVIEW AND APPROVAL BY OWNER'S REPRESENTATIVE PRIOR TO DELIVERY.
- 9. STORED AND INSTALLED BOULDERS ON SITE TO BE PROTECTED FROM DAMAGE FROM ALL CONSTRUCTION OPERATIONS WITH DAMAGED BOULDERS REPLACED AT NO COST TO OWNER.
- 10. LOCATION AND ORIENTATION OF BOULDERS TO BE APPROVED BY OWNER'S REPRESENTATIVE.


TYPICAL BOULDER INSTALLATION

CAUTION

NOTICE TO CONTRACTOR

THE CONTRACTOR IS SPECIFICALLY CAUTIONED THE LOCATION AND ELEVATION OF EXISTING UTILITIES AS SHOWN ON THESE PLANS ARE BASED ON RECORDS OF THE VARIOUS UTILITY COMPANIES AND MEASUREMENTS TAKEN IN THE FIELD. THE INFORMATION IS NOT TO BE RELIED ON AS BEING EXACT OR COMPLETE. THE CONTRACTOR MUST CALL THE LOCAL UTILITY LOCATION CENTER AT LEAST 72 HOURS BEFORE ANY EXCAVATION TO REQUEST EXACT FIELD LOCATIONS OF THE UTILITIES.



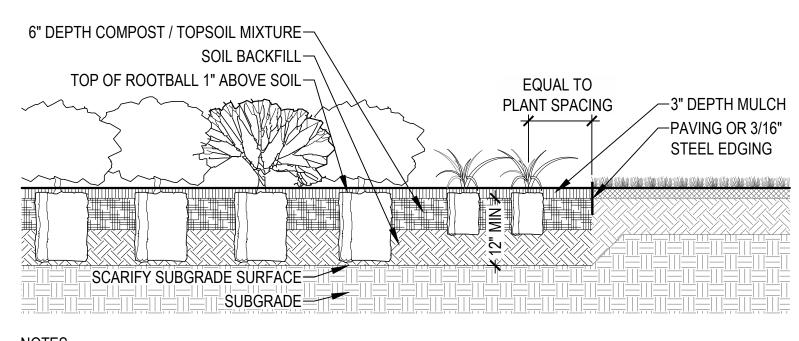

1. REFER TO LANDSCAPE PLANS FOR LOCATIONS AND EDGE CONDITIONS.

- 2. EXCAVATED SOIL MAY BE USED FOR BACKFILL IF IT IS FRIABLE AND FREE OF ROCKS AND CLODS OVER 2" DIAMETER. PROVIDE ADDITIONAL TOPSOIL IF NEEDED FOR TOPSOIL/COMPOST MIX AT SURFACE.
- 3. COMPOST TO BE EQUAL TO BACK TO EARTH COMPOSTED COTTON BURS AND BE INCORPORATED INTO UPPER 6" OF BACKFILL BY APPROVED MEANS FOR ALL SHRUB PLANTING AREAS.
- 4. TOPSOIL / BACKFILL SOIL DEPTH IN PLANTING AREAS TO BE 12" MINIMUM UNLESS OTHERWISE NOTED.

TYPICAL SHRUB PLANTING

tructural · civil · landscape · survey 9800 pyramid court, suite 350

wallace

collective



Project #: _____ Application #: _____

This checklist will be used to verify the completeness of site plans submitted for review by the Planning Department. Because development proposals vary in type and scale, there may be submittal requirements that are not specified here. Also there may additional requirements if a site is located in CPO, HPO, and/or VPO or if located in DT-UC-MS or PT areas. See the IDO or AGIS for boundaries. Nonetheless, applicants are responsible for providing a complete submittal. Certification as specified below is required.
CERTIFY THAT THE SUBMITTED SITE PLAN IS COMPLETE AND ACCURATE, AND THAT ALL APPLICABLE INFORMATION AS SPECIFIED IN THIS CHECKLIST IS PROVIDED. FURTHER, I UNDERSTAND THAT THIS APPLICATION IS BEING ACCEPTED PROVISIONALLY AND THAT INACCURATE AND/OR INCOMPLETE INFORMATION MAY RESULT IN THE SUBSEQUENT ADDRESS OF ONE MONTH OR MORE IN THE DATE THE APPLICATION IS SCHEDULED FOR PUBLIC HEARING. A DELAY OF ONE MONTH OR PUBLIC HEARING. Applicant or Agent Signature / Date

Site plan packets shall be composed of the following plan sheets (unless otherwise approved in writing prior to submittal by the Planning Department):

- **Site Plan (**including utilities and easements)
- 2. **Landscaping Plan**
- **Grading and Drainage Plan** 3.
- **Utility Plan** 4.
- **Building and Structure Elevations** 5-
- Previously approved Development Plan (if applicable) 6.

The electronic format must be organized in the above manner.

The following checklist describes the minimum information necessary for each plan element. The Applicant must include all checklist items on their site plan drawings and confirm inclusion by checking off the items below. Non-applicable items must be labeled "N/A." Each non-applicable designation must be explained by notation on the Checklist.

NOTE: There may be addition information required if site is located with a CPO, VPO or HPO and/or any other special areas as defined by the IDO.

NOTE: If there requests for deviations (Section 14-16-6-4(O), they must be clearly labelled on the site plan (Sheet 1) as well as addressed in the application letter made with the submittal.

SHEET #1 - SITE PLAN

A. General Information



1. Date of drawing and/or last revision 2. Scale: 1.0 acre or less 1" = 10' Date of drawing and/or last revision

1.0 - 5.0 acres 1" = 20' Over 5 acres 1" = 50' Over 20 acres 1" = 100'

3. Bar scale
4. North arrow
5. Legend

✓ 6. Scaled vicinity map

7. Property lines (clearly identify)

8. Existing and proposed easements (identify each)

NA9. Phases of development, if applicable

B. Proposed Development

1. Structural

A. Location of existing and proposed structures (distinguish between existing & proposed) and include any accessory structures

✓B. Square footage of each structure✓C. Proposed use of each structure

✓ D. Signs (freestanding) and other improvements

NA E. Walls, fences, and screening: indicate height, length, color and materials

F. Dimensions of all principal site elements or typical dimensions

NAG. Loading facilities

✓H. Site lighting (indicate height & fixture type)

NA I. Indicate structures within 20 feet of site

✓ J. Elevation drawing of refuse container and enclosure, if applicable.

K. Existing zoning/land use of all abutting properties

2. Parking, Loading and Internal Circulation

✓A. Parking layout with spaces numbered per aisle and totaled.

Location and typical dimensions, including motorcycle spaces, bicycle spaces, ADA accessible spaces, and compact spaces

Calculations: spaces required and proposed (include any reduction calculations) for motorcycle, bicycle, compact and ADA spaces

NA 3. On street parking spaces

✓B. Bicycle parking & facilities

✓1. Bicycle racks – location and detail

NA 2. Other bicycle facilities, if applicable

✓ C. Vehicular Circulation (Refer to DPM and IDO)

1. Ingress and egress locations, including width and curve radii dimensions


2. Drive aisle locations, including width and curve radii dimensions


3. End aisle locations, including width and curve radii dimensions Location & orientation of refuse enclosure, with dimensions

Loading, service area, and refuse service locations and dimensions

✓ D. Pedestrian Circulation

Location and dimensions of all sidewalks and pedestrian paths (including ADA connection from ROW to building and from ADA parking to building)

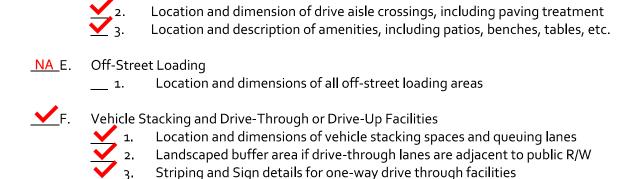


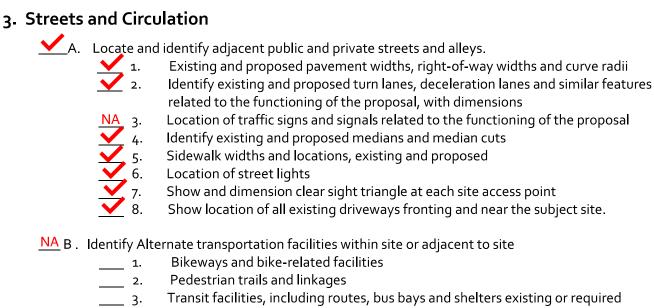

4. Phasing

NAA. Proposed phasing of improvements and provision for interim facilities. Indicate phasing plan, including location and square footage of structures and associated improvements including circulation, parking and landscaping.

SHEET #2 - LANDSCAPING PLAN

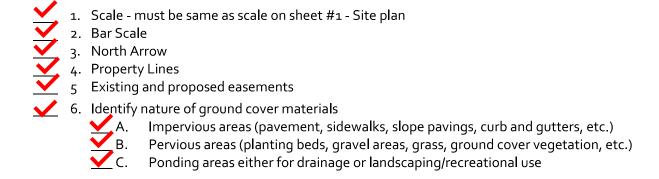



7. Identify type, location and size of plantings (common and/or botanical names).

NA A. Existing, indicating whether it is to preserved or removed.

Proposed, to be established for general landscaping.

Proposed, to be established for screening/buffering.

8. Describe irrigation system – Phase I & II . . .

9. Planting Beds, indicating square footage of each bed

10. Turf Area - only 20% of landscaped area can be high water turf; provide square footage and percentage.

11. Responsibility for Maintenance (statement)

12. Landscaped area requirement; square footage and percent (specify clearly on plan)

13. Landscaped buffer areas provided; dimensions, label clearly that it is a landscape buffer, square footage and percent (specify clearly on plan)

14. Planting or tree well detail

15. Street Trees (only trees from the Official Albuquerque Plant Palette and Sizing list or 8 inch caliper or larger will be counted)

✓ 16. Parking lot edges and interior – calculations, dimensions and locations including tree requirements

17. Show Edge Buffer Landscaping (14-16-5-6(D)) – location, dimensions and plant material

SHEET #3 –GRADING AND DRAINAGE PLAN

A separate grading and drainage plan (and drainage report) must be submitted to the DRS Hydrology Section prior to the DRB submittal for a site plan (See DRWS Form).

A. General Information

1. Scale - must be same as Sheet #1 - Site Plan

2. Bar Scale

3. North Arrow

4. Property Lines


5. Existing and proposed easements

6. Building footprints

NA 7. Location of Retaining walls

B. Grading Information

1. On the plan sheet, provide a narrative description of existing site topography, proposed grading improvements and topography within 100 feet of the site.

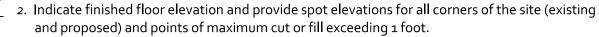

3. Identify ponding areas, erosion and sediment control facilities.

NA 4. Cross Sections

Provide cross section for all perimeter property lines where the grade change is greater than 4 feet at the point of the greatest grade change. Provide one additional cross section in each direction within no more than 100 feet of the reference point.

SHEET #4- UTILITY PLAN

🟒 A. Fire hydrant locations, existing and proposed. (or submit signed off Fire One Plan)

B. Distribution lines

C. Right-of-Way and easements, existing and proposed, on the property and adjacent to the boundaries, with identification of types and dimensions.

D. Existing water, sewer, storm drainage facilities (public and/or private).

L. Proposed water, sewer, storm drainage facilities (public and/or private)

F. Existing electric lines both overhead and underground. Power Poles shown with dimensions to proposed buildings and structures must be clearly shown.

SHEET #5 - BUILDING AND STRUCTURE ELEVATIONS

A. General Information

Scale Bar Scale

Detailed Building Elevations for each facade

✓ 1. Identify facade orientation

2. Dimensions of facade elements, including overall height and width

✓ 3. Location, material and colors of windows, doors and framing.

Materials and colors of all building elements and structures

Location and dimensions of mechanical equipment (roof and/or ground mounted)

B. Building Mounted Signage

Site location(s)
 Sign elevations to scale
 Dimensions, including height and width
 Sign face area - dimensions and square footage clearly indicated
 Lighting
 Materials and colors for sign face and structural elements.

List the sign restrictions per the IDO

LETTER OF AUTHORIZATION

December 12, 2023

Lawrence Goodman Revocable Trust u/a/d December 6, 1977 Attn: Scott Goodman 100 Sun Ave. N.E., Suite 200 Albuquerque, NM 87109 sgoodman@goodmanrealty.com

City of Albuquerque Planning & Development Plaza del Sol 600 2nd NW Albuquerque, NM 87102

Attn: City of Albuquerque Planning and Development

I, Scott Goodman of the Lawrence Goodman Revocable Trust u/a/d/December 6, 1977, property owner, hereby authorize Aaron Barnhart (Wallace), Jim Desmond (Wallace) and Mario Valentini (MRV) of Wallace Engineering (Wallace) and MRV Architects (MRV) respectively, and to prepare and sign application materials and otherwise represent the owner(s) regarding the Alvarado Development, LLC d/b/a Taco Bell development located at 1115 Snow Vista Blvd. SW, Albuquerque, New Mexico;

<u>Description of Property.</u> The parties acknowledge that the Final Plat was filed as Document #2022106470 in the office of the County Clerk of Bernalillo County, New Mexico on December 14, 2022, in Plat Book 2022C, Page 225, and that the proper legal description of the Property is as follows:

Lot 1D, as shown and designated on the Plat of Lots 1A, 1B, 1C, 1D and 1E, Snow Heights Investors, filed in the office of the County Clerk of Bernalillo County, New Mexico on December 14, 2022, in Plat Book 2022C, Page 225.

This authorization is limited to the submission of application materials to the City of Albuquerque planning and for the above referenced land development project.

			odm				
Sc	ott Go	odmar	i, on be	half of	the La	wrence G	Goodman
Re	evocab	le Trus	t u/a/d	/Decer	nber 6,	1977	
INC	vocab	ic iius	t u, u, u	Decei	ilibel 0,	1377	

Date: 2/12/24_____





October 8, 2024

Planning Department- Development Review City of Albuquerque 600 2nd St, NW Albuquerque, NM 87102

Re: Project Justification Letter

Project Number PR-2024-009956

1115 Snow Vista Blvd, SW

Albuquerque, NM

To whom it may concern:

Alvarado Development, LLC is pleased to submit for Planning Review our proposed project located at 1115 Snow Vista Blvd, SW Albuquerque, NM.

We are planning to develop a multi-tenant space to be anchored by the latest Taco Bell design. This location will fit very nicely into the neighborhood, serving great food and the Community in a variety of ways such as an easily accessible dining room, drive-through lane, and mobile ordering.

Taco Bell, being the primary anchor of the Development, strives to engage with the community, offering above average wages, great and affordable food, as well as support of local charities, schools, and events. In addition to the Taco Bell, we also anticipate a variety of other retail services, such as dry cleaners, hair salons, walk-up food concepts, clothing shops, and others that will benefit the community.

The current zoning is NR-C, which is consistent with the proposed development; our engineers have done a good job of addressing zoning requirements such as setbacks, landscape requirements, building heights, internal traffic flow, and public access, and we do not anticipate the need for any variances currently. We have also worked closely with the various City departments such as Traffic, Waste Management, Fire, Water and Sewer, among others to address any questions or concerns they may have.





Please feel free to reach out if you have any questions, we look forward to a successful project and continuing to serve the Albuquerque community.

Kindest regards,

Tracy D. Knapp

V.P. of Development

Alvarado Development, LLC

678-458-9013

TDKnapp@TeamARN.com

MRV ARCHITECTS, INC.

5105 Tollview Dr., Suite 201, Rolling Meadows, IL 60008 Ph. (224) 318-2140 – Email: mariov@mrvarch.com

May 25, 2023

City of Albuquerque Planning Department Plaza del Sol Building 600 Second NW Albuquerque, NM 87102

Memo - Taco Bell / Tenant Building

Dear Planning Department,

The applicant, Alvarado Restaurant Nation are proposing site improvements for a new tenant building with a Taco Bell quick-service restaurant with accessory drive-thru as the end cap. The address of the proposed work shall be located at 1115 Snow Vista Blvd.

As planned, the site will have shared access with Lot 1E on Snow Vista Blvd. as well as cross access with Lot 1C (not in contract).

The proposed building is 9595 SF. Of the 9595 SF, Taco Bell shall occupy 1,950 SF at the south end of the building. The remaining area (7,645 SF) shall be devoted to retail spaces.

All the typical equipment required for a fully operating drive-thru will be present. This includes a menu board, speaker-post with canopy and clearance bar. The drive-thru window will be located at the southwest corner of the building. As planned, this site allows for a 12-car drive-thru stack.

The building façade includes a variety of materials including light colored stone veneer, Graphite color metal panel, and stucco (in light and dark tan). We are proposing Graphite awnings and bronze storefront throughout.

Please feel free to contact me with any further questions regarding the request for review.

Sincerely,

Mario Valentini

MRV Architects, Inc.



SIGN POSTING AGREEMENT

REQUIREMENTS

POSTING SIGNS ANNOUNCING PUBLIC HEARINGS

All persons making application to the City under the requirements and procedures established by the Integrated Development Ordinance are responsible for the posting and maintaining of one or more signs on the property which is subject to the application, as shown in Table 6-1-1. Vacations of public rights-of-way (if the way has been in use) also require signs. Waterproof signs are provided at the time of application for a \$10 fee per sign. If the application is mailed, you must still stop at the Development Services Front Counter to pick up the sign(s).

The applicant is responsible for ensuring that the signs remain posted throughout the 15-day period prior to any public meeting or hearing. Failure to maintain the signs during this entire period may be cause for deferral or denial of the application. Replacement signs for those lost or damaged are available from the Development Services Front Counter.

1. LOCATION

- A. The sign shall be conspicuously located. It shall be located within twenty feet of the public sidewalk (or edge of public street). Staff may indicate a specific location.
- B. The face of the sign shall be parallel to the street, and the bottom of the sign shall be at least two feet from the ground.
- C. No barrier shall prevent a person from coming within five feet of the sign to read it.

NUMBER

- A. One sign shall be posted on each paved street frontage. Signs may be required on unpaved street frontages.
- B. If the land does not abut a public street, then, in addition to a sign placed on the property, a sign shall be placed on and at the edge of the public right-of-way of the nearest paved City street. Such a sign must direct readers toward the subject property by an arrow and an indication of distance.

PHYSICAL POSTING

- A. A heavy stake with two crossbars or a full plywood backing works best to keep the sign in place, especially during high winds.
- B. Large headed nails or staples are best for attaching signs to a post or backing; the sign tears out less easily.

4.	TIME						
Signs mus	t be post	ed from	October 8th	n, 2024	To	November 8, 2024	
5.	REMO	VAL					= 40
	A. B.					earing on the request. after the initial hearing.	
I have read to keep the	d this she sign(s)	eet and di posted fo	scussed it with or (15) days and	the Developm (B) where the	ent Services sign(s) are	s Front Counter Staff. I understan to be located. I am being given a 10/8/2024	d (A) my obligation copy of this sheet.
	_		00	(Applican	t or Agent)	(Date)	
l issued	sign	s for this	application, _	(Date)		(Staff Member)	

PROJECT NUMBER: PR-2024-009956

From: Tracy D. Knapp <TDKnapp@TeamARN.com>
Sent: Tuesday, September 10, 2024 2:55 PM
To: David Serban; Aaron Barnhart; Jake Croop

Subject: Fw: 1115 Snow Vista Blvd. SW_Public Notice Inquiry Sheet Submission

Attachments: IDOZoneAtlasPage_M-09-Z_Site Label.pdf

See the attached links to use for applying for the permits and planning approval for 98th and Sage. Please let me know what else you need to complete the process.

Kindest regards,

Tracy D. Knapp Vice President of Development

TDKnapp@TeamARN.com Mobile 678-458-9013





Please submit all invoices to APinvoices@teamarn.com

From: Office of Neighborhood Coordination <onc@cabq.gov>

Sent: Tuesday, September 10, 2024 12:08 PM **To:** Tracy D. Knapp < TDKnapp@TeamARN.com>

Subject: 1115 Snow Vista Blvd. SW_Public Notice Inquiry Sheet Submission

This email came from an EXTERNAL sender

PLEASE NOTE:

The neighborhood association contact information listed below is valid for 30 calendar days after today's date.

Dear Applicant:

Please find the neighborhood contact information listed below. Please make certain to read the information further down in this e-mail as it will help answer other questions you may have.

		First	Last						Mobile	
Association Name	Association Email	Name	Name	Email	Address Line 1	City	State	Zip	Phone	Phone
Route 66 West NA		Cherise	Quezada	cherquezada@yahoo.com	10304 Paso Fino Place SW	Albuquerque	NM	87121	5052631178	
Route 66 West NA		Paul	Fava	paulfava@gmail.com	505 Parnelli Drive SW	Albuquerque	NM	87121	5053853202	
South West Alliance of Neighborhoods (SWAN Coalition)		Geraldine	Ulibarri	gerulibarri1@gmail.com	9009 Starboard NW	Albuquerque	NM	87121	5059076851	
South West Alliance of Neighborhoods (SWAN Coalition)		Lorenzo	Otero	housealbchrome@gmail.com	1413 Hilda Ct NW	Albuquerque	NM	87105		5053851251
Westgate Heights NA	westgate9901@gmail.com	Matthew	Archuleta	mattearchuleta1@hotmail.com	1628 Summerfield Place SW	Albuquerque	NM	87121	5054016849	

Westgate Heights NA	westgate9901@gmail.com	Christoper	Sedillo	navrmc6@aol.com	605 Shire Street SW	Albuquerque	NM	87121	6193155051	
Westside Coalition of Neighborhood Associations		Rene	Horvath	aboard111@gmail.com	5515 Palomino Drive NW	Albuquerque	NM	87120	5059852391	5058982114
Westside Coalition of Neighborhood Associations		Elizabeth	Haley	elizabethkayhaley@gmail.com	6005 Chaparral Circle NW	Albuquerque	NM	87114	5054074381	

The ONC does not have any jurisdiction over any other aspect of your application beyond this neighborhood contact information. We can't answer questions about sign postings, pre-construction meetings, permit status, site plans, buffers, or project plans, so we encourage you to contact the Planning Department at: 505-924-3857 Option #1, e-mail: devhelp@cabq.gov, or visit: https://www.cabq.gov/planning/online-planning-permitting-applications with those types of questions.

Please note the following:

- You will need to e-mail each of the listed contacts and let them know that you are applying for an approval from the Planning Department for your project.
- Please use this online link to find the required forms you will need to submit your permit application. https://www.cabq.gov/planning/urban-design-development/public-notice.
- The Checklist form you need for notifying neighborhood associations can be found here: https://documents.cabq.gov/planning/online-forms/PublicNotice/CABQ-Official public notice form-2019.pdf.
- The Administrative Decision form you need for notifying neighborhood associations can be found here: https://documents.cabq.gov/planning/online-forms/PublicNotice/Emailed-Notice-Administrative-Print&Fill.pdf
- Once you have e-mailed the listed contacts in each neighborhood, you will need to attach a copy of those e-mails AND a copy of this e-mail from the ONC to your application and submit it to the Planning Department for approval.

If your application requires you to offer a neighborhood meeting, you can click on this link to find required forms to use in your e-mail to the neighborhood association(s): http://www.cabq.gov/planning/urban-design-development/neighborhood-meeting-requirement-in-the-integrated-development-ordinance

If you have questions about what type of notification is required for your particular project or meetings that might be required, please click on the link below to see a table of different types of projects and what notification is required for each:

https://ido.abc-zone.com/integrated-development-ordinance-ido?document=1&outline-name=6-1%20Procedures%20Summary%20Table

Thank you,

Suzie



Suzie Flores

Senior Administrative Assistant

Office of Neighborhood Coordination (ONC) | City Council Department | City of Albuquerque

(505) 768-3334 Office

E-mail: suzannaflores@cabq.gov
Website: www.cabq.gov/neighborhoods

From: webmaster@cabq.gov <webmaster@cabq.gov>

Sent: Tuesday, September 10, 2024 11:40 AM

To: Office of Neighborhood Coordination <TDKnapp@TeamARN.com>

Cc: Office of Neighborhood Coordination <onc@cabq.gov>

Subject: Public Notice Inquiry Sheet Submission

[EXTERNAL] Forward to phishing@cabq.gov and delete if an email causes any concern.

Public Notice Inquiry For:

Other (please specify in field below)

If you selected "Other" in the question above, please describe what you are seeking a Public Notice Inquiry for below:

Site Plan Review

Contact Name

Tracy Knapp

Telephone Number

678-458-9013

Email Address

TDKnapp@TeamARN.com

Company Name

Alvarado Development, LLC

Company Address

City

State

ZIP

Legal description of the subject site for this project:

Physical address of subject site:

1115 Snow Vista Blvd. SW, Albuquerque, NM 87121

Subject site cross streets:

98th St SW and Sage Ranch Ct

Other subject site identifiers:

This site is located on the following zone atlas page:

M-09-Z

Captcha

X

Public Notice of a Proposed Project in the City of Albuquerque Administrative Review/Decision – Electronic Mail

Date o	f Notice*:
This no	otice of an application for a proposed project is provided as required by Integrated Development
Ordina	nce (IDO) §14-16-6-4(K) Public Notice. This notice is being provided to the Neighborhood
Repres	sentatives on the attached list from the City of Albuquerque's Office of Neighborhood
Coordi	nation.
Projec	t Information Required by <u>IDO §14-16-6-4(K)(1)(a)</u>
1.	Subject Property Address*
	Location Description
2.	Property Owner*
3.	Agent/Contractor [if other than the property owner]
4.	Application(s) Type* per IDO <u>Table 6-1-1</u>
	 □ Historic Certificate of Appropriateness – Minor □ Sign Permit □ Alternative Signage Plan □ Wall/Fence Permit □ Site Plan – Administrative Summary of project/request*:
5.	This application will be decided by staff. Please contact devhelp@cabq.gov or call the Planning Department at 505-924-3860 and select option for Development Review Services.
6.	Where more information about the project can be found*:
	Preferred project contact information:
	Name:
	Email:
	Phone:

	 Attachments: Neighborhood Association Representative Contact List from the City's Office of Neighborhood Coordination* Others:
	☐ Online website or project page:
Projec	t Information Required for Email Notice by IDO §14-16-6-4(K)(1)(b):
1.	Zone Atlas Page(s)*1
2.	•
	Architectural drawings
	Elevations of the proposed building(s)
	Other illustrations of the proposed application
	See attachments or the website/project page noted above for the items marked above
3.	The following exceptions to IDO standards have been requested for this project*:
	Deviation(s) Variance(s) ³ Waiver(s) ⁴
	Explanation*:
4.	For Site Plan – Administrative Applications only*,
	Attach the proposed site plan showing, at a minimum:
	☐ a. Location of proposed buildings and landscape areas. *
	□ b. Access and circulation for vehicles and pedestrians. *
	☐ c. Maximum height of any proposed structures, with building elevations.*
	☐ d. For residential development*: Maximum number of proposed dwelling units.
	☐ e. For non-residential development*:

□ Total gross floor area of proposed project.□ Gross floor area for each proposed use.

[Note: Items with an asterisk (*) are required.]

¹ Available online here: <u>http://data.cabq.gov/business/zoneatlas/</u>

² While not required, it is recommended that a site plan be included illustrating the location of existing buildings, if any, and the proposed project.

³ Separate notice is required for Variance Applications.

⁴ Separate notice is required for Waiver Applications.

[Note:	Items with an asterisk (*) are required.]
	Pre-submittal Neighborhood Meeting date, if it occurred:
	Brief Meeting Summary:
	[Note: The meeting report by the Office of Alternative Dispute Resolution is required to be provided in the application materials.]
Additi	ional Information from IDO Zoning Map ⁵ :
1.	Area of Property [typically in acres]
2.	IDO Zone District(s)
3.	Overlay Zone(s) [if applicable]
4.	Center or Corridor Area [if applicable]
5.	Current Land Use(s) [vacant, if none]
within for a S more t Plannii	Pursuant to IDO §14-16-6-4(L), property owners within 330 feet and Neighborhood Associations 660 feet may request a post-submittal facilitated meeting within 15 days of the date of this notice ite Plan – Administrative application that proposes more than 100 multi-family dwelling units or than 50,000 s.f. of nonresidential development. To request a facilitated meeting, contact the ng Department at devhelp@cabq.gov or 505-924-3860 and select the option for "Development of Services".
Useful	Links
	Integrated Development Ordinance (IDO): https://ido.abc-zone.com/
	IDO Interactive Map: https://tinyurl.com/idozoningmap

⁵ Available here: https://tinyurl.com/idozoningmap



Language Access Notice:

We provide free interpretation services to help you communicate with us. If you need help, you can request interpretation at any service counter in our Department, located in the Plaza Del Sol building, 600 2nd Street NW, Albuquerque, NM 87102.

Notificación de Acceso Lingüístico.
Ofrecemos servicios gratuitos de interpretación para ayudarlo a comunicarse con nosotros. Si necesita ayuda, puede solicitar servicios de interpretación en cualquier mostrador de servicio de nuestro Departamento, ubicado en el edificio Plaza Del Sol, 600 2nd Street NW, Albuquerque, NM 87102.

語言輔助通知。我們提供免費口譯服務,以幫助你與我們溝通。如果你需要幫助,你可以在我們部門的任何服務台請求口譯,服務台位於Plaza Del Sol大樓,600 2nd Street NW,阿爾伯克基,NM 87102。

Thông báo về cách Tiếp cận Ngôn ngữ. Chúng tôi cung cấp các dịch vụ thông dịch miễn phí để giúp quý vị giao tiếp với chúng tôi. Nếu quý vị cần giúp đỡ, quý vị có thể yêu cầu thông dịch tại bất cứ quầy dịch vụ nào trong Sở của chúng tôi, tọa lạc tại tòa nhà Plaza Del Sol, 600 2nd Street NW, Albuquerque, NM 87102.

Saad Hadahwiis'a O'oolkaah bee dah na'astsooz. Nihi bik'inaasdzil t'aadoo baahilinigoo 'ata' hashne' tse'esgizii ach'i' dzaadi! Dzaadi! Danihi dahootahgoo bee nihi-. Daa' danihi bidin nishli dzaadi! Dzaadi! Dzaadi! Dzaadi! Danihi bineesh'a yinishkeed 'ata' hashne' -di t'aa biholniihgoo tse'esgizii ket'aaz -di nihihigii dah diikaah, -k'eh -di tsin Plaza Del Sol Kiniit'aagoo, 600 2nd Kiniit'aa NW, Albuquerque, NM 87102.

From: David Serban

Sent: Thursday, September 12, 2024 8:32 AM

To: cherquezada@yahoo.com
Cc: Tracy D. Knapp; Mario Valentini

Subject: Public Notice - New Multi-Tenant Building - 1115 Snow Vista Blvd. SW, Albuquerque,

NM

Attachments: 1115 Snow Vista Blvd_Public Notice of Proposed Project.pdf; 1115 Snow Vista Blvd_Site

Plan and Elevations.pdf

Hello,

We are notifying you that we are applying for a site plan approval from the Planning Department for a multi-tenant building with a Taco Bell endcap to be located at 1115 Snow Vista Blvd, SW, Albuquerque, NM 87121. I've attached the public notice form along with a PDF showing a zone atlas map, site plan, and elevations for the proposed project.

Thank you,

David Serban MRV Architects, Inc. 5105 Tollview Dr., Suite 201 Rolling Meadows, IL 60008

From: David Serban

Sent: Thursday, September 12, 2024 8:33 AM

To: paulfava@gmail.com

Cc: Tracy D. Knapp; Mario Valentini

Subject: Public Notice - New Multi-Tenant Building - 1115 Snow Vista Blvd. SW, Albuquerque,

NM

Attachments: 1115 Snow Vista Blvd_Public Notice of Proposed Project.pdf; 1115 Snow Vista Blvd_Site

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Thank you,

David Serban MRV Architects, Inc. 5105 Tollview Dr., Suite 201 Rolling Meadows, IL 60008

From: David Serban

Sent: Thursday, September 12, 2024 8:35 AM

To: gerulibarri1@gmail.com

Cc: Tracy D. Knapp; Mario Valentini

Subject: Public Notice - New Multi-Tenant Building - 1115 Snow Vista Blvd. SW, Albuquerque,

NM

Attachments: 1115 Snow Vista Blvd_Public Notice of Proposed Project.pdf; 1115 Snow Vista Blvd_Site

Plan and Elevations.pdf

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Thank you,

David Serban MRV Architects, Inc. 5105 Tollview Dr., Suite 201 Rolling Meadows, IL 60008

From: David Serban

Sent: Thursday, September 12, 2024 8:36 AM

To: housealbchrome@gmail.com
Cc: Tracy D. Knapp; Mario Valentini

Subject: Public Notice - New Multi-Tenant Building - 1115 Snow Vista Blvd. SW, Albuquerque,

NM

Attachments: 1115 Snow Vista Blvd_Public Notice of Proposed Project.pdf; 1115 Snow Vista Blvd_Site

Plan and Elevations.pdf

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Thank you,

David Serban MRV Architects, Inc. 5105 Tollview Dr., Suite 201 Rolling Meadows, IL 60008

From: David Serban

Sent: Thursday, September 12, 2024 8:38 AM

To: mattearchuleta1@hotmail.com
Cc: Tracy D. Knapp; Mario Valentini

Subject: Public Notice - New Multi-Tenant Building - 1115 Snow Vista Blvd. SW, Albuquerque,

NM

Attachments: 1115 Snow Vista Blvd_Public Notice of Proposed Project.pdf; 1115 Snow Vista Blvd_Site

Plan and Elevations.pdf

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Thank you,

David Serban MRV Architects, Inc. 5105 Tollview Dr., Suite 201 Rolling Meadows, IL 60008

From: David Serban

Sent: Thursday, September 12, 2024 8:39 AM

To: navrmc6@aol.com

Cc: Tracy D. Knapp; Mario Valentini

Subject: Public Notice - New Multi-Tenant Building - 1115 Snow Vista Blvd. SW, Albuquerque,

NM

Attachments: 1115 Snow Vista Blvd_Public Notice of Proposed Project.pdf; 1115 Snow Vista Blvd_Site

Plan and Elevations.pdf

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Thank you,

David Serban MRV Architects, Inc. 5105 Tollview Dr., Suite 201 Rolling Meadows, IL 60008

From: David Serban

Sent: Thursday, September 12, 2024 8:40 AM

To: westgate9901@gmail.com **Cc:** Tracy D. Knapp; Mario Valentini

Subject: Public Notice - New Multi-Tenant Building - 1115 Snow Vista Blvd. SW, Albuquerque,

NM

Attachments: 1115 Snow Vista Blvd_Public Notice of Proposed Project.pdf; 1115 Snow Vista Blvd_Site

Plan and Elevations.pdf

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Thank you,

David Serban MRV Architects, Inc. 5105 Tollview Dr., Suite 201 Rolling Meadows, IL 60008

From: David Serban

Sent: Thursday, September 12, 2024 8:41 AM

To: aboard111@gmail.com

Cc: Tracy D. Knapp; Mario Valentini

Subject: Public Notice - New Multi-Tenant Building - 1115 Snow Vista Blvd. SW, Albuquerque,

NM

Attachments: 1115 Snow Vista Blvd_Public Notice of Proposed Project.pdf; 1115 Snow Vista Blvd_Site

Plan and Elevations.pdf

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Thank you,

David Serban MRV Architects, Inc. 5105 Tollview Dr., Suite 201 Rolling Meadows, IL 60008

From: David Serban

Sent: Thursday, September 12, 2024 8:42 AM

To: elizabethkayhaley@gmail.com
Cc: Tracy D. Knapp; Mario Valentini

Subject: Public Notice - New Multi-Tenant Building - 1115 Snow Vista Blvd. SW, Albuquerque,

NM

Attachments: 1115 Snow Vista Blvd_Public Notice of Proposed Project.pdf; 1115 Snow Vista Blvd_Site

Plan and Elevations.pdf

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Thank you,

David Serban MRV Architects, Inc. 5105 Tollview Dr., Suite 201 Rolling Meadows, IL 60008