


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		l, Inc. Consultants Consultants e Street NE NM 87108 v.iacivil.com
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		firm or corporation for any purpose whatsoever except with the written permission of
		Isaacson & Arfman, Inc.
		N. AND Ching
		A EN MET COS
	PROJECT INFORMATION LEGAL DESCRIPTION:	
	DEGAL DESCRIPTION. TRACT A-1, BLOCK 11, LA MESA NO. 2 SUBDIVISION, AS SHOWN ON THE REPLAT OF LOTS 1-8 AND LOT A, BLOCK 11, LA MESA NO. 2, RECORDED IN THE OFFICE OF THE BERNALILLO COUNTY CLERK ON NOVEMBER 18, 2013, IN BOOK 2013C,	Mu ROFFOCIONA ST
	PAGE 130, DOCUMENT NO. 2013124811.	09/06/24
	<u>SITE AREA:</u> 0.9494 ACRES <u>ZONING:</u> MX-M	Engineer
(ZONE MX-M) 	BUILDING CALCULATIONS: GROSS FLOOR AREA (GFA)=64,380 SF ± 1-BEDROOM UNITS= 70 LEASING OFFICE= 500 SF COMMERCIAL= 1,700 SF	
	OPEN SPACE CALCULATIONS: UC-MS-PT OPENSPACE REQUIREMENTS 225 SQUARE FEET x 1 BED= 15,750 SF	SE 108
NOTE: ALL BROKEN OR CRACKED	Solve MAIN STREET CORRIDOR REDUCTION=7,875 SF REQUIRED: 7,875 SF	E. 87
II SIDEWALK MUST BE II REPLACED WITH SIDEWALK II AND CURB & GUTTER.	PROVIDED: 10,853 SF PARKING CALCULATIONS:	E,
	SEE TABLE THIS SHEET	os DU
REQUIRED PARKING AFTER PARKING REDUCTION REDUCTION	NOTE: COMMERCIAL SPACE MAY BE COMMERCIAL SERVICE, COMMERCIAL RETAIL, OR A COMBINATION OF BOTH. THEREFORE, THE PARKING CALCULATION USED BELOW IS BASED ON COMMERCIAL SERVICES, WHICH REQUIRES MORE PARKING THAN COMMERCIAL RETAIL.	SOMOS NTRAL UERQU
70 28 (40%) 42	APPLICABLE PARKING REDUCTIONS MULTI-FAMILY UNITS: 5-5(C)(5)(d)(1&2) 40% PROXIMITY TO TRANSIT REDUCTION	EN S
1 1 (40%) 0	LEASING OFFICE: 5-5(C)(5)(d)(1&2) 40% PROXIMITY TO TRANSIT REDUCTION COMMERCIAL SERVICES: 5-5(C)(5)(d) 50% PREMIUM TRANSIT REDUCTION	B C
5 3 (50%) 2	APPLICABLE PARKING CREDITS 5-5(C)(6)(b) 1 VAN POOL PARKING x 7 SPACES= 7 SPACES 5-5(C)(6)(c) SHARED VEHICLE PROGRAM x 4 SPACES= 4 SPACES	200
PARKING CREDITS 11	<i>1 PARKING SPACE TO BE DESIGNATED AS "CAR SHARING PARKING ONLY"</i> AND TO BE MADE PART OF A CAR SHARING PROGRAM ESTABLISHED BY	
TOTAL PARKING REQUIRED 33	<u>THE OWNER DURING DEVELOPMENT OF THE PROJECT.</u> TOTAL CREDITS = 11 TOTAL REQUIRED: 33 SPACES	
	TOTAL PROVIDED: 37 SPACES (INCLUDES 9 ADA, 3 COMPACT, AND 5 ON-STREET)	
DFF-PEAK FREQUENCY OF 15 MINUTES QUENCY OF 15 MINUTES OFF-PEAK FREQUENCY OF 15 MINUTES	ADA REQUIRED: 2 SPACES (1 VAN SPACE) (PER 26-50 REQUIRED PARKING) ADA PROVIDED: 9 SPACES (3 VAN SPACES)	STRUCTION SUBMITTAL T.dwg
EQUENCY OF 40 MINUTES	EV READY REQUIRED:2 SPACES (5% OF REQUIRED PARKING)EV READY PROVIDED:2 SPACESEV CAPABLE REQUIRED:6 SPACES (15% OF REQUIRED PARKING)	STRU(SUBM T.dwg
EGEND	EV CAPABLE REQUIRED: 6 SPACES (15% OF REQUIRED PARKING) EV CAPABLE PROVIDED: 6 SPACES MOTORCYCLE REQUIRED: 2 SPACES (PER 26-50 REQUIRED PARKING)	ON 01 01 01 01 01 01 01 01 01 01 01 01 01
PROPERTY LINE	MOTORCYCLE PROVIDED: 3 SPACES BICYCLE REQUIRED: 4 SPACES (10% OF REQUIRED PARKING)	FOR SP-1
EXISTING CURB AND GUTTER	BICYCLE PROVIDED : 20 SPACES (18 SPACES INTERIOR, 2 SPACES EXTERIOR)	O T N By By KED
PROPOSED CURB	PROJECT NO: PR-2024-010784 APPLICATION NO: SI-2024-01164	N ISSUE: NUMBE FILE: 2 CHECK
ADA SPACE	IS AN APPROVED INFRASTRUCTURE LIST REQUIRED? []YES [x]NO IF YES, THEN A SET OF APPROVED DRC PLANS WITH A WORK ORDER IS REQUIRED FOR	
PEDESTRIAN CROSSWALK	ANY CONSTRUCTION WITHIN PUBLIC RIGHT OF WAY OR FOR CONSTRUCTION OF PUBLIC IMPROVEMENTS. DFT SITE DEVELOPMENT PLAN APPROVAL	Description DFT Comments
		DFT (Deso
BIKE RACK PARKING COUNT	<u>Const Grazie</u> Ernest Armijo (Oct 10, 2024 09:20 MDT) TED A FEIO EN OLIVIEE ED IN O	
FIRELANE (RED)	TRAFFIC ENGINEERING, DATE TRANSPORTATION DIVISION	Date 09-03-2
"NO PARKING"	Die Guile Oct 25, 2024 ABCWUA DATE	2 -
LANDSCAPE AREA SEE LANDSCAPE PLANS	Uhitry Bula Oct 10, 2024	
PCC SIDEWALK	PARKS & RECREATION DEPARTMENT DATE Theories Chan Oct 10, 2024	SHEET TITLE
	HYDROLOGY DATE	
LIGHT ASPHALT PAVING SECTION	Jeff Palmer Oct 10, 2024 12:18 MDT)Oct 10, 2024CODE ENFORCEMENTDATE	DFT SITE PLAN
HEAVY ASPHALT PAVING SECTION		
GRAVEL PAVING SECTION	*ENVIROMENTAL HEALTH (CONDITIONAL) DATE	
	Herman Gallegos 09-18-24 SOLID WASTE MANAGEMENT DATE	SHEET NUMBER
CONCRETE PAVING SECTION	Wov. 18, 2024	SP1
	PLANNING DEPARTMENT DATE	

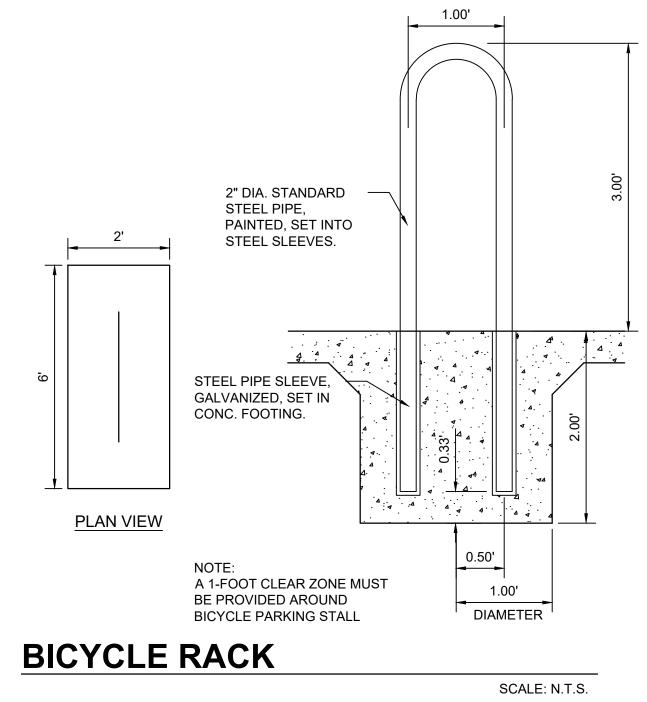



MEDIAN CURB AND GUTTER

- DRIVES. 4. EDGES NOT SPECIFICALLY DIMENSIONED SHALL BE EDGED WITH A 3/8" RADII
- CONTRACTION / CONTROL JOINTS @ 6' O.C. MAX.
- 1. REQUIRES FULL FORM ON ALL FACES.

- GENERAL NOTES

SEE PAVING

SECTION

1'-6"

11"

1"

1. CONTRACTION / CONTROL JOINTS @ 6' MAX.

2. 1/2" EXPANSION JOINTS 24' O.C.

HEADER CURB


3. REQUIRES FULL FORM ON ALL FACES.


4. 3/8" RADII AT ALL EXPOSED EDGES.

GENERAL NOTES

ALLEY GUTTER


- 3. FINISHED EDGE OF ASPHALT PAVING TO BE 1/2" ABOVE EDGE OF CONCRETE (TYP). 3/8" RADII AT ALL EXPOSED EDGES.
- 1/2" SEALED EXPANSION JOINTS 48' O.C., CURB RETURNS AND EACH SIDE OF DRIVES.
- 1. SEALED CONTRACTION / CONTROL JOINTS @ 6' MAX.
- GENERAL NOTES

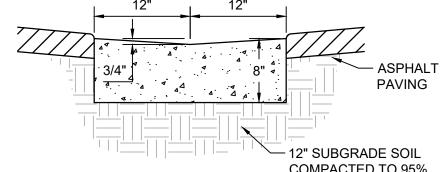

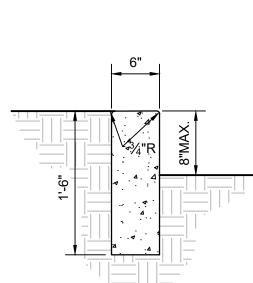

SCALE: N.T.S.

SCALE: N.T.S.

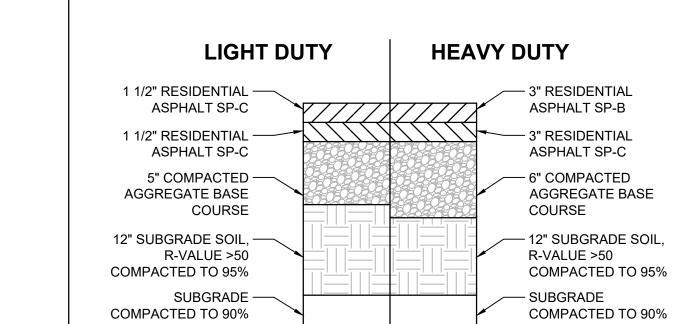


ALL EARTHWORK, OVER-EXCAVATION, COMPACTION, SUBGRADE

ASPHALT PAVING SECTIONS

REPORT PREPARED BY

PREPARATION ETC. TO BE PER THE GEOTECHNICAL ENGINEERING

CONTRACTION / CONTROL JOINT: TROWELLED ³/₈" RADII EDGES ³/₄" DEEP

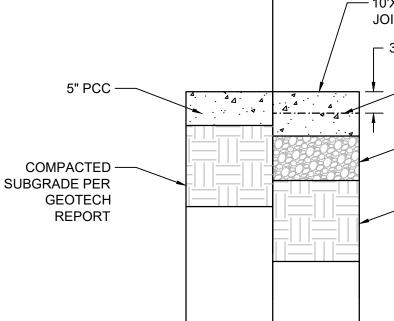

HEAVY DUTY


JOINT PATTERN.


> 6" PCC W/ #4 BARS EACH WAY @ 12" O.C.

- 6" COMPACTED AGGREGATE BASE COURSE


COMPACTED SUBGRADE PER GEOTECH REPORT

CONCRETE PAVEMENT SECTION SCALE: N.T.S.

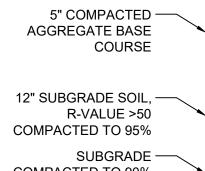

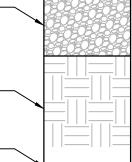


COMPACTED TO 90%

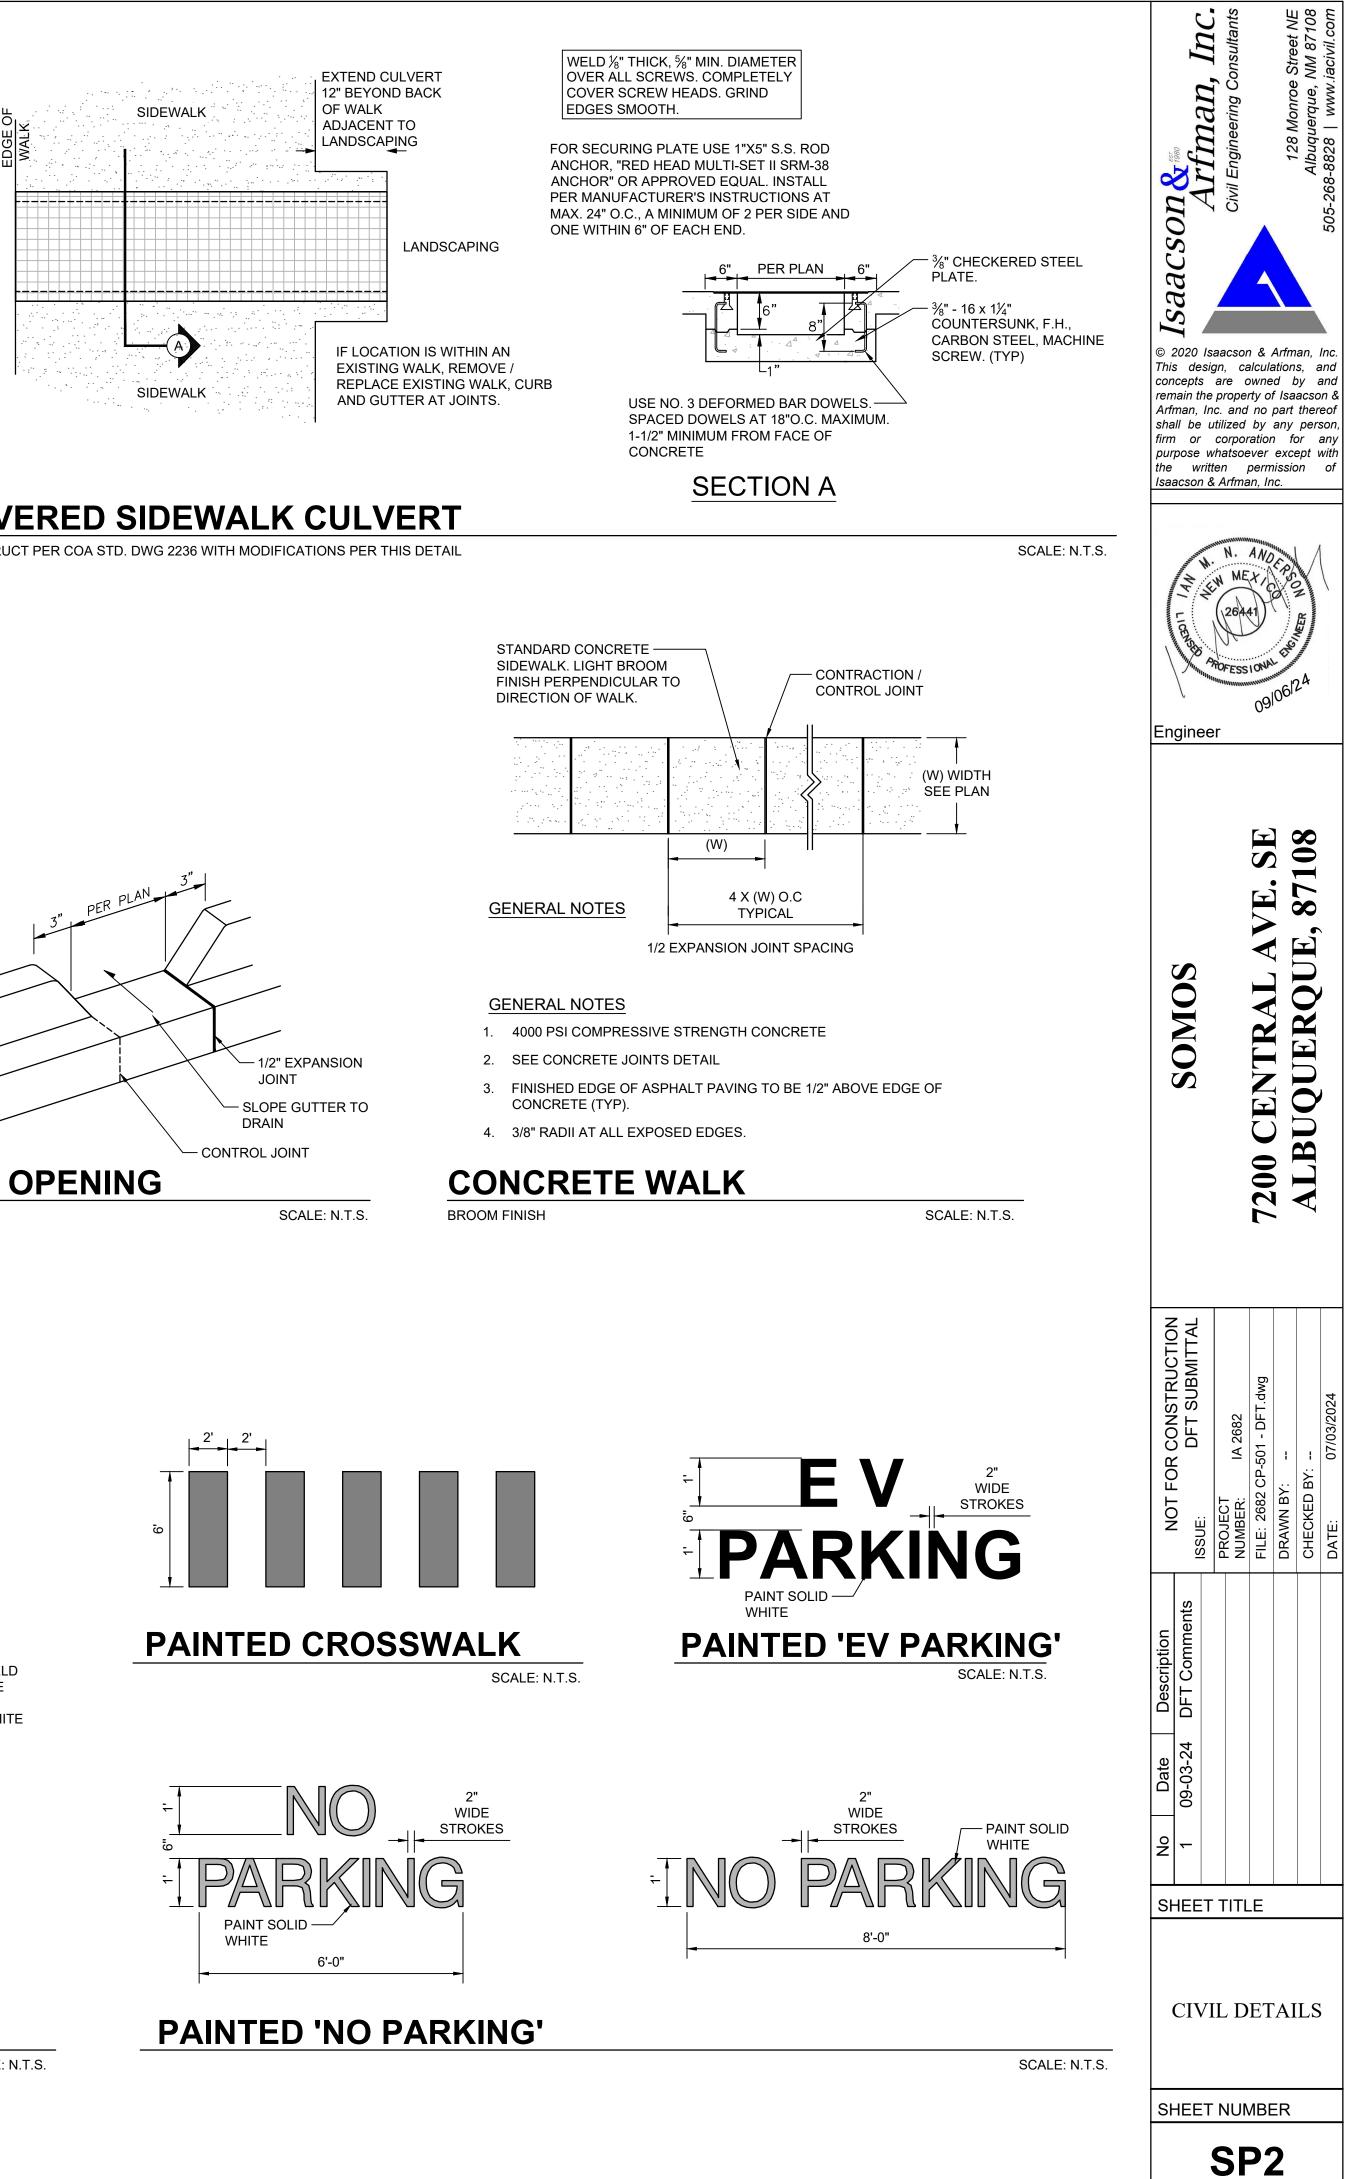

COMPACTED TO 95%

SCALE: N.T.S.

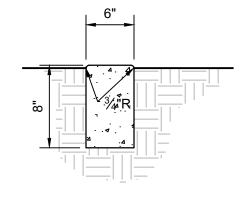

GENERAL NOTES

1. CONTRACTION / CONTROL JOINTS @ 6' MAX.

- 2. 1/2" EXPANSION JOINTS 24' O.C.
- 3. REQUIRES FULL FORM ON ALL FACES.
- 4. 3/8" RADII AT ALL EXPOSED EDGES.





SCALE: N.T.S.

2" WIDE STROKES

PAINT SOLID -


WHITE

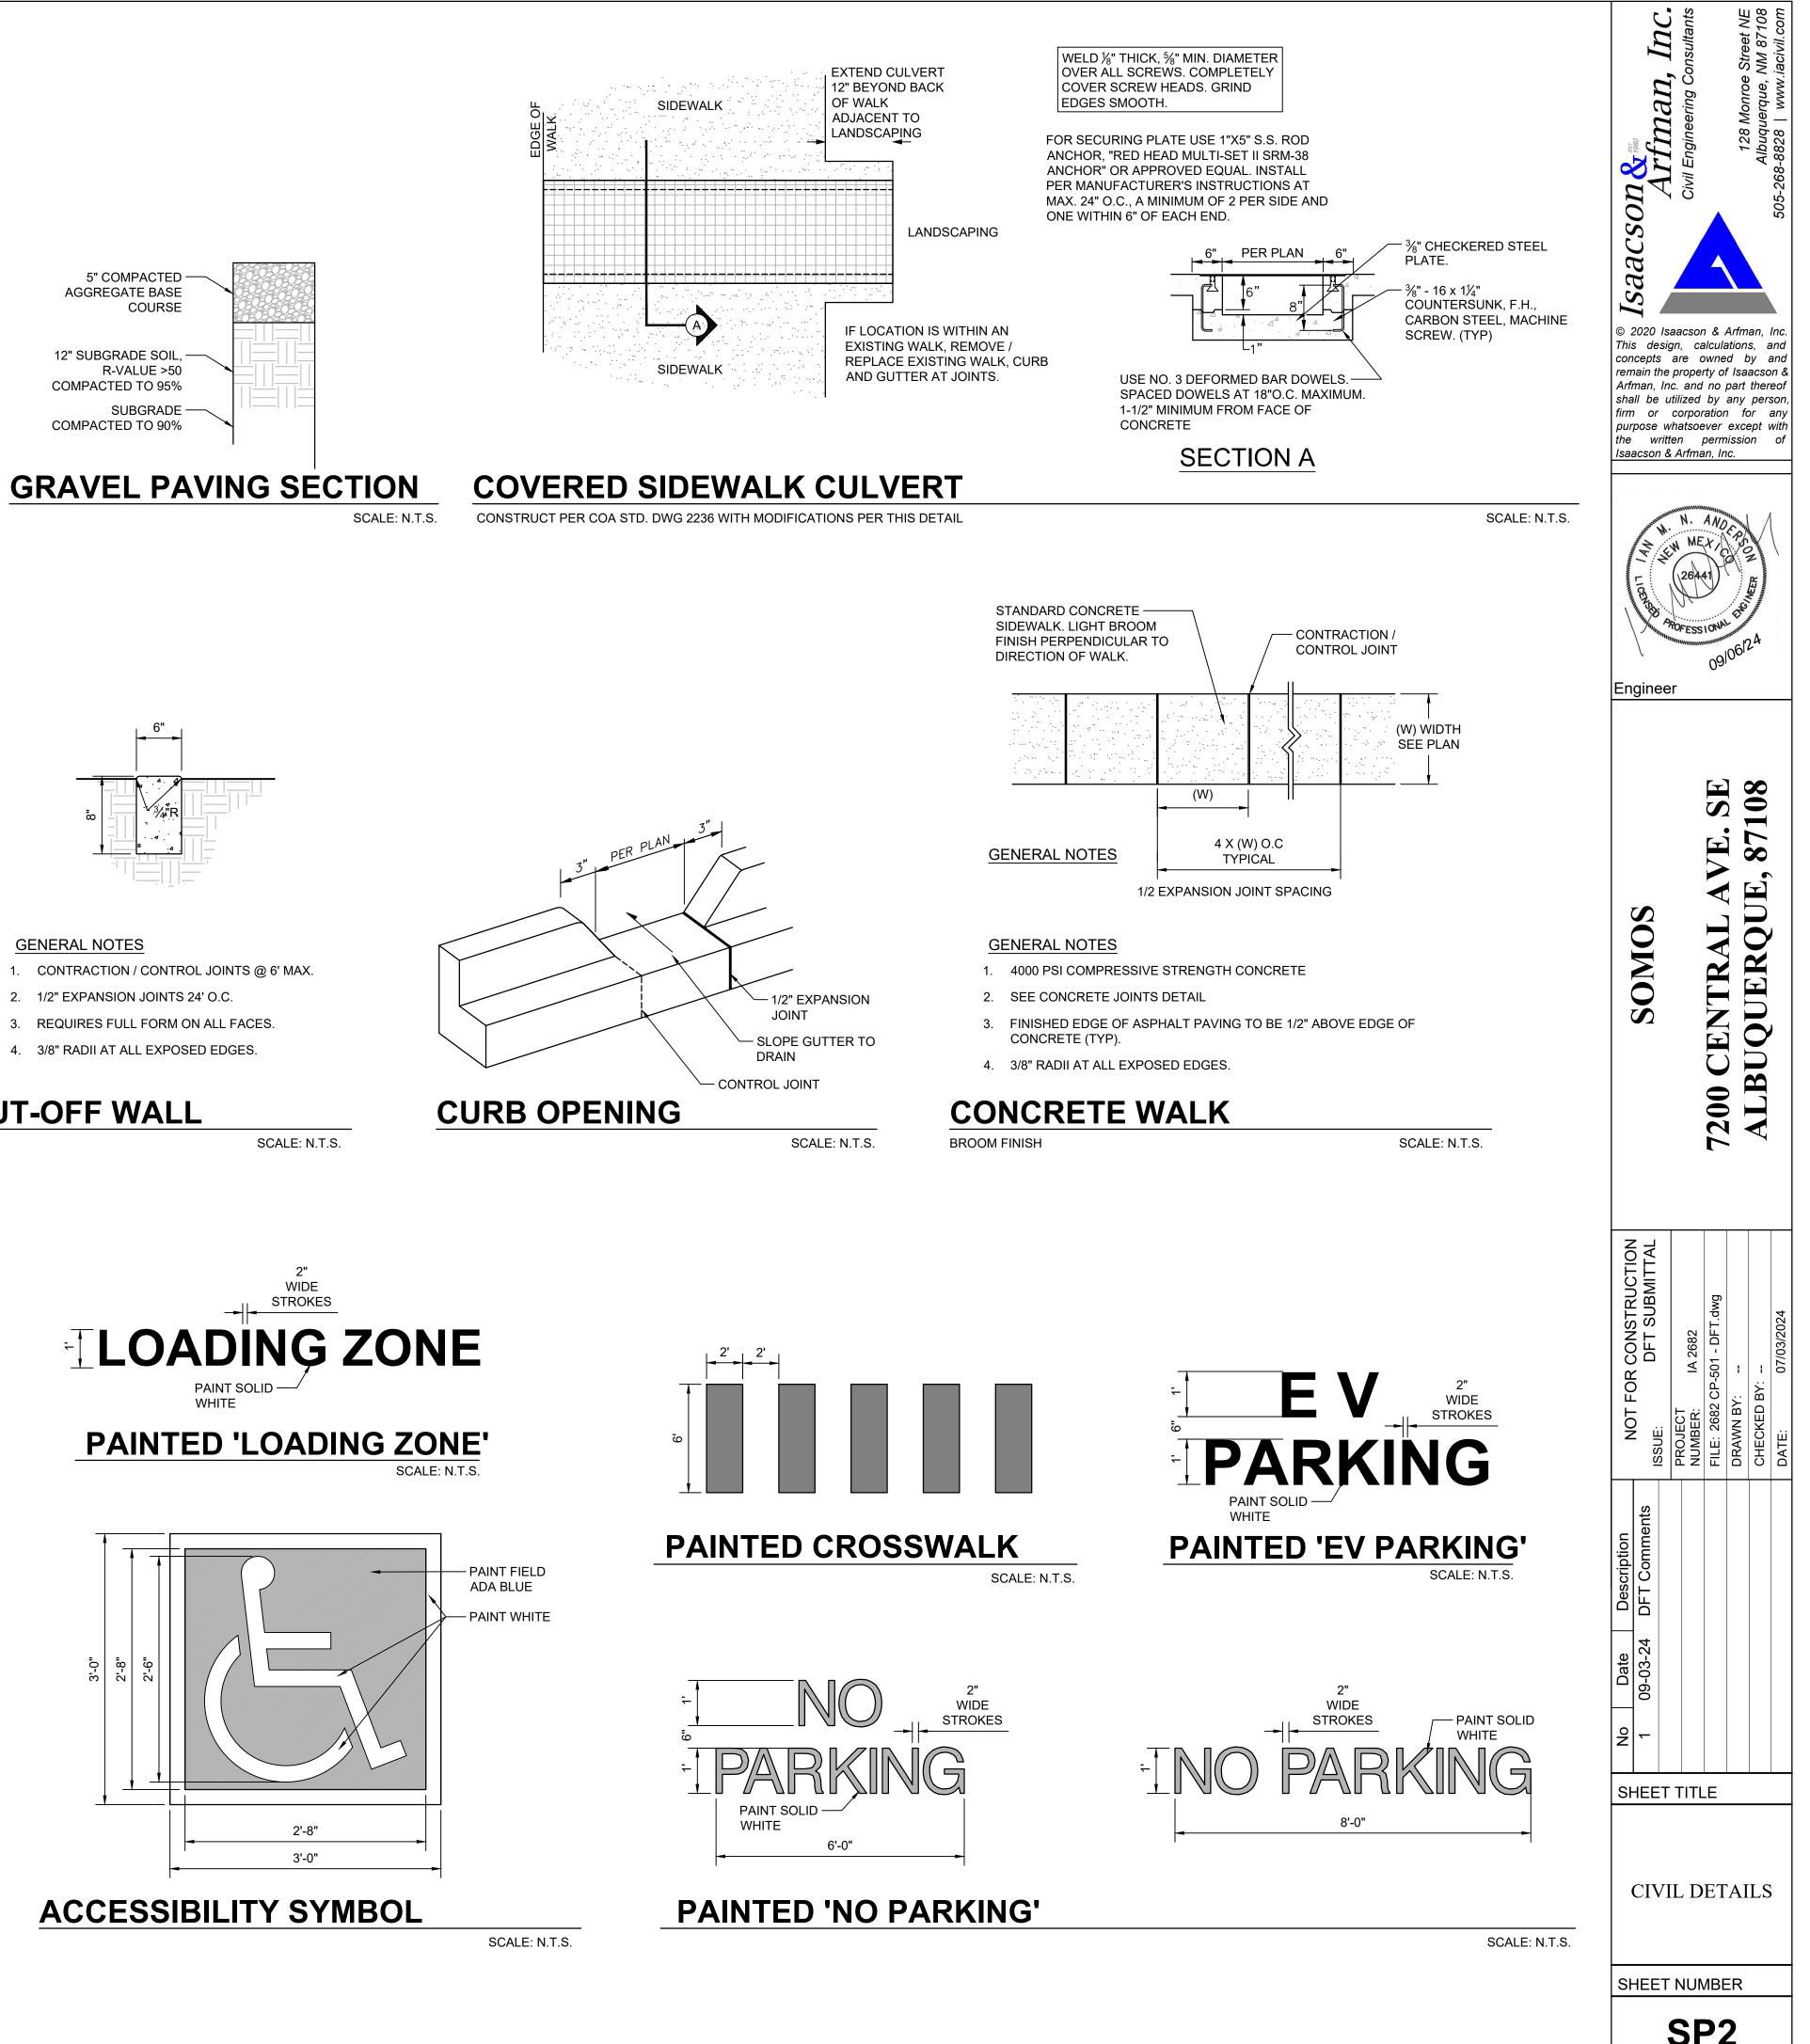


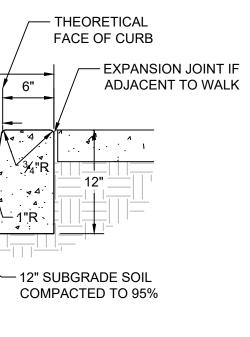



EXPANSION JOINTS @ 48' O.C., CURB RETURNS AND EACH SIDE OF

SCALE: N.T.S.

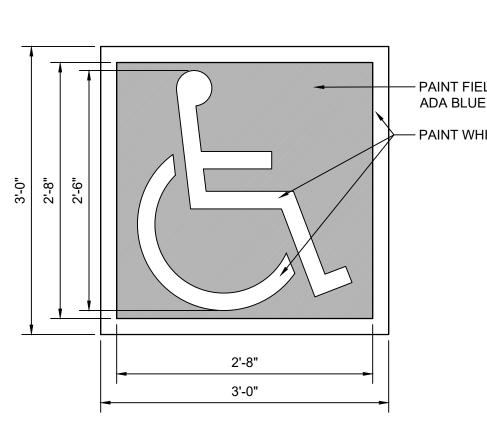


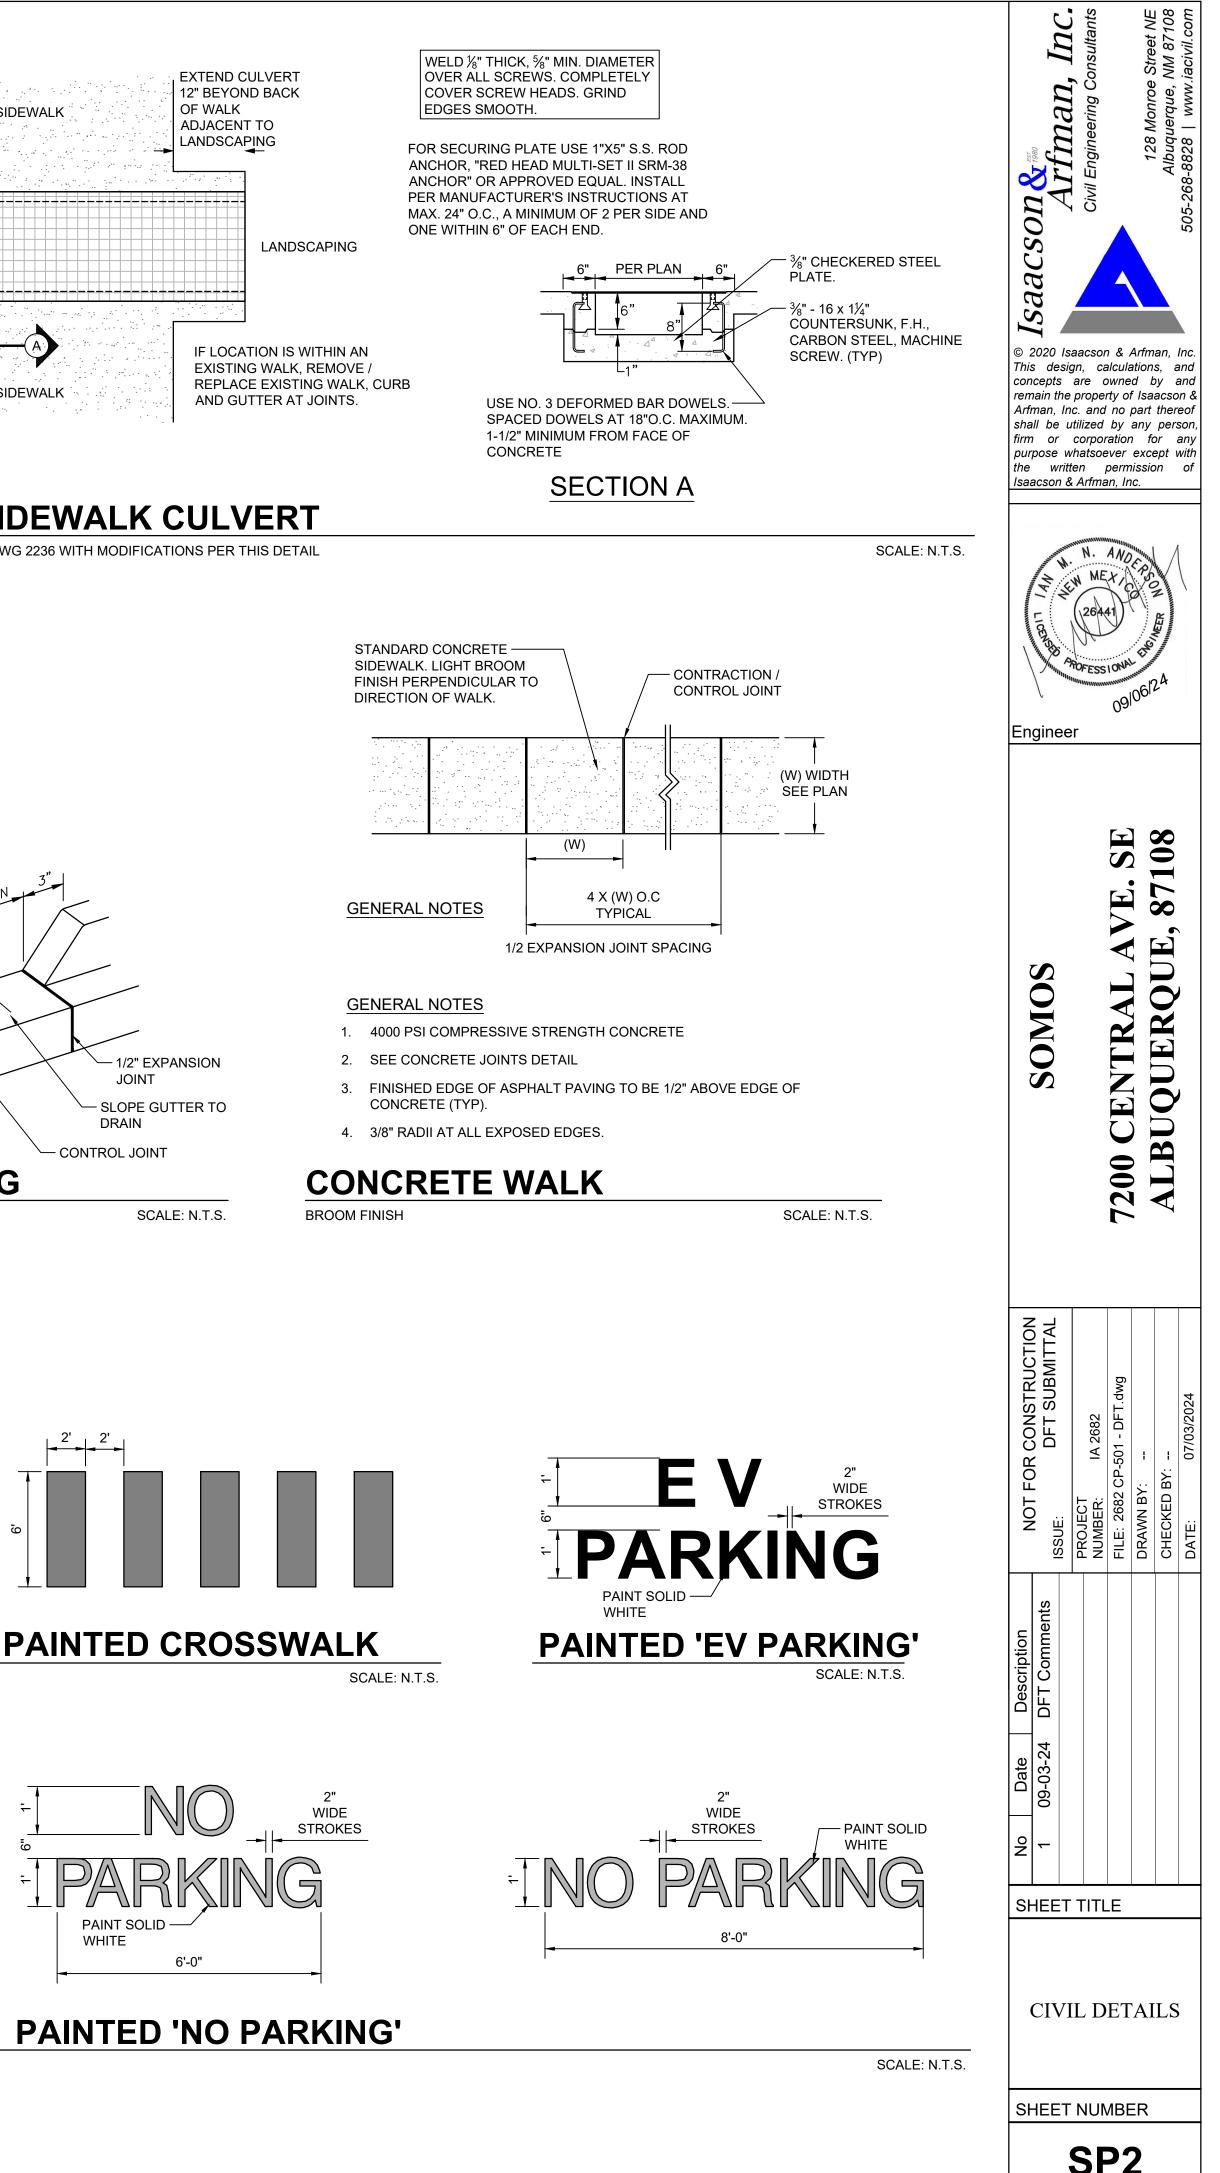


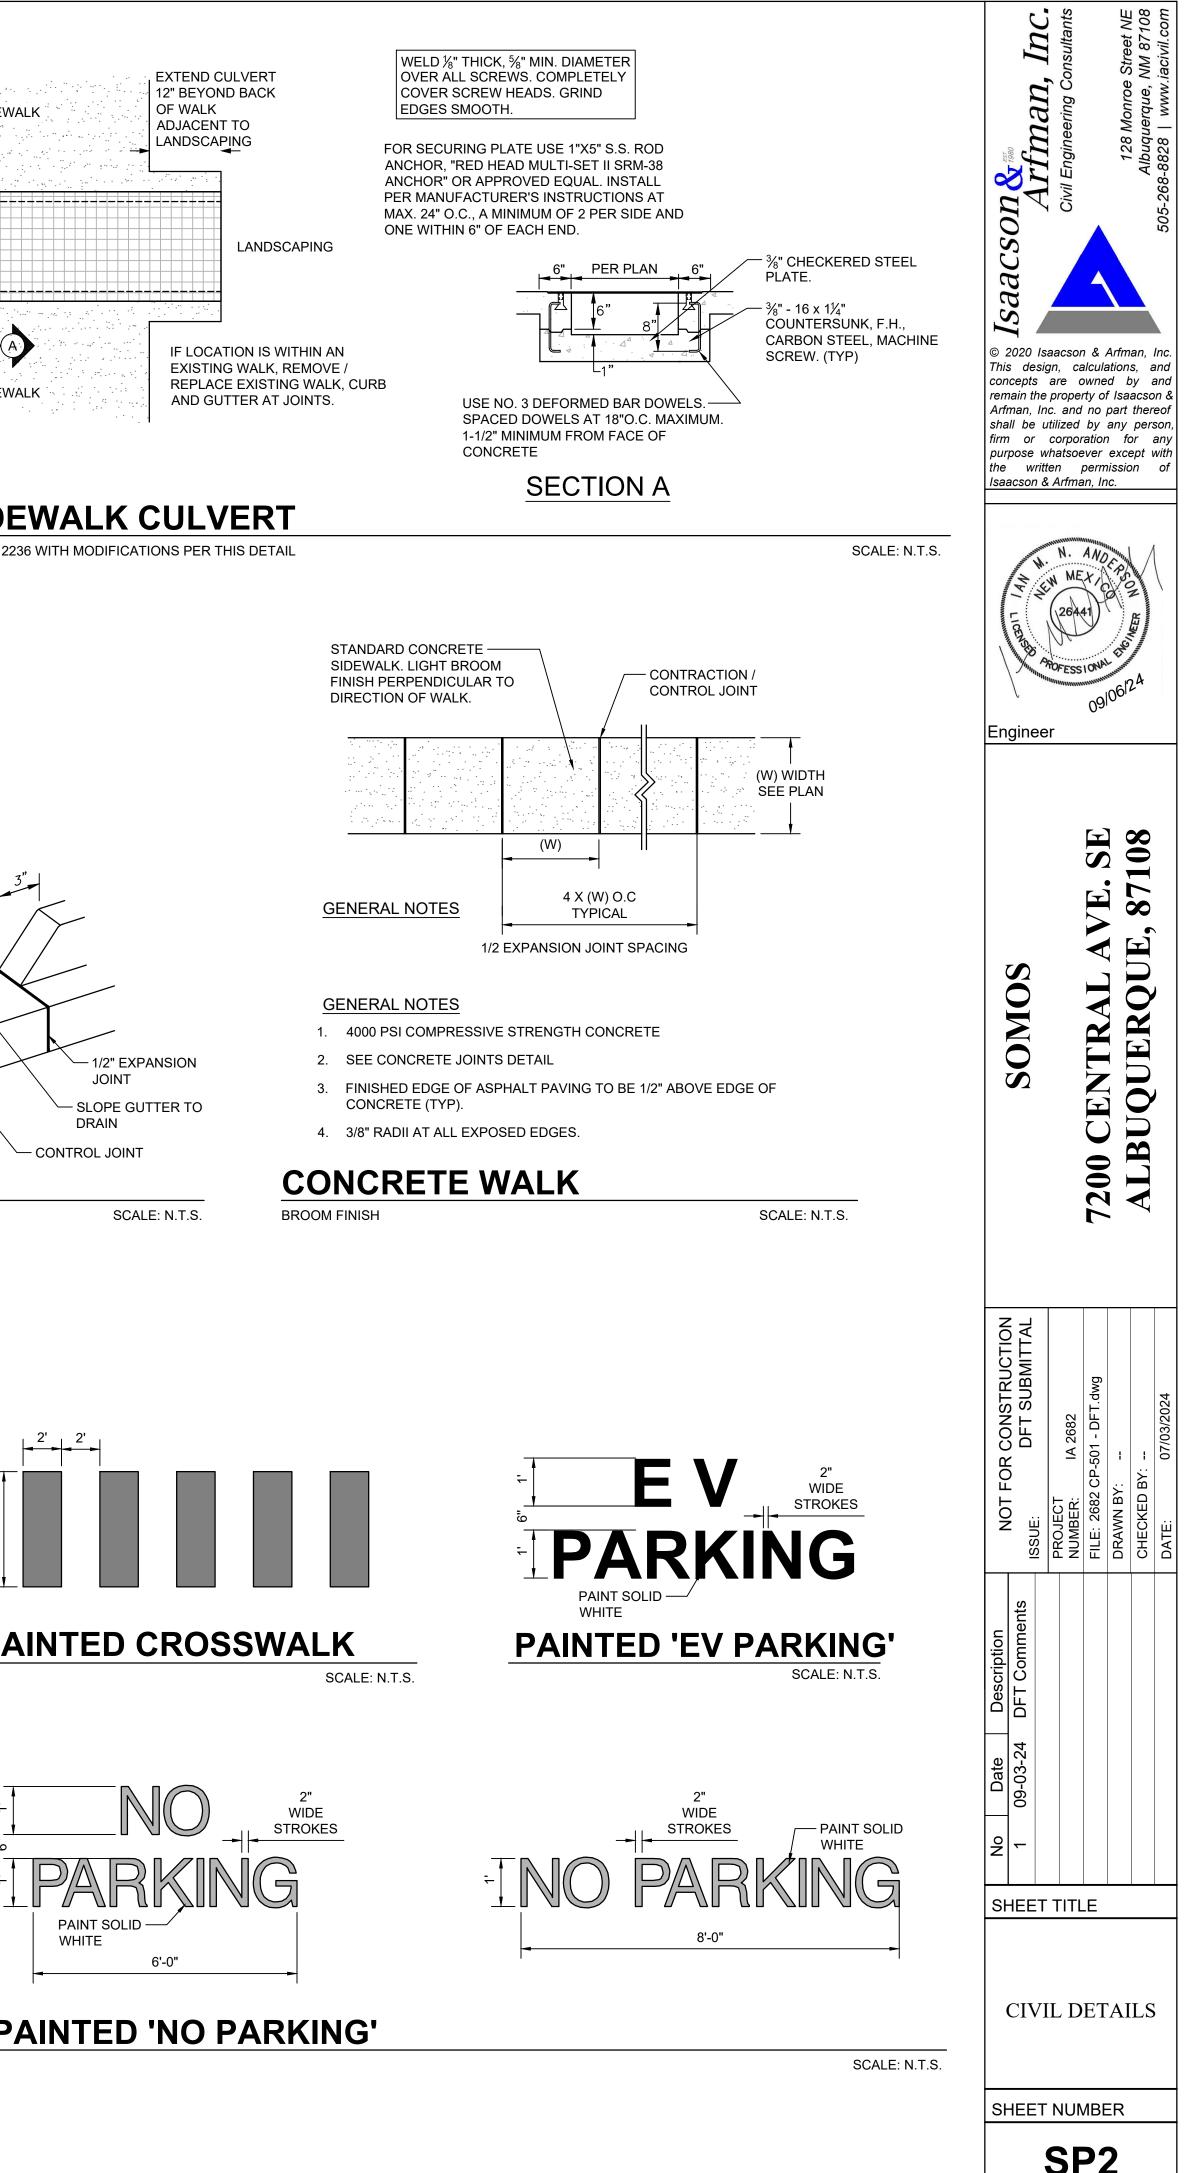

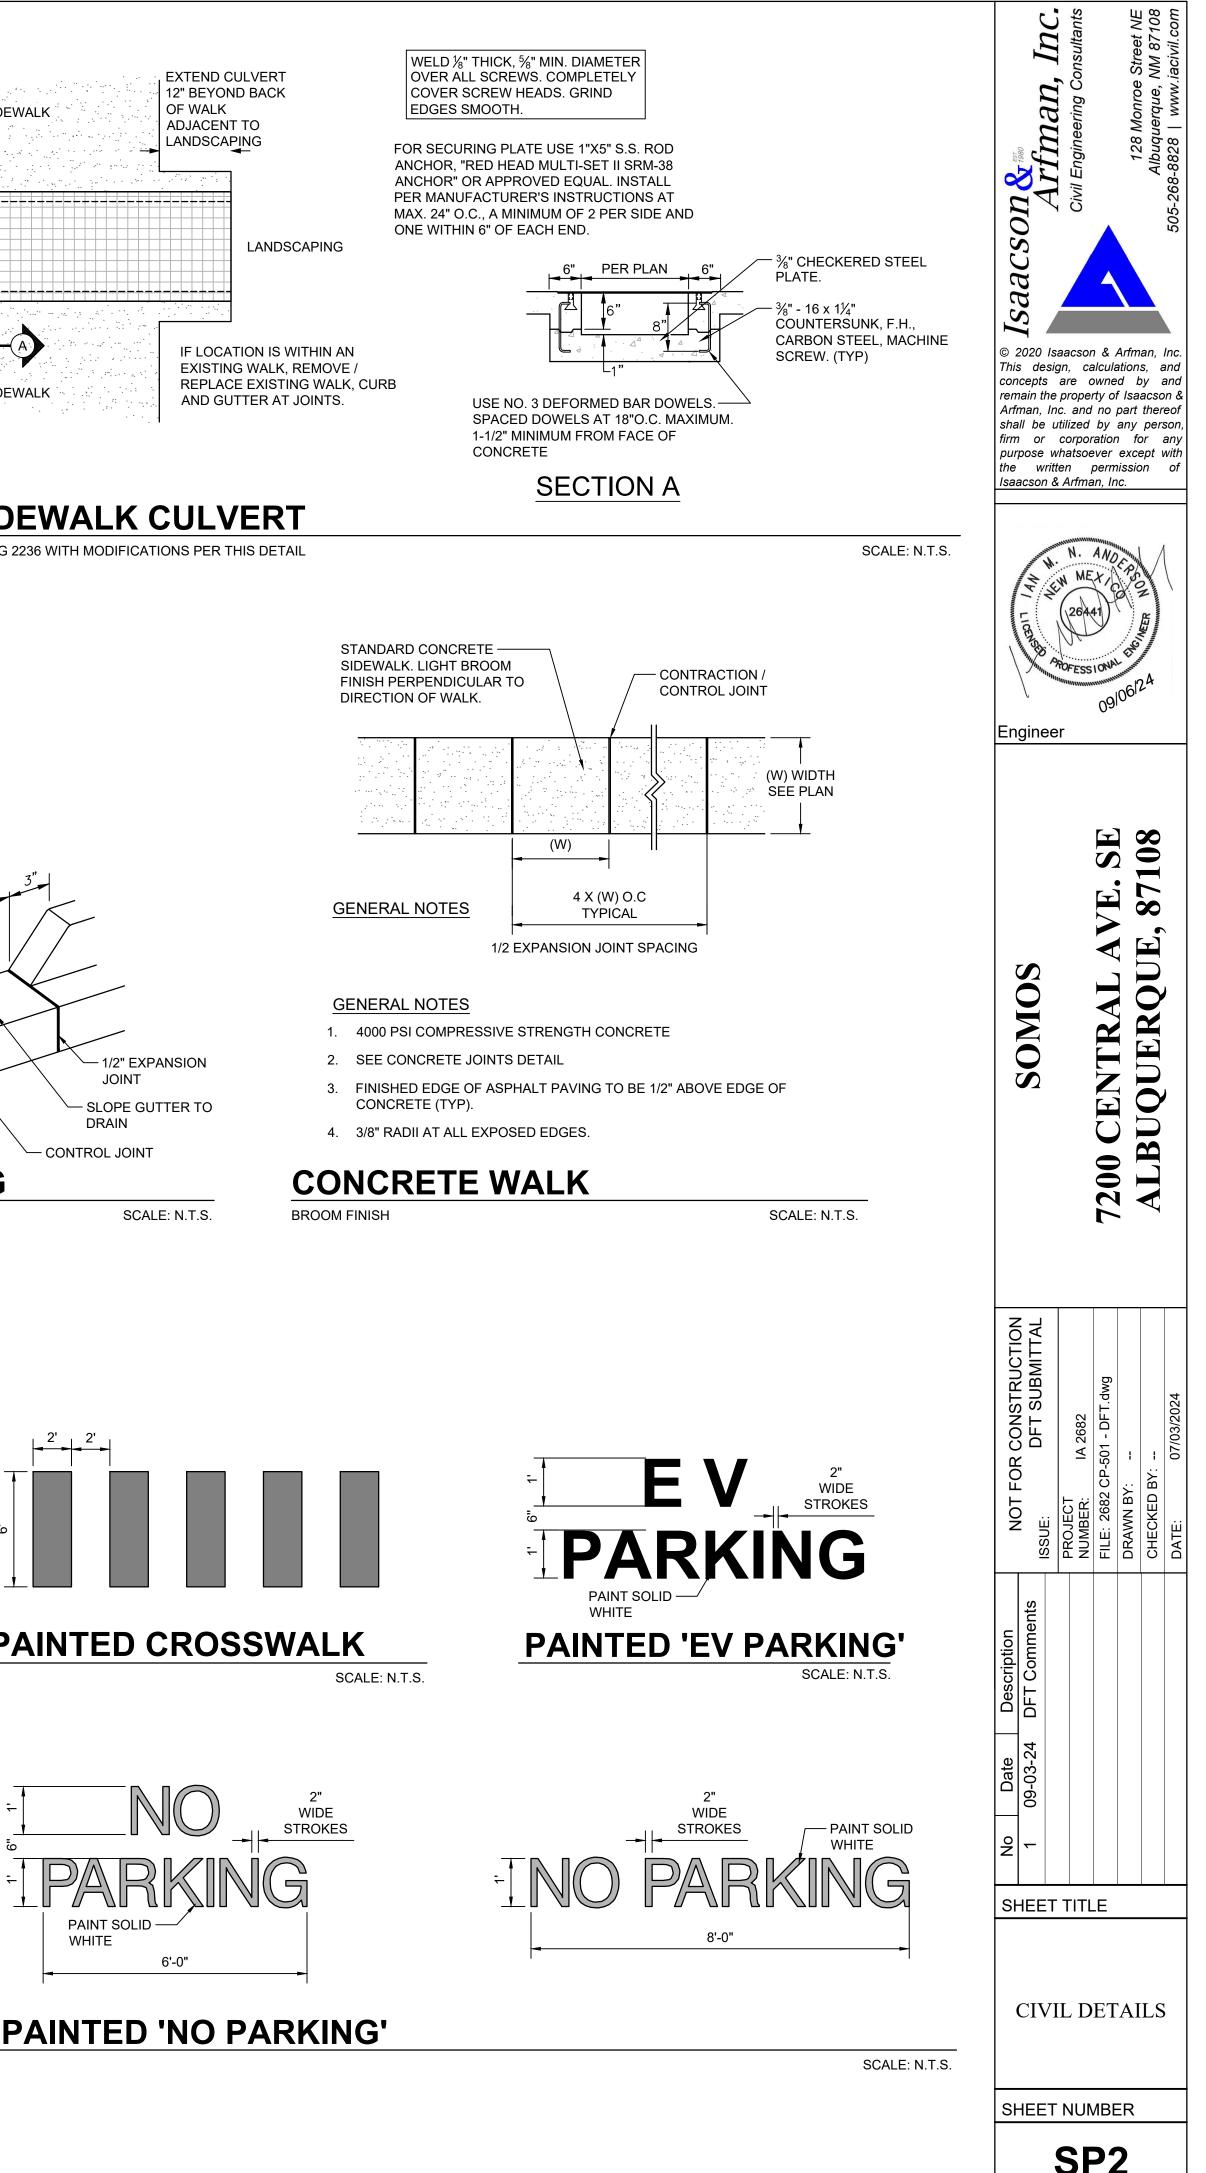



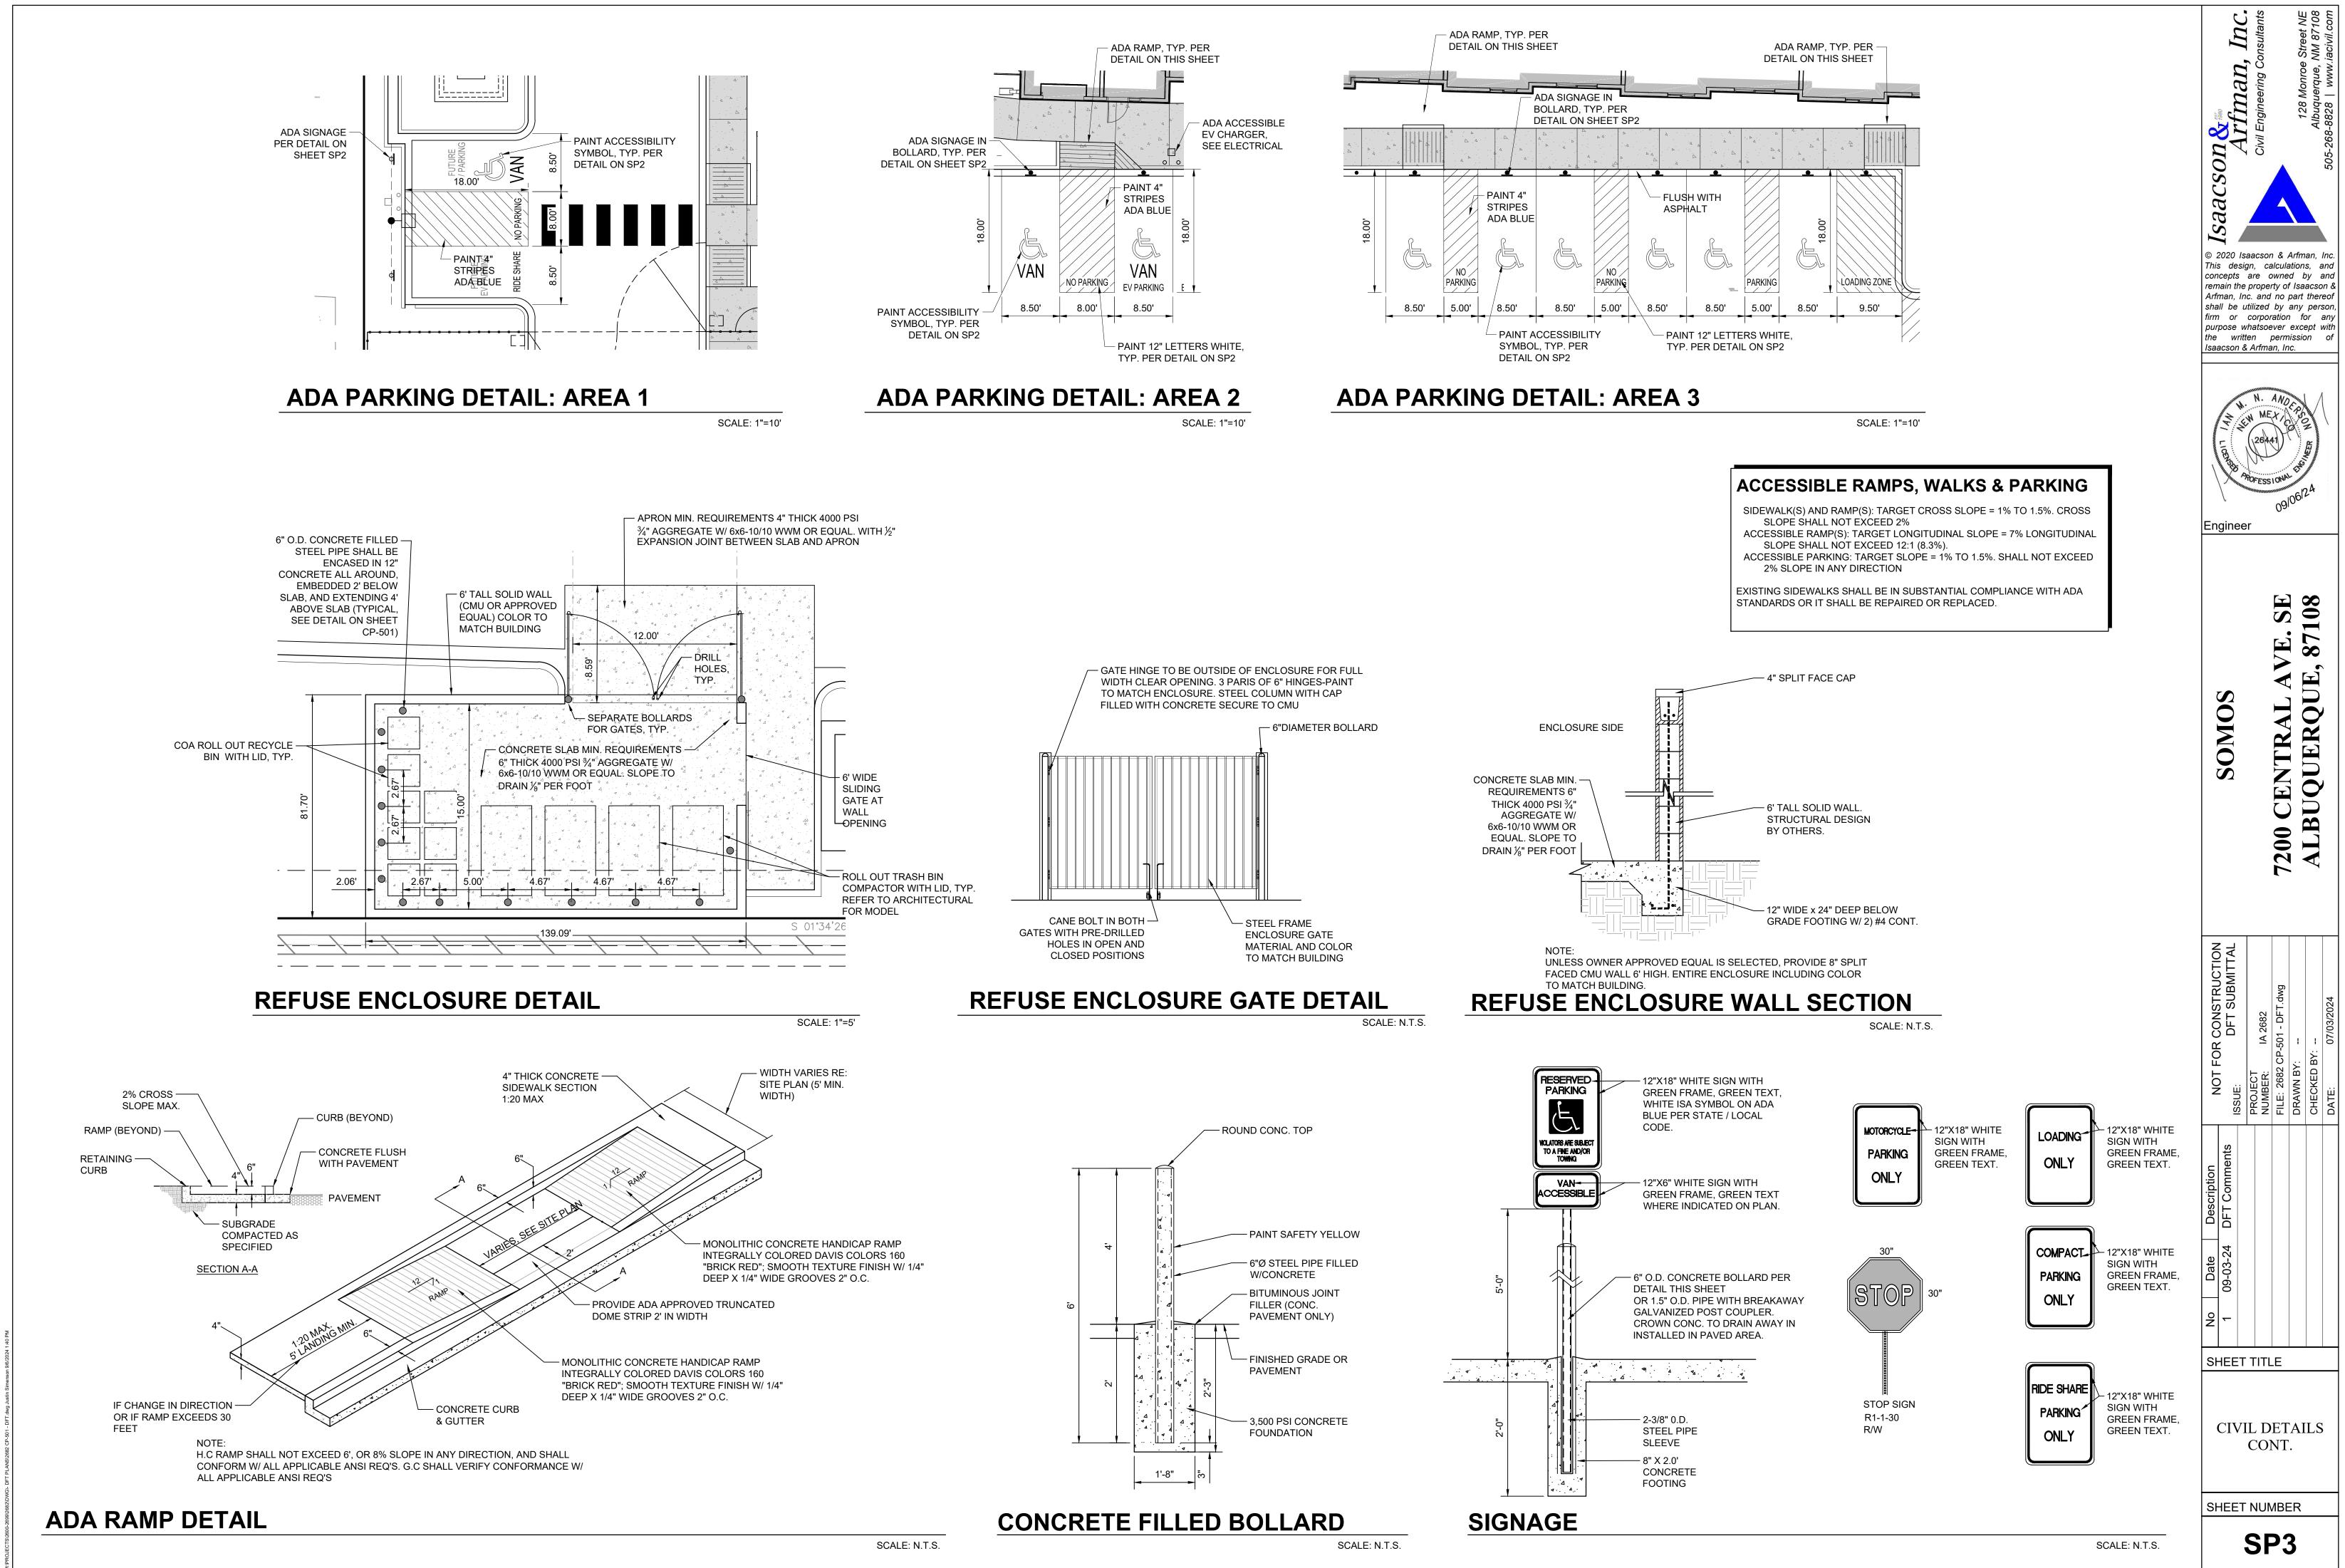

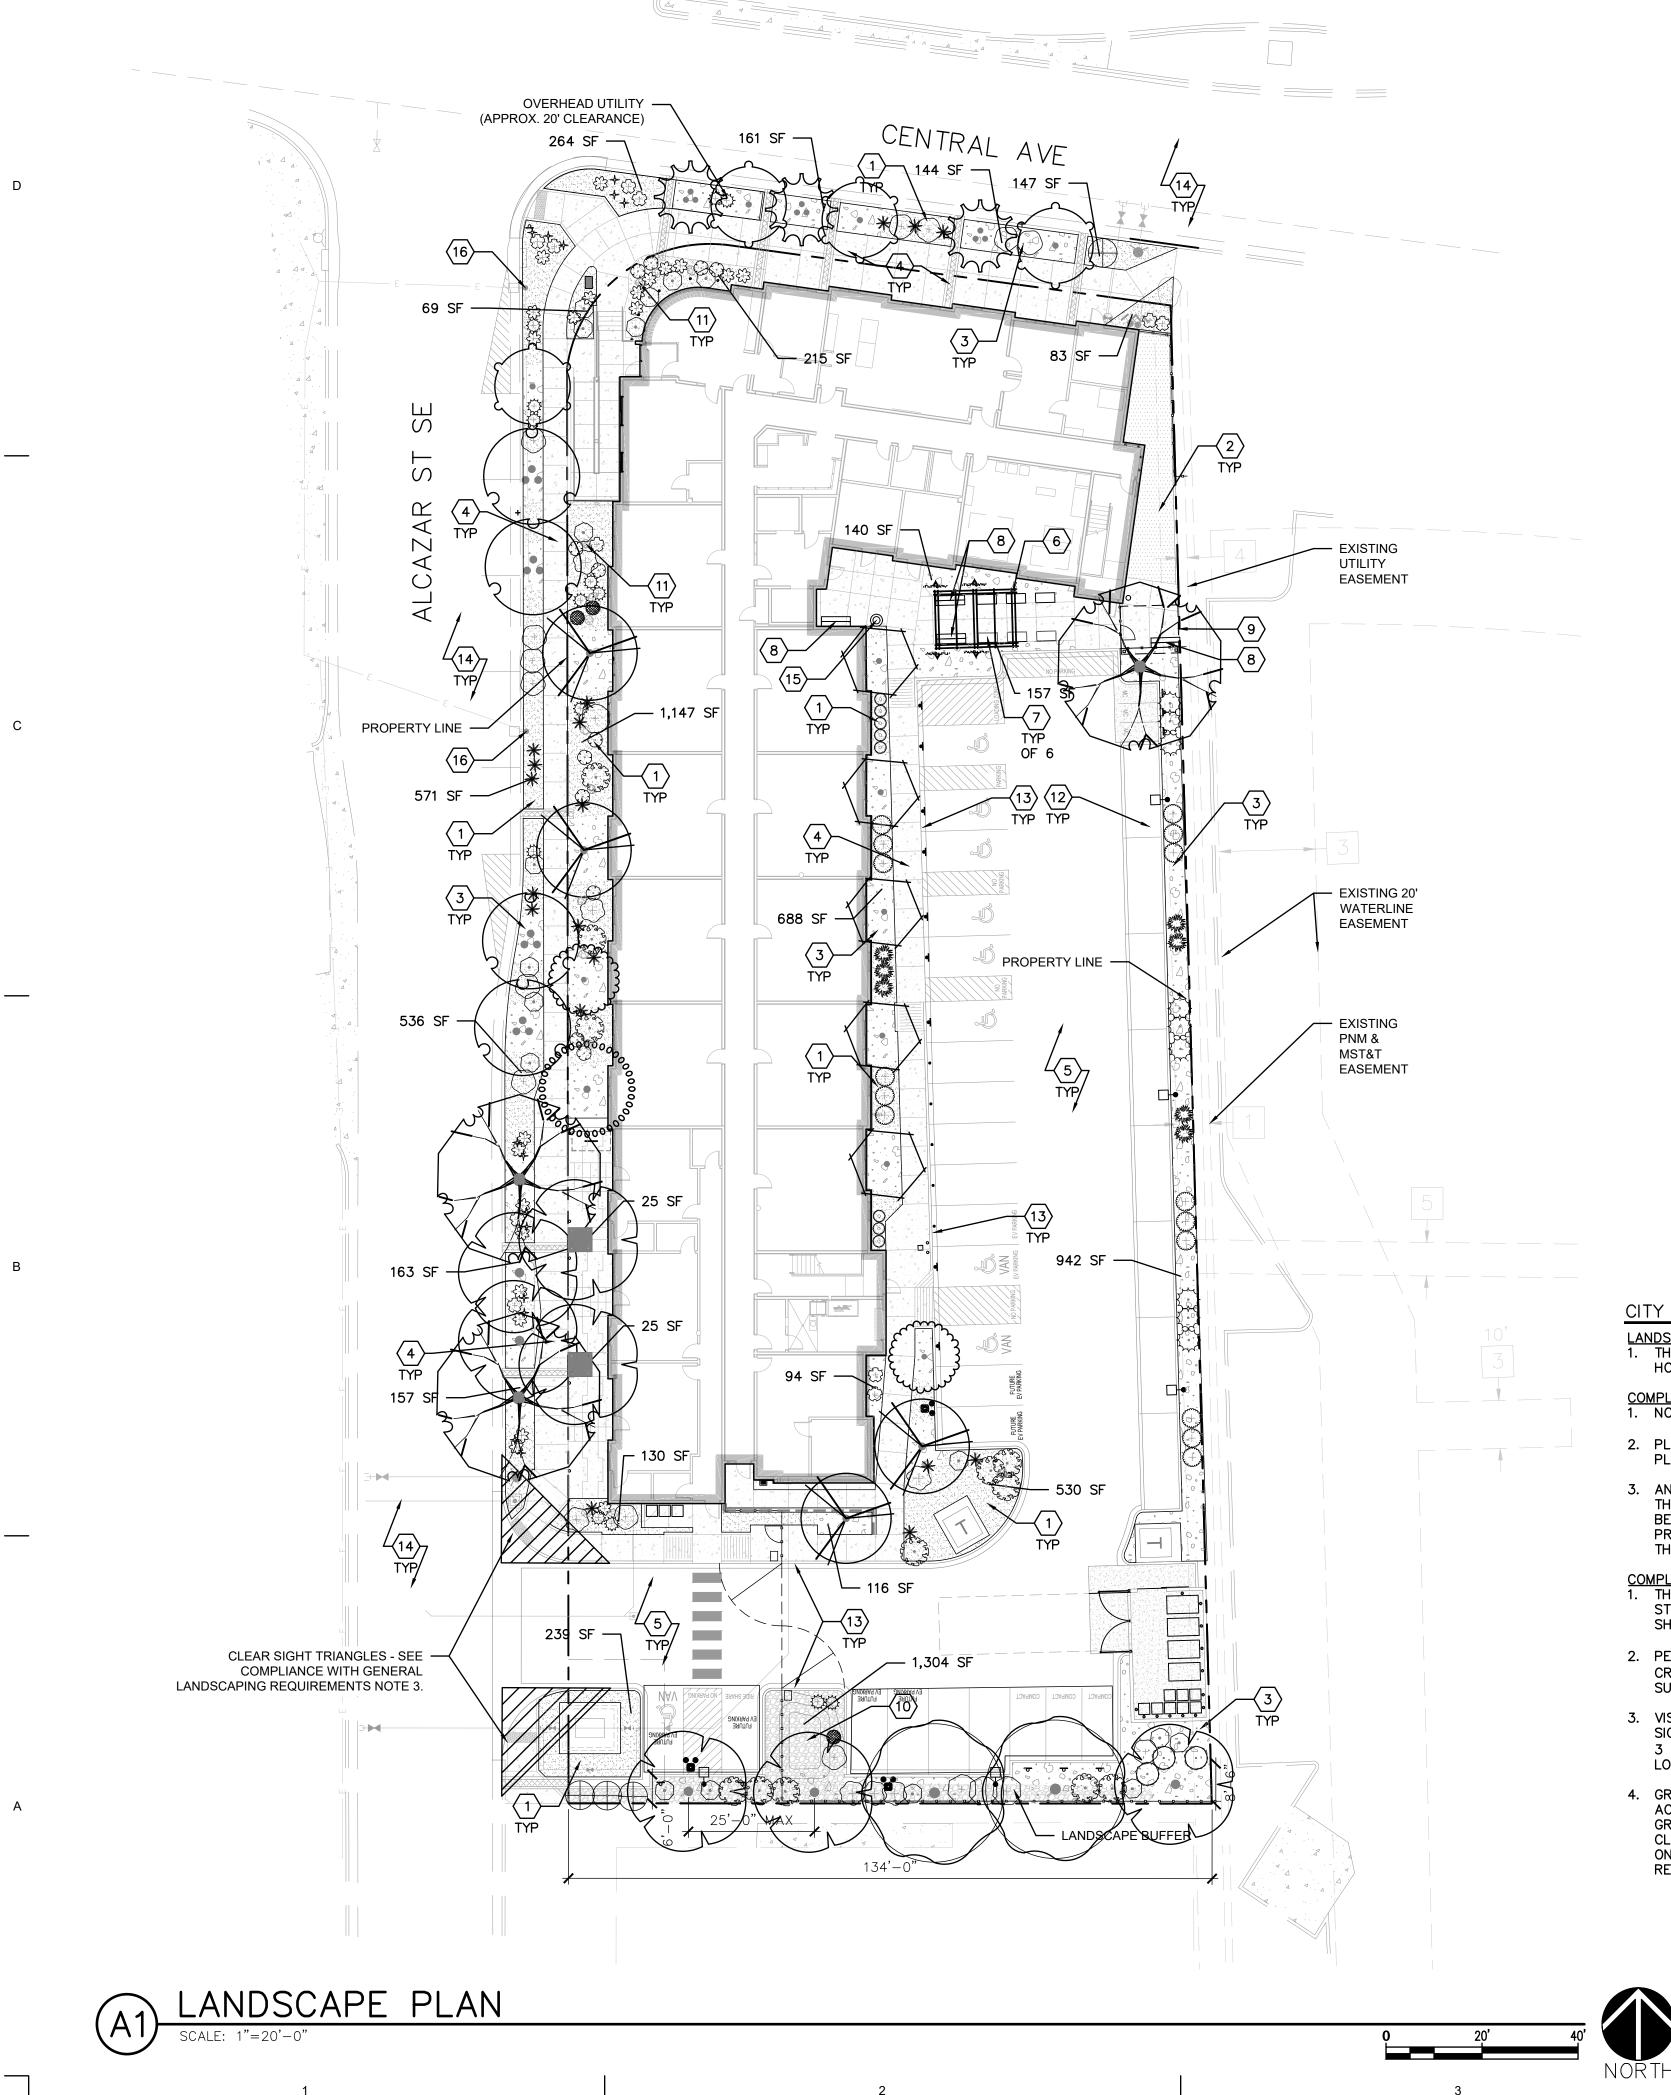

1

PLANTING KEYED NOTES

<u>CODE</u>	DESCRIPTION
1	GRAVEL MULCH
2	CRUSHER FINES N
3	ORGANIC MULCH.
4	CONCRETE SIDEW
5	ASPHALT PAVEME
6	25' LONG X12' W TRELLIS.
7	ACCESSIBLE PLAN
8	6' LONG BENCH.
9	12' LONG X 10' V
10	AREA USED FOR
11	ACCENT BOULDER
12	GRAVEL PARKING
13	CURB AND GUTTE
14	EXISTING ASPHAL
15	TRASH RECEPTAC
16	EXISTING STREET

4

CITY LANDSCAPE ORDINANCE COMPLIANCE

3

LAN	<u>DSCAPING R</u>	<u>ESPO</u>	<u> </u>	<u>ILITY F</u>	<u>OR MAI</u>	INTEN	IANCE	<u> </u>		
1.	THE OWNER	WILL	BE	RESPO	NSIBLE	FOR	ALL	LANDSCAPE	MAINTENANCE	AT SOMOS
I	HOUSING.									

COMPLIANCE WITH WATER CONSERVATION ORDINANCE: 1. NO SPRAY IRRIGATION IS PROPOSED.

- 2. PLANT SPECIES WILL BE LOW OR MEDIUM USE SPECIES PER THE ABCWUA'S XERIC PLANT LIST.
- 3. AN AUTOMATIC IRRIGATION SYSTEM WILL BE INSTALLED FOR ALL PLANT MATERIAL. THE SYSTEM WILL BE CONTROLLED BY AN AUTOMATIC CONTROLLER. PLANTS WILL BE IRRIGATED BY LOW WATER USE BUBBLERS. A REDUCED PRESSURE BACKFLOW PREVENTER WILL BE INSTALLED IN AN INTERIOR MECHANICAL ROOM TO PROTECT THE DOMESTIC WATER SUPPLY FROM CROSS-CONTAMINATION.
- COMPLIANCE WITH GENERAL LANDSCAPING REGULATIONS: 1. THIS PLAN PROVIDES VISUALLY ATTRACTIVE LANDSCAPE, A VISUALLY ATTRACTIVE STREETSCAPE, AND INTERSPERSED TREES IN LANDSCAPE AREAS TO PROVIDE SHADE AND REDUCE LARGE EXPANSES OF PAVEMENT.
- 2. PER 5-6(C)(5)(c), GROUNDCOVER MULCH SHALL COMPRISE OF A COMBINATION OF CRUSHED GRAVEL (NOT TO EXCEED 50% OF TOTAL AREA) AND ORGANIC MULCH SUCH AS SHREDDED BARK, PECAN SHELLS, ETC.
- 3. VISIBILITY, LANDSCAPING FENCING, AND SIGNS SHALL NOT INTERFERE WITH CLEAR SIGHT REQUIREMENTS. THEREFORE, SIGNS, WALLS, TREES, AND SHRUBS BETWEEN 3 AND 8 FEET IN HEIGHT (AS MEASURED FROM THE GUTTER PAN) WILL NOT BE LOCATED IN THE CLEAR SIGHT TRIANGLE.
- 4. GROUND-MOUNTED EQUIPMENT SCREENING WILL BE DESIGNED TO ALLOW FOR ACCESS TO UTILITY FACILITIES. ALL SCREENING AND VEGETATION SURROUNDING GROUND-MOUNTED TRANSFORMERS AND UTILITY PADS ARE TO ALLOW 10 FEET OF CLEARANCE IN FRONT OF THE EQUIPMENT DOOR AND 5-6 FEET OF CLEARANCE ON THE REMAINING THREE SIDES FOR SAFE OPERATION, MAINTENANCE, AND REPAIR PURPOSES.


4

MULCH,

- WALK SEE SITE PLAN. MENT – SEE SITE PLAN.
- WIDE X 8' HEIGHT WHITE METAL

NTER – 8 SF EACH.

- WIDE MONOSLOPED SHADE STRUCTURE PASSIVE WATER HARVESTING.
- R.
- PAVEMENT SEE SITE PLAN.
- TER SEE SITE PLAN.
- LT PAVEMENT.
- CLE.
- LIGHT.

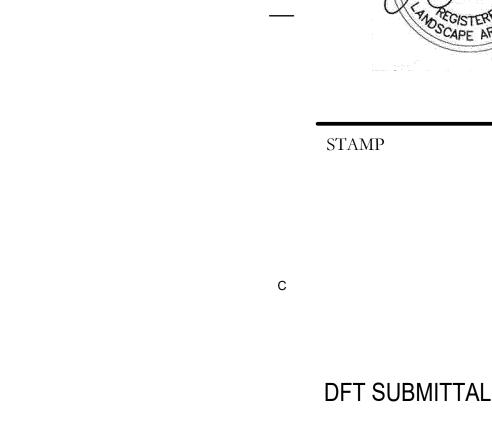



___ SOMOS

7200 CENTRAL AVE SE, ALBUQUERQUE, NEW MEXICO 87108

SOMOS APARTMENTS LIMITED PARTNERSHIP LLLP

LANDSCAPE CALCULATION TABLE: TOTAL LOT AREA: LESS TOTAL BUILDING AREA: NET LOT AREA:	41,298 SF <u>16,435 SF</u> 24,863 SF
REQUIRED LANDSCAPE AREA (10% OF NET LOT AREA): PROVIDED LANDSCAPE AREA:	2,486 SF 5,709 SF
<u>REQUIRED PLANTS:</u> REQUIRED STREET TREES: 15 (365 LF ALONG ALCAZAR ST SE, TREES AVERAGE 25' O.C.) 6 (136 LF ALONG CENTRAL AVE SE, TREES AVERAGE 25' O.C.)	PROVIDED: 15 6
NUMBER OF GROUND FLOOR* DWELLING UNITS: 10 *IN DT-UC-MS-PT AREAS, ONLY GROUND FLOOR DWELLING UNITS CALCULATE THE REQUIRED TREES NUMBER OF TREES REQUIRED (AT LEAST ONE TREE PER GROUND FLO UNITS): 10	
<u>PARKING LOT LANDSCAPE REQUIREMENTS:</u> TOTAL PARKING STALLS: TREES REQUIRED (1 TREE PER 10 PARKING STALLS) TREES PROVIDED: 15% OF TOTAL PARKING LOT AREA SHALL BE LANDSCAPED: TOTAL PARKING LOT LANDSCAPE AREA PROVIDED:	34 STALLS 4 TREES 8 TREES 1,545 SF 1,722 SF
REQUIRED COVERAGE (75% OF PROVIDED LANDSCAPE AREA): VEGETATIVE COVER REQUIRED: PROVIDED COVERAGE:	4,310 SF 4,555 SF
REQUIRED GROUND LEVEL VEGETATIVE COVERAGE (25% OF PROVIDED AREA)	LANDSCAPE
VEGETATIVE GROUNDCOVER REQUIRED: PROVIDED GROUND LEVEL PLANT COVERAGE:	1,437 SF 1,892 SF
ORGANIC MULCH GROUNDCOVER (50% OF LANDSCAPE AREA): REQUIRED ORGANIC MULCH GROUNDCOVER: PROVIDED ORGANIC MULCH GROUNDCOVER:	2,855 SF 2,857 SF

REVISIO	\mathcal{N}

09/20/24	DFT COMMENTS
09/03/24	DFT COMMENTS
DATE	DESCRIPTION
	09/03/24

Copyright: Design Group

Drawn by	KA
Checked by	GM
Date	AUGUST 12TH, 2024
Project number	2735

SHEET TITLE

Α



SHEET NUMBER

SP6




CONSULTANT

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	1	 Plan1	T SCH		2 11 F		3				GENEF	RAL PLANTING NOTES
		F LAN									CODE	DESCRIPTION
		<u>SYMBOL</u> <u>TREES</u>	<u>CODE</u>	<u>QTY</u>	COMMON NAME	BOTANICAL NAME	<u>REMARKS</u>	<u>HT.</u>	<u>SPD.</u>	INSTALLED SIZE	GP-01	IN CASE OF DISCREPANCY IN PLANT QUANTITIES SHOW QUANTITIES SHOWN ON THE PLAN SHALL GOVERN. CON ADDITIONAL PAYMENT WILL BE MADE FOR ANY DISCREP
			во	2	BURR OAK	QUERCUS MACROCARPA	В&В	60'	35'	2" CAL., 10'–12' HT.	GP-02	FILTER FABRIC SHALL BE MIN. 4 OZ. NON-WOVEN NEEL TURN DOWN EDGES 6"
		jug									GP-03	THE TOP OF MULCH SHALL BE 1" BELOW TOP OF ADJA
			VC	3	CHASTE TREE	VITEX AGNUS-CASTUS	24" BOX, MULTI-TRUNK	15`	15՝	MIN. 6' HT.	GP-04	CONTRACTOR SHALL PRUNE LOWER BRANCHES OF DECI
D		()	PC	7	CHINESE PISTACHE	PISTACIA CHINENSIS	30" BOX	35'	30'	2" CAL., 12'–14' HT.	GP-05	TREES SHALL BE INSTALLED PER DETAIL A4/LP501.
	$\overline{1}$	Le la	10	,				00	50		GP-06 GP-07	SHRUBS SHALL BE INSTALLED PER DETAIL B4/LP501. IF THERE IS A DISCREPANCY IN THE FIELD OR NURSER
			CL2	4	DESERT WILLOW	CHILOPSIS LINEARIS	24" BOX	20'	20'	5'– 7' HT., MS		SPREAD CALLED OUT UNDER "SIZE", THE SPECIFIED PLAEVEN IF A LARGER CONTAINER SIZE IS REQUIRED TO M
		AND RU	UP	.3	LACEBARK ELM	ULMUS PARVIFOLIA	24" BOX	40'	40'	2.5" CAL.	GP-08 GP-09	TREES AND SHRUBS SHALL BE INSTALLED PER SPECIFIC
			01	0				40	40	2.0 0/L.	GP-09 GP-10	VINES SHALL BE INSTALLED PER DETAIL $B6/LP501$. PER 5-6(C)(4)(G), ALL VEGETATION SHALL COMPLY WI
			FN	2	NEW MEXICO OLIVE	FORESTIERA NEOMEXICANA	24" BOX	15'	15ʻ	2" CAL. 6'–8' HT.		CONTROL, WATER CONSERVATION LANDSCAPING AND WA BERNALILLO COUNTY WATER AUTHORITY (ABCWUA) LEGI APPLICABLE.
			C02	5	OKLAHOMA TEXAS REDBUD	CERCIS CANADENSIS TEXENSIS 'OKLAHOMA'	24" BOX	15'	15'	2" CAL. 6'–8' HT.	GP-11	PER 5–6(C)(4)(H), ALL REQUIRED PLANT MATERIALS SH AMERICAN STANDARD FOR NURSERY STOCK (ASNA) OF
		ومسكم	CP	4	PINK POM POMS FASTERN REDBUD	CERCIS CANADENSIS 'PINK POM POMS'	24" BOX	12՝	20'	2" CAL. 6'–8' HT.	GP-12	PER 5–6(C)(5)(A), ALL VEGETATED MATERIAL REQUIRED PLEASE ADD A NOTE TO THE LANDSCAPE PLAN GENER
		- N ⁰⁰⁰⁰⁰⁰ -	01	·				12	20		GP-13	PER 5–6(C)(5)(B), IF USED, WEED BARRIERS SHALL BE
		0,000000	SB	1	SENSATION BOX ELDER	ACER NEGUNDO 'SENSATION'	B&B	30'	20'	2" CAL., 10'–12' HT.	GP-14	PER 5-6(C)(5)(D), A MINIMUM OF 2 INCHES OF ORGAN RECOMMENDED.
		20000000000000000000000000000000000000									GP-15	5-6(C)(9)(A) ALL PLANTING OF VEGETATED MATERIAL
			WH	4	WESTERN HACKBERRY	CELTIS OCCIDENTALIS	30" BOX	30'	20'	2" CAL, 12'–14' HT.		THE PUBLIC RIGHT-OF WAY SHALL REQUIRE THE PRIOR THE MAINTENANCE, REPAIRS, OR LIABILITY FOR ALL THI
	$\frac{\bigcirc}{1. \text{ VINE} - \text{ SEE PLAN FOR SPECIES AND LOCATION.}}$	SHRUBS									GP-16	PER 5–6(C)(9)(B) ANY TREES THAT OVERHANG A PUB AN 8–FOOT CLEARANCE OVER THE SIDEWALK. ANY TRE 9–FOOT CLEARANCE OVER THE STREET SURFACE.
С	2. VERTICAL STRUCTURE – SEE PLAN. 3. PLANT AT SAME DEPTH AS MAINTAINED AT		FP	4	APACHE PLUME	FALLUGIA PARADOXA	5 GAL.	6'	6ʻ	MIN. 18" SPD.	GP-17	PER $5-6(C)(9)(C)$, WHERE LANDSCAPING IS INSTALLED
	NURSERY. 4. MULCH – SEE PLAN. HOLD BACK 2" FROM VINE STEMS.	\bigcirc	ВМ	3	BLUE MIST SPIREA	CARYOPTERIS X CLANDONENSIS	5 GAL.	5'	5'	MIN. 12" HT.		IRRIGATION SYSTEM THAT MEETS THE MINIMUM TECHNIC LANDSCAPING) AND THE DPM, WITH A SEPARATE METER
	5. EARTHEN BERM, 6" HEIGHT 6. BACKFILL AND SOIL AMENDMENTS – SEE		HB	14	BRAKELIGHTS®RED YUCCA	HESPERALOE PARVIFLORA 'PERPA'	3 GAL.	2'	2'	MIN. 6"HT.		VALVE(S) AT THE PROPERTY LINE ALLOWING ISOLATION DRIP IRRIGATION SYSTEMS AND ARTIFICIAL TURF SHALL
	SPECIFICATIONS. MIX THOROUGHLY PRIOR TO INSTALLATION.		CAT	14	CATMINT	NEPETA FAASSENII	1 GAL.	1՝	3'	MIN. 6" SPD.	GP-18	PER 5-6(C)(14)(A), IRRIGATION SYSTEMS SHALL COMPL CONNECTION PREVENTION AND CONTROL ORDINANCE).
	 SCARIFY EDGE OF PLANTING HOLE, CONTINUOUS ALL SIDES. UNDISTURBED SUBGRADE 	$\left(+ \right)$	EN	4	CHAMISA	ERICAMERIA NAUSEOSA	5 GAL.	5'	6'	MIN. 8"HT.	GP-19	PER 5-6(C)(14)(B), ALL IRRIGATION SYSTEMS SHALL BI
			CSC	13	CREEPING SAND CHERRY	PRUNUS BESSEYI 'PAWNEE BUTTES'	5 GAL.	2'	5'	MIN. 18" SPD.	GP-20	5-6(C)(14)(C), ALL NON-RESIDENTIAL LANDSCAPE IRRIG
	(C1) VINE PLANTING		LA	8	ENGLISH LAVENDER	LAVANDULA ANGUSTIFOLIA	1 GAL.	3'	3'	MIN. 12" HT.	GP-21	AVOID OVERWATERING. PER 5-6(C)(14)(D), THE IRRIGATION SYSTEM SHALL NO
			CM2		FERNBUSH	CHAMAEBATIARIA MILLEFOLIUM	5 GAL.	6'	6ʻ	MIN. 18" SPD.	Gr-21	DRIVEWAYS, DRIVE AISLES, STREETS, AND PARKING AND
	_	ANNIA	VS		FLAME SEEDLESS TABLE GRAPE	VITIS VINIFERA 'FLAME SEEDLESS'	5 GAL.	15'	15'	MIN. 12" HT.	GP-22	5-6(C)(15)(C) ANY DAMAGE TO UTILITY LINES RESULTIN PROPERTY OWNER'S AGENTS OR EMPLOYEES IN THE INS
			RG		GOLDEN CURRANT	RIBES AUREUM	3 GAL.	4' _:	4` _•	MIN. 12" HT.		BUFFERING IN A PUBLIC RIGHT-OF-WAY, PRIVATE WAY, DAMAGE TO UTILITY LINES RESULTING FROM THE GROW PUBLIC UTILITY AS PART OF A PLAN FOR LANDSCAPING
			GLS		GRO-LOW SUMAC	RHUS AROMATICA 'GRO-LOW'	5 GAL.	3'	5	MIN. 18" SPD.		RESPONSIBILITY OF SUCH PUBLIC UTILITY. IF A PUBLIC RIGHT-OF-WAY, PRIVATE WAY, OR EASEMENT, IT SHALI
		June (RI		INDIAN HAWTHORN MORMON TEA	RHAPHIOLEPIS INDICA EPHEDRA VIRIDIS	5 GAL. 5 GAL.	3	4	MIN. 12" HT.		AND RETURN THEM TO THEIR PRIOR LOCATIONS AFTER THE OBLIGATION OF THE ABUTTING PROPERTY OWNER 1
			EV NWR		NEARLY WILD ROSE	ROSA 'NEARLY WILD'	5 GAL.		5` 3`	MIN. 12" SPD. MIN. 12" HT.	GP-23	5-6(C)(15)(D) PROPERTY OWNERS ACKNOWLEDGE THAT RIGHT-OF-WAY, PRIVATE WAY, OR EASEMENT ABUTTING
	SURVER IL		RD		PINK DOUBLE KNOCK OUT®ROSE	ROSA X 'RADTKOPINK'	3 GAL.		3 3'	MIN. 12 HT.		CITY RESERVES THE RIGHT TO REMOVE THEM IF NECES COST TO THE PROPERTY OWNER. LANDSCAPING INSTALL
			PS		PRARIE SAGE	ARTEMISIA LUDOVICIANA	5 GAL.		3	MIN. 12" HT.		PROPERTY OWNERS AND LATER REMOVED BY THE CITY REQUIRED LANDSCAPING.
в		£+	SU		ROSEMARY	SALVIA ROSMARINUS	3 GAL.		5	MIN 18" HT	GP-24	5–13(B)(7)(A) LANDSCAPING, SCREENING AND BUFFERIN OF ROA 1994 (TREES, VEGETATION, AND LANDSCAPING
								-	-			BERNALILLO COUNTY WATER AUTHORITY (ABCWUA) LEGI
		GRASSES	SN	3	INDIAN GRASS	SORGHASTRUM NUTANS	3 GAL.	4'	3'	MIN. 12" HT.	GP-25	5-13(B)(7)(B) ALL LANDSCAPED AREAS SHALL BE MAI REMOVAL AND REPLACEMENT OF DEAD OR DISEASED PL SURFACE AREAS, AND UPKEEP OF IRRIGATION SYSTEMS
			CCENTS	,							GP-26	5-13(B)(7)(D) WHERE LANDSCAPING WAS INSTALLED PU
		×	RY	-	RED YUCCA	HESPERALOE PARVIFLORA	5 GAL.	3'	3'	MIN. 12" HT.		SHALL BE REPLACED ACCORDING TO ANY LANDSCAPING
		- v									GP-27	5–13(B)(7)(E) TREES OR PLANTS THAT DIE SHALL BE LONGER THAN 60 CALENDAR DAYS AFTER NOTICE FROM THE PROPERTY OWNER.
A	 S' RADIUS AROUND TRUNK SE PLAN FOR SPECIES AND LOCATION. TREE - SEE PLAN FOR SPECIES AND LOCATION. TREE - SEE PLAN FOR SPECIES AND LOCATION. REMOVE EXISTING SOIL FROM NURSERY AS NEEDED TO EXPOSE ROOT INSTALL WITH ROOT FLARE 2"-3" ABOVE GRADE. PLACE TREE IN HOLE AND STRAIGHTEN. REMOVE WIRE BASKET, WOOD TWINE AND/OR ROPE, AND BURLAP PRIOR TO BACKFILL. AVOID MULCH INSTALLATION 4"-6" FROM TREE TRUNK. ORGANIC MULCH. THOROUGHLY MIX BACKFILL AND SOIL AMENDMENTS PRIOR TO INSTALL SPECIFICATIONS. SCARIFY EDGE OF PLANTING HOLE, CONTINUOUS ALL SIDES. UNDISTURBED SUBGRADE 	BOX, PLASTIC,	1. S 2. P 3. F 4. G 5. S 6. T	SHRUB - PLANT A FEATHER FROM SHI GRAVEL M SCARIFY THOROUG SEE SPEC	1 (2 (3 (3 (3) (12") (12	NURSERY. F ROOT BALL AND HOLD BACK 2" DUS ALL SIDES.					GP-28	5–13(B)(7)(F) STREET TREES SHALL BE MAINTAINED AI TREES PLANTED IN THE PUBLIC RIGHT-OF-WAY ARE TH
	A1 NOT TO SCALE		(A)		TTO SCALE							
-	1				2		2					A

ALIVE AND HEALTHY. MAINTAINING AND REPLACING STREET TREES OR OTHER THE RESPONSIBILITY OF ABUTTING PROPERTY OWNERS.

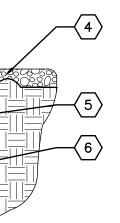

3

4

HOWN ON THE PLANT LEGEND AND THOSE SHOWN ON THE PLANTING PLAN, THE CONTRACTOR SHALL VERIFY ALL QUANTITIES PRIOR TO BID AND INSTALLATION. NO CREPANCIES IN QUANTITIES BETWEEN THE PLANTING PLAN AND THE PLANT LIST.

NEEDLE-PUNCHED POLYPROPYLENE (MIRAFI OR EQUIVALENT). OVERLAP ENDS 3" AND

ADJACENT CONCRETE SURFACES.

DECIDUOUS TREES AS DIRECTED BY LANDSCAPE ARCHITECT IN THE FIELD.

D1.

SERY BETWEEN THE CONTAINER SIZE CALLED OUT UNDER "REMARKS" AND HEIGHT & PLANT MUST MEET HEIGHT & SPREAD REQUIREMENTS SPECIFIED UNDER "SIZE", TO MEET THESE SPECIFICATIONS, AT NO ADDITIONAL COST TO THE OWNER. ECIFICATION SECTION 329300 - PLANTS.

WITH ARTICLE 9-12 AND PARTS 6-1-1 AND 6- 6-2 OF ROA 1994 (POLLEN WATER WASTE, AND STREET TREES) AND SECTION 4 OF THE ALBUQUERQUE LEGISLATION AND ORDINANCES (WATER WASTE REDUCTION ORDINANCE) AS

S SHALL BE FREE OF DISEASE AND INSECTS AND SHALL CONFORM TO THE OF THE AMERICAN NURSERY AND LANDSCAPE ASSOCIATION.

JIRED BY THIS SECTION 14-16-5-6 SHALL BE PLANTED IN UNCOMPACTED SOIL. NERAL NOTES TO REFLECT THIS CODE

. BE PERMEABLE TO OPTIMIZE STORMWATER INFILTRATION AND PREVENT RUNOFF.

CANIC MULCH IS REQUIRED IN ALL PLANTING AREAS, WITH 3-4 INCHES

IAL OR INSTALLATION OF ANY LANDSCAPING, BUFFERING, OR SCREENING MATERIAL IN RIOR APPROVAL OF THE CITY. THE PROPERTY OWNER SHALL BE RESPONSIBLE FOR THE LANDSCAPING PLACED IN OR OVER THE PUBLIC RIGHT-OF WAY.

PUBLIC SIDEWALK OR MAJOR PUBLIC OPEN SPACE SHALL BE TRIMMED TO MAINTAIN TREES THAT OVERHANG A PUBLIC STREET SHALL BE TRIMMED TO MAINTAIN A

LED IN THE PUBLIC RIGHT-OF-WAY, THE APPLICANT SHALL INSTALL AN ADEQUATE C HNICAL REQUIREMENTS IN ARTICLE 6-6 OF ROA 1994 (TREES, VEGETATION AND IETER FOR THE LANDSCAPE AREA IN THE PUBLIC RIGHT-OF-WAY, OR A SEPARATE TION OF THE IRRIGATION TO THE LANDSCAPE WITHIN THE PUBLIC RIGHT-OF-WAY. HALL NOT BE ALLOWED WITHIN THE PUBLIC RIGHT-OF-WAY.

MPLY WITH SECTION 8 OF THE ABCWUA LEGISLATION AND ORDINANCES (CROSS

. BE DESIGNED TO MINIMIZE THE USE OF WATER.

IRRIGATION SHALL HAVE AUTOMATIC TIMERS AND/OR PROGRAMMABLE SETTINGS TO

. NOT SPRAY OR IRRIGATE IMPERVIOUS SURFACES, INCLUDING SIDEWALKS, AND LOADING AREAS.

JLTING FROM THE NEGLIGENCE OF THE ABUTTING PROPERTY OWNER OR THE _____ INSTALLATION AND MAINTENANCE OF ANY LANDSCAPING, SCREENING, OR WAY, OR EASEMENT SHALL BE THE RESPONSIBILITY OF SUCH PROPERTY OWNER. ANY ROWTH OF PLANT MATERIALS THAT HAVE BEEN APPROVED BY THE APPLICABLE APING, SCREENING, OR BUFFERING ON THE PUBLIC RIGHT OF WAY SHALL BE THE BLIC UTILITY DISTURBS LANDSCAPING, SCREENING, OR BUFFERING IN A PUBLIC HALL MAKE EVERY REASONABLE EFFORT TO PRESERVE THE LANDSCAPING MATERIALS TER THE UTILITY WORK. IF THE PLANT MATERIALS DIE DESPITE THOSE EFFORTS, IT IS ER TO REPLACE THE PLANT MATERIALS.

HAT APPROVED LANDSCAPING AND TREES INSTALLED AND MAINTAINED IN A PUBLIC TTING PRIVATE PROPERTIES ARE THE PROPERTY OF THE CITY, AND THAT THAT THE CESSARY FOR A TRANSPORTATION PROJECT WITHOUT COMPENSATION, BUT AT NO TALLED IN AN ABUTTING PUBLIC RIGHT-OF-WAY, PRIVATE WAY, OR EASEMENT BY CITY SHALL NOT IMPACT PREVIOUSLY APPROVED NET LOT AREA CALCULATIONS FOR

FERING AREAS SHALL BE MAINTAINED IN COMPLIANCE WITH ARTICLES 6-6 AND 9-8 PING AND WEEDS, LITTER, AND SNOW) AND SECTION 4 OF THE ALBUQUERQUE LEGISLATION AND ORDINANCES (WATER WASTE REDUCTION ORDINANCE).

MAINTAINED WITH A NEAT AND ORDERLY APPEARANCE, WHICH INCLUDES PRUNING, ED PLANTS AND TREES, DISPOSAL OF LITTER, REPAIR OF DAMAGED WALLS AND HARD TEMS.

PURSUANT TO A SITE PLAN OR DEVELOPMENT APPROVAL, THE LANDSCAPING PING AND MAINTENANCE PLAN UNDER THAT APPROVAL.

BE REPLACED BY THE OWNER AS EXPEDITIOUSLY AS POSSIBLE, BUT IN NO CASE FROM THE CITY. THE REPLACEMENT OF DEAD VEGETATION IS THE RESPONSIBILITY OF



CONSULTANT

D



STAMP

DFT SUBMITTAL

PROJECT NAME

SOMOS

7200 CENTRAL AVE SE, ALBUQUERQUE, NEW MEXICO 87108

SOMOS APARTMENTS LIMITED PARTNERSHIP LLLP

REVISIONS


02	09/20/24	DFT COMMENTS
01	09/03/24	DFT COMMENTS
NO.	DATE	DESCRIPTION

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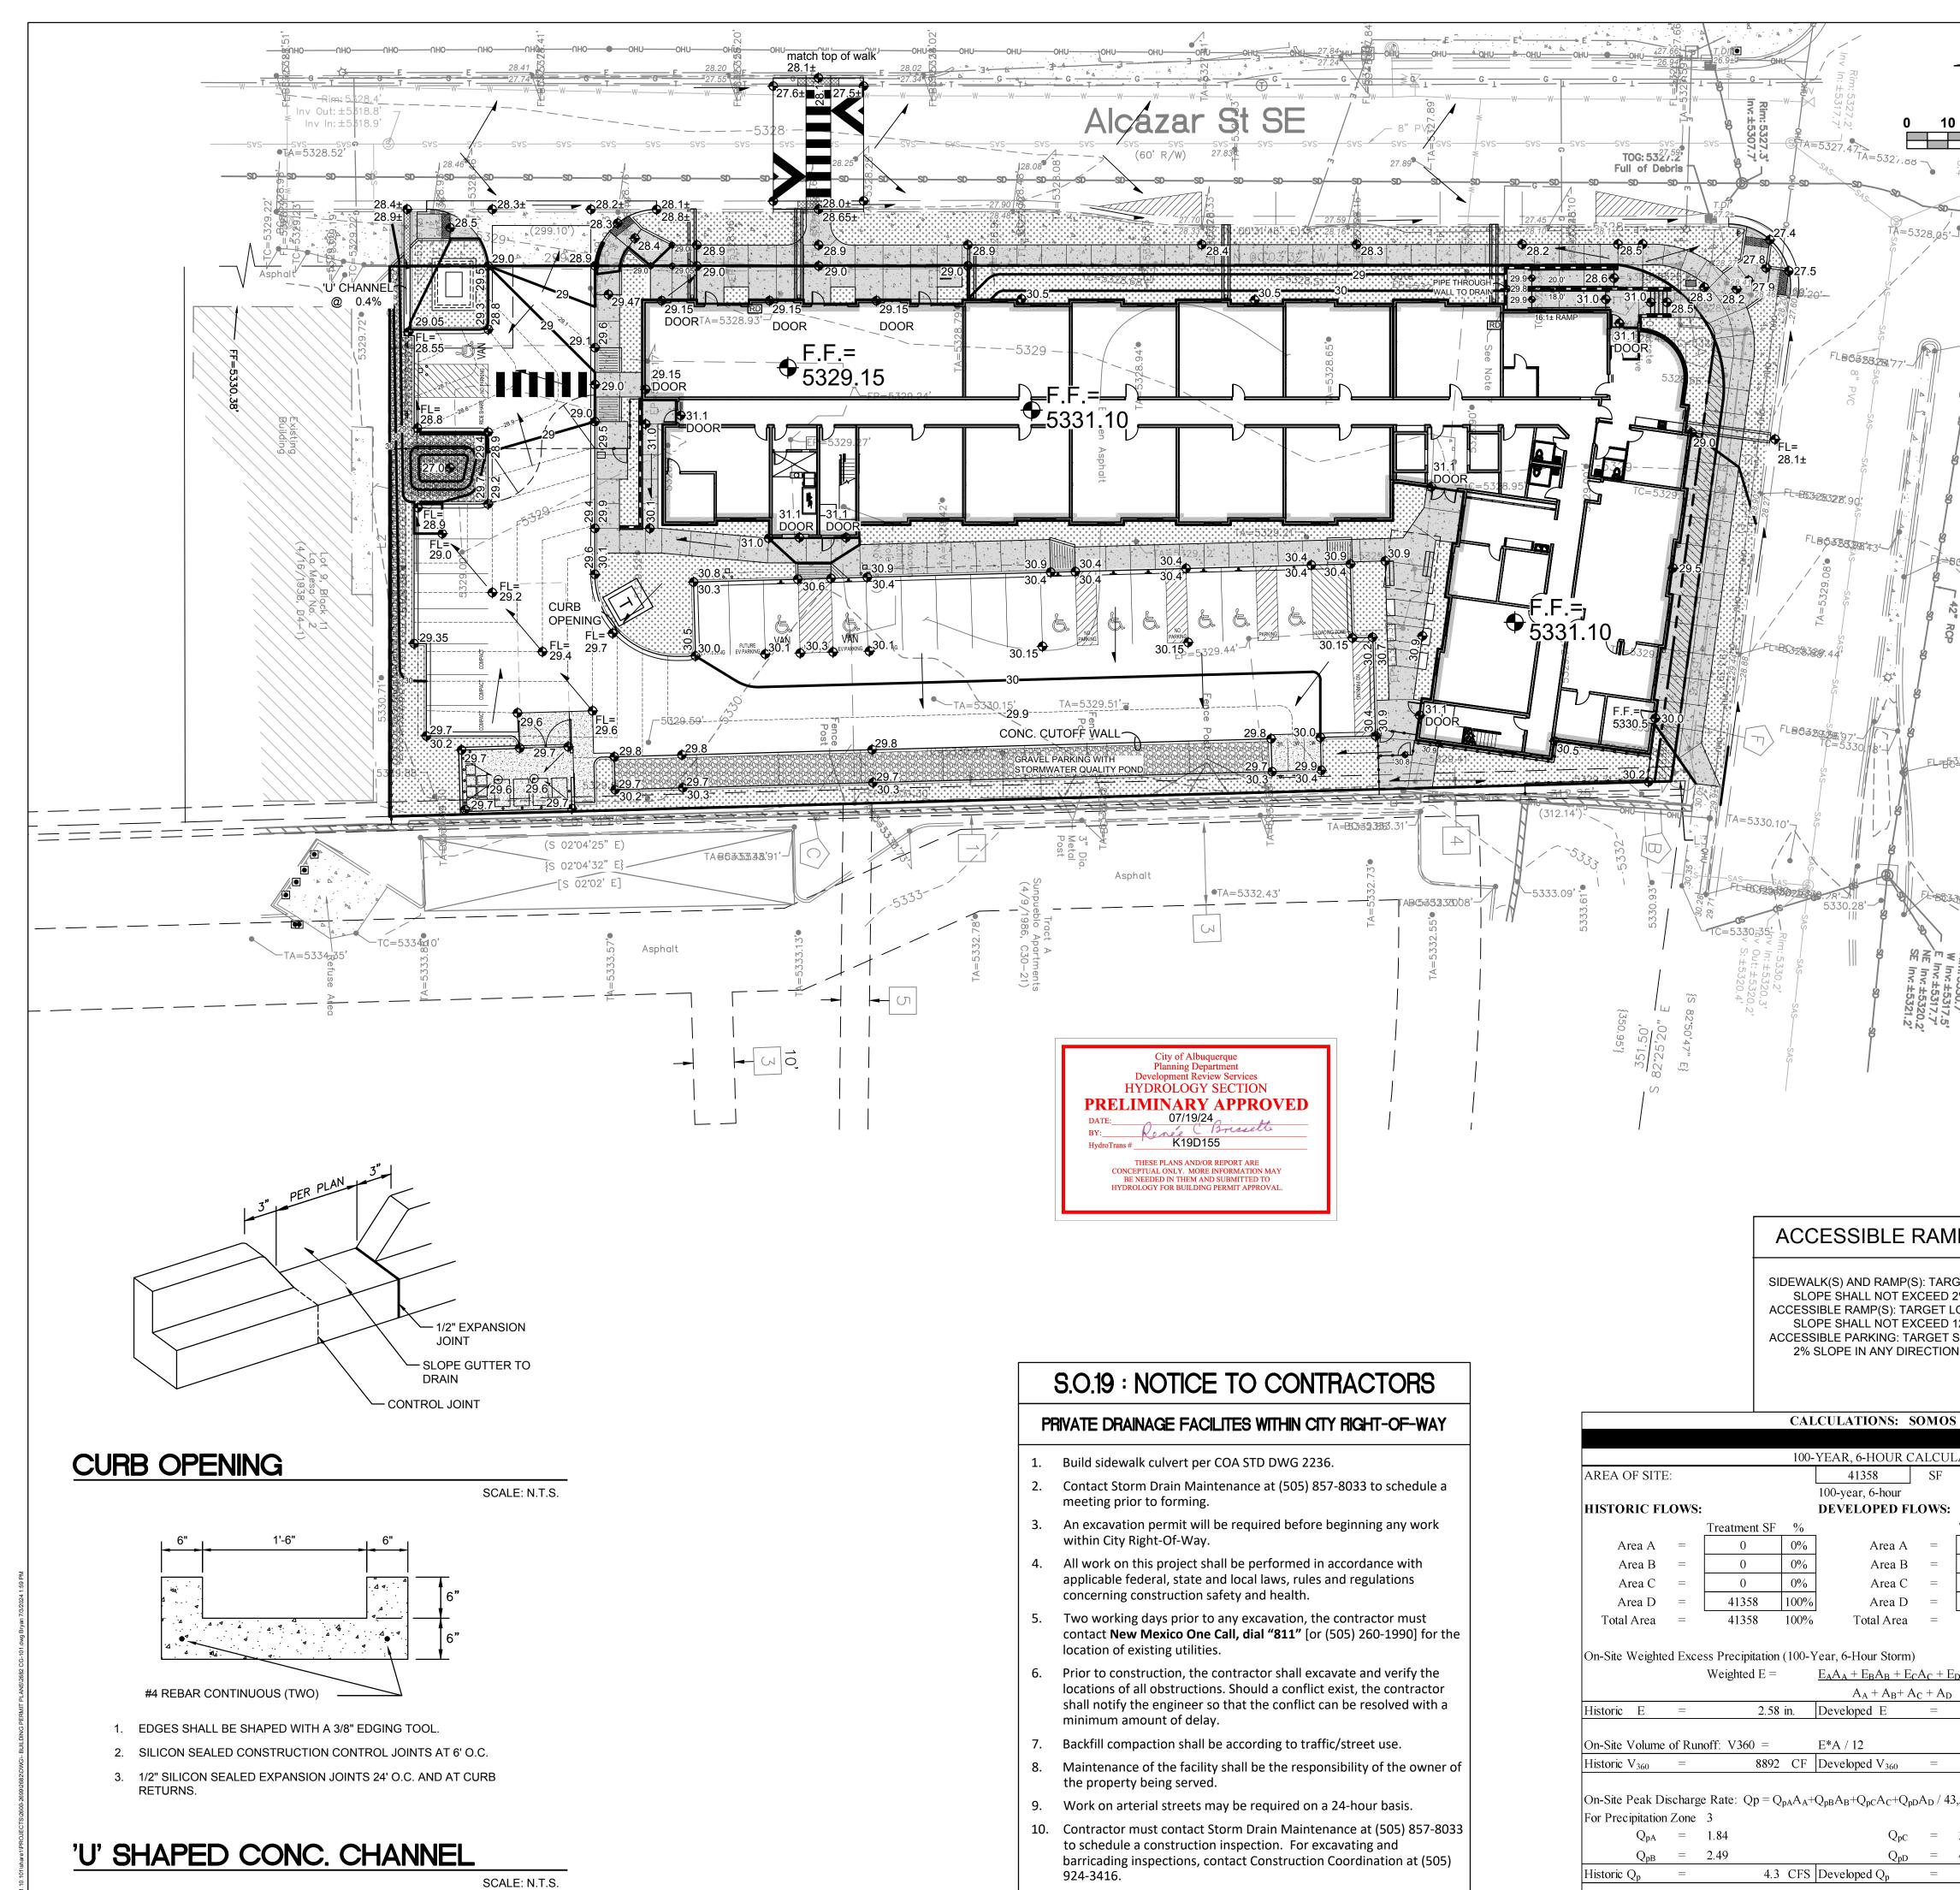
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Drawn by	KA
Checked by	GM
Date	AUGUST 12TH, 2024
Project number	2735

SHEET TITLE



SHEET NUMBER

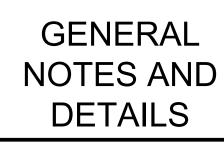


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В

			CAL	CULATIONS:	SOMOS
			100-	YEAR, 6-HOUR	CALCUI
AREA OF SITE:Treatment SFArea A $=$ 0 Area B $=$ 0 Area C $=$ 0 Area D $=$ 41358 Total Area $=$ 41358 On-Site Weighted Excess Precipitation Weighted E $=$ Historic E $=$ 2.58 On-Site Volume of Runoff: V360 $=$ Historic V ₃₆₀ $=$ 8892 On-Site Peak Discharge Rate: Qp = 0 C For Precipitation Zone 3 Q_{pA} $=$ 1.84 Q_{pB} $=$ 2.49 Historic Qp $=$ 4.3		41358	SF		
				100-year, 6-hour	
HISTORIC FI	LOWS	•		DEVELOPED F	FLOWS:
		Treatment SF	%		
Area A	=	0	0%	Area A	. =
Area B	=	0	0%	Area B	=
Area C	=	0	0%	Area C	=
Area D	=	41358	100%	Area D) =
Total Area	=	41358	100%	Total Area	. =
		Weighted E =		$\frac{E_AA_A + E_BA_B + I}{A_A + A_B + I}$	
Historic E		2.58	ın.	Developed E	=
			<u>111.</u>	E*A / 12	=
On-Site Volume	of Ru				=
On-Site Volume Historic V ₃₆₀ On-Site Peak D For Precipitatior Q _{pA}	of Rui = ischarg n Zone =	noff: V360 = 8892 ge Rate: Qp = Q 3 1.84	CF	E*A / 12 Developed V_{360} $Q_{pB}A_B+Q_{pC}A_C+Q$ Q_{pC}	$P_{pD}A_D / 43$
On-Site Volume Historic V ₃₆₀ On-Site Peak D For Precipitatior Q _{pA} Q _{pB}	of Rui = ischarg n Zone = =	noff: $V360 =$ 8892 ge Rate: $Qp = Q$ 3 1.84 2.49	CF P _{pA} A _A ++	E*A / 12 Developed V_{360} $Q_{pB}A_B+Q_{pC}A_C+Q$	$P_{pD}A_D / 43$

	C.O.A. VICINITY MAP K-19-Z		nc.	onsultants		Street NE	NM 87108	vil.com
20 40 60 20 40 60 SCALE 1"=20' N Inv: ±5320.2' N Inv:	Image:	purpos	design ots a the p n, Incore when writted on & writted on & writted on & writted on & writted on & or & o	Civil Engineering C Civil Engineering C ME 732	Icula whee ty of by a ation ver bermin AR/ X/C 2	128 Monroe 128 Monroe 128 Monroe 128 Monroe 128 Monroe	Albudue, and the second	nd nd & of on, ny
0; ±5329.1 (in): ±5324. Out): ±5324.	LOT BOUNDED TO THE NORTH BY CENTRAL AVE NE, TO THE EAST BY A DEVELOPED MULTI-FAMILY RESIDENTIAL, TO THE SOUTH BY DEVELOPED COMMERCIAL LOT, AND TO THE WEST BY ALCAZAR ST SE. PROPOSED IMPROVEMENTS: THE PROPOSED IMPROVEMENTS INCLUDE A		re		ni	inina D3 PM	ar	' y
IPS, WALKS & PARKING SET CROSS SLOPE = 1% TO 1.5%. CROSS 2000	Interventional and the second state of the second state	%(OJECT MBER: IA 2682	82 CG-101.dwg 7200 CENTRAL AV			DATE: 07/03/2024
5 : 43978	KEYED NOTES							
= 0.95 ACRE $= 0.95 ACRE$ $EXCESS PRECIP:$ $Treatment SF % Precip. Zone 3$ $= 0.67$ $= 0.86$	 PROVIDE SMOOTH TRANSITION TO EXISTING PAVEMENT 1' (BOTTOM WIDTH) CURB OPENING CONSTRUCT ADA COMPLIANT PARKING SPACES CONSTRUCT ADA COMPLIANT PEDESTRIAN ACCESS WALK AT ELEVATIONS SHOWN CONCRETE DUMPSTER PAD SLOPED TO INTERIOR DRAIN INLET(S). BUILDING EXTENDED STEMWALL REQUIRED TO ACHIEVE GRADES SHOWN. CONSTRUCT 2' WIDE ALLEY GUTTER CONSTRUCT 1.5' (BOTTOM WIDTH) 'U' SHAPED CONCRETE CHANEL THROUGH ISLAND TO PASS WATER 		RA R⁄			١G		
3,560 3.17	29.4 PROPOSED 0.1' CONTOUR 29.5 PROPOSED SPOT ELEVATION SURFACE FLOW DIRECTION	SHE	ET	NUM	1BE	R		
4.49 4.1 CFS	FF = 5331.10FINISHED FLOOR ELEVATIONGRAVEL			G-	1	0	1	

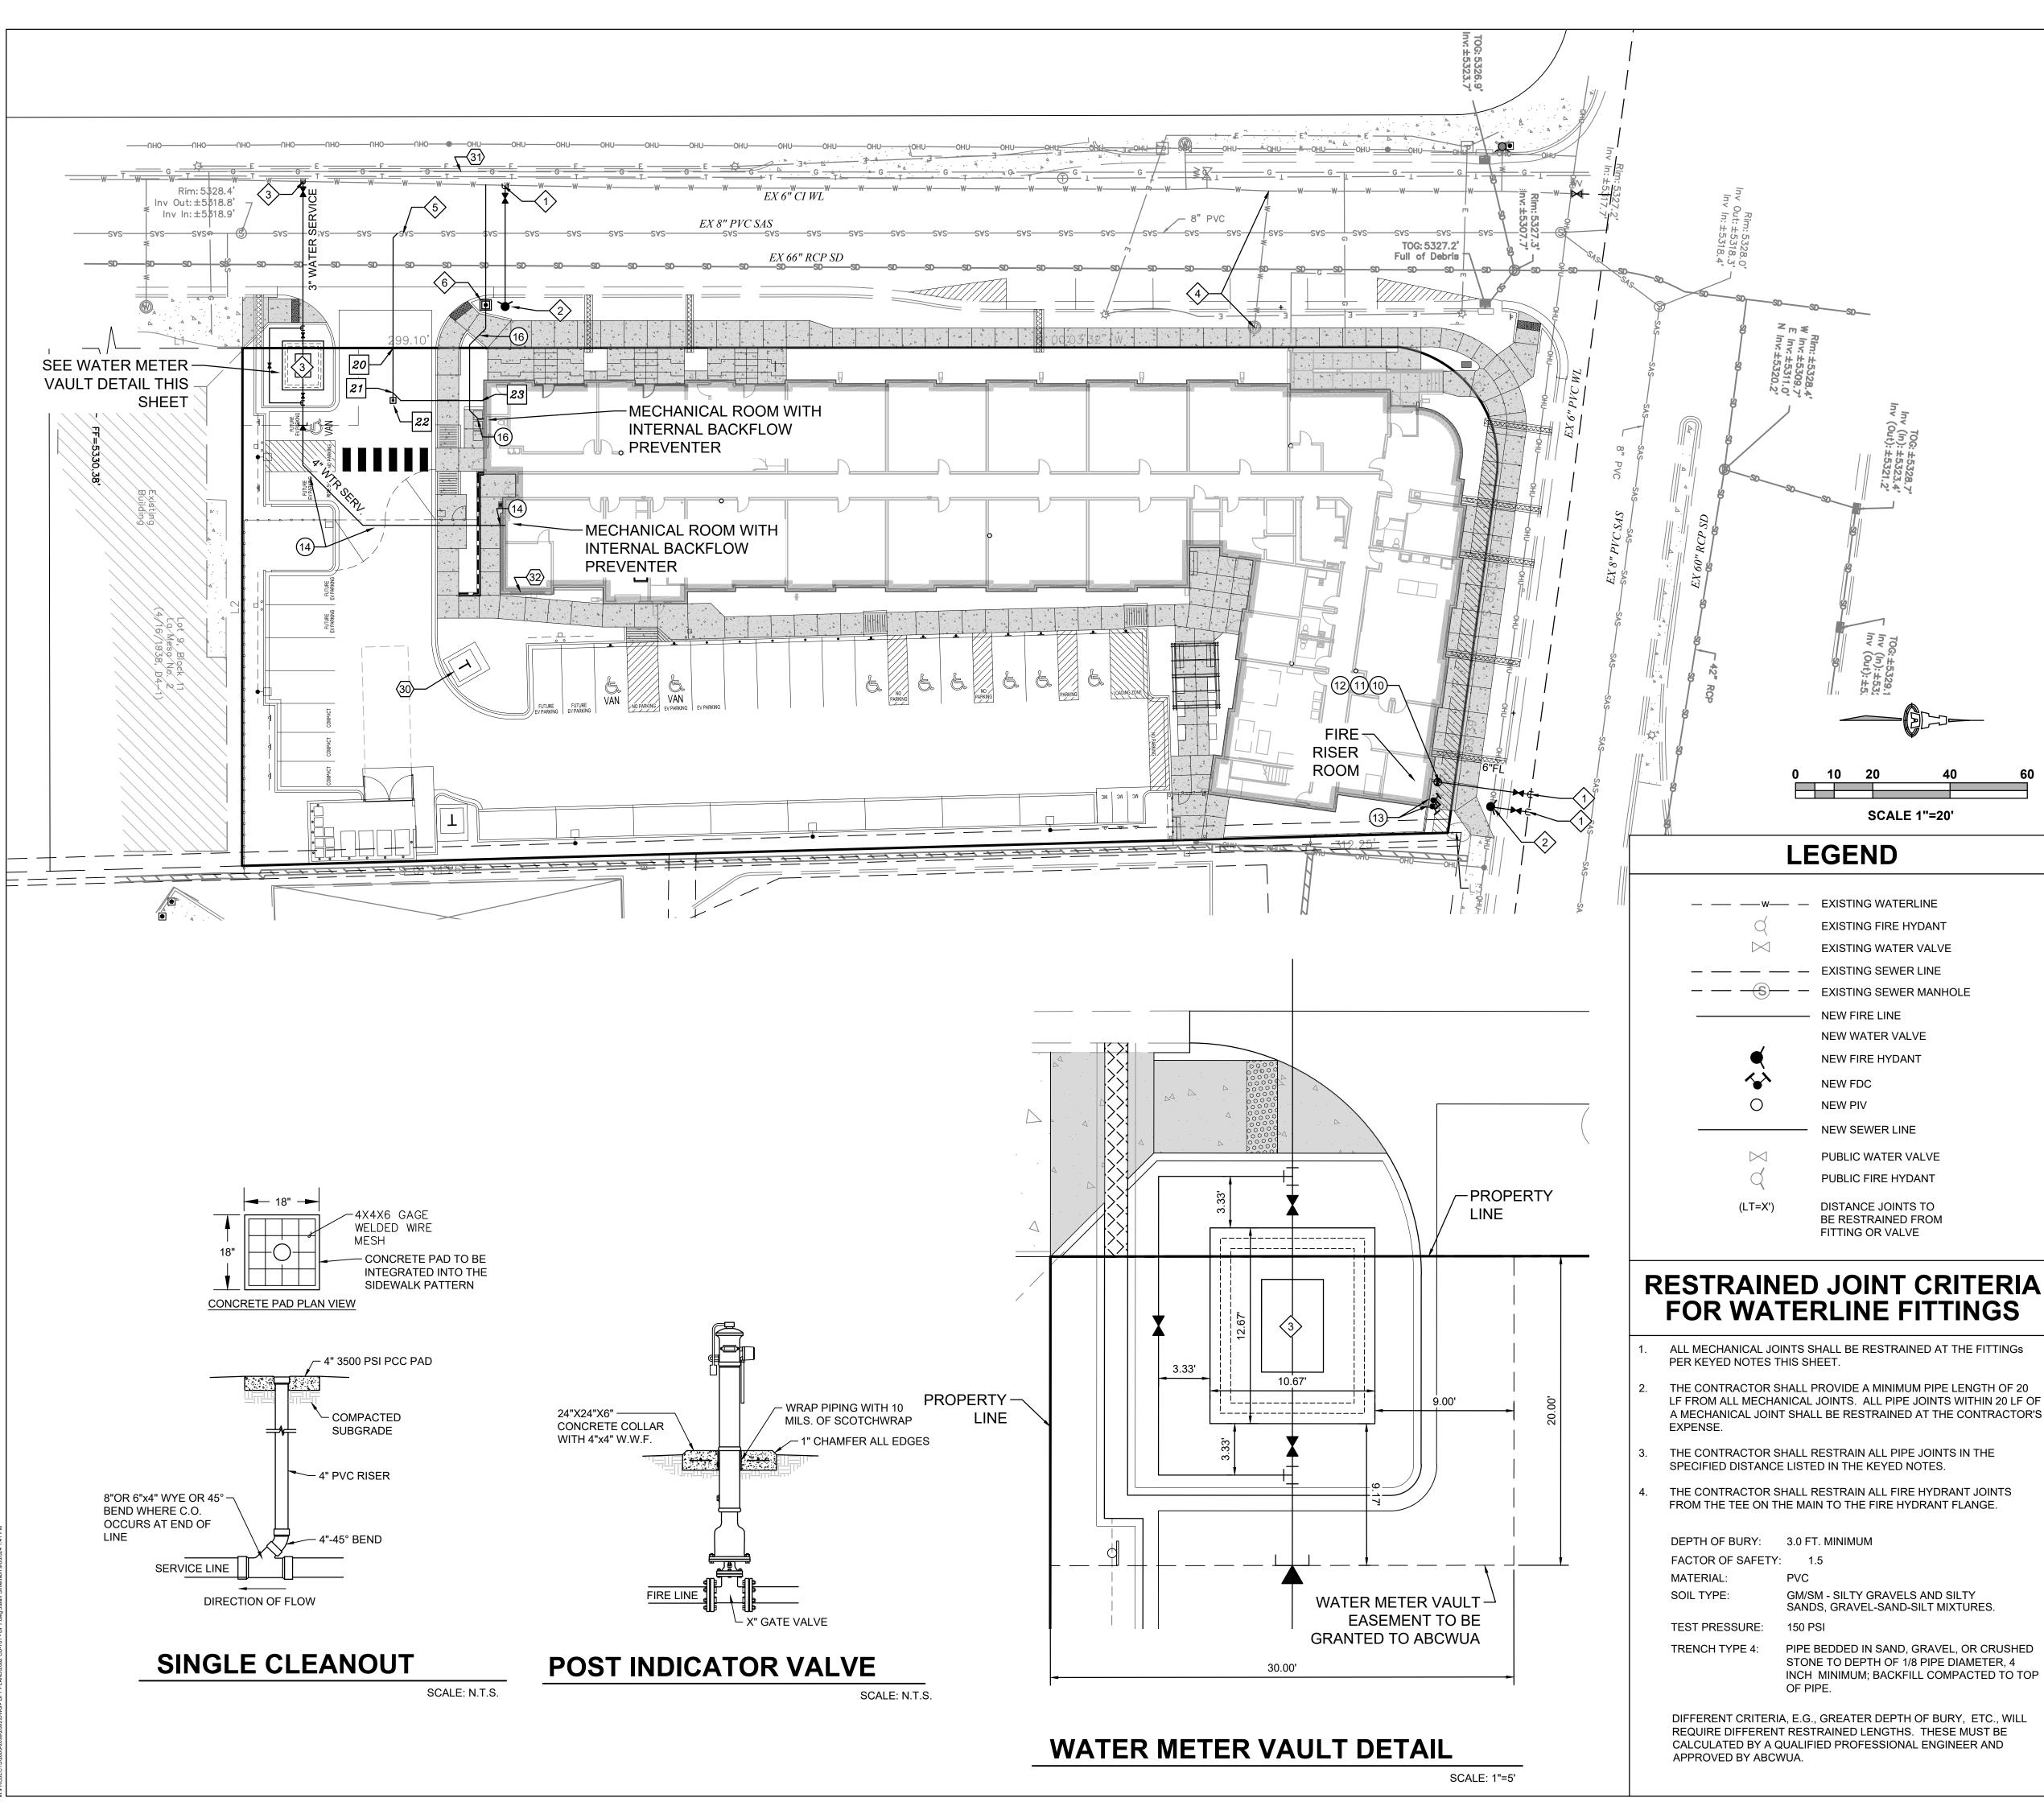

GENERAL NOTES

- A. EXISTING UTILITY LINES ARE SHOWN IN AN APPROXIMATE MANNER ONLY AND MAY BE INCOMPLETE OR OBSOLETE. SUCH LINES MAY OR MAY NOT EXIST WHERE SHOWN OR NOT SHOWN. ALL UTILITIES SHOULD BE FIELD VERIFIED AND LOCATED BY THE CONTRACTOR PRIOR TO COMMENCEMENT OF ANY CONSTRUCTION. THE CONTRACTOR IS FULLY RESPONSIBLE FOR ANY AND ALL DAMAGE CAUSED BY ITS FAILURE TO LOCATE, IDENTIFY AND PRESERVE ANY AND ALL EXISTING UTILITIES, PIPELINES, AND UNDERGROUND UTILITY LINES.
- CONTRACTOR SHALL NOT USE VIBRATORY COMPACTION EQUIPMENT OR HEAVY VEHICLES OVER EXISTING UTILITIES.
- SITE STORM DRAIN, ELECTRIC LINES & TRANSFORMERS AND GAS LINES ARE SHOWN FOR GENERAL INFORMATION ONLY TO PROVIDE AN OVERVIEW OF SITE UTILITIES AND POTENTIAL CONFLICTS. SEE MECHANICAL PLANS FOR GAS LINE SIZING. SEE CG-101 FOR STORM DRAIN DESIGN.
- ALL WATER FITTINGS SHALL HAVE JOINT RESTRAINTS (LT). SEE RESTRAINED JOINT CRITERIA NOTES THIS SHEET. (LT) LENGTH SHOWN ON KEYED NOTES.
- ALL ABOVE GROUND UTILITY EQUIPMENT AND FITTINGS SHALL BE PAINTED IN COLORS TO MATCH BUILDING COLORS.
- WATERLINES 4" IN DIAMETER OR LARGER SHALL BE PVC PIPE MEETING AWWA C900 DR-18 REQUIREMENTS.
- G. SANITARY SEWER LINE MATERIALS SHALL BE PVC SDR-35 PIPE.
- COORDINATION WITH WATER AUTHORITY CROSS CONNECTION SECTION WILL BE REQUIRED TO ENSURE PROPER BACKFLOW CONTAINMENT IS IN PLACE PRIOR TO RELEASE OF METER FOR THE SITE. CONTACT THE CROSS CONNECTION SECTION AT 505-289-3454.
- COORDINATION WITH THE WATER AUTHORITY PRE-TREATMENT ENGINEER IS REQUIRED TO ENSURE THE SITE COMPLIES WITH WATER AUTHORITY SEWER USE ORDINANCE. CONTACT THE PRE-TREATMENT ENGINEER AT 505-289-3439.
- CONNECTION TO THE 10" STEEL LINE WILL REQUIRE ENGINEERED DETAILS ON THE CONNECTION PERMIT PLAN SUBMITTAL.
- ALL WORK PERFORMED ON PRIVATELY OWNED SEWER LINE AND SERVICE LINES MUST BE INSPECTED BY THE CITY OF ALBUQUERQUE'S CODE ADMINISTRATION DIVISION. IN ORDER THAT INSPECTION BY THE PLANNING DEPARTMENT, CODE ADMINISTRATION DIVISION, PLUMBING SECTION CAN BE EFFICIENTLY HANDLED, WITH A MINIMUM LOSS OF TIME TO CONTRACTOR, THE FOLLOWING SHALL BE NOTED:
- INSPECTION ARRANGEMENTS FOR A SEWER SERVICE LINE SHALL BE MADE BY THE CONTRACTOR CALLING THE CITY OF ALBUQUERQUE, CODE ADMINISTRATION DIVISION, PLUMBING SECTION.
- INSPECTION REQUESTS CALLED IN BETWEEN THE HOURS OF 8:00 A.M. AND 12:00 NOON WILL BE INSPECTED THE SAME AFTERNOON. INSPECTION REQUESTS CALLED IN BETWEEN THE HOURS OF 1:00 AND 5:00 P.M. WILL BE INSPECTED THE FOLLOWING MORNING, EXCEPT IN CASES OF EMERGENCY.

KEYED NOTES

ABCWUA CONNECTION PERMIT ITEMS

- 1. NON-PRESSURE CONNECTION. INSTALL 6" TEE W/ 6" GATE VALVE PER ABCWUA STD DWG #S 2301, 2326, 2328.
- 2. INSTALL PUBLIC 4' BURY FIRE HYDRANT PER ABCWUA STD DWG #2340.
- 3. 3" WATER METER IN VAULT PER ABCWUA STD DWG #2370.
- 4. REMOVE AND DISPOSE EXISTING WATER METER BOX, CLOSE CORP STOP AT MAIN.
- 5. INSTALL 8" WYE ON EXISTING SAS MAIN AND INSTALL NEW 8" SERVICE LINE TO ROW.
- 6. 1" WATER METER PER ABCWUA STD DWGS #2362 & #2366.

- 10. REMOVE EXISTING 6" CAP AND CONNECT NEW 6" WATERLINE.
- 11. PIV (POST INDICATOR VALVE).
- 12. $\frac{3}{4}$ " ELECTRICAL CONDUIT W/ PULL STRING FROM PIV TO FIRE ROOM.
- 13. WALL MOUNT FDC (FIRE DEPARTMENT CONNECTION).
- 14. REMOVE 3" CAP. INSTALL 4"x3" REDUCER AND CONNECT NEW 4" SERVICE LINE TO BUILDING. SEE MECHANICAL PLAN FOR CONTINUATION.
- 15. 4" 45° BEND (LT = 5')
- 16. TIE TO 1" WATER METER. INSTALL EXPANSION TO TRANSITION FROM 1" TO 1-1/4". INSTALL 1-1/4" WATER SERVICE LINE TO BUILDING. SEE MECHANICAL PLAN FOR CONTINUATION.

SEWER KEYED NOTES


20. CONNECT TO 8" SANITARY SEWER SERVICE AT ROW.

- 21. INSTALL 8" WYE.
- 22. INSTALL SINGLE CLEAN OUT PER DETAIL THIS SHEET.
- 23. SEE MECHANICAL PLAN FOR CONTINUATION.

24. INSTALL 8" - 45° BEND

$\langle \rangle$ <u>DRY UTILITY KEYED NOTES</u>

- 30. PNM TRANSFORMER. OWNER / CONTRACTOR TO COMPLETE AND SUBMIT A COMMERCIAL SERVICE APPLICATION TO PNM. PNM REPRESENTATIVE TO TO PROVIDE ONSITE ELECTRICAL SERVICE LINE LOCATION.
- 31. NEW MEXICO GAS COMPANY GAS MAIN. OWNER / CONTRACTOR TO COMPLETE AND SUBMIT A COMMERCIAL SERVICE APPLICATION TO NMGCO.
- 32. GAS METER LOCATION TO BE DETERMINED BY OWNER AND NMGCO.

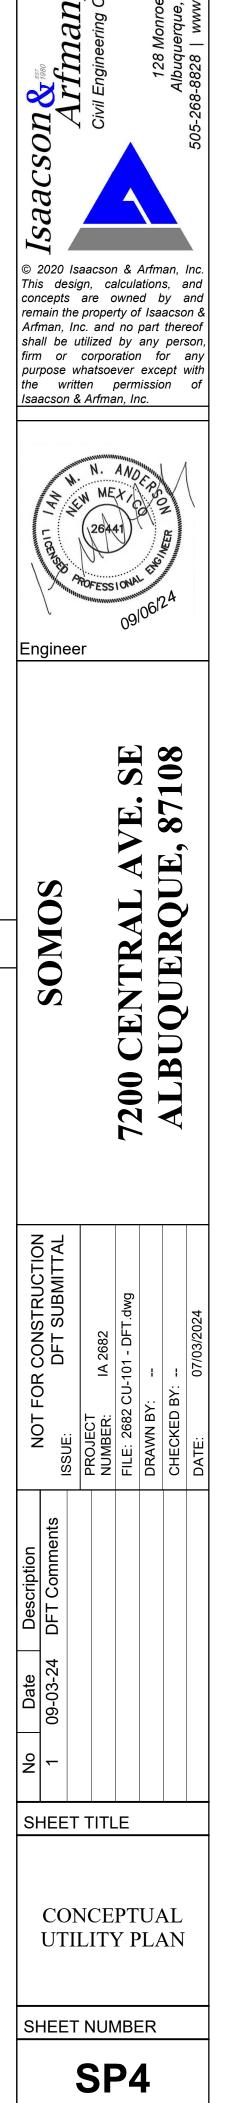

Inc.

Street NM 87 iacivil c

que,



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Hollow Metal Door Orange Decorative Lighting Composite Window White Metal Trellis NORTH ELEVATION (CENTRAL AVE FACING FACADE) 3/32" = 1'-0"

2



3

WEST ELEVATION (ALCAZAR STREET FACING FACADE) 3/32" = 1'-0"

2

1

Width, maximum: 50% of building frontage width Height of message surface, maximum: letters and images must located on vertical surfaces, which may not exceed 18 in. height.

Commercial Signage Maximum Size Based Off IDO (Table 5-12-3): Number, maximum: 1 / establishment frontage

4

Vinyl Window White Metal Coping Orange 13' - 6 1/2" 32' - 3" FACE RECEDES 20'-0" Approx. 17' - 4" Glass Storefront

3

Office/Main Entry Lobby Beyond

RelocatedExisting Tile Pillar Monument

- Metal Awening at Main Entry Door

Sun Shelf

Custom trellis (optional)

Metal Sunshade (optional)

Illuminated Raised Signage 49 SF (less than 15%)

Roof Deck (Optional)

Location: Where there is no side setback between 2 establishment frontages in the same or abutting buildings, no wall sign may extend closer than 2 feet to the shared edge of the frontage.

Area, maximum: Shall not exceed the following percentages of

facade area, inclusive of door and window openings: MX-M: 15%.

Wall Sign Maximum Size Based Off IDO (Table 5-12-3): Number, maximum: N/A.

- Wall Mural (Image to be determined - 150sf min)

STREET ELEVATIONS TRANSPARENCY CALCULATIONS

32% PROVIDED > 30% REQUIRED

977SF OF TRANSPARENT DOORS AND WINDOWS PROVIDED.

254'-6" LENGTH X 12' HEIGHT = 3,054SF OF FACADE SURFACE AREA FOR THE FIRST 12 FEET OF BUILDING HEIGHT. 30% REQUIRED TRANSPARENT DOORS AND WINDOWS FOR THE FIRST 12 OF BUILDING HEIGHT.

TOTAL NORTH FACADE LENGTH:254'-6"

ALCAZAR ST ELEVATION

TOTAL NORTH FACADE LENGTH:103'-6"

34.5% PROVIDED > 30% REQUIRED

CENTRAL AVE ELEVATION

GENERAL SHEET NOTES

- Building mounted signs shall meet IDO Section 5-12(E)(5)(c) Mixed Use and Nona. Residential Zone Districts and Table 5-12-3. The sign area shall not exceed 25% of the façade area, inclusive of door and window openings. Building design shall meet IDO Section 5-11(E) Multi-family Residential Development in b.
- UC-MS-PT Areas and Mixed Use and Non-Residential development in Mixed-Use Zone Districts. Per IDO 5-11(E) (1) the ground floor height shall have a minimum clear height of 10 feet. C.
- Per IDO Section 5-11(E)(2)(a), the façade design shall provide a sense of human scale d. and shall incorporate features along at least 30 percent of the length of the façade, distributed along the facade so that at least 1 of the features occurs every 40 feet. The elevations provide windows on the upper floors and awnings over windows as shown. The facades facing Central Avenue and Alcazar incorporate changes in color more than 20% of the horizontal length of the façade and wall plane projections or recesses of at least 1 foot in depth every 100 feet of the façade length and extending for at least 25 percent of the length of the façade.
- Per 5-11(E)(2)(b), windows on the upper floors shall be recessed by a minimum of 2inches and the ground floor of the Central and Alcazar facades shall contain a minimum of 30 percent of its surface in transparent windows and/or doors. All exterior windows in common areas are to receive roller shades. All other exterior
- windows are to receive 2 1/2" white faux wood blinds. West facing facade solar effect mitigation elements: Fixed fenestration vinyl window U-Factor of U-0.33. Operable fenestration vinyl window U-Factor of U-0.35. Glazing Solar Heat Gain Coefficient (SHGC) PF<0.2 Fixed of 0.33 Glazing Solar Heat Gain Coefficient (SHGC) PF<0.2 Operable of 0.31

Wood framed walls above grade R-19 + R-3.8 c.i.




CONSULTANT

103'-6" LENGTH X 12' HEIGHT = 1,242SF OF FACADE SURFACE AREA FOR THE FIRST 12 FEET OF BUILDING HEIGHT. 30% REQUIRED TRANSPARENT DOORS AND WINDOWS FOR THE FIRST 12 OF BUILDING HEIGHT.

429SF OF TRANSPARENT DOORS AND WINDOWS PROVIDED. 429SF / 1,242SF = 34.5% OF FACADE SURFACE AREA IS TRANSPARENT DOORS AND WINDOWS FOR THE FIRST 12 FEET OF BUILDING HEIGHT.

977SF / 3,0542SF = 32% OF FACADE SURFACE AREA IS TRANSPARENT DOORS AND WINDOWS FOR THE FIRST 12 FEET OF BUILDING HEIGHT.

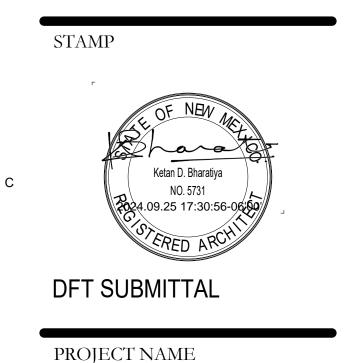


SOMOS

7200 CENTRAL AVE SE, ALBUQUERQUE, NEW MEXICO 87108

SOMOS APARTMENTS LIMITED PARTNERSHIP LLLP

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Drawn by	JJ/VM
Checked by	KB
Date	SEP 03, 2024
Project number	2735
	2100

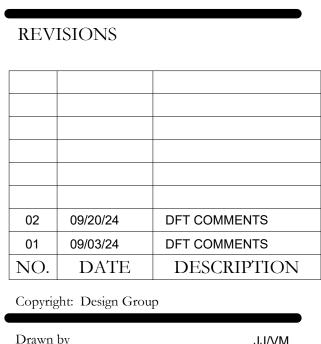SHEET TITLE


BUILDING ELEVATIONS -DFT SUBMITTAL

SHEET NUMBER

SP-8



5

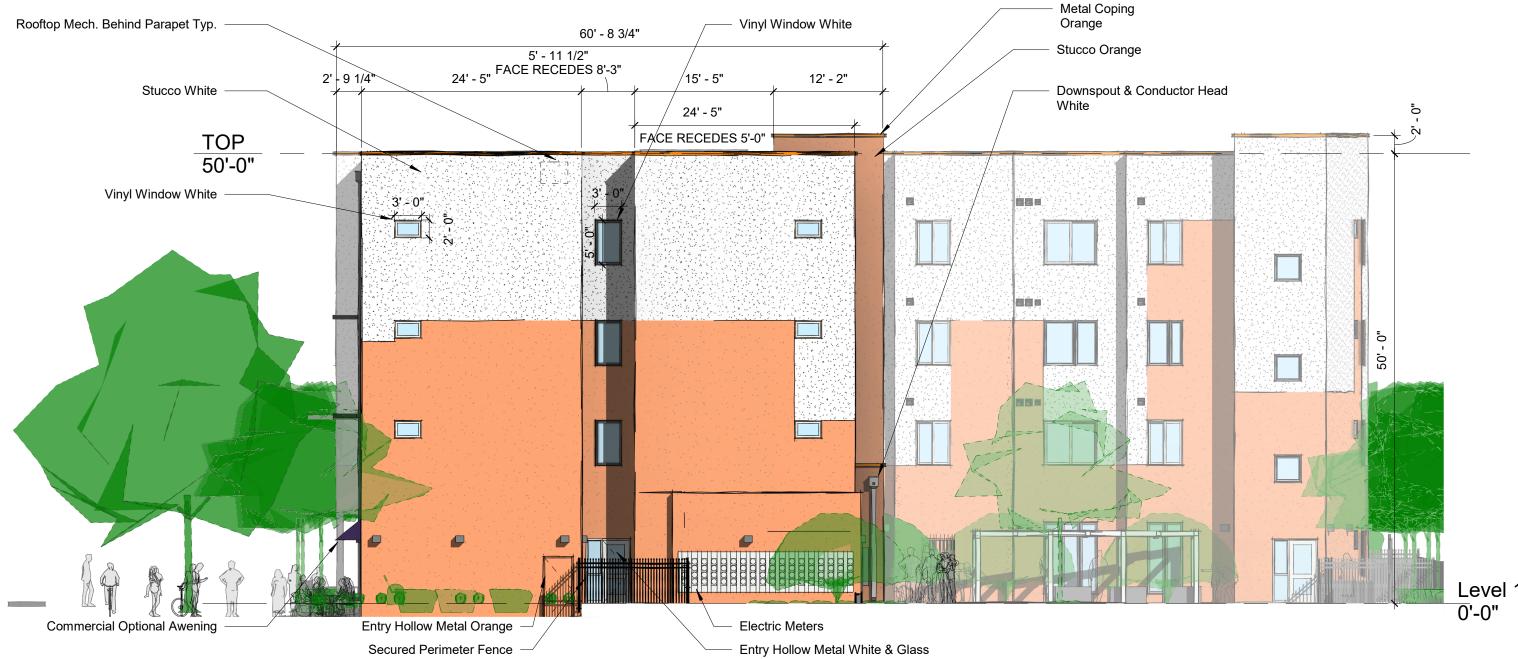

SOUTH ELEVATION (INTERIOR FACING FACADE) 0' 5' 10'


3/32" = 1'-0"

1

D

С

В

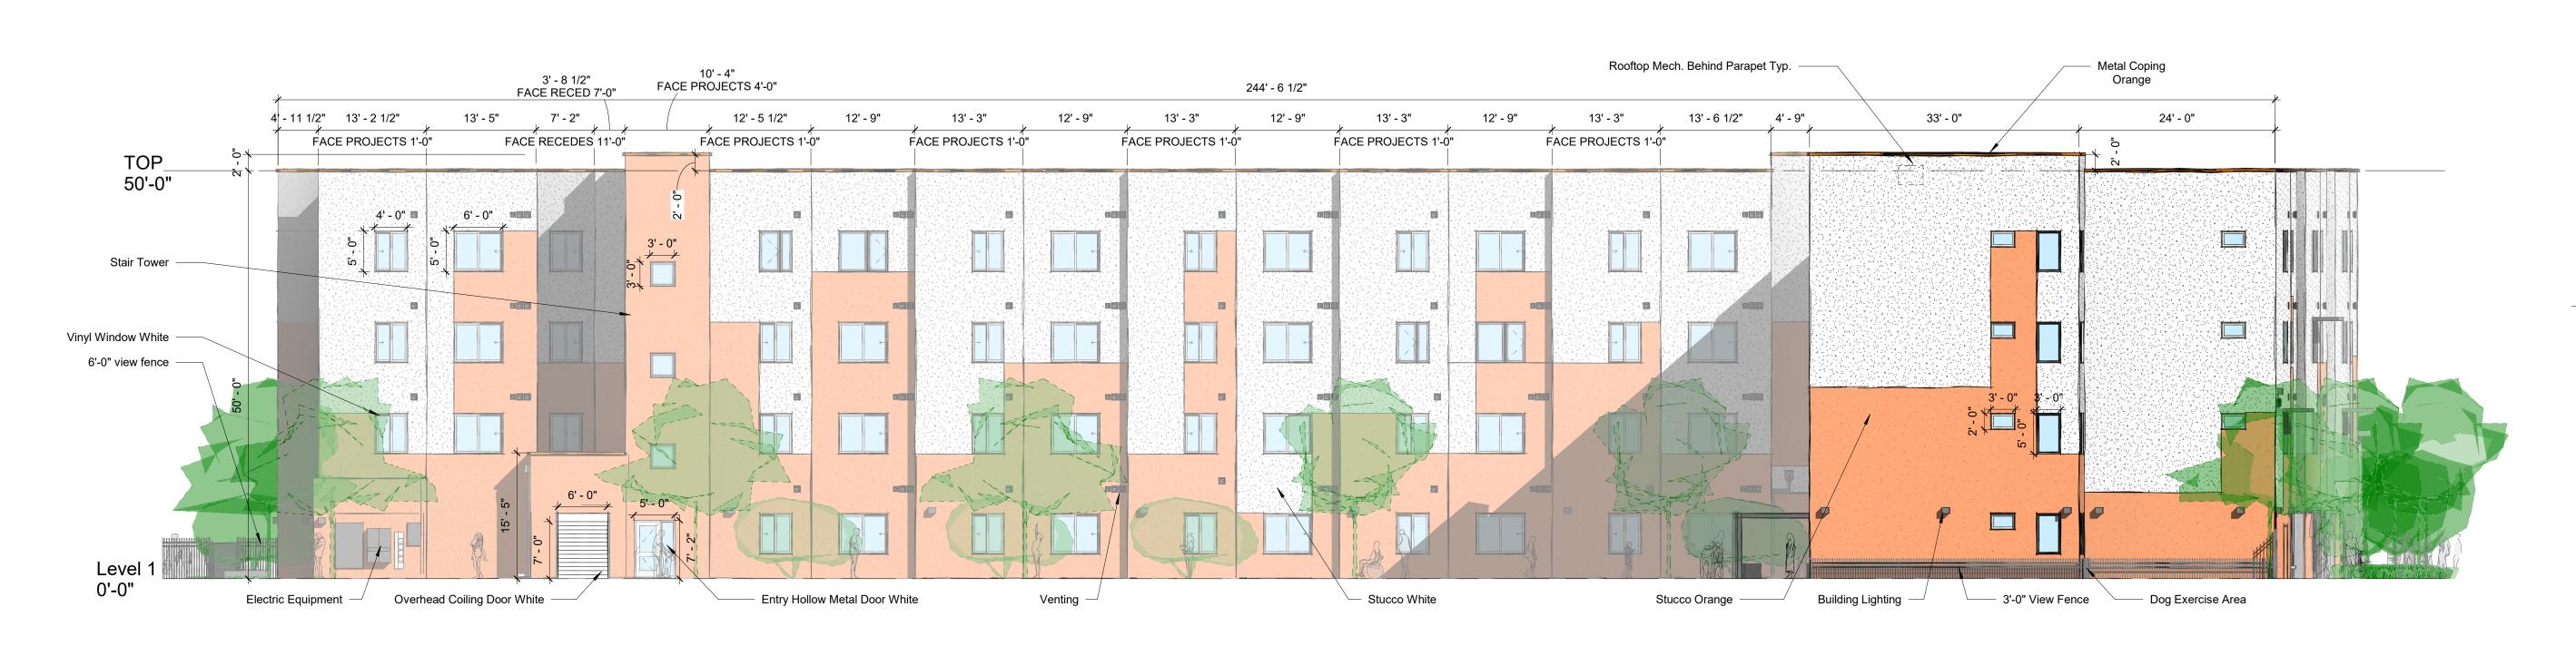

3

EAST ELEVATION (INTERIOR FACING FACADE) 3/32" = 1'-0"

2

1

А

SOUTH ELEVATION (INTERIOR FACING FACADE) 3/32" = 1'-0"

4



4

3

GENERAL SHEET NOTES Building mounted signs shall meet IDO Section 5-12(E)(5)(c) Mixed Use and Non-Residential Zone Districts and Table 5-12-3. The sign area shall not exceed 25% of the a. façade area, inclusive of door and window openings. Building design shall meet IDO Section 5-11(E) Multi-family Residential Development in UC-MS-PT Areas and Mixed Use and Non-Residential development in Mixed-Use Zone b. Districts.

- Per IDO 5-11(E) (1) the ground floor height shall have a minimum clear height of 10 feet. Per IDO Section 5-11(E)(2)(a), the façade design shall provide a sense of human scale d. and shall incorporate features along at least 30 percent of the length of the façade, distributed along the facade so that at least 1 of the features occurs every 40 feet. The elevations provide windows on the upper floors and awnings over windows as shown. The facades facing Central Avenue and Alcazar incorporate changes in color more than 20% of the horizontal length of the façade and wall plane projections or recesses of at least 1 foot in depth every 100 feet of the façade length and extending for at least 25 percent of the length of the façade. e.
- Per 5-11(E)(2)(b), windows on the upper floors shall be recessed by a minimum of 2inches and the ground floor of the Central and Alcazar facades shall contain a minimum of 30 percent of its surface in transparent windows and/or doors.




CONSULTANT

ם

5' 10'

5

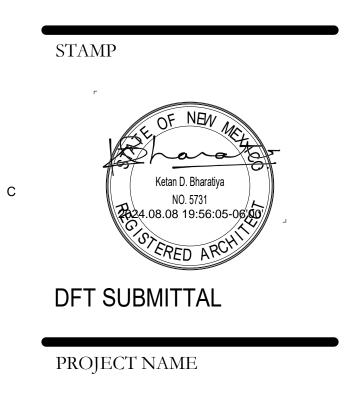

SOMOS

REVISIONS

7200 CENTRAL AVE SE, ALBUQUERQUE, NEW MEXICO 87108

SOMOS APARTMENTS LIMITED PARTNERSHIP LLLP

NO.	DATE	DESCRIPTION
Copyrigh	nt: Design Grou	p
Drawn b	У	VM

214	V
Checked by	К
Date	AUGUST 12, 202
Project number	273

SHEET TITLE

BUILDING ELEVATIONS -DFT SUBMITTAL

SHEET NUMBER

SP-9

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А

1

2


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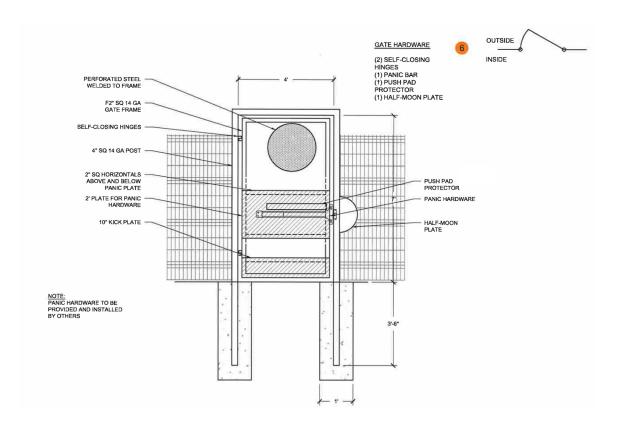
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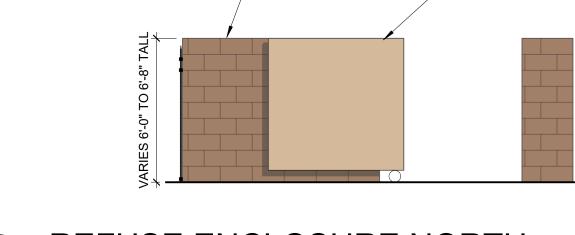
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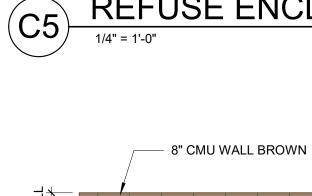
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2











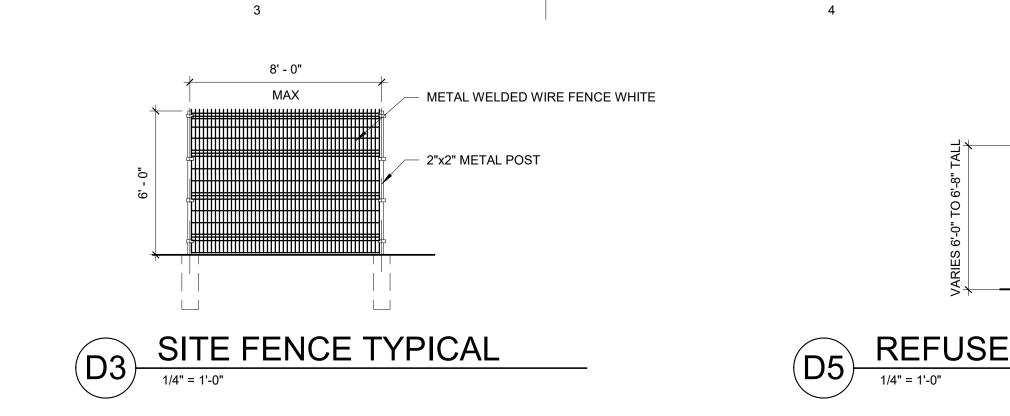


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4

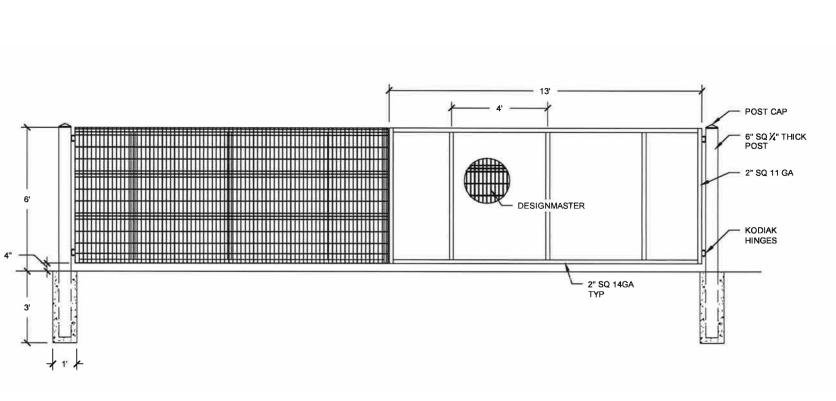- 8" CMU WALL BROWN



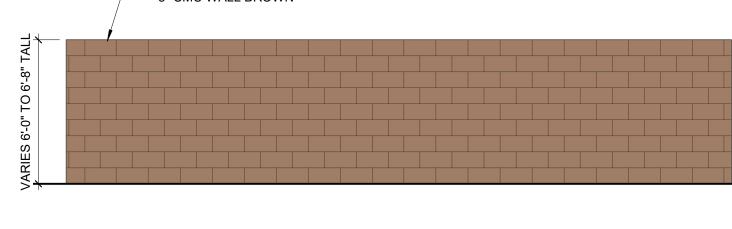


CONSULTANT

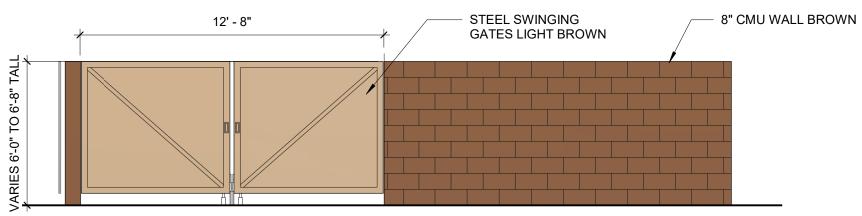STAMP

С

D

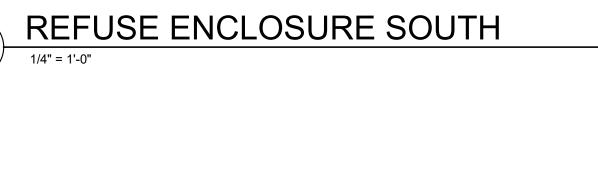

- 8" CMU WALL BROWN - STEEL SLIDING GATE LIGHT BROWN

REFUSE ENCLOSURE NORTH

5

		REVISIONS	
		NO.	DATE
		Copyrig	ht: Design C
		Drawn	by

В

Ketan D. Bharatiya NO. 5731 DFT SUBMITTAL PROJECT NAME

7200 CENTRAL AVE SE, ALBUQUERQUE, NEW MEXICO 87108

SOMOS APARTMENTS

LIMITED PARTNERSHIP

DESCRIPTION

AUGUST 12, 2024

VM

KB

2735

LLLP

Checked by

Project number

SHEET TITLE

SUBMITTAL

SHEET NUMBER


SITE DETAILS - DFT

SP-10

Date

А

SOMOS

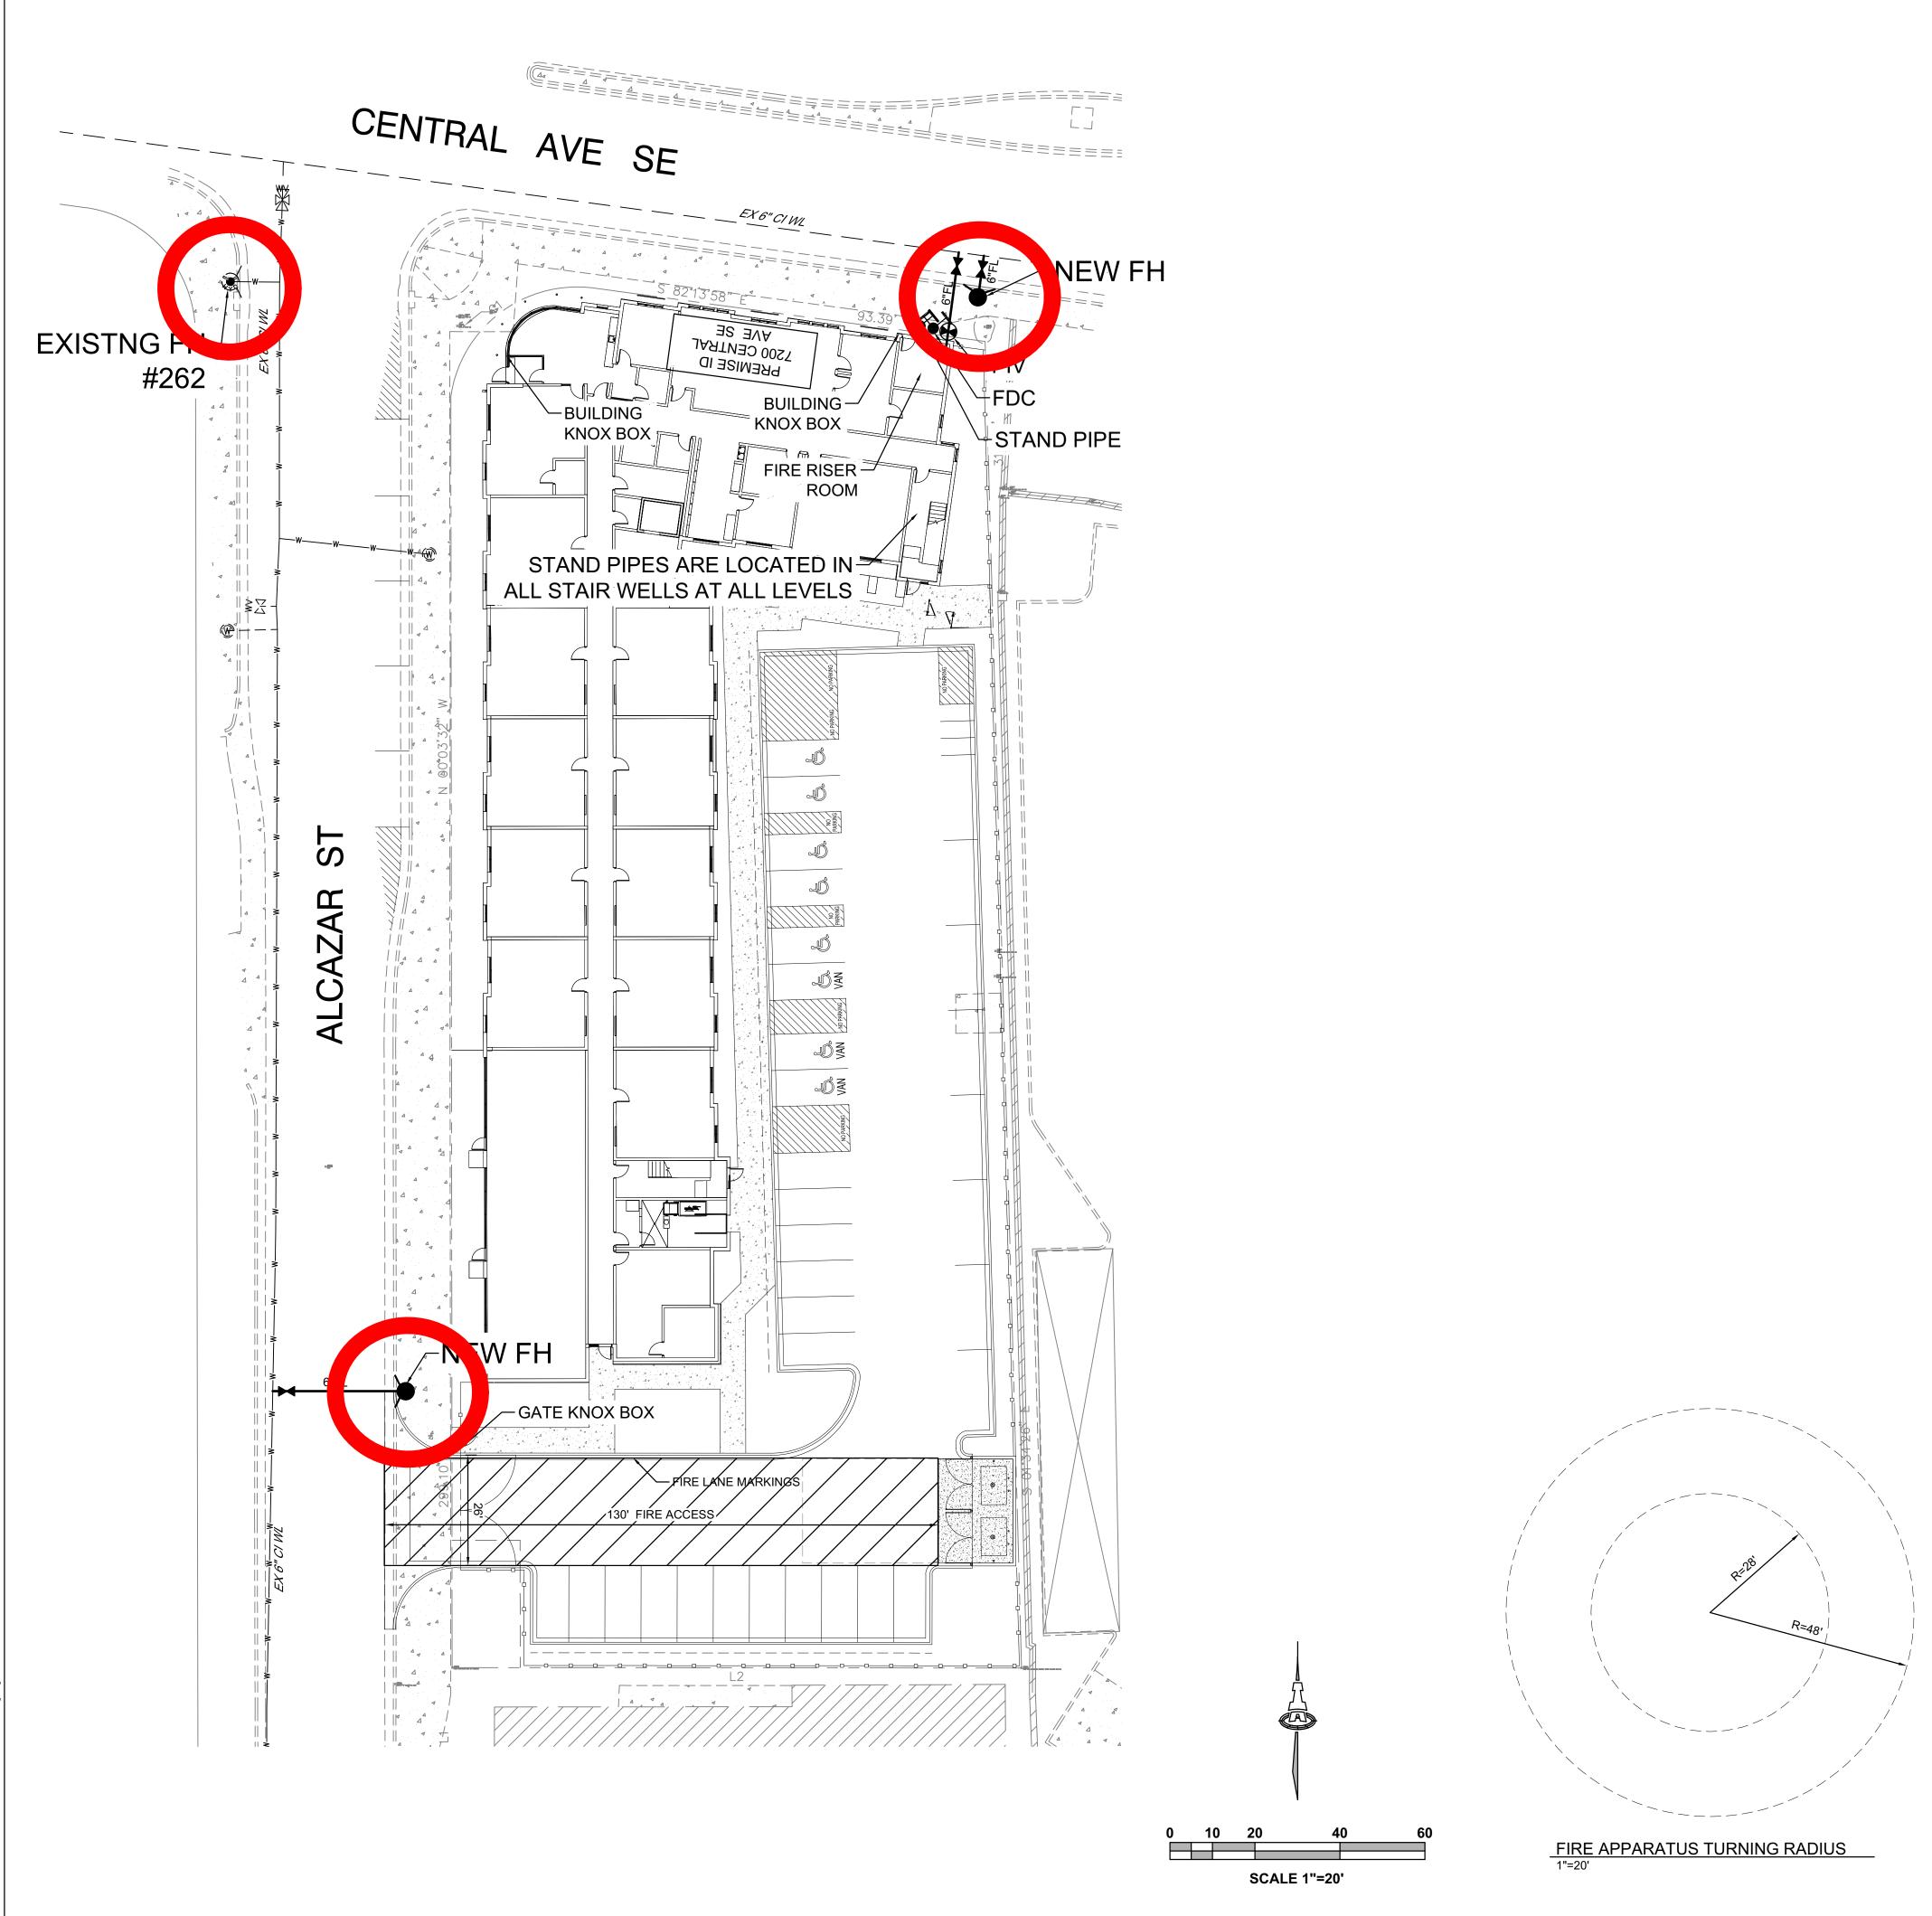



K-19

FP-24-019530

PR-2024-010784_SI-2024-01164_Somos Final Sign-off Signature Page

Interim Agreement Report

2024-11-19

Created:	2024-10-10
Ву:	Jay Rodenbeck (jrodenbeck@cabq.gov)
Status:	Out for Signature
Transaction ID:	CBJCHBCAABAAKoEqaTnt90I9VDViuubuAhkyJQssCs2r

Agreement History

Agreement history is the list of the events that have impacted the status of the agreement prior to the final signature. A final audit report will be generated when the agreement is complete.

"PR-2024-010784_SI-2024-01164_Somos Final Sign-off Signatu re Page" History

- Document created by Jay Rodenbeck (jrodenbeck@cabq.gov) 2024-10-10 - 3:12:14 PM GMT
- Document emailed to Tiequan Chen (tchen@cabq.gov) for signature 2024-10-10 - 3:14:27 PM GMT
- Document emailed to Jolene Wolfley (jwolfley@cabq.gov) for signature 2024-10-10 - 3:14:28 PM GMT
- Document emailed to Ernest Armijo (earmijo@cabq.gov) for signature 2024-10-10 3:14:28 PM GMT
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- Email viewed by Ernest Armijo (earmijo@cabq.gov) 2024-10-10 - 3:20:19 PM GMT

- Document e-signed by Ernest Armijo (earmijo@cabq.gov) Signature Date: 2024-10-10 - 3:20:30 PM GMT - Time Source: server
- Email viewed by Tiequan Chen (tchen@cabq.gov) 2024-10-10 - 3:29:18 PM GMT
- Document e-signed by Tiequan Chen (tchen@cabq.gov) Signature Date: 2024-10-10 - 3:30:26 PM GMT - Time Source: server
- Email viewed by Jeff Palmer (jppalmer@cabq.gov) 2024-10-10 - 6:18:31 PM GMT
- Document e-signed by Jeff Palmer (jppalmer@cabq.gov) Signature Date: 2024-10-10 - 6:18:50 PM GMT - Time Source: server
- Email viewed by Whitney Phelan (wphelan@cabq.gov) 2024-10-10 - 8:43:19 PM GMT
- Document e-signed by Whitney Phelan (wphelan@cabq.gov) Signature Date: 2024-10-10 - 8:43:42 PM GMT - Time Source: server
- Document e-signed by David Gutierrez (dggutierrez@abcwua.org) Signature Date: 2024-10-25 - 4:44:50 PM GMT - Time Source: server