### Memorandum



To:	Jolene Wolfley, Chair
	Jay Rodenbeck, Planning Manager

- From: Jackie Fishman, AICP, Principal
- Date: September 9, 2024

Re: Re-submittal of Site Plan-DFT \_ PR-2024-010784/SI-2024-01164

The following memo provides responses to DFT staff comments for the SOMOS Affordable Housing Plan, Site Plan-Administrative application heard on August 21, 2024. Staff comments are in italic followed by the Applicant responses.

#### CODE ENFORCEMENT

1. Property is zoned MX-M and Must meet all Dimensional Standards of MX-M, as per IDO 5- 1(D), Table 5-1-2. Table requires a 15 ft corner side yard setback on site plan in the UC-MS- PT areas. Site Plan shows building setback at 8.36 feet. Need to correct or obtain Variance.

Applicant Response: As explained at the 8/21 DFT meeting, Table 5-1-2 requires a minimum side setback of 0 feet and a **maximum** setback of 15 feet on street sides of corner lots within UC-MS-PT areas. Therefore, the 8.36-foot side setback is compliant with the IDO dimensional standards.

2. Property is located within the Main Street (MS), Premium Transit (PT), and Major Transit (MT) Corridor areas, and must meet development standards of IDO 5-1(D)(2) for Urban Center, Main Street, and Premium Transit Areas.

**Applicant Response:** Agreed, the Site Plan is compliant with the development standards for UC-MS-PT areas.

- 3. Parking calculations have several potential discrepancies, as follows:
  - a. Parking shown for "commercial space" is calculated as 1.75/1000 x 1700 sq ft. Clarify what use is being cited for this parking calculation (ie: restaurant, retail, commercial service). Commercial services requires 3 spaces/1000.

**Applicant Response:** The Site Plan has been revised to state that the "Commercial space may be commercial service, commercial retail, or a combination of both. Therefore, the parking calculation used below is based on commercial services, which requires more parking than commercial retail." The parking calculation shows 1,700 SF commercial x **3 spaces/1,000 SF** GFA.

 Parking Reduction of 50% cited as a Premium Transit Reduction, as per 5-5(C)(5)(a), is inaccurate. This section does not apply, nor does it cite a 50% potential credit. You may want to explore reductions for Proximity to transit, as per IDO 5-5(C)(5)(c).

**Applicant Response:** The reference to the IDO section has been revised to IDO 5-5(C)(5)(d), which allows for a "**50% reduction** if the proposed development is located within a **PT area.**"

c. Parking reduction miscalculation affects the totals for all further parking calculations (motorcycle, bicycle, ADA).

Applicant Response: This is inaccurate, see response above.

d. EV charging stations are not required for a development of this size. However, you may claim the appropriate credits for EV charging stations installed.

**Applicant Response:** Agreed, but the Applicant is required to provide EV charging stations by Housing New Mexico (formerly New Mexico Mortgage Finance Authority).

e. Shared Vehicle Program credits: please show note with details for planned use of the 4 proposed spaces as "the exclusive use of an existing car-sharing program" to be utilized.

**Applicant Response:** A note has been added to the parking calculations. A carsharing program will be implemented as part of the development of this project.

4. Fencing must be approved by separate permit and meet requirements of IDO 5-7.

#### Applicant Response: Agreed.

5. Signage must be approved by separate permit(s) and meet requirements of IDO 5-12.

#### Applicant Response: Agreed.

#### ENGINEERING

1. The speed table should be added to the infrastructure list.

**Applicant Response:** The speed table has been removed from the Site Plan. An infrastructure list will not be required per discussion at the previous DFT meeting.

#### PLANNING

Application and project numbers need to be added to the Site Plan.

Applicant Response: The numbers have been added to the Site Plan.

An Infrastructure List is included with this application. Planning defers to Transportation and Water Authority for review.

**Applicant Response:** An infrastructure list is not required per discussion at the previous DFT meeting.

Solid Waste and Fire One approved plans are included in the Site Plan set. Fire one plan must be signed and sealed by a professional licensed in the state of New Mexico.

Applicant Response: The Fire One plan has been stamped.

Check and demonstrate compliance with section 7 of the DPM, Table 7.2.29, regarding Sidewalk width requirements and its landscape buffer. See Table 7.2.29 marked up below for sites located in the Major Transit/ Premium Transit/Main Street inside Center zone. Section 7-2(D)(1) discusses the definitions for Pedestrian Realm including Frontage Zone, Sidewalks, and Landscape/Buffer Zone for your information.

For Major Transit/Premium Transit/Main Street inside Center, 10-12 feet sidewalk and 6-8 feet landscape buffer is required.

Planning defers to Transportation for review.

**Applicant Response**: Compliant, the Central Avenue frontage includes a 10-foot sidewalk with a 6-foot landscape buffer for projects within a Major Transit Corridor and within a Center.

Side Min/Max Setback: 0 ft. / Street side: 15 ft. / Provided: Confirm Compliance

Applicant Response: Compliant, see Site Plan.

In DT-UC-MS-PT areas, this use shall provide somewhere on the lot at least 1 tree per ground floor dwelling unit, in addition to meeting all applicable standards in Section 14- 16-5-6 (Landscaping, Buffering, and Screening). Calculations for required trees must be provided.

**Applicant Response:** Compliant, calculations for required trees are provided on the Landscape Plan.

4-3(B)(8)(d) At least 50 percent of the trees required by Subsection (b) or (c) above shall be deciduous canopy-style shade trees or coniferous trees capable of attaining a mature canopy diameter of at least 25 feet. Confirm compliance.

Applicant Response: Compliant, see Landscape Plan.

#### 5-3(D)(3)(b) Network of Pedestrian Walkways

Per 5-3(D)(3)(b) 4 c. Pedestrian walkways shall be installed along any street-facing façade with a pedestrian entrance of a building. Pedestrian walkways required by this Subsection shall meet the standards of the DPM, except where Table 5-3-1 requires a wider walkway.

Table 5-3-1: Required Walkway Width						
Building Size (sq. ft.) Minimum Walkway Width (f						
≤10,000	8					
>10,000 and ≤50,000	10					
>50,000 and ≤60,000	11					
>60,000 and ≤70,000	12					
>70,000 and ≤80,000	13					
>80,000 and ≤90,000	14					
>90,000	15					

**Applicant Response:** The building is 64,380 SF. The pedestrian walkway in front of the commercial spaces along Alcazar is 15 feet in depth and the walkway at the corner of Alcazar and Central is 20 feet in width.

Per 5-3(D)(3)(b) 4 d. The width of the required walkway may vary along the entire length of the façade provided that the average required width is maintained and provided that the width of the walkway along the façade is a minimum of 8 feet. Please confirm compliance with this code.

**Applicant Response:** The walkway along Central Avenue is 10 feet in width and the walkway along Alcazar varies in width from 5 feet to 20 feet.

 Table 5-1-1:

 Required parking spaces: 76 Parking reductions and credits: 46

Final total required parking spaces: 30 Provided parking spaces: 37 > 9 ADA, 3 compact, 5 on-street

ADA required: 2 / Provided: 9 EV ready required: 2 / Provided: 2 EV Compatible required: 6 / Provided:6 Motorcycle required: 2 / Provided: 3 Bicycle required: 4 / provided: 20 Planning defers to Code Enforcement to confirm that the project complies with these codes.

**Applicant Response:** Compliant, the parking calculations were slighting updated per the previous comment on the commercial use; calcs use the higher standard for commercial services.


5-6(C)(4)(l) In DT-UC-MS areas, landscaped areas other than street frontage shall include pedestrian furniture, pedestrian amenities, or trash receptacles to encourage pedestrian use. Confirm compliance

Applicant Response: Compliant, see Landscape Plan showing benches and trash receptacles.

Per 5-6(C)(5)(c), the use of gravel or crusher fines as ground cover is limited to 50 percent in DT-UC-MS areas. Please add proper calculations to demonstrate compliance with this code. Organic mulch around trees will count towards this item.

Applicant Response: Compliant, calculation was added to Landscape Plan.

5-6(C)(5)(e) Organic mulch is required as ground cover under trees, not including street trees, within a 5-foot radius around the tree trunk, but not directly against the trunk. In these areas, weed barrier fabric is prohibited. (See figure below.) Around street trees provide the organic mulch at a 5' radius as much as the space allows.

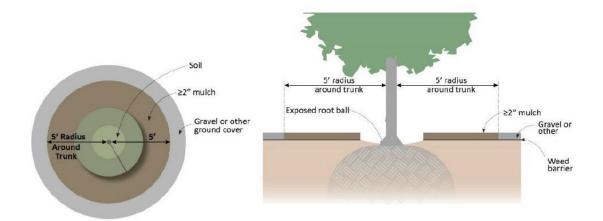

Applicant Response: Compliant, added to Landscape Plan.

Per 5-6(C)(5)(f), all landscaped areas shall be protected from vehicular encroachment by curbs or wheel stops located 2 feet outside the landscaped area, with openings to accommodate surface collection of stormwater runoff in vegetated swales and stormwater infiltration areas. Please provide more information regarding storm water run-off collection for this project.

**Applicant Response**: Gravel paving will be used in the on-site parallel parking area to provide storm water quality for this project. Curb cuts are also used in landscape areas where practical.

5-6(C)(7)(a) Vegetation required by this Section 14-16-5-6 shall be located the following distances in any direction from any fire hydrants, valve vaults, hose bibs, manholes, hydrants, and fire department connections:

Shrubs: 3 feet Trees: 15 feet Confirm Compliance **Applicant Response**: Compliant, see Landscape Plan. Hydrants are located at the northeast corner of the project and the gate area along Alcazar Street.

#### 5-6(C)(6) Minimum Plant Sizes at Installation

All vegetation required by this section 14-16-5-6 shall meet the minimum size requirements in Table 5-6-1 unless specified otherwise in this IDO. Confirm compliance

Applicant Response: Compliant, see Landscape Plan Plant Schedule.

#### 5-6(C)(8) Protecting Clear Sight Triangle

*Per* 5-6(*C*)(10)(*b*), trees shall not be planted within 10 feet in any direction of the centerline of a sewer or water line. (See figure below.) Please confirm compliance with this code. Confirm compliance

Applicant Response: Compliant, see Landscape Plan.

Per 5-6(C)(10)(c), trees or shrubs planted within utility easements shall comply with the standards of the utility provider to minimize effects on facilities maintenance and repair. Please confirm compliance with this code. Confirm compliance

Applicant Response: Compliant, see Landscape Plan, Note #3.

Per 5-6(C)(10)(d), if overhead distribution electric lines are present and large trees cannot be planted due to potential interferences with the electric lines, one ornamental tree with a mature height of 12 feet shall be planted per 20 feet of street frontage. New trees planted near electric transmission lines shall be no taller than 25 feet in height at maturity to avoid conflicts with existing electric facilities. Consider alternating the trees in this area to avoid loss of all trees due to potential future disease. Pink Pom Poms redbud, Paul's Scarlet Hawthorne, and Goldenrain tree are suggested by the City Forester for these areas.

Applicant Response: Compliant. Revised Landscape Plan includes Pink Pom-Pom Redbud along Central Avenue.

Per 5-6(C)(10)(e), all screening and vegetation surrounding ground-mounted transformers and utility pads must allow 10 feet of clearance for access and to ensure the safety of the work crews and public during maintenance and repair. Please confirm compliance with this code. Please confirm the location of this transformer.

**Applicant Response**: Compliant, two transformers are shown on the Site Plan (see Keyed Note #39). Access to the transformers is from the drive aisle.

*Per* 5-6(*C*)(10)(*f*), trees shall not be planted near existing or proposed street light poles. 15 feet of clearance is required. Please confirm compliance with this code.

Applicant Response: Compliant. Revised locations shown on Landscape Plan.

#### 5-6(C)(12) Existing Vegetation Credit

#### Please confirm whether or not any existing vegetation will be maintained.

Applicant Response: No existing vegetation will be maintained.

#### 5-6(C)(13) Stormwater Management Features

Per 5-6(C)(13)(a), required landscape and buffer areas shall be designed to serve as stormwater management areas to the maximum extent practicable and consistent with their required locations and vegetation. Please articulate how this project has considered this code.

**Applicant Response**: Stormwater is directed to pervious parking area. Excess run-off is directed through a swale in the landscape buffer area to a detention pond located at the south end of the site. Landscape buffer will be depressed per City of Albuquerque Standard Drawing #2414. Note is added to the Site Plan.

5-6(D)(1)(c) Planting areas necessary for trees in the street frontage shall meet the minimum size requirements in Table 5-6-3 unless specified otherwise in this IDO. Tree grates may be used in constrained locations to accommodate pedestrian circulation, to allow the required planting areas to have a walkable surface.

Table 5-6-3: Minimum Planting Area by Tree Height at Maturity					
Tree Height at Maturity (ft.)	Minimum Planting Area (ft.)				
0-20	4 x 4				
>20-40	5 x 5				
>40	6 x 6				

#### *Confirm compliance*

**Applicant Response**: Compliant. Trees taller than 40 feet include Burr Oak, which has a minimum planting area of 6 feet. Trees between 20 and 40 feet in height include Chinese Pistache, Lacebark Elm, Box Elder, and Western Huckberry, which has a minimum planting width of 5 feet. Trees with a height of 20 feet or smaller include New Mexico Olive, Chaste Tree, Desert Willow, Oklahoma Texas Redbud, and Eastern Redbud, which have a minimum planning area of 4 feet. (see Landscape Plan Plant Schedule).

Per 5-6(D)(2)(b) **Downtown, Urban Centers, and Main Street and Premium Transit areas** Fifty(50) percent of any front setback area not used for pedestrian access to the building or improved with pedestrian furniture and amenities shall be landscaped, and no part of the front setback area surface shall be asphalt. (See figure below.)



50% of front setback area not used for pedestrian access or pedestrian furniture and amenities shall be landscaped

#### Confirm compliance.

Applicant Response: Compliant, see Landscape Plan.

#### 5-6(G)(2) Ground-mounted Mechanical Equipment

Per 5-6(G)(2)(a), R-ML, R-MH, and Mixed-use Zone Districts, outdoor ground-mounted mechanical equipment shall be located where it is not visible from streets, City parks or trails, Major Public Open Space, or major arroyos adjacent to the lot or from adjacent properties to the maximum extent practicable. Confirm compliance

**Applicant Response**: Compliant, the project does not contain ground-mounted mechanical equipment.

#### 5-6(G)(2)(d) Loading, Service, and Refuse Areas

Per 5-6(G)(3)(a) Covering Waste Containers, all waste containers and dumpsters shall be in a roofed enclosure or be equipped with and use a lid covering and shall be designed so that stormwater runoff does not reach storm drain inlets. Confirm compliance

**Applicant Response**: Compliant, refuse containers are roll-out bins with lids. Details for refuse containers are provided on Sheet SP3.

#### LANDSCAPING and IRRIGATION NOTES

**Applicant Response**: All of the cited notes for landscaping and Irrigation notes were on the original submitted Landscape Plan.

#### 5-11 BUILDING DESIGN

# For heat mitigation along west-facing facade, more awnings are required especially for the second and third floors.

**Applicant Response**: Aluminum awnings over bedroom windows were added to the fourth floor, maintaining the rhythm of the awnings on the lower floors (see Elevation Sheet SP-8).

#### 5-11(E)(2)(b) Urban Centers, Activity Centers, and Main Street and Premium Transit Areas


1. In new residential and mixed-use development, windows on the upper floors shall be recessed not less than 2 inches. Confirm Compliance. Note must be added to the elevation sheets.

**Applicant Response**: Note e. under General Sheet Notes on the elevation sheet states that upper floor windows are recessed a minimum of 2 inches.

*b.* For commercial or office uses, interior space must be visible to a depth of 6 feet from the façade. Confirm compliance

**Applicant Response**: Compliant, the interior spaces of commercial and office uses are visible to a depth of at least 6 feet from the façade.


Thank you for your consideration and review of the project. Please do not hesitate to contact me with any questions.

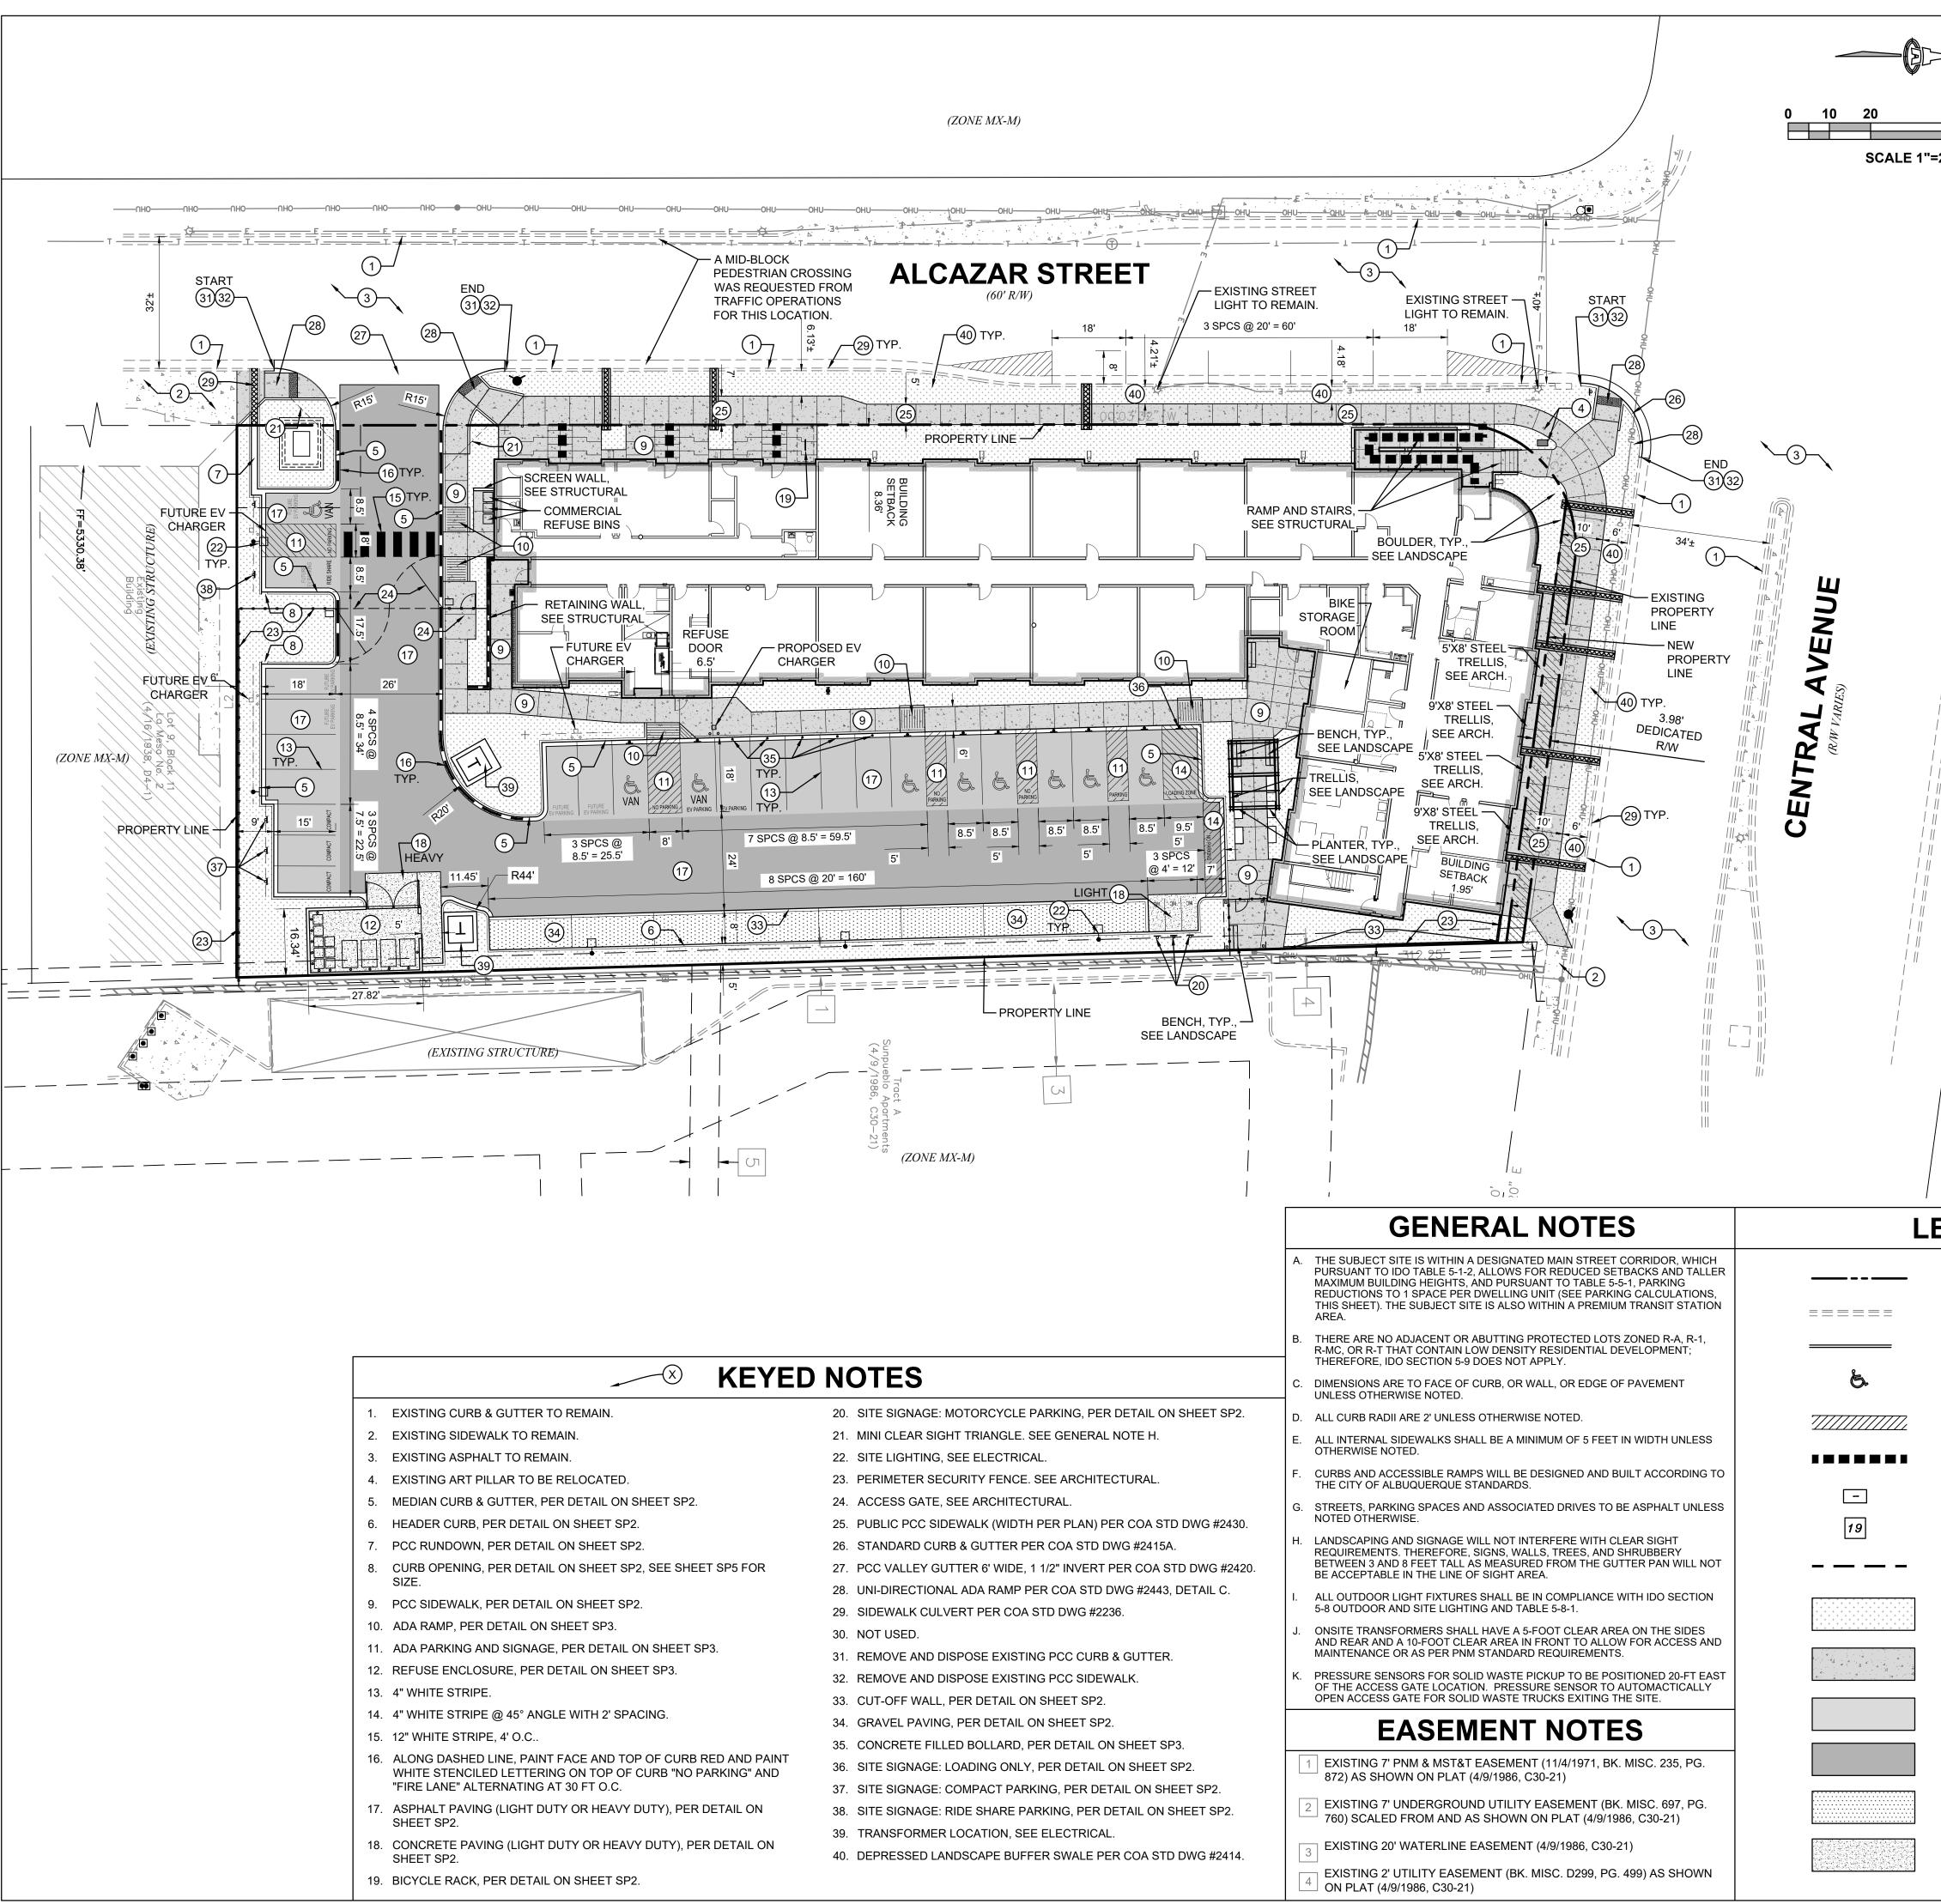

4			
1.	EXISTING CURB & GUTTER TO REMAIN.		SITE SIGNAG
2.	EXISTING SIDEWALK TO REMAIN.		MINI CLEAR
3.	EXISTING ASPHALT TO REMAIN.		SITE LIGHTIN
4.	EXISTING ART PILLAR TO BE RELOCATED.		PERIMETER
5.	MEDIAN CURB & GUTTER, PER DETAIL ON SHEET SP2.	24.	ACCESS GA
5.	HEADER CURB, PER DETAIL ON SHEET SP2.	25.	PUBLIC PCC
<b>7</b> .	PCC RUNDOWN, PER DETAIL ON SHEET SP2.	26.	STANDARD (
3.	CURB OPENING, PER DETAIL ON SHEET SP2, SEE SHEET SP5 FOR	27.	PCC VALLEY
	SIZE.	28.	UNI-DIRECTI
•	PCC SIDEWALK, PER DETAIL ON SHEET SP2.	29.	SIDEWALK C
	ADA RAMP, PER DETAIL ON SHEET SP3.	30.	NOT USED.
	ADA PARKING AND SIGNAGE, PER DETAIL ON SHEET SP3.	31.	REMOVE AN
2.	REFUSE ENCLOSURE, PER DETAIL ON SHEET SP3.	32.	REMOVE AN
3.	4" WHITE STRIPE.	33.	CUT-OFF WA
4.	4" WHITE STRIPE @ 45° ANGLE WITH 2' SPACING.	34.	GRAVEL PA
5.	12" WHITE STRIPE, 4' O.C	35.	CONCRETE I
6.	ALONG DASHED LINE, PAINT FACE AND TOP OF CURB RED AND PAINT WHITE STENCILED LETTERING ON TOP OF CURB "NO PARKING" AND "FIRE LANE" ALTERNATING AT 30 FT O.C.	36.	SITE SIGNAC
7			SITE SIGNAG
1.	ASPHALT PAVING (LIGHT DUTY OR HEAVY DUTY), PER DETAIL ON SHEET SP2.		SITE SIGNAG
18.	CONCRETE PAVING (LIGHT DUTY OR HEAVY DUTY), PER DETAIL ON		TRANSFORM
	SHEET SP2.	40.	DEPRESSED
9.	BICYCLE RACK, PER DETAIL ON SHEET SP2.		

	C.O.A. VICINITY MAP K-19-Z		tants t NE 7108	com
40 60 20'		1& 500 Arfman Ir	Civil Engineering Consultants 128 Monroe Street NE Albuquerque, NM 87108	-268-8828   www.iacivil.com
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NOTE: ALL BROKEN OR CRACKED SIDEWALK MUST BE	ZONING:MX-MBUILDING CALCULATIONS:GROSS FLOOR AREA (GFA)=64,380 SF ± 1-BEDROOM UNITS= 70 LEASING OFFICE= 500 SF COMMERCIAL SERVICE, COMMERCIAL RETAIL, OR A COMBINATION OF BOTH. THEREFORE, THE PARKING CALCULATION USED BELOW IS BASED ON COMMERCIAL SERVICES, WHICH REQUIRES MORE PARKING THAN COMMERCIAL RETAIL.OPEN SPACE CALCULATIONS: $UC-MS-PT$ OPENSPACE REQUIREMENTS 225 SQUARE FEET x 1 BED= 15,750 SF 50% MAIN STREET CORRIDOR REDUCTION=7,875 SFREQUIRED:7,875 SF PROVIDED:10.853 SFPARKING CALCULATIONS: $UC-MS-PT$ PARKING REQUIREMENTS 70 1-BR x 1 SPACE PER DWELLING UNIT = 70 500 SF LEASING OFFICE x 2.5 SPACES/1,000 SF GFA= 3 1,700 SF COMMERCIAL x 3 SPACES/1,000 SF GFA= 5 REQUIRED SUBTOTAL = 785-5(C)(6)PARKING REDUCTION S-5(C)(6)(a) 2 EV CHARGING STATION x 2 SPACES = 4 SPACES S-5(C)(6)(a) 2 EV CHARGING STATION x 2 SPACES = 4 SPACES S-5(C)(6)(a) 2 EV CHARGING STATION x 4 SPACES = 4 SPACES S-5(C)(6)(a) 2 EV CHARGING STATION x 4 SPACES = 4 SPACES S-5(C)(6)(a) 2 EV CHARGING STATION x 4 SPACES = 4 SPACES S-5(C)(6)(a) 2 EV CHARGING STATION x 2 SPACES = 4 SPACES S-5(C)(6)(a) 2 EV CHARGING STATION x 2 SPACES = 4 SPACES S-5(C)(6)(a) 2 EV CHARGING STATION x 4 SPACES = 4 SPACES S-5(C)(6)(a) 2 EV CHARGING STATION x 2 SPACES = 4 SPACES S-5(C)(6)(a) 2 EV CHARGING STATION x 2 SPACES = 4 SPACES S-5(C)(6)(a) 2 EV CHARGING STATION x 2 SPACES = 4 SPACES S-5(C)(6)(a) 2 EV CHARGING STATION X 2 SPACES = 4 SPACES S-5(C)(6)(a) 2 EV CHARGING STATION x 2 SPACES = 4 SPACES S-5(C)(6)(a) 2 EV CHARGING STATION x 2 SPACES = 4 SPACES S-5(C)(6)(a) 2 EV CHARGING STATION X 2 SPACES = 4 SPACES S-5(C)(6)(a) 2 EV CHARGING STATION X 2 SPACES = 4 SPACES S-5(C)(6)(a) 2 EV CHARGING STATION X 2 SPACES = 4 SPACES S-5(C)(6)(a) 2 EV CHARGING STATION X 2 SPACES = 4 SPACES S-	SOMOS	7200 CENTRAL AVE. SE ALBUQUERQUE, 87108	
REPLACED WITH SIDEWALK AND CURB & GUTTER. EGEND PROPERTY LINE EXISTING CURB AND GUTTER PROPOSED CURB	ADA REQUIRED: 2 SPACES (1 VAN SPACE) (PER 26-50 REQUIRED PARKING) ADA PROVIDED: 9 SPACES (3 VAN SPACES) EV READY REQUIRED: 2 SPACES (5% OF REQUIRED PARKING) EV READY PROVIDED: 2 SPACES EV CAPABLE REQUIRED: 6 SPACES (15% OF REQUIRED PARKING) EV CAPABLE PROVIDED: 6 SPACES MOTORCYCLE REQUIRED: 2 SPACES (PER 26-50 REQUIRED PARKING) MOTORCYCLE PROVIDED: 3 SPACES BICYCLE REQUIRED: 4 SPACES (10% OF REQUIRED PARKING) BICYCLE PROVIDED: 20 SPACES (18 SPACES INTERIOR, 2 SPACES EXTERIOR). PROJECT NO: PR-2024-0110784 APPLICATION NO: SI-2024-01164	NOT FOR CONSTRUCTION ISSUE: DFT SUBMITTAL	PROJECT IA 2682 NUMBER: IA 2682 FILE: 2682 CP-101 - DFT.dwg DRAWN BY: CHECKED BY:	DATE: 07/03/2024
ADA SPACE PEDESTRIAN CROSSWALK ADA PATHWAY BIKE RACK	IS AN APPROVED INFRASTRUCTURE LIST REQUIRED? [ ] YES [ x ] NO IF YES, THEN A SET OF APPROVED DRC PLANS WITH A WORK ORDER IS REQUIRED FOR ANY CONSTRUCTION WITHIN PUBLIC RIGHT OF WAY OR FOR CONSTRUCTION OF PUBLIC IMPROVEMENTS. DFT SITE DEVELOPMENT PLAN APPROVAL	Description DFT Comments		
PARKING COUNT FIRELANE (RED) "NO PARKING"	TRAFFIC ENGINEERING, DATE TRANSPORTATION DIVISION	Date 09-03-24		
LANDSCAPE AREA SEE LANDSCAPE PLANS	ABCWUA DATE PARKS & RECREATION DEPARTMENT DATE	ਟ ← SHEET		
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HEAVY ASPHALT PAVING SECTION GRAVEL PAVING SECTION	*ENVIROMENTAL HEALTH (CONDITIONAL) DATE	SHFFT		
CONCRETE PAVING SECTION	SOLID WASTE MANAGEMENT     DATE       PLANNING DEPARTMENT     DATE		SP1	



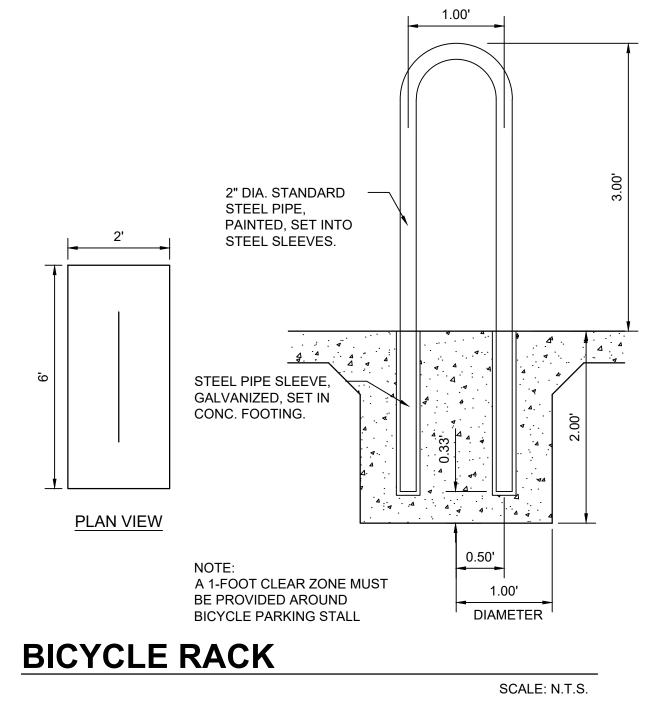

# MEDIAN CURB AND GUTTER

- 4. EDGES NOT SPECIFICALLY DIMENSIONED SHALL BE EDGED WITH A 3/8" RADII
- EXPANSION JOINTS @ 48' O.C., CURB RETURNS AND EACH SIDE OF DRIVES.


- CONTRACTION / CONTROL JOINTS @ 6' O.C. MAX.
- GENERAL NOTES 1. REQUIRES FULL FORM ON ALL FACES.
- SEE PAVING SECTION


1'-6"

11"

1"

- **ALLEY GUTTER**
- 3/8" RADII AT ALL EXPOSED EDGES.
- 3. FINISHED EDGE OF ASPHALT PAVING TO BE 1/2" ABOVE EDGE OF CONCRETE (TYP).
- SIDE OF DRIVES.
- 1. SEALED CONTRACTION / CONTROL JOINTS @ 6' MAX. 1/2" SEALED EXPANSION JOINTS 48' O.C., CURB RETURNS AND EACH
- GENERAL NOTES

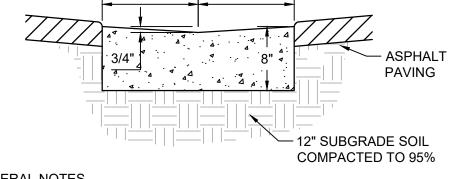

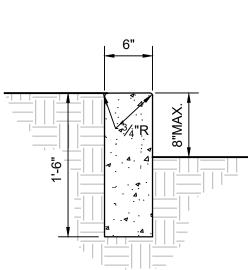

1. CONTRACTION / CONTROL JOINTS @ 6' MAX.

2. 1/2" EXPANSION JOINTS 24' O.C.

**HEADER CURB** 


3. REQUIRES FULL FORM ON ALL FACES.


4. 3/8" RADII AT ALL EXPOSED EDGES.

# **GENERAL NOTES**

SCALE: N.T.S.

SCALE: N.T.S.

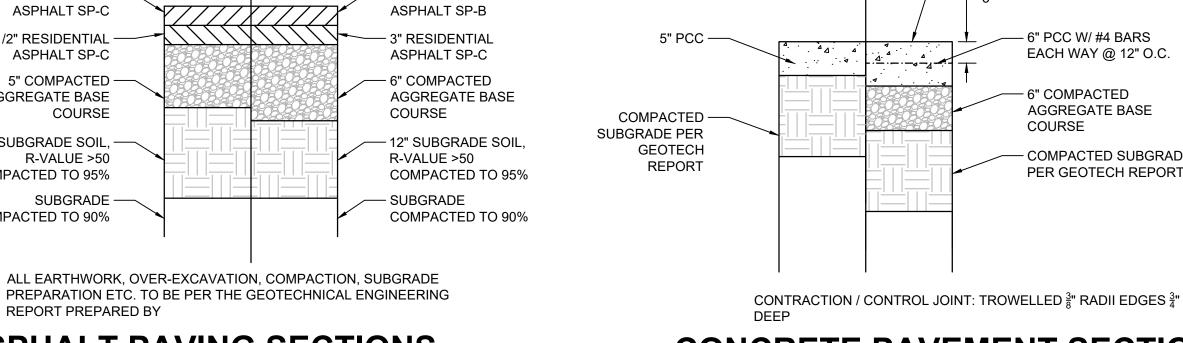

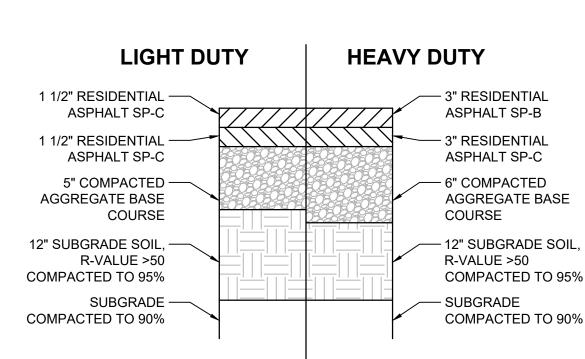

ALL EARTHWORK, OVER-EXCAVATION, COMPACTION, SUBGRADE

**ASPHALT PAVING SECTIONS** 

REPORT PREPARED BY

## LIGHT DUTY

## **HEAVY DUTY**


JOINT PATTERN.

> 6" PCC W/ #4 BARS EACH WAY @ 12" O.C.


- 6" COMPACTED AGGREGATE BASE COURSE

COMPACTED SUBGRADE PER GEOTECH REPORT

**CONCRETE PAVEMENT SECTION** SCALE: N.T.S.

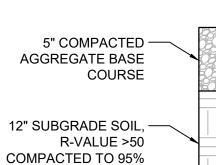


SUBGRADE -COMPACTED TO 90%

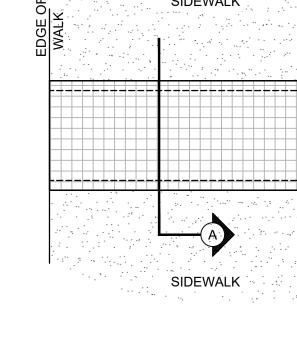

# **GRAVEL PAVING SECTION**

SCALE: N.T.S.

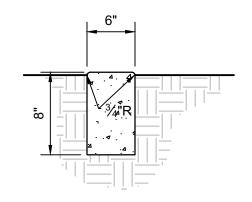

## GENERAL NOTES

1. CONTRACTION / CONTROL JOINTS @ 6' MAX.

- 2. 1/2" EXPANSION JOINTS 24' O.C.
- 3. REQUIRES FULL FORM ON ALL FACES.
- 4. 3/8" RADII AT ALL EXPOSED EDGES.





SCALE: N.T.S.

2" WIDE STROKES


PAINT SOLID -


WHITE

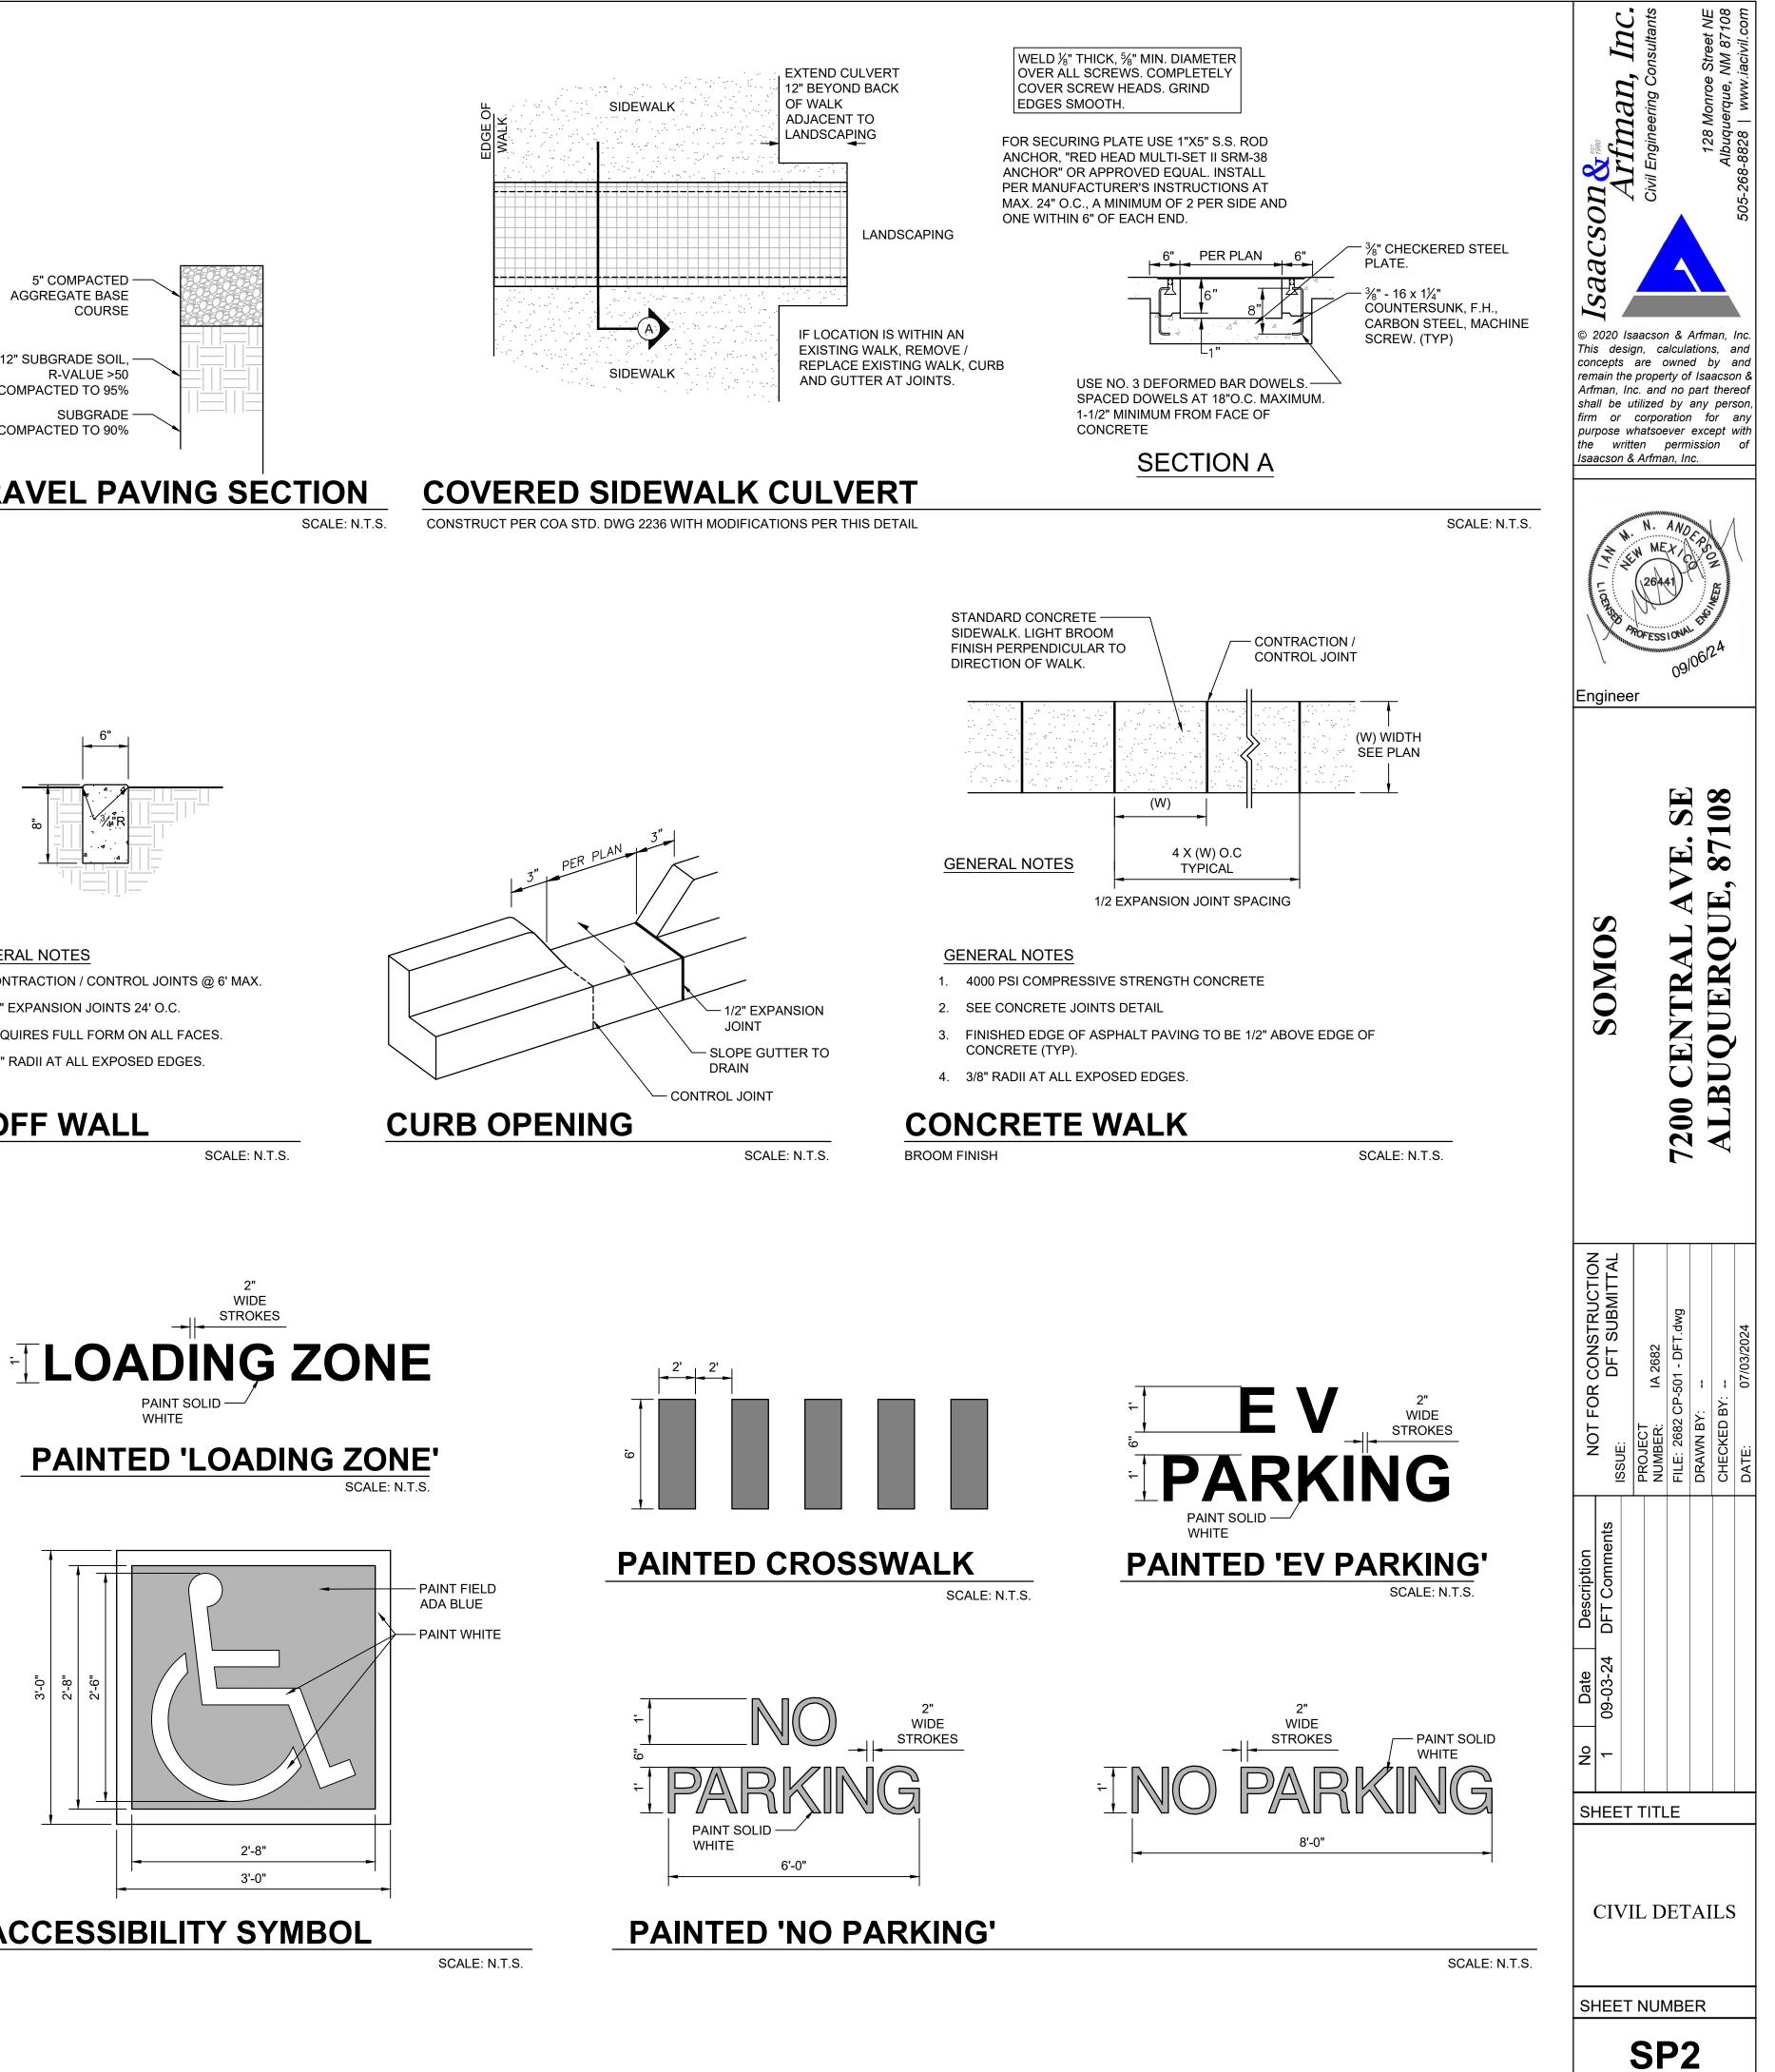


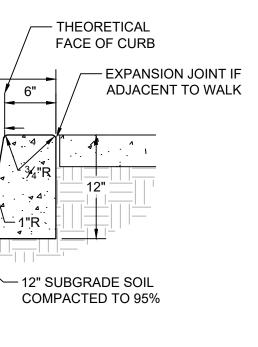


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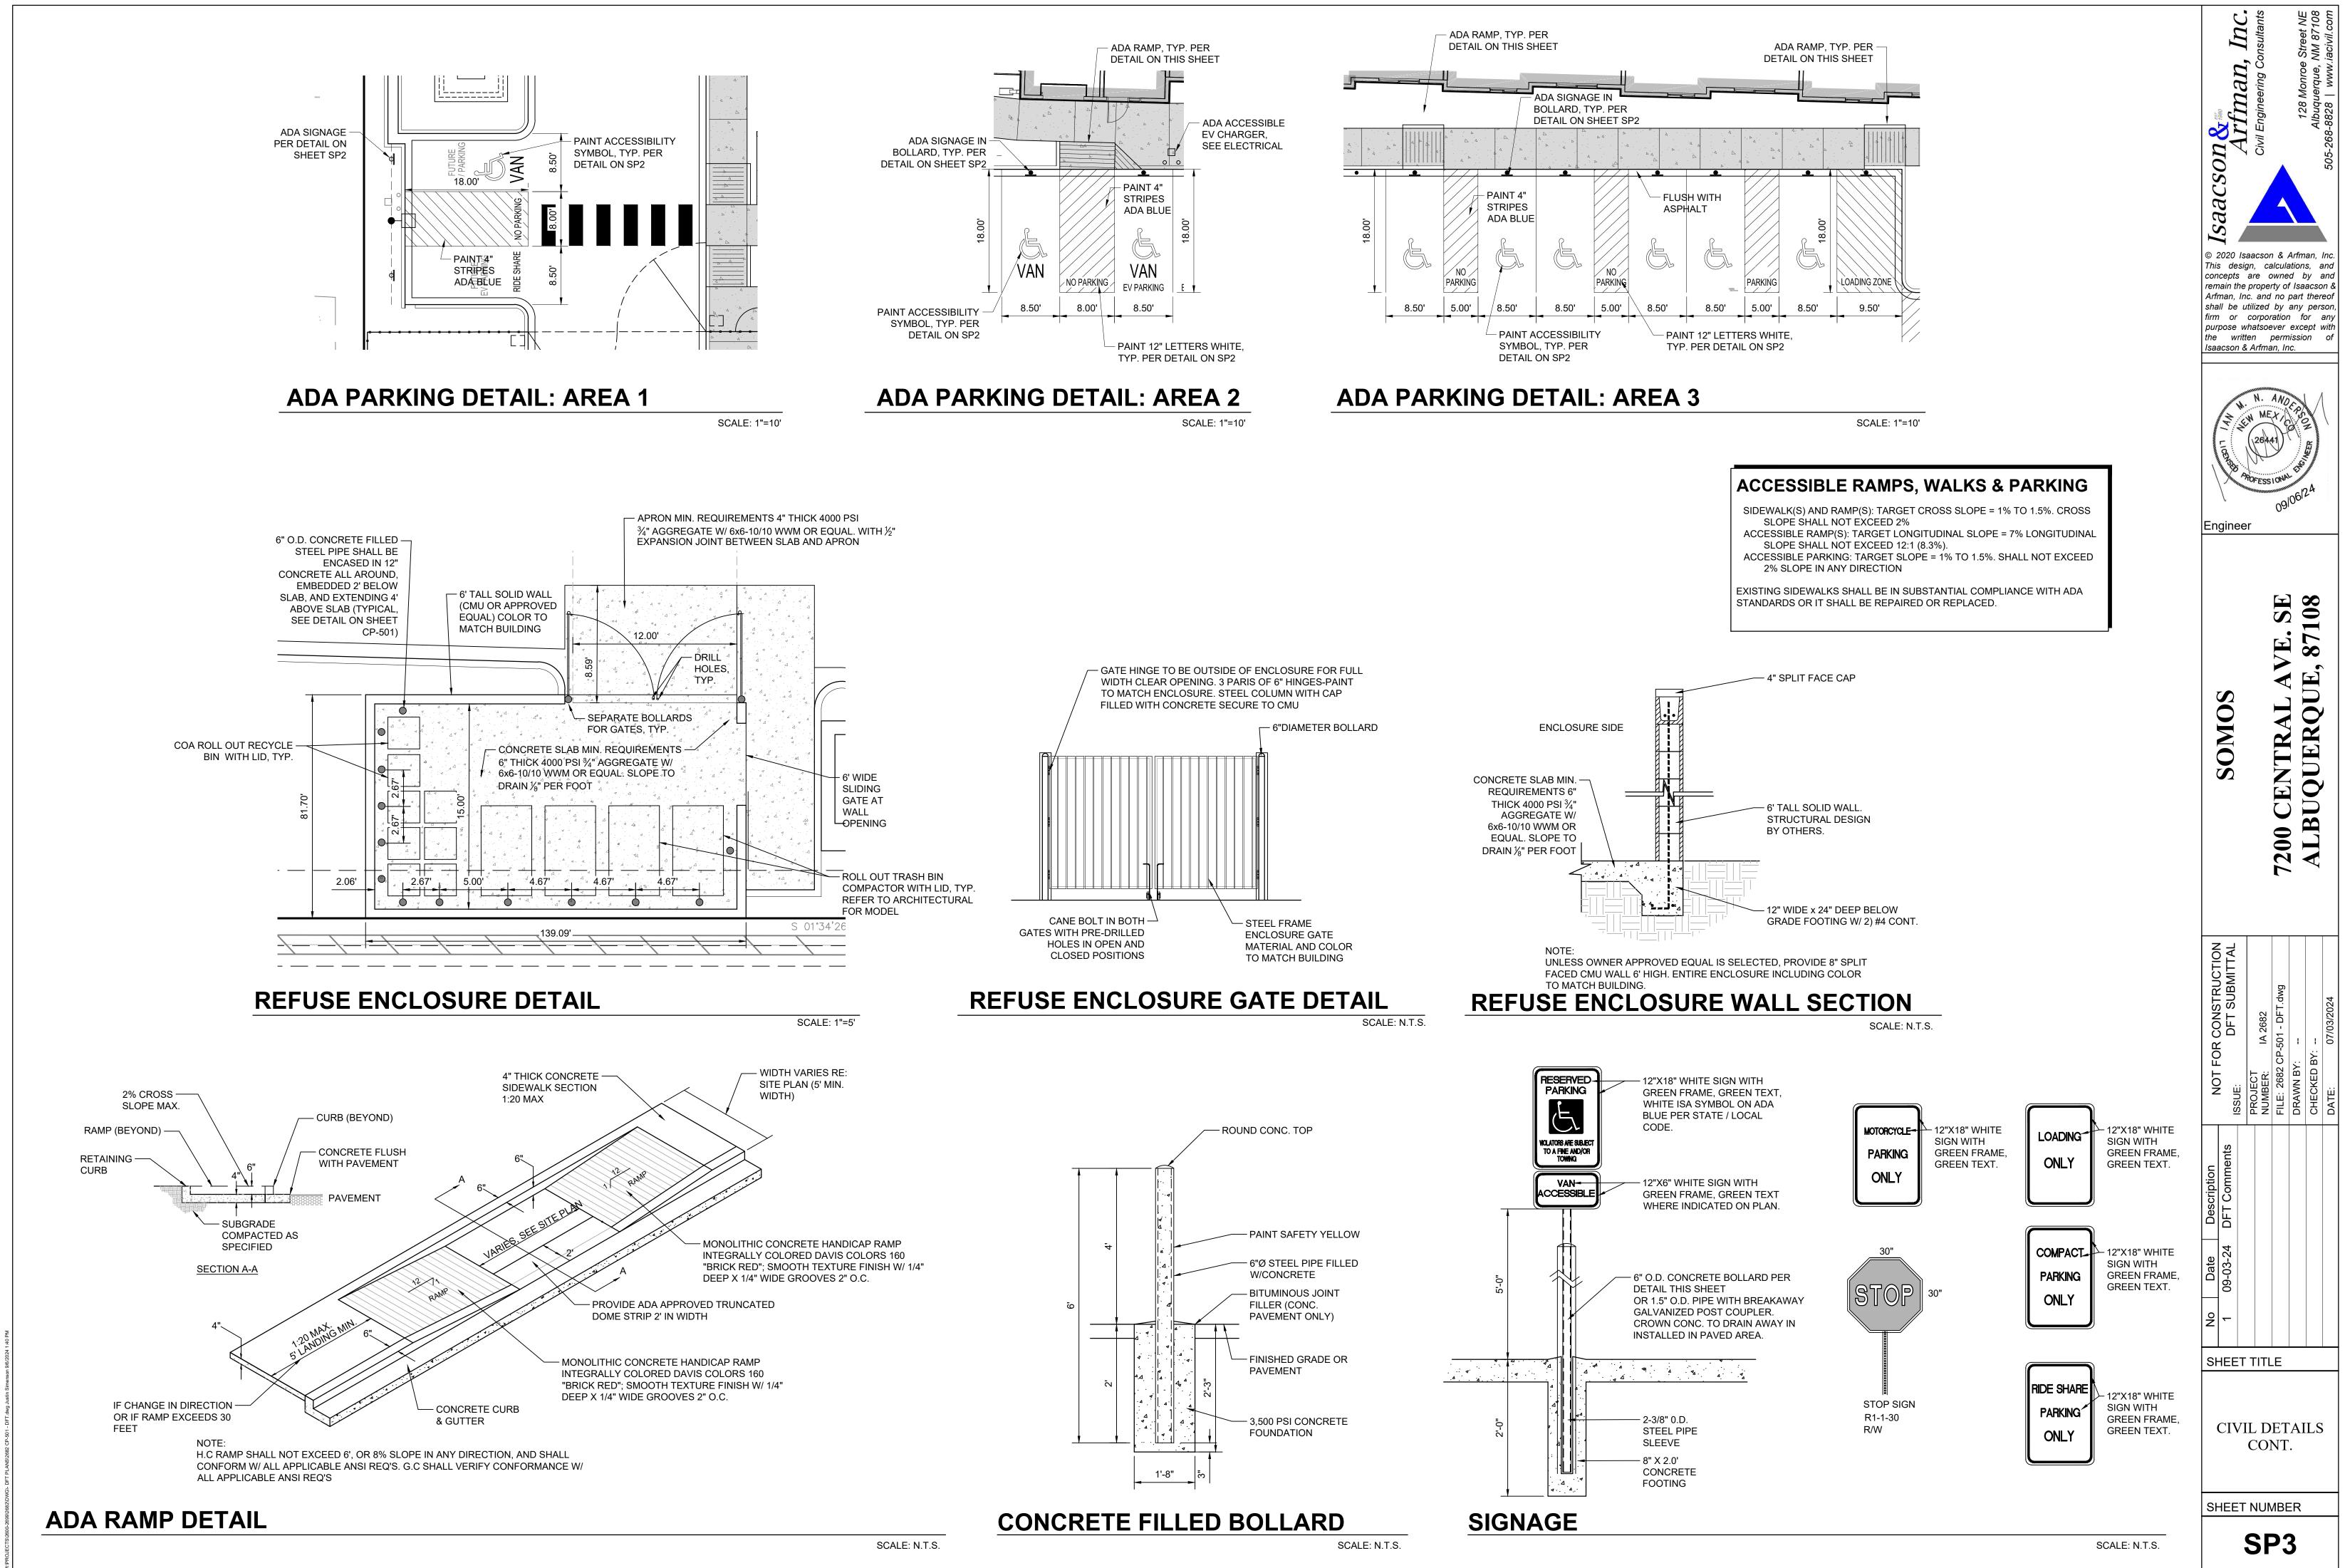


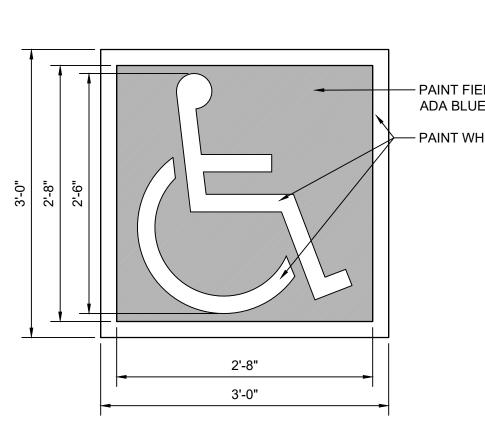


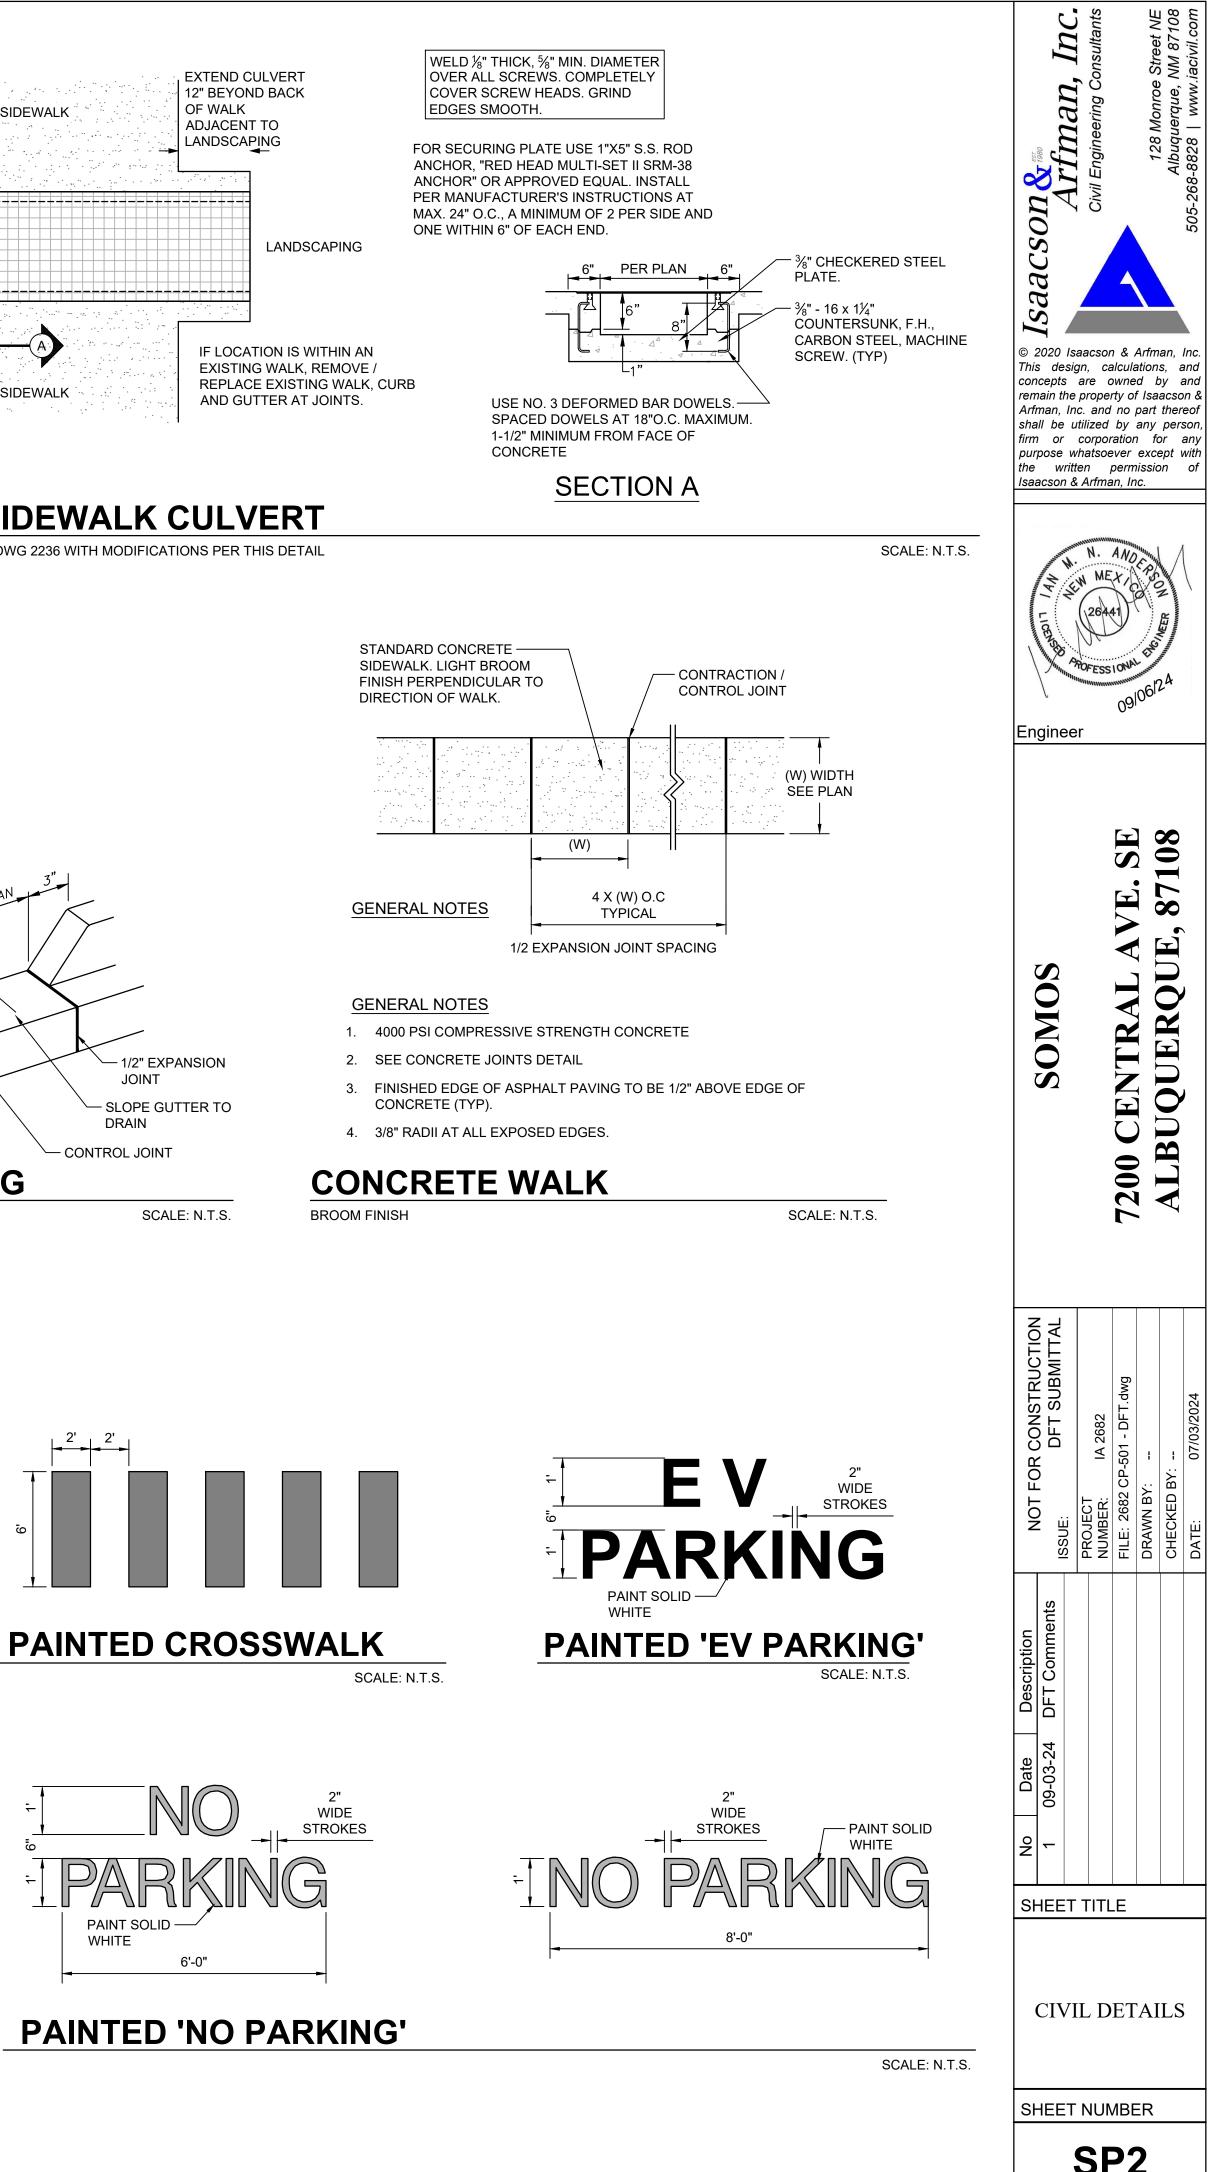

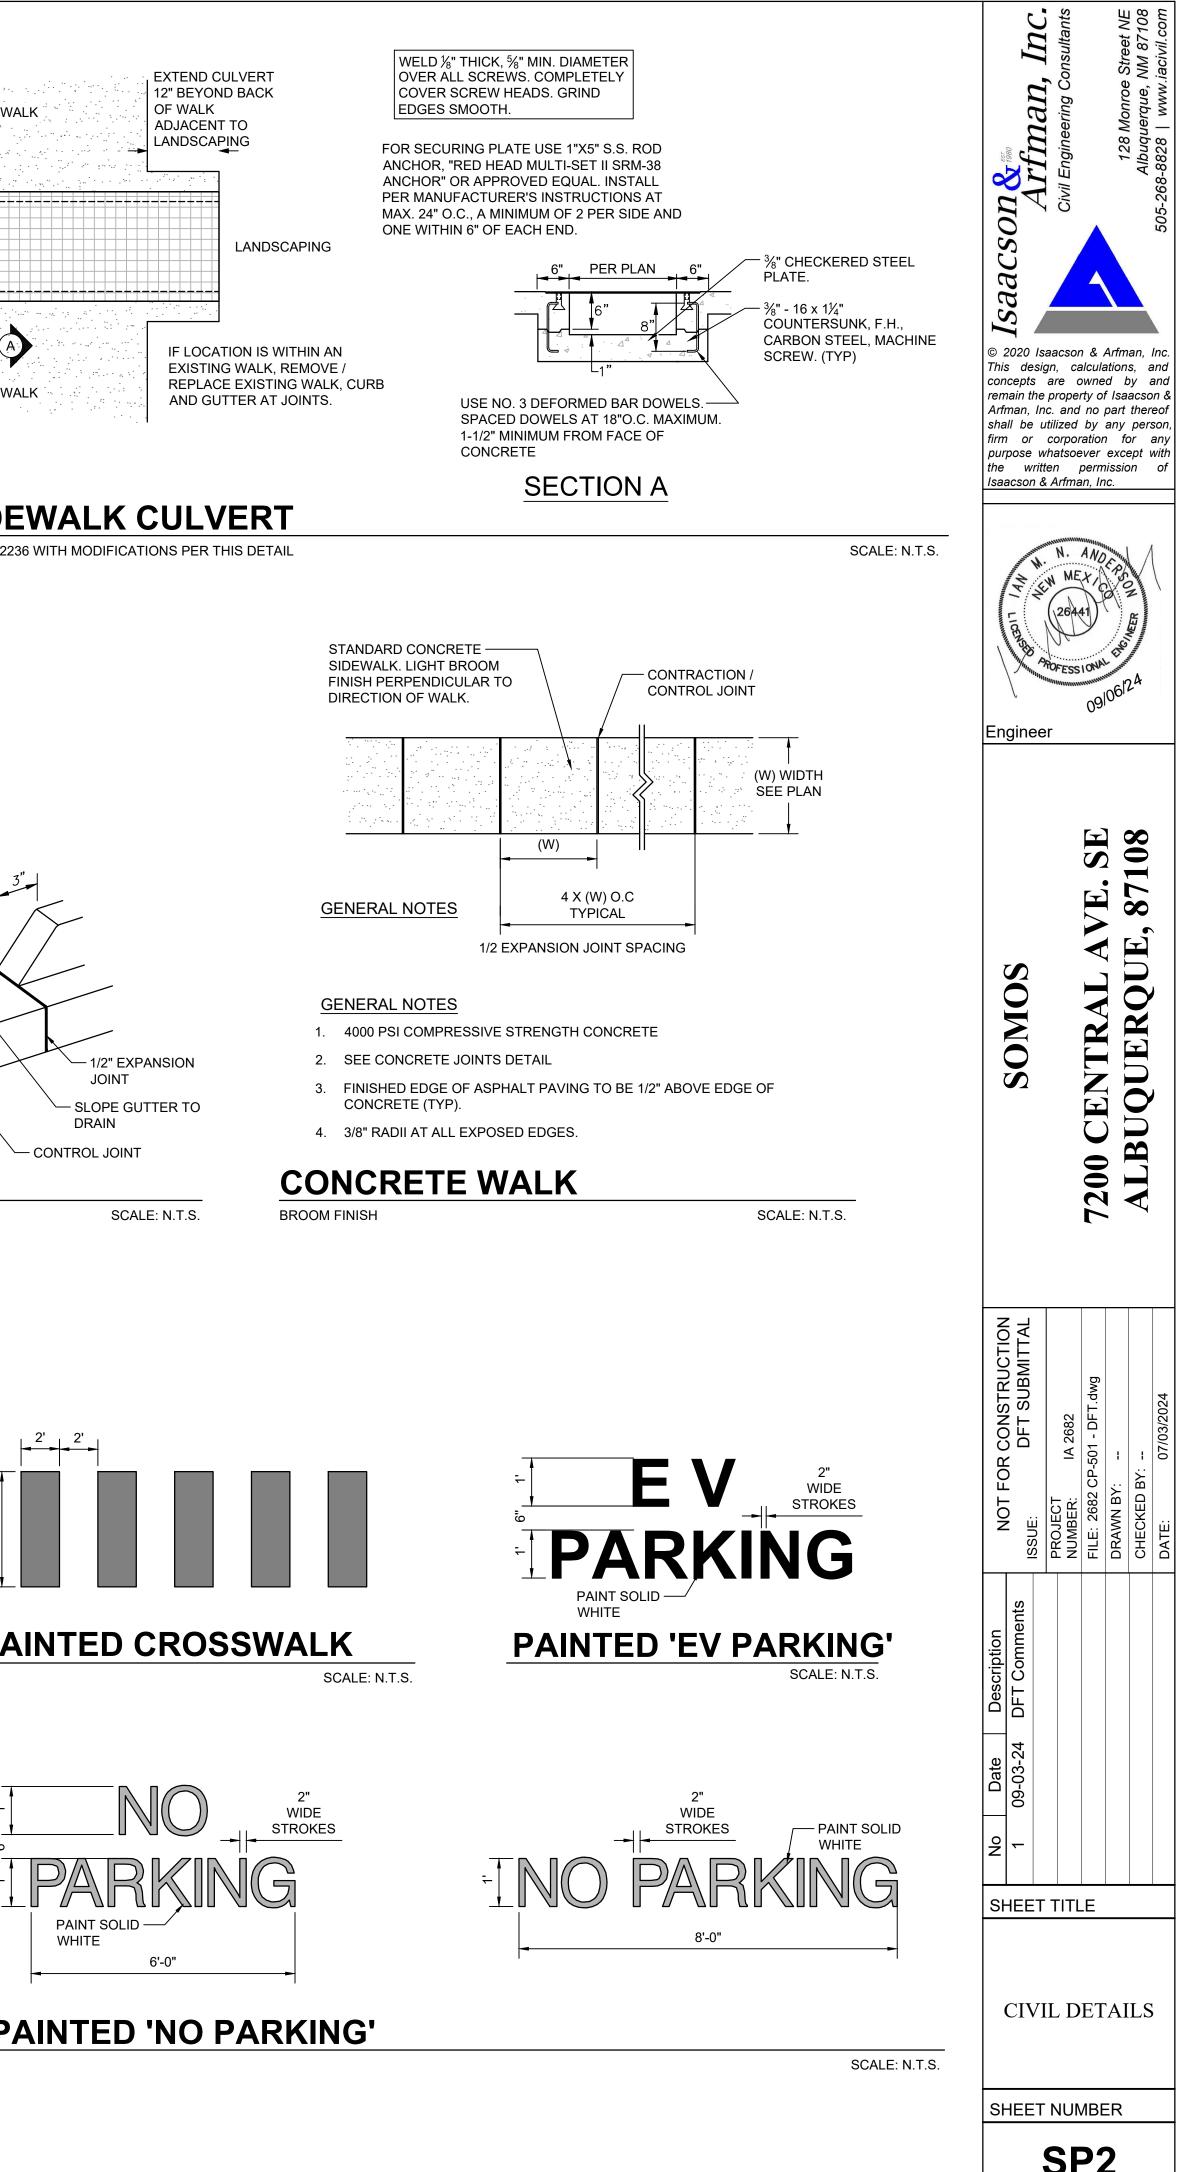

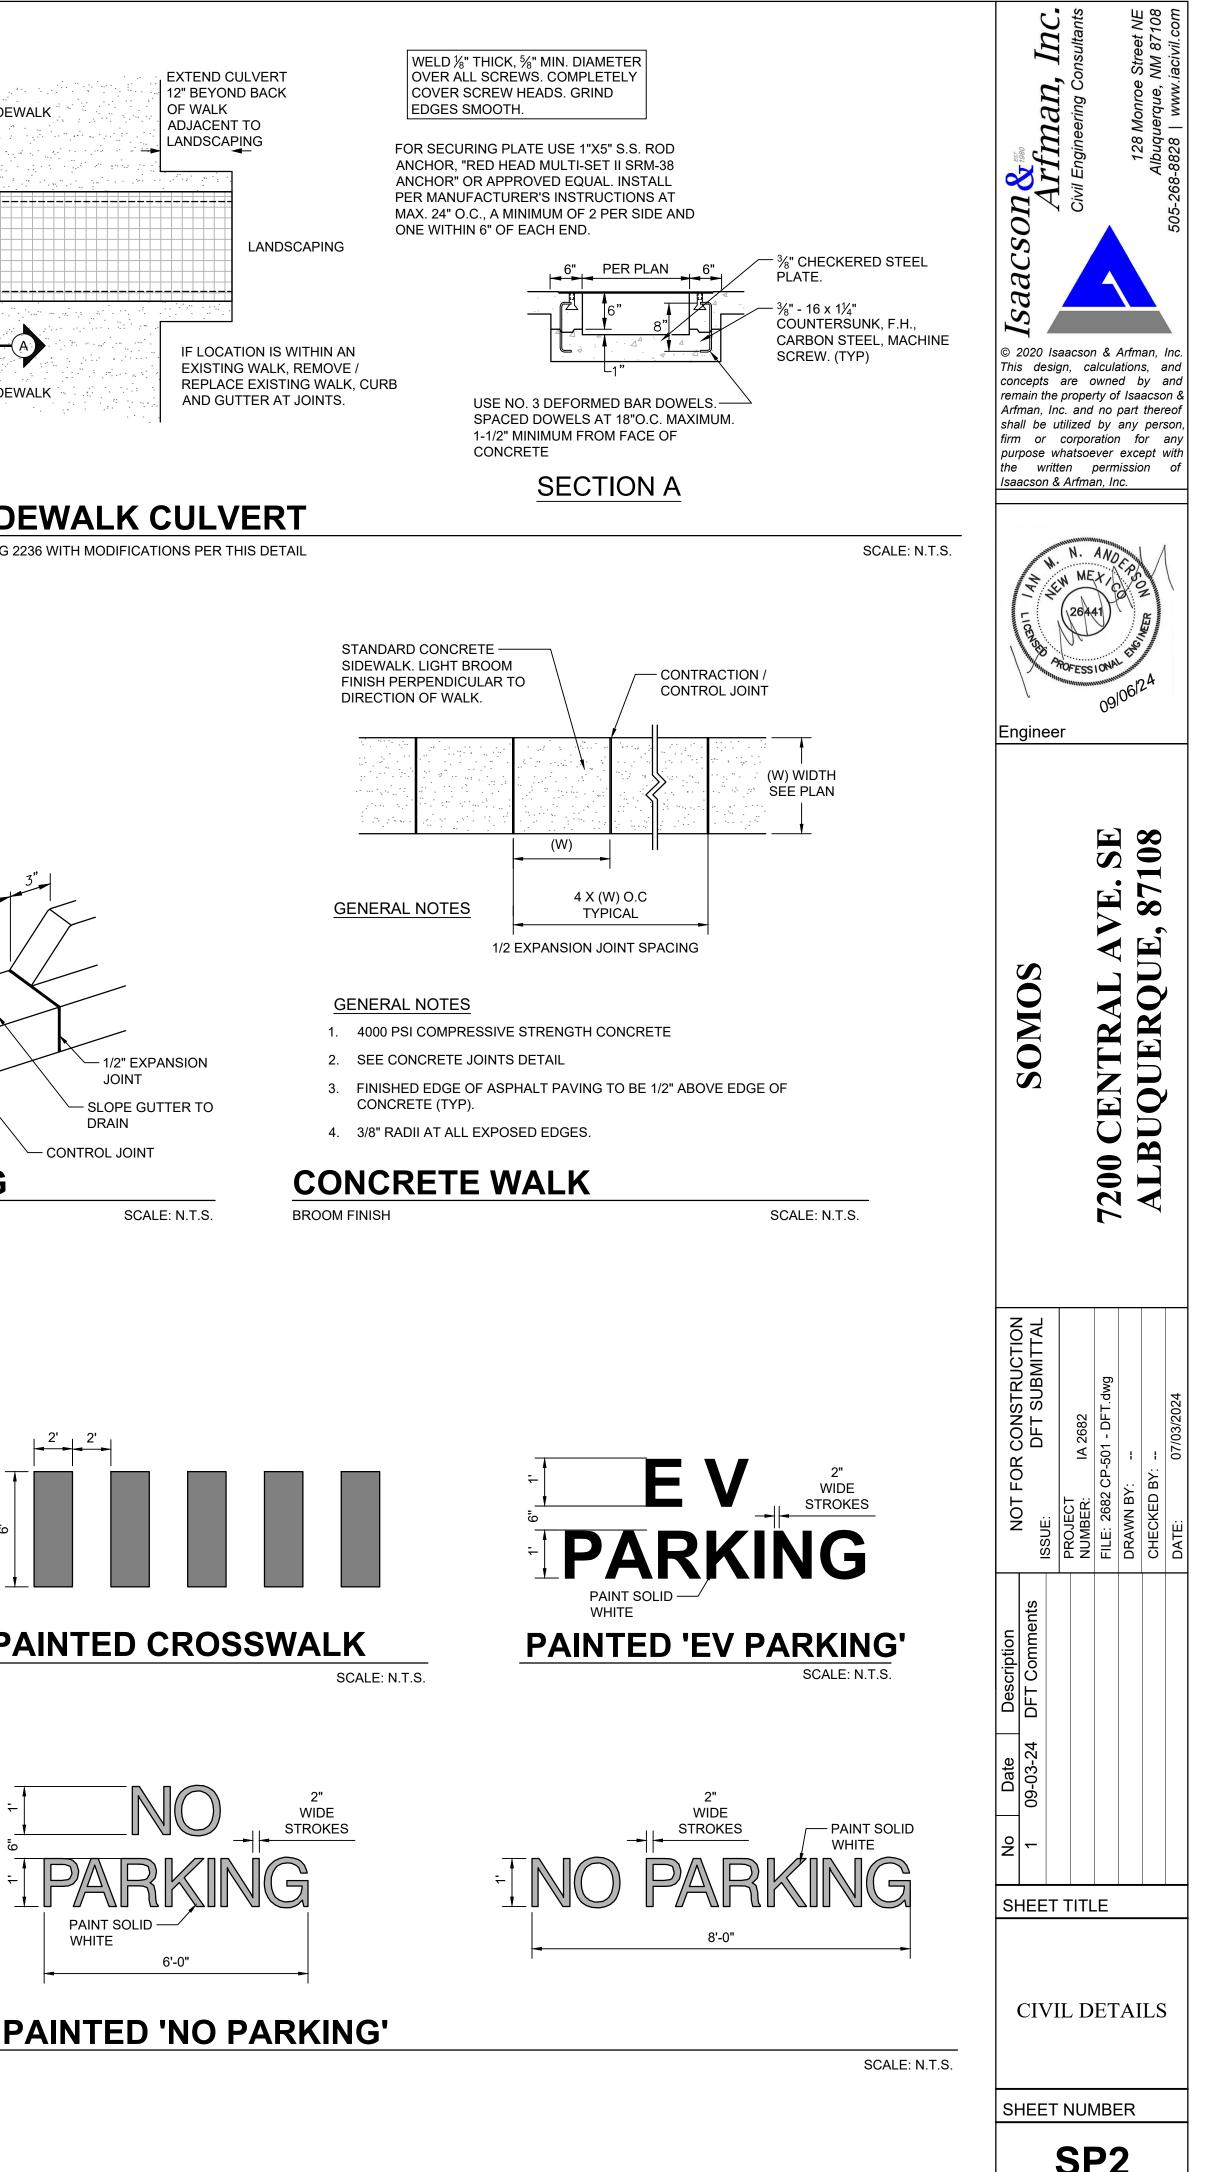



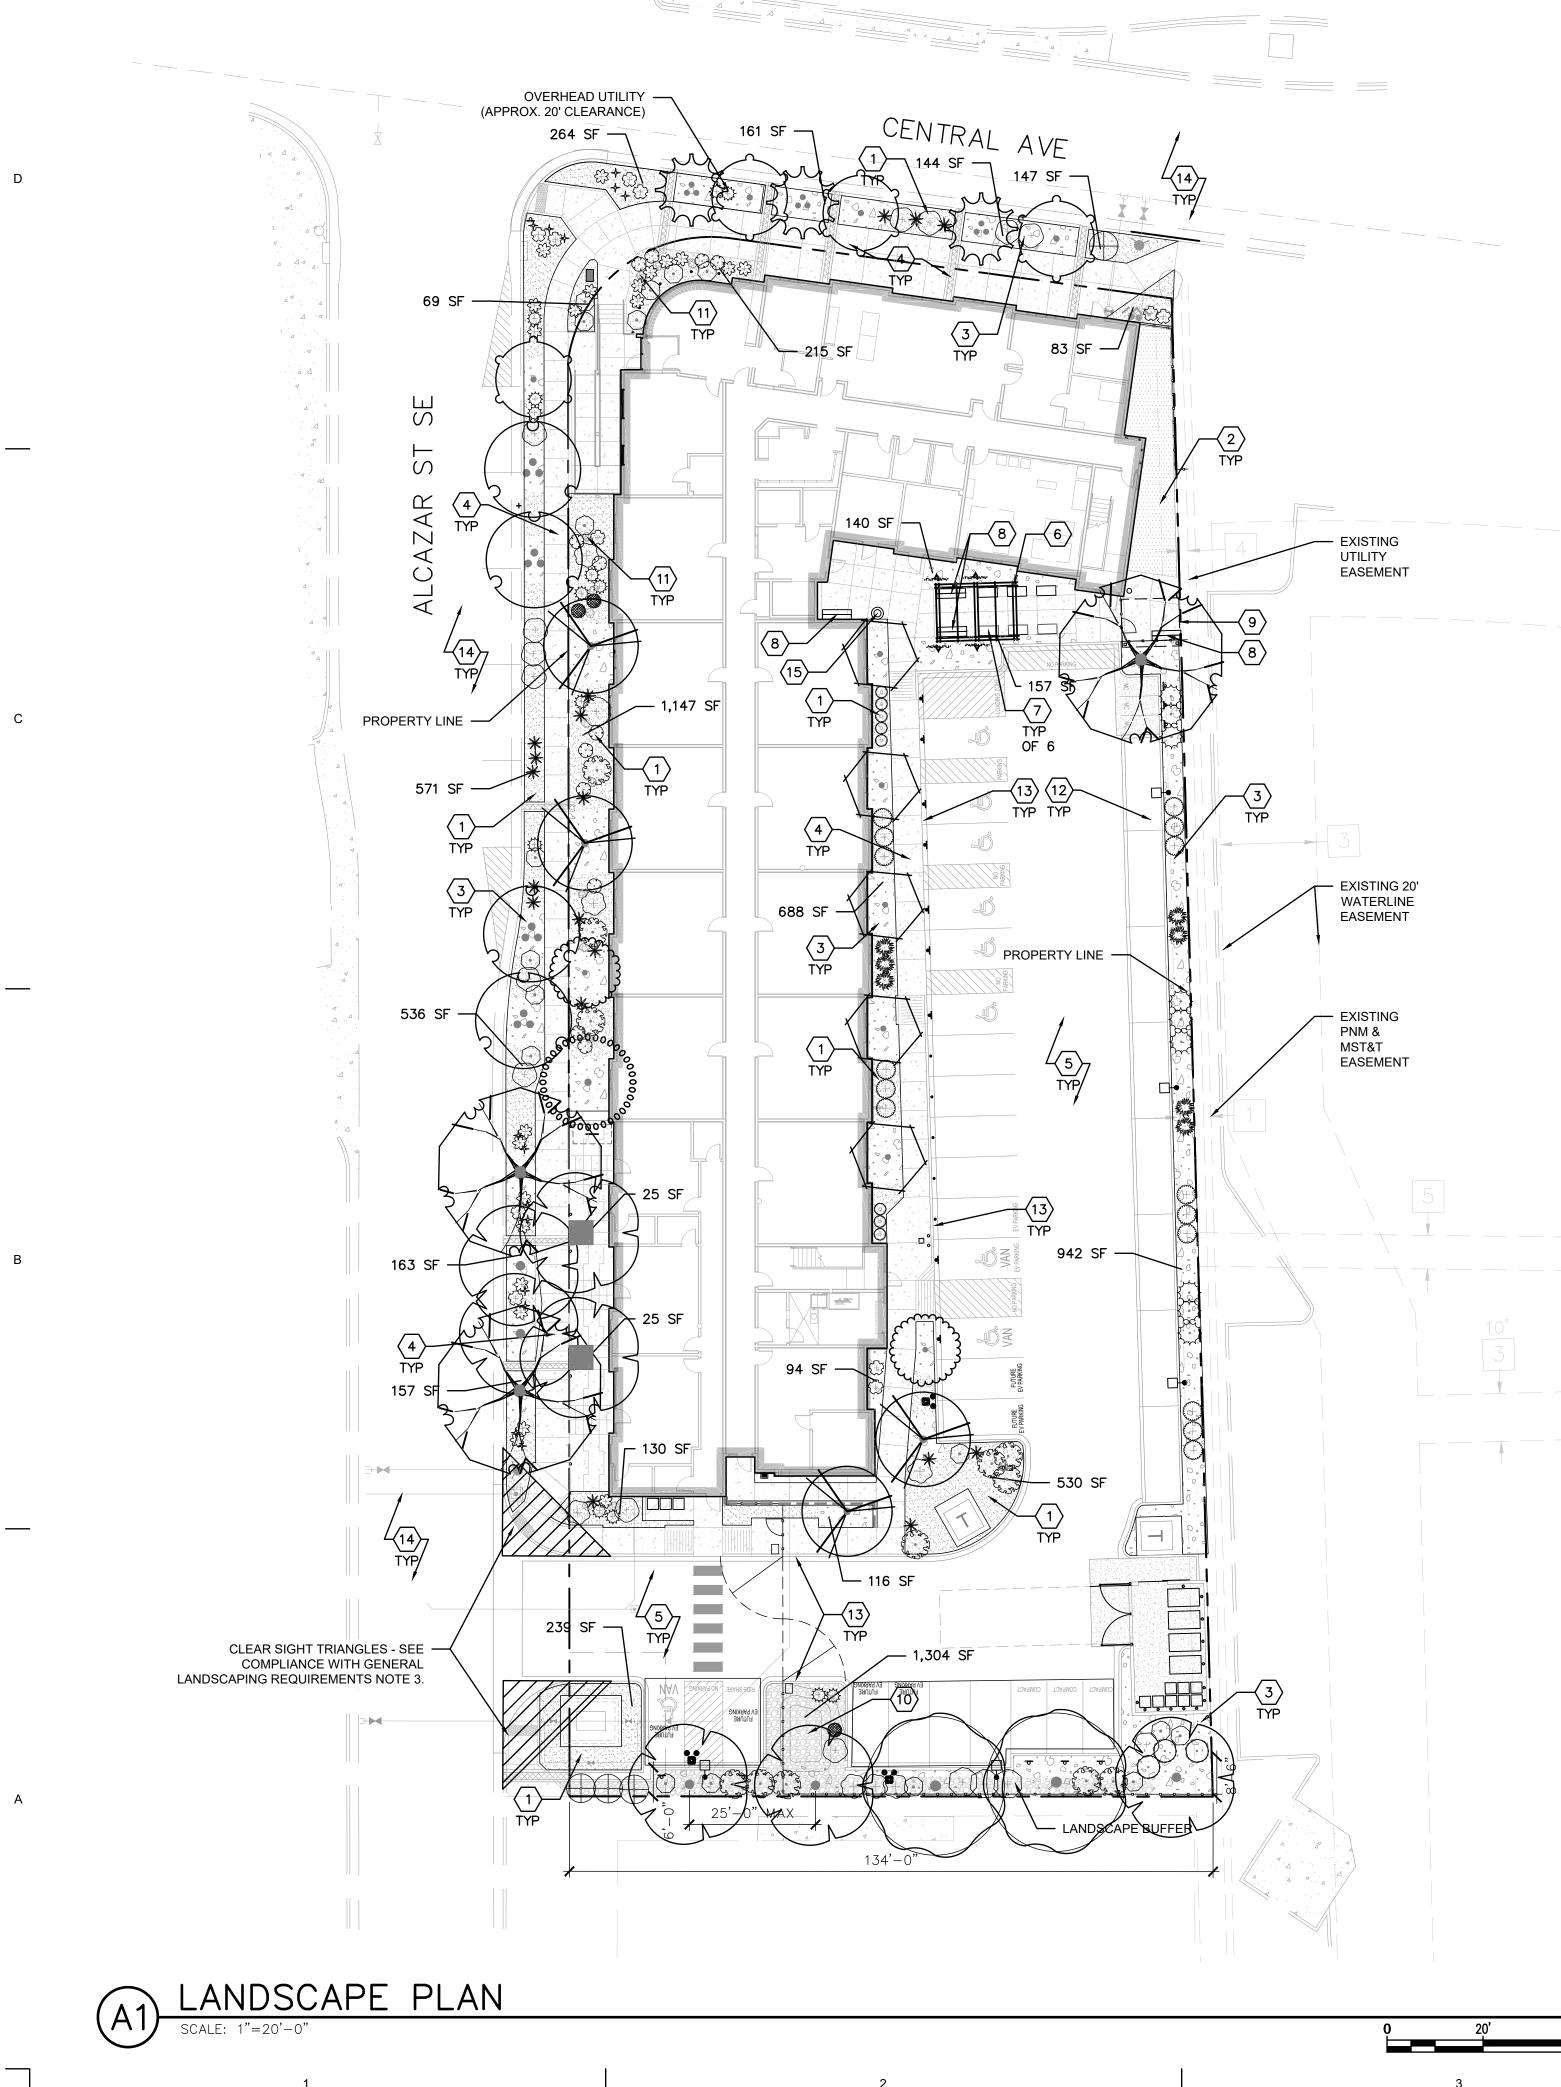



#### PLANTING KEYED NOTES <u>CODE</u> DESCRIPTION

4

	DESCRIPTION
1	GRAVEL MULCH
2	CRUSHER FINES M
3	ORGANIC MULCH – SEE DETAIL A3
4	CONCRETE SIDEW
5	ASPHALT PAVEME
6	25' LONG X12' WI TRELLIS.
7	ACCESSIBLE PLAN
8	6' LONG BENCH.
9	12' LONG X 10' V
10	AREA USED FOR
11	ACCENT BOULDER
12	GRAVEL PARKING
13	CURB AND GUTTE
14	EXISTING ASPHAL
15	TRASH RECEPTAC

#### CITY LANDSCAPE ORDINANCE COMPLIANCE

LA	<u>NDSCAPING R</u>	ESPONS	<u>IBILITY FOR</u>	MAINTEN	IANCE:		
1.	THE OWNER	WILL B	E RESPONSI	BLE FOR	ALL LANDSCAP	E MAINTENANCE	AT SOMOS
	HOUSING.						

COMPLIANCE WITH WATER CONSERVATION ORDINANCE: 1. NO SPRAY IRRIGATION IS PROPOSED.

- 2. PLANT SPECIES WILL BE LOW OR MEDIUM USE SPECIES PER THE ABCWUA'S XERIC PLANT LIST.
- 3. AN AUTOMATIC IRRIGATION SYSTEM WILL BE INSTALLED FOR ALL PLANT MATERIAL. THE SYSTEM WILL BE CONTROLLED BY AN AUTOMATIC CONTROLLER. PLANTS WILL BE IRRIGATED BY LOW WATER USE BUBBLERS. A REDUCED PRESSURE BACKFLOW PREVENTER WILL BE INSTALLED IN AN INTERIOR MECHANICAL ROOM TO PROTECT THE DOMESTIC WATER SUPPLY FROM CROSS-CONTAMINATION.
- COMPLIANCE WITH GENERAL LANDSCAPING REGULATIONS: 1. THIS PLAN PROVIDES VISUALLY ATTRACTIVE LANDSCAPE, A VISUALLY ATTRACTIVE STREETSCAPE, AND INTERSPERSED TREES IN LANDSCAPE AREAS TO PROVIDE SHADE AND REDUCE LARGE EXPANSES OF PAVEMENT.
- 2. PER 5-6(C)(5)(c), GROUNDCOVER MULCH SHALL COMPRISE OF A COMBINATION OF CRUSHED GRAVEL (NOT TO EXCEED 50% OF TOTAL AREA) AND ORGANIC MULCH SUCH AS SHREDDED BARK, PECAN SHELLS, ETC.
- 3. VISIBILITY, LANDSCAPING FENCING, AND SIGNS SHALL NOT INTERFERE WITH CLEAR SIGHT REQUIREMENTS. THEREFORE, SIGNS, WALLS, TREES, AND SHRUBS BETWEEN 3 AND 8 FEET IN HEIGHT (AS MEASURED FROM THE GUTTER PAN) WILL NOT BE LOCATED IN THE CLEAR SIGHT TRIANGLE.
- 4. GROUND-MOUNTED EQUIPMENT SCREENING WILL BE DESIGNED TO ALLOW FOR ACCESS TO UTILITY FACILITIES. ALL SCREENING AND VEGETATION SURROUNDING GROUND-MOUNTED TRANSFORMERS AND UTILITY PADS ARE TO ALLOW 10 FEET OF CLEARANCE IN FRONT OF THE EQUIPMENT DOOR AND 5-6 FEET OF CLEARANCE ON THE REMAINING THREE SIDES FOR SAFE OPERATION, MAINTENANCE, AND REPAIR PURPOSES.

4

PROVIDED ORGANIC MULCH GROUNDCOVER:

- MULCH,
- WITH GRAVEL MULCH TOPPING LAYER 3/SP7.
- WALK SEE SITE PLAN. IENT – SEE SITE PLAN.
- WIDE X 8' HEIGHT WHITE METAL
- NTER 8 SF EACH.
- WIDE MONOSLOPED SHADE STRUCTURE PASSIVE WATER HARVESTING.
- R.
- PAVEMENT SEE SITE PLAN.
- TER SEE SITE PLAN.
- LT PAVEMENT.
- CLE.



CONSULTANT

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STAMP

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## DFT SUBMITTAL

#### PROJECT NAME

## \_\_\_ SOMOS

7200 CENTRAL AVE SE, ALBUQUERQUE, NEW MEXICO 87108

## SOMOS APARTMENTS LIMITED PARTNERSHIP LLLP

LANDSCAPE CALCULATION TABLE: TOTAL LOT AREA: 41,298 SF <u>16,435 SF</u> 24,863 SF LESS TOTAL BUILDING AREA: NET LOT AREA: REQUIRED LANDSCAPE AREA (10% OF NET LOT AREA): PROVIDED LANDSCAPE AREA: 2,486 SF 5,709 SF REQUIRED PLANTS: REQUIRED STREET TREES: PROVIDED: 15 (365 LF ALONG ALCAZAR ST SE, TREES AVERAGE 25' O.C.) 15 6 (136 LF ALONG CENTRAL AVE SE, TREES AVERAGE 25' O.C.) NUMBER OF GROUND FLOOR\* DWELLING UNITS: 10 \*IN DT-UC-MS-PT AREAS, ONLY GROUND FLOOR DWELLING UNITS ARE USED TO CALCULATE THE REQUIRED TREES NUMBER OF TREES REQUIRED (AT LEAST ONE TREE PER GROUND FLOOR DWELLING UNITS): 10 PARKING LOT LANDSCAPE REQUIREMENTS: 34 STALLS TOTAL PARKING STALLS: TREES REQUIRED (1 TREE PER 10 PARKING STALLS) 4 TREES TREES PROVIDED: 8 TREES 15% OF TOTAL PARKING LOT AREA SHALL BE LANDSCAPED: 1,545 SF TOTAL PARKING LOT LANDSCAPE AREA PROVIDED: 1,722 SF REQUIRED COVERAGE (75% OF PROVIDED LANDSCAPE AREA): VEGETATIVE COVER REQUIRED: 4,310 SF PROVIDED COVERAGE: 4,555 SF REQUIRED GROUND LEVEL VEGETATIVE COVERAGE (25% OF PROVIDED LANDSCAPE AREA) VEGETATIVE GROUNDCOVER REQUIRED: 1,437 SF 1,892 SF PROVIDED GROUND LEVEL PLANT COVERAGE: ORGANIC MULCH GROUNDCOVER (50% OF LANDSCAPE AREA): REQUIRED ORGANIC MULCH GROUNDCOVER: 2,855 SF

#### REVISIONS

01	09/03/24	DFT COMMENTS
NO.	DATE	DESCRIPTION
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Drawn by	KA
Checked by	GM
Date	AUGUST 12TH, 2024
Project number	2735

SHEET TITLE



SHEET NUMBER


2,857 SF

SP6

1	I Plan <sup>-</sup>	T SCH	IEDI	2      F		3				GENEF	RAL PLANTING NOTES
										CODE	DESCRIPTION
	<u>SYMBOL</u> TREES	<u>CODE</u>	<u>QTY</u>	COMMON NAME	BOTANICAL NAME	<u>REMARKS</u>	<u>HT.</u>	<u>SPD.</u>	INSTALLED SIZE	GP-01	IN CASE OF DISCREPANCY IN PLANT QUANTITIES SHOW QUANTITIES SHOWN ON THE PLAN SHALL GOVERN. CON ADDITIONAL PAYMENT WILL BE MADE FOR ANY DISCREF
		BO	2	BURR OAK	QUERCUS MACROCARPA	B&B	60'	35'	2" CAL., 10'–12' HT.	GP-02	FILTER FABRIC SHALL BE MIN. 4 OZ. NON-WOVEN NEEI TURN DOWN EDGES 6"
	jury								_	GP-03	THE TOP OF MULCH SHALL BE 1" BELOW TOP OF ADJA
	5.4	VC	3	CHASTE TREE	VITEX AGNUS-CASTUS	24"BOX, MULTI-TRUNK	15`	15'	MIN. 6' HT.	GP-04	CONTRACTOR SHALL PRUNE LOWER BRANCHES OF DECI
D		PC	7	CHINESE PISTACHE	PISTACIA CHINENSIS	30" BOX	35'	30'	2" CAL., 12'–14' HT.	GP-05 GP-06	TREES SHALL BE INSTALLED PER DETAIL A4/LP501. SHRUBS SHALL BE INSTALLED PER DETAIL B4/LP501.
$\overline{1}$	La									GP-07	IF THERE IS A DISCREPANCY IN THE FIELD OR NURSER
		CL2	4	DESERT WILLOW	CHILOPSIS LINEARIS	24" BOX	20'	20'	5'– 7' HT., MS		SPREAD CALLED OUT UNDER "SIZE", THE SPECIFIED PL EVEN IF A LARGER CONTAINER SIZE IS REQUIRED TO M
	- Ru	UP	3	LACEBARK ELM	ULMUS PARVIFOLIA	24" BOX	40'	40'	2.5" CAL.	GP-08 GP-09	TREES AND SHRUBS SHALL BE INSTALLED PER SPECIFI
										GP-10	PER 5-6(C)(4)(G), ALL VEGETATION SHALL COMPLY W <sup><math>-1</math></sup>
		FN	2	NEW MEXICO OLIVE	FORESTIERA NEOMEXICANA	24" BOX	15՝	15՝	2" CAL. 6'–8' HT.		CONTROL, WATER CONSERVATION LANDSCAPING AND WATER AUTHORITY (ABCWUA) LEG APPLICABLE.
		CO2	5	OKLAHOMA TEXAS REDBUD	CERCIS CANADENSIS TEXENSIS 'OKLAHOMA	A' 24" BOX	15՝	15'	2" CAL. 6'–8' HT.	GP-11	PER 5–6(C)(4)(H), ALL REQUIRED PLANT MATERIALS SI AMERICAN STANDARD FOR NURSERY STOCK (ASNA) OF
	٢٠٠	СР	4	PINK POM POMS FASTERN REDBUD	CERCIS CANADENSIS 'PINK POM POMS'	24" BOX	12'	20'	2" CAL. 6'–8' HT.	GP-12	PER 5–6(C)(5)(A), ALL VEGETATED MATERIAL REQUIRED PLEASE ADD A NOTE TO THE LANDSCAPE PLAN GENER
	200000	OI	т		CENCIS CANADENSIS FINK FOM FOMS	24 007	12	20	2 CAL: 0 -0 111.	GP-13	PER 5–6(C)(5)(B), IF USED, WEED BARRIERS SHALL BE
	0000000	SB	1	SENSATION BOX ELDER	ACER NEGUNDO 'SENSATION'	B&B	30'	20'	2" CAL., 10'–12' HT.	GP-14	PER 5-6(C)(5)(D), A MINIMUM OF 2 INCHES OF ORGAN RECOMMENDED.
	23000000000	WH	4	WESTERN HACKBERRY	CELTIS OCCIDENTALIS	30" BOX	30'	20'	2" CAL, 12'–14' HT.	GP-15	5–6(C)(9)(A) ALL PLANTING OF VEGETATED MATERIAL THE PUBLIC RIGHT–OF WAY SHALL REQUIRE THE PRIOR THE MAINTENANCE, REPAIRS, OR LIABILITY FOR ALL TH
○ KEYED NOTES	$\checkmark$		•				00	20		GP-16	PER 5-6(C)(9)(B) ANY TREES THAT OVERHANG A PUB
1. VINE – SEE PLAN FOR SPECIES AND LOCATION. 2. VERTICAL STRUCTURE – SEE PLAN.											AN 8-FOOT CLEARANCE OVER THE SIDEWALK. ANY TRE 9-FOOT CLEARANCE OVER THE STREET SURFACE.
C 3. PLANT AT SAME DEPTH AS MAINTAINED AT NURSERY.		FP	4	APACHE PLUME	FALLUGIA PARADOXA	5 GAL.	6'	6'	MIN. 18" SPD.	GP-17	PER 5-6(C)(9)(C), WHERE LANDSCAPING IS INSTALLED IRRIGATION SYSTEM THAT MEETS THE MINIMUM TECHNIC
4. MULCH – SEE PLAN. HOLD BACK 2" FROM VINE STEMS.	$\underbrace{\bullet}_{\Lambda}$	BM	3	BLUE MIST SPIREA	CARYOPTERIS X CLANDONENSIS	5 GAL.	-	5'	MIN. 12" HT.		LANDSCAPING) AND THE DPM, WITH A SEPARATE METER VALVE(S) AT THE PROPERTY LINE ALLOWING ISOLATION
<ol> <li>5. EARTHEN BERM, 6" HEIGHT</li> <li>6. BACKFILL AND SOIL AMENDMENTS – SEE SPECIFICATIONS. MIX THOROUGHLY PRIOR TO</li> </ol>	June -		14	BRAKELIGHTS®RED YUCCA	HESPERALOE PARVIFLORA 'PERPA'	3 GAL.	2'	2'	MIN. 6" HT.		DRIP IRRIGATION SYSTEMS AND ARTIFICIAL TURF SHALL
INSTALLATIONS. MIX THOROUGHET PRIOR TO INSTALLATION. 7. SCARIFY EDGE OF PLANTING HOLE, CONTINUOUS	<u>}+</u> }		14	CATMINT	NEPETA FAASSENII	1 GAL.	1`	3'	MIN. 6" SPD.	GP-18	PER 5-6(C)(14)(A), IRRIGATION SYSTEMS SHALL COMPL CONNECTION PREVENTION AND CONTROL ORDINANCE).
ALL SIDES. 8. UNDISTURBED SUBGRADE		EN	4	CHAMISA	ERICAMERIA NAUSEOSA	5 GAL.	5'	6` _:	MIN. 8" HT.	GP-19	PER 5-6(C)(14)(B), ALL IRRIGATION SYSTEMS SHALL B
VINE PLANTING	(+) <i>f</i> <sup>(-)</sup>		13	CREEPING SAND CHERRY	PRUNUS BESSEYI 'PAWNEE BUTTES'	5 GAL.	2'	5`	MIN. 18" SPD.	GP-20	5–6(C)(14)(C), ALL NON–RESIDENTIAL LANDSCAPE IRRI AVOID OVERWATERING.
NOT TO SCALE	در می مرکز می	LA	8	ENGLISH LAVENDER		1 GAL.	3'	3'	MIN. 12" HT.	GP-21	PER 5-6(C)(14)(D), THE IRRIGATION SYSTEM SHALL NO
	Lesson	CM2 VS	12	FERNBUSH FLAME SEEDLESS TABLE GRAPE	CHAMAEBATIARIA MILLEFOLIUM VITIS VINIFERA 'FLAME SEEDLESS'	5 GAL. 5 GAL.	6' 15'	ь 15'	MIN. 18" SPD. MIN. 12" HT.		DRIVEWAYS, DRIVE AISLES, STREETS, AND PARKING AND
	ANN'S	RG	т 7	GOLDEN CURRANT	RIBES AUREUM	3 GAL.	т5 Д*	13 A'	MIN. 12 HT.	GP-22	5-6(C)(15)(C) ANY DAMAGE TO UTILITY LINES RESULTIN PROPERTY OWNER'S AGENTS OR EMPLOYEES IN THE INS BUFFERING IN A PUBLIC RIGHT-OF-WAY, PRIVATE WAY,
		GLS	, 7	GRO-LOW SUMAC	RHUS AROMATICA 'GRO-LOW'	5 GAL.	ד ז'	т 5'	MIN. 12 111. MIN. 18" SPD.		DAMAGE TO UTILITY LINES RESULTING FROM THE GROW PUBLIC UTILITY AS PART OF A PLAN FOR LANDSCAPING
			, 18	INDIAN HAWTHORN	RHAPHIOLEPIS INDICA	5 GAL.	.3'	۲ 4	MIN. 12" HT.		RESPONSIBILITY OF SUCH PUBLIC UTILITY. IF A PUBLIC RIGHT-OF-WAY, PRIVATE WAY, OR EASEMENT, IT SHALL
		EV	9	MORMON TEA	EPHEDRA VIRIDIS	5 GAL.		5`	MIN. 12" SPD.		AND RETURN THEM TO THEIR PRIOR LOCATIONS AFTER THE OBLIGATION OF THE ABUTTING PROPERTY OWNER
			11	NEARLY WILD ROSE	ROSA 'NEARLY WILD'	5 GAL.		3'	MIN. 12" HT.	GP-23	5-6(C)(15)(D) PROPERTY OWNERS ACKNOWLEDGE THAT RIGHT-OF-WAY, PRIVATE WAY, OR EASEMENT ABUTTING
NVVV VIL		RD	22	PINK DOUBLE KNOCK OUT®ROSE	ROSA X 'RADTKOPINK'	3 GAL.	-	3'	MIN. 12" HT.		CITY RESERVES THE RIGHT TO REMOVE THEM IF NECES COST TO THE PROPERTY OWNER. LANDSCAPING INSTALL
	(		12	PRARIE SAGE	ARTEMISIA LUDOVICIANA	5 GAL.	3'	3'	MIN. 12" HT.		PROPERTY OWNERS AND LATER REMOVED BY THE CITY REQUIRED LANDSCAPING.
B		SU	15	ROSEMARY	SALVIA ROSMARINUS	3 GAL.	5'	5'	MIN 18" HT	GP-24	5–13(B)(7)(A) LANDSCAPING, SCREENING AND BUFFERI OF ROA 1994 (TREES, VEGETATION, AND LANDSCAPING BERNALILLO COUNTY WATER AUTHORITY (ABCWUA) LEG
	GRASSES									GP-25	5–13(B)(7)(B) ALL LANDSCAPED AREAS SHALL BE MAI REMOVAL AND REPLACEMENT OF DEAD OR DISEASED P
		SN	3	INDIAN GRASS	SORGHASTRUM NUTANS	3 GAL.	4'	3'	MIN. 12" HT.		SURFACE AREAS, AND UPKEEP OF IRRIGATION SYSTEMS
	DESERT A									GP-26	5–13(B)(7)(D) WHERE LANDSCAPING WAS INSTALLED PU SHALL BE REPLACED ACCORDING TO ANY LANDSCAPING
	$\ast$	RY	18	RED YUCCA	HESPERALOE PARVIFLORA	5 GAL.	3'	3'	MIN. 12" HT.	GP-27	5–13(B)(7)(E) TREES OR PLANTS THAT DIE SHALL BE LONGER THAN 60 CALENDAR DAYS AFTER NOTICE FROI
										GP-28	THE PROPERTY OWNER. 5-13(B)(7)(F) STREET TREES SHALL BE MAINTAINED AI
										GP-28	TREES PLANTED IN THE PUBLIC RIGHT-OF-WAY ARE TI
5' RADIUS AROUND TRUNK AROUND TRUNK		Ň			Die						
	$\int \int (5)$	>									
		-									
				3	-4						
	6					*	6000000000	<u> </u>	3292() 52292() 52292() 52292() 52292()	_	
	$\overline{7}$				5		10005 200 10005 200 10005 200 2020 2020		20022800222200022200000000000000000000	$-\langle 1 \rangle$	
	<u> </u>					,4				$-\langle 2 \rangle$	
A CKEYED NOTES											
<ol> <li>TREE - SEE PLAN FOR SPECIES AND LOCATION.</li> <li>REMOVE EXISTING SOIL FROM NURSERY AS NEEDED TO EXPOSE ROOT INSTALL MITTLE DOOT FLADE OF A ROOT STATE OF A ROOT</li> </ol>	FLARE.	~	\ . / <del>-</del>				_   =     ==   = =   =	 =            _		3>	
INSTALL WITH ROOT FLARE 2"-3" ABOVE GRADE. 3. PLACE TREE IN HOLE AND STRAIGHTEN. REMOVE WIRE BASKET, WOOD TWINE AND/OR ROPE, AND BURLAP PRIOR TO BACKFILL.	BOX, PLASTIC	,		YED NOTES			11111	ıI		$\smile$	
4. AVOID MULCH INSTALLATION 4"-6" FROM TREE TRUNK. 5. ORGANIC MULCH WITH GRAVEL MULCH TOPPING LAYER - SEE DETAIL	A3 /I P501	2. Pl	LANT A	– SEE PLAN FOR SPECIES AND LOCA AT SAME DEPTH AS MAINTAINED AT R MULCH TO A 2" DEPTH ON TOP OF	NURSERY.	Г	) ki	TYFC	) NOTES		
<ol> <li>THOROUGHLY MIX BACKFILL AND SOIL AMENDMENTS PRIOR TO INSTALL SPECIFICATIONS.</li> </ol>	ATION - SEE	FF	ROM SI	HRUB STEM(S). MULCH OVER ORGANIC MULCH - SE			GRAVEL	_ MULCH	– SEE PLANTING PLAN.	-	
7. SCARIFY EDGE OF PLANTING HOLE, CONTINUOUS ALL SIDES. 8. UNDISTURBED SUBGRADE		5. S0 6. Th	CARIFY HOROU	' EDGE OF PLANTING HOLE, CONTINU( GHLY MIX BACKFILL AND SOIL AMENI	OUS ALL SIDES.	3.	ORGAN SUBGRA	ADE 🛛	H – SEE PLANTING PLAN.		
TREE PLANTING		$\sim$		CIFICATIONS.					ITH GRAVEL TO		
(A1) IREE PLANTING NOT TO SCALE		· (A2	∕┝──	OT TO SCALE	(A	$3^{\circ} = 1^{\circ} - 0^{\circ}$		<u>/   VV</u>	O O O O O O O O O O O O O O O O O O O	4"	<u> </u>
$\neg \checkmark$ 1		$\sim$		2		3					4

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ALIVE AND HEALTHY. MAINTAINING AND REPLACING STREET TREES OR OTHER THE RESPONSIBILITY OF ABUTTING PROPERTY OWNERS.

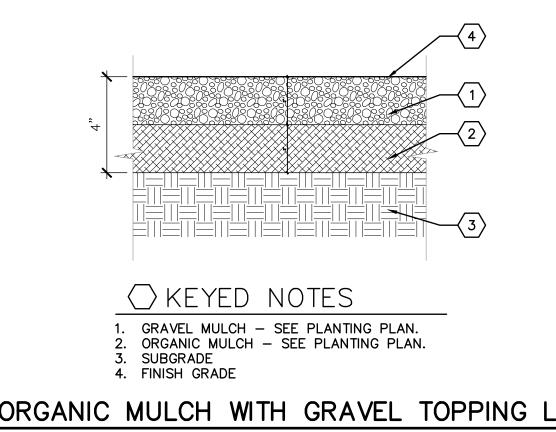

HOWN ON THE PLANT LEGEND AND THOSE SHOWN ON THE PLANTING PLAN, THE CONTRACTOR SHALL VERIFY ALL QUANTITIES PRIOR TO BID AND INSTALLATION. NO CREPANCIES IN QUANTITIES BETWEEN THE PLANTING PLAN AND THE PLANT LIST.

NEEDLE-PUNCHED POLYPROPYLENE (MIRAFI OR EQUIVALENT). OVERLAP ENDS 3" AND

ADJACENT CONCRETE SURFACES.

DECIDUOUS TREES AS DIRECTED BY LANDSCAPE ARCHITECT IN THE FIELD.

#### D1.

SERY BETWEEN THE CONTAINER SIZE CALLED OUT UNDER "REMARKS" AND HEIGHT & PLANT MUST MEET HEIGHT & SPREAD REQUIREMENTS SPECIFIED UNDER "SIZE", TO MEET THESE SPECIFICATIONS, AT NO ADDITIONAL COST TO THE OWNER. ECIFICATION SECTION 329300 - PLANTS.

WITH ARTICLE 9-12 AND PARTS 6-1-1 AND 6- 6-2 OF ROA 1994 (POLLEN WATER WASTE, AND STREET TREES) AND SECTION 4 OF THE ALBUQUERQUE LEGISLATION AND ORDINANCES (WATER WASTE REDUCTION ORDINANCE) AS

S SHALL BE FREE OF DISEASE AND INSECTS AND SHALL CONFORM TO THE OF THE AMERICAN NURSERY AND LANDSCAPE ASSOCIATION.

JIRED BY THIS SECTION 14-16-5-6 SHALL BE PLANTED IN UNCOMPACTED SOIL. NERAL NOTES TO REFLECT THIS CODE

BE PERMEABLE TO OPTIMIZE STORMWATER INFILTRATION AND PREVENT RUNOFF.

GANIC MULCH IS REQUIRED IN ALL PLANTING AREAS, WITH 3-4 INCHES

IAL OR INSTALLATION OF ANY LANDSCAPING, BUFFERING, OR SCREENING MATERIAL IN RIOR APPROVAL OF THE CITY. THE PROPERTY OWNER SHALL BE RESPONSIBLE FOR THE LANDSCAPING PLACED IN OR OVER THE PUBLIC RIGHT-OF WAY.

PUBLIC SIDEWALK OR MAJOR PUBLIC OPEN SPACE SHALL BE TRIMMED TO MAINTAIN TREES THAT OVERHANG A PUBLIC STREET SHALL BE TRIMMED TO MAINTAIN A

LED IN THE PUBLIC RIGHT-OF-WAY, THE APPLICANT SHALL INSTALL AN ADEQUATE C HNICAL REQUIREMENTS IN ARTICLE 6-6 OF ROA 1994 (TREES, VEGETATION AND IETER FOR THE LANDSCAPE AREA IN THE PUBLIC RIGHT-OF-WAY, OR A SEPARATE TION OF THE IRRIGATION TO THE LANDSCAPE WITHIN THE PUBLIC RIGHT-OF-WAY. HALL NOT BE ALLOWED WITHIN THE PUBLIC RIGHT-OF-WAY.

OMPLY WITH SECTION 8 OF THE ABCWUA LEGISLATION AND ORDINANCES (CROSS

. BE DESIGNED TO MINIMIZE THE USE OF WATER.

IRRIGATION SHALL HAVE AUTOMATIC TIMERS AND/OR PROGRAMMABLE SETTINGS TO

. NOT SPRAY OR IRRIGATE IMPERVIOUS SURFACES, INCLUDING SIDEWALKS, AND LOADING AREAS.

JLTING FROM THE NEGLIGENCE OF THE ABUTTING PROPERTY OWNER OR THE \_\_\_\_\_ INSTALLATION AND MAINTENANCE OF ANY LANDSCAPING, SCREENING, OR WAY, OR EASEMENT SHALL BE THE RESPONSIBILITY OF SUCH PROPERTY OWNER. ANY ROWTH OF PLANT MATERIALS THAT HAVE BEEN APPROVED BY THE APPLICABLE APING. SCREENING, OR BUFFERING ON THE PUBLIC RIGHT OF WAY SHALL BE THE BLIC UTILITY DISTURBS LANDSCAPING, SCREENING, OR BUFFERING IN A PUBLIC HALL MAKE EVERY REASONABLE EFFORT TO PRESERVE THE LANDSCAPING MATERIALS TER THE UTILITY WORK. IF THE PLANT MATERIALS DIE DESPITE THOSE EFFORTS, IT IS ER TO REPLACE THE PLANT MATERIALS.

HAT APPROVED LANDSCAPING AND TREES INSTALLED AND MAINTAINED IN A PUBLIC TTING PRIVATE PROPERTIES ARE THE PROPERTY OF THE CITY, AND THAT THAT THE CESSARY FOR A TRANSPORTATION PROJECT WITHOUT COMPENSATION, BUT AT NO TALLED IN AN ABUTTING PUBLIC RIGHT-OF-WAY, PRIVATE WAY, OR EASEMENT BY CITY SHALL NOT IMPACT PREVIOUSLY APPROVED NET LOT AREA CALCULATIONS FOR

FERING AREAS SHALL BE MAINTAINED IN COMPLIANCE WITH ARTICLES 6-6 AND 9-8 PING AND WEEDS, LITTER, AND SNOW) AND SECTION 4 OF THE ALBUQUERQUE LEGISLATION AND ORDINANCES (WATER WASTE REDUCTION ORDINANCE).

MAINTAINED WITH A NEAT AND ORDERLY APPEARANCE, WHICH INCLUDES PRUNING, ED PLANTS AND TREES, DISPOSAL OF LITTER, REPAIR OF DAMAGED WALLS AND HARD TEMS.

PURSUANT TO A SITE PLAN OR DEVELOPMENT APPROVAL, THE LANDSCAPING PING AND MAINTENANCE PLAN UNDER THAT APPROVAL.

BE REPLACED BY THE OWNER AS EXPEDITIOUSLY AS POSSIBLE, BUT IN NO CASE FROM THE CITY. THE REPLACEMENT OF DEAD VEGETATION IS THE RESPONSIBILITY OF



CONSULTANT

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STAMP

## DFT SUBMITTAL

PROJECT NAME

## SOMOS

7200 CENTRAL AVE SE, ALBUQUERQUE, NEW MEXICO 87108

### SOMOS APARTMENTS LIMITED PARTNERSHIP LLLP

#### REVISIONS

01	09/03/24	DFT COMMENTS
NO.	DATE	DESCRIPTION


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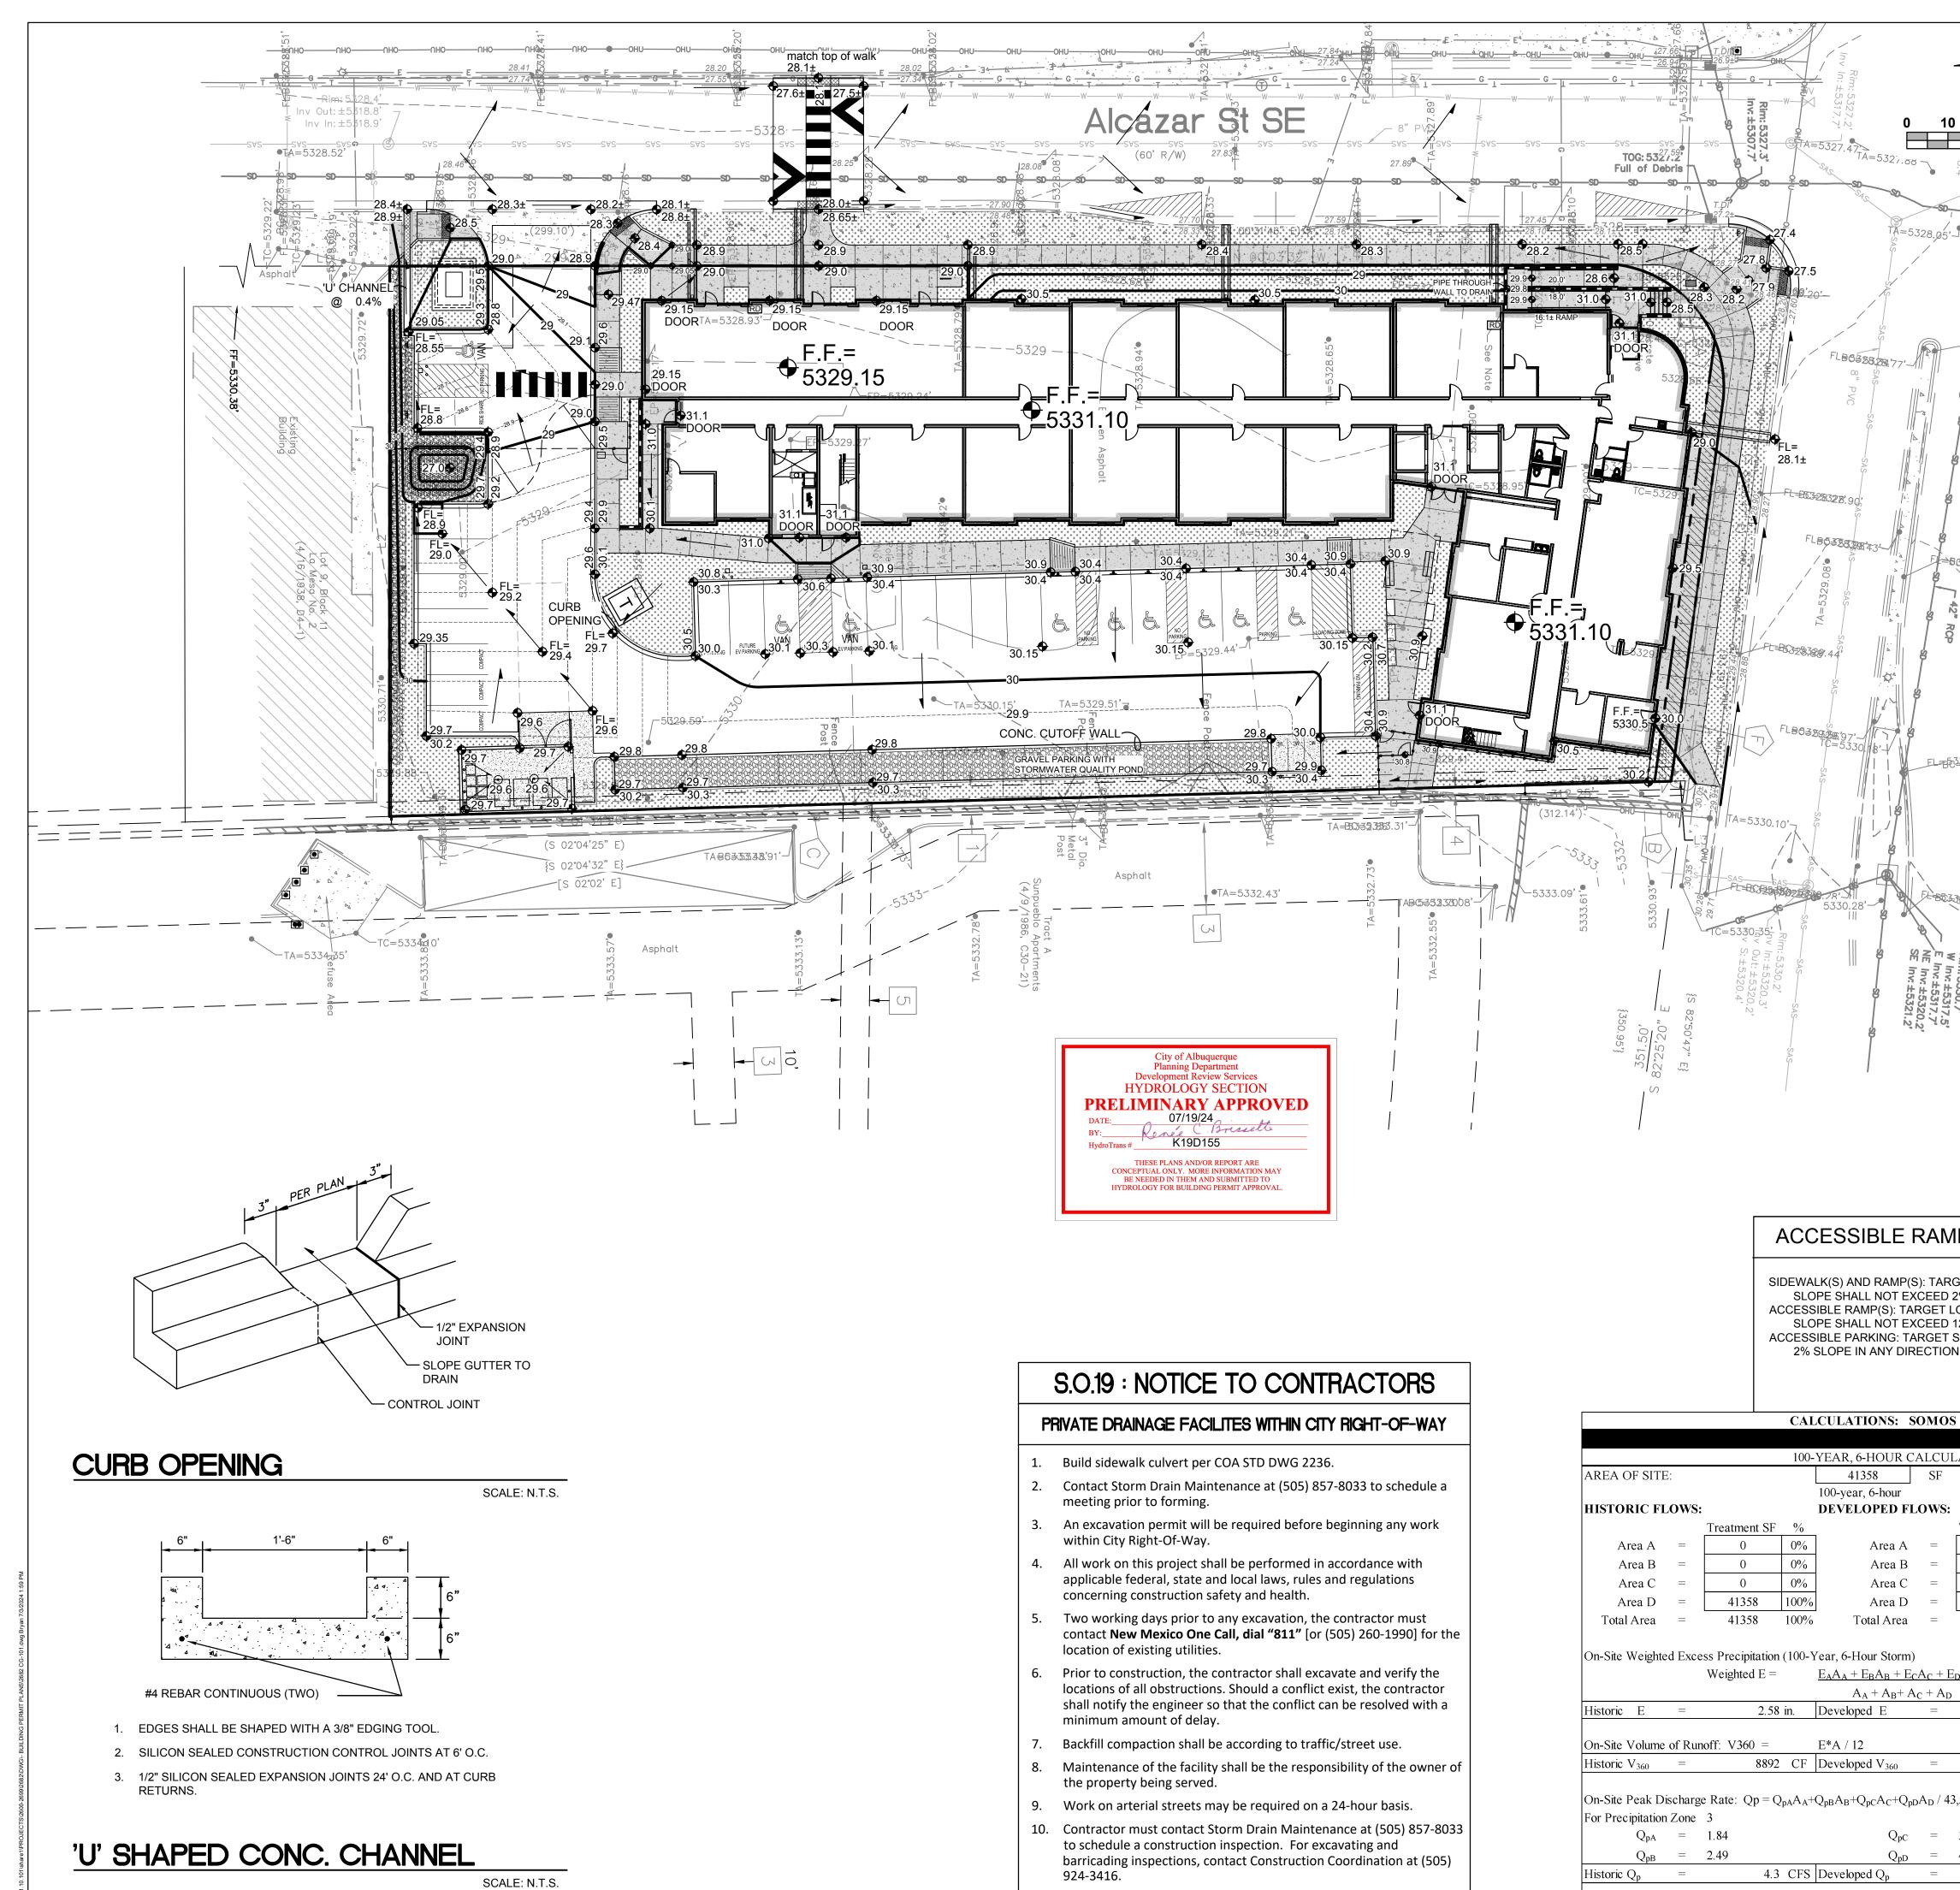
Drawn by	KA
Checked by	GM
Date	AUGUST 12TH, 2024
Project number	2735

SHEET TITLE



SHEET NUMBER

SP7

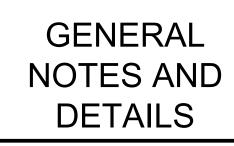

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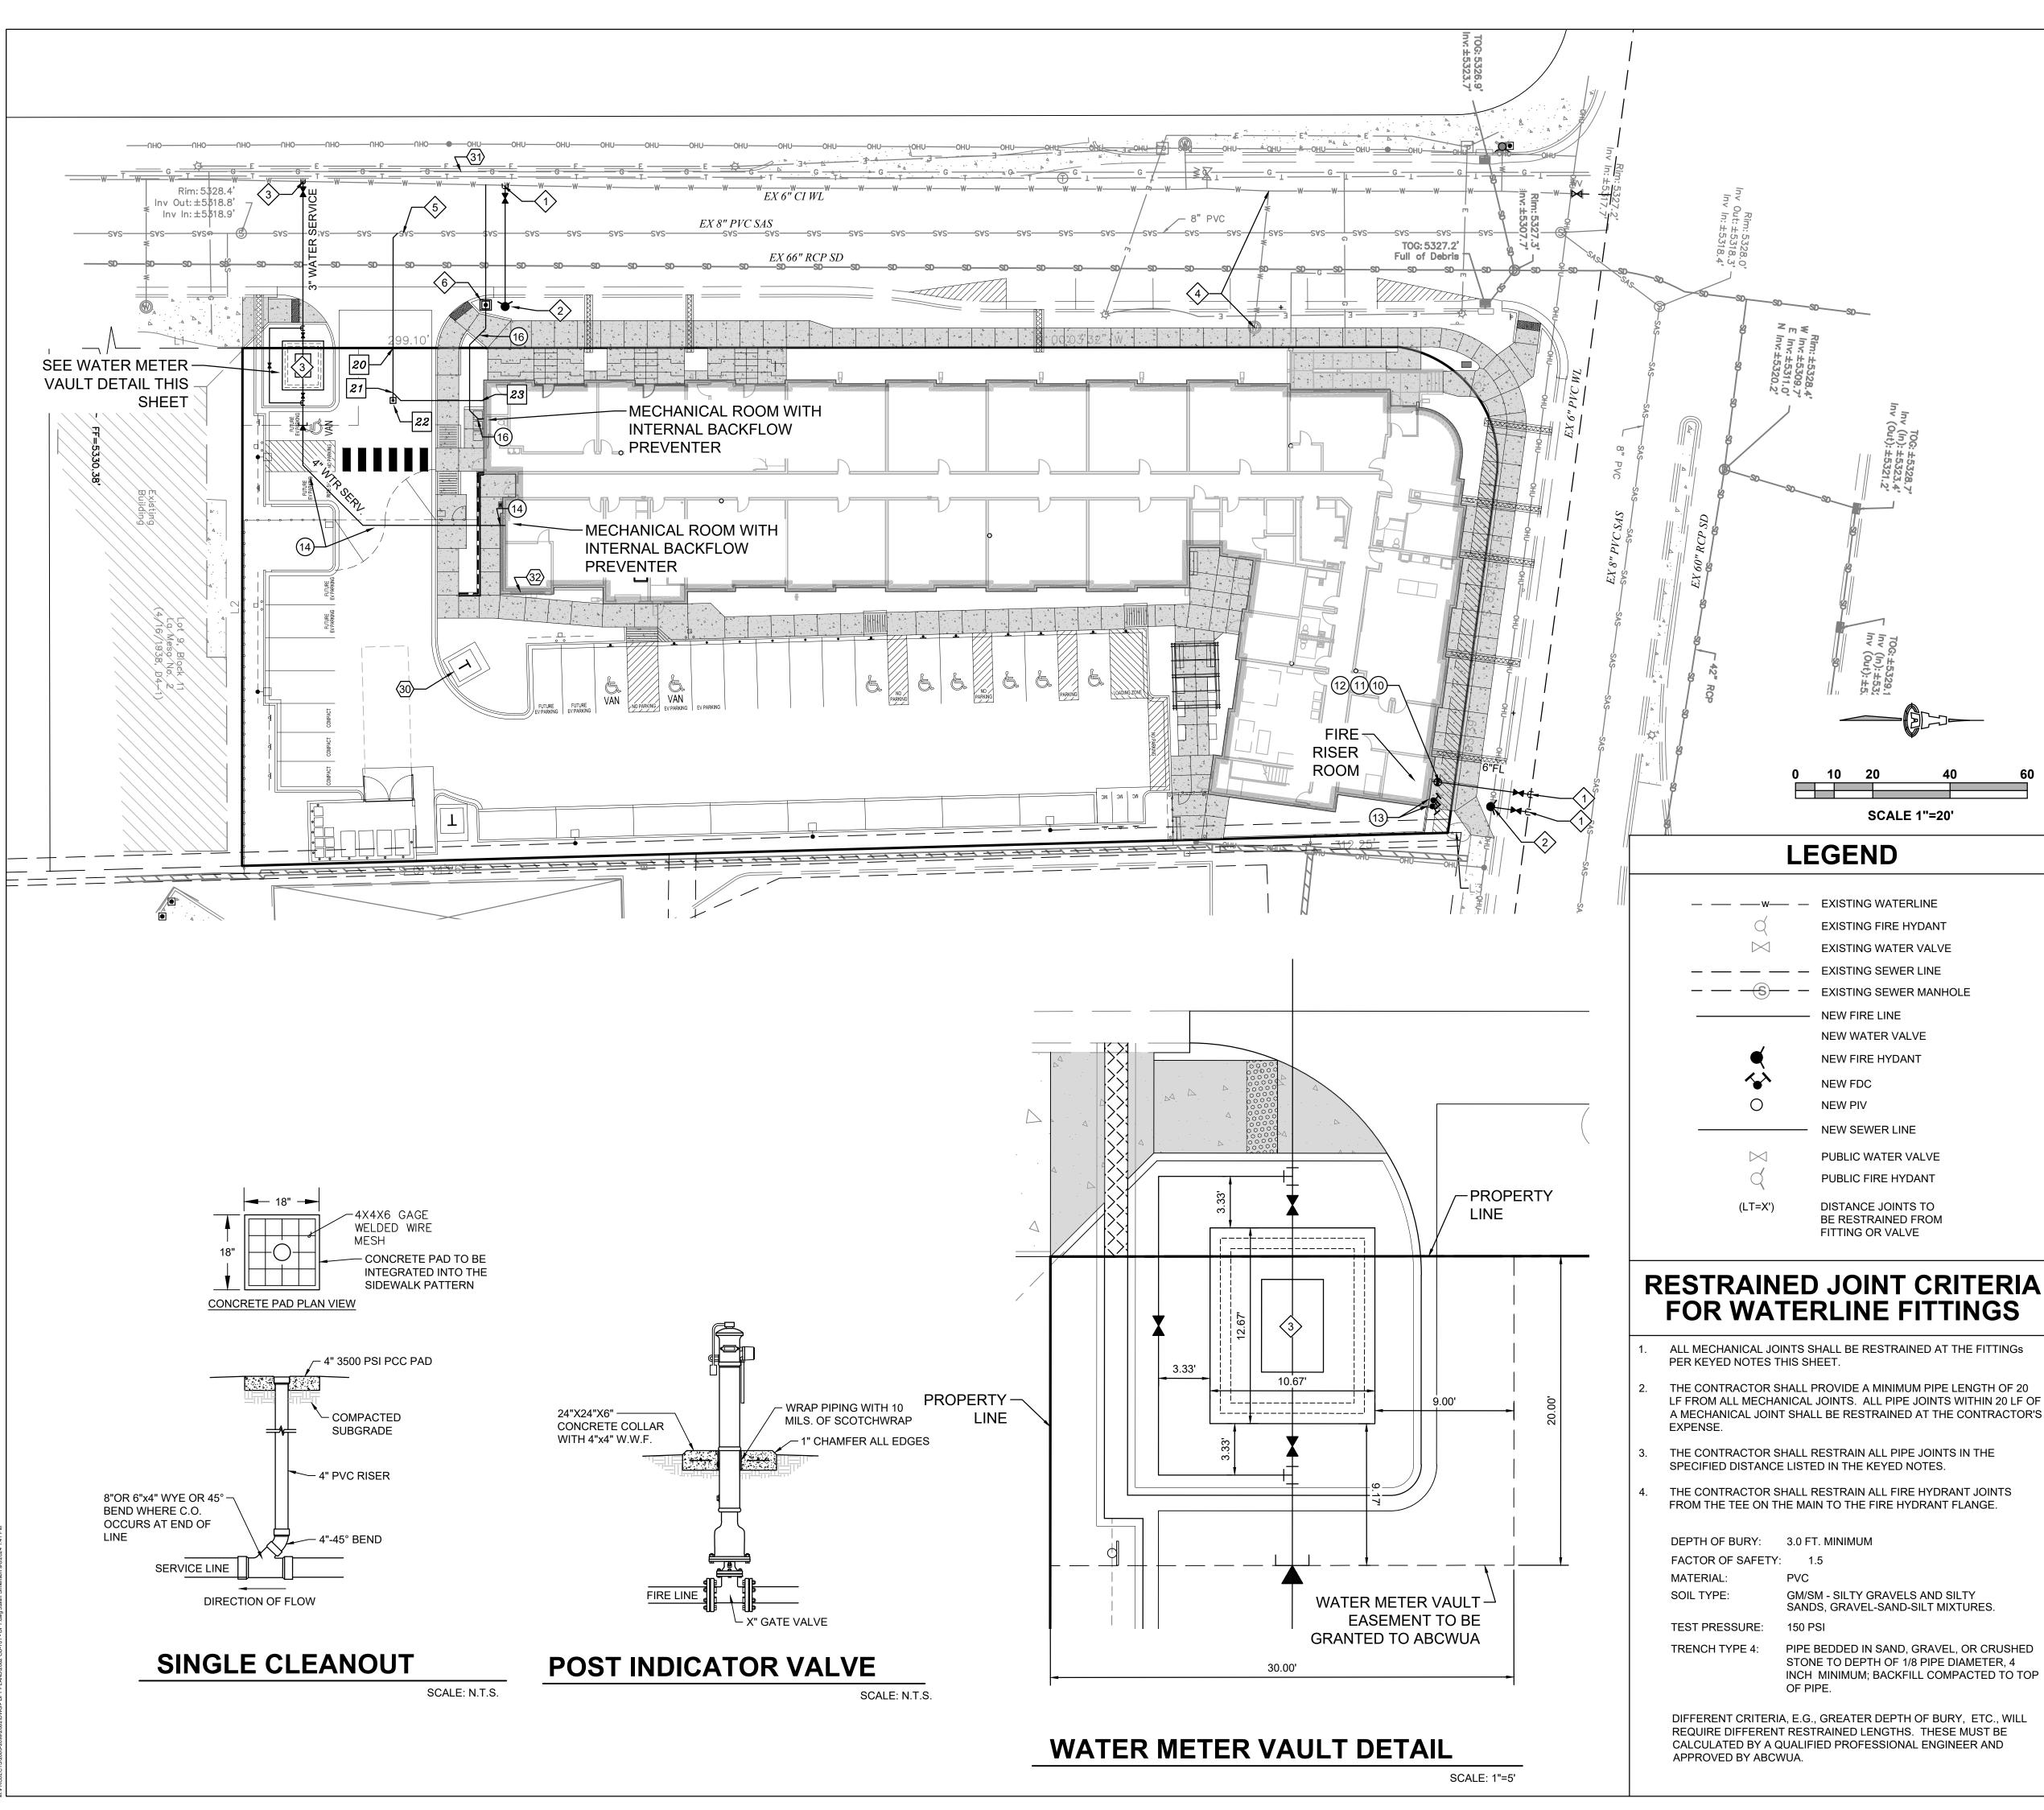
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В

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			CAL	CULATIONS:	SOMOS
			100-	YEAR, 6-HOUR	CALCUI
AREA OF SITE	E:			41358	SF
				100-year, 6-hour	
HISTORIC FI	LOWS	•		DEVELOPED F	FLOWS:
		Treatment SF	%		
Area A	=	0	0%	Area A	. =
Area B	=	0	0%	Area B	=
Area C	=	0	0%	Area C	=
Area D	=	41358	100%	Area D	) =
Total Area	=	41358	100%	Total Area	ι =
		Weighted E =		$\frac{E_A A_A + E_B A_B + I}{A_A + A_B +}$	
	=	2.58	in	Developed E	_
Historic E		2.50	ші.	Developed L	_
Historic E On-Site Volume	of Ru		111.	E*A / 12	_
	of Ru				=
On-Site Volume Historic V <sub>360</sub> On-Site Peak D For Precipitation Q <sub>pA</sub>	= ischarg Zone =	noff: V360 = 8892 ge Rate: Qp = Q 3 1.84	CF	E*A / 12 Developed $V_{360}$ $Q_{pB}A_B+Q_{pC}A_C+Q$ $Q_{pC}$	$P_{pD}A_D / 43$
On-Site Volume Historic V <sub>360</sub> On-Site Peak D For Precipitatior	= ischarg n Zone	noff: V360 = 8892 ge Rate: Qp = Q 3	CF P <sub>pA</sub> A <sub>A</sub> ++	E*A / 12 Developed $V_{360}$ $Q_{pB}A_B+Q_{pC}A_C+Q$	$P_{pD}A_D / 43$

	C.O.A. VICINITY MAP K-19-Z		nc.	onsulation		Street NE	NM 87108	vil.com
20 40 60 20 40 60 SCALE 1"=20' N Inv: ±5320.2' N Inv:	Image: Strate in the strate	concep remain Arfmar shall b firm c purpos	Usaac Isaac Isaac Isaac Isaac Isaac Isaac Isaac Isaac Isaac Isaac Isaac Isaac	Contracting and the second sec	Iculation when the point of the	128 Monroe	Albuduer, unit and a second se	nd nd of on, ny
06: ±5329.1 (in): ±5324. (out): ±5324.	LOT BOUNDED TO THE NORTH BY CENTRAL AVE NE, TO THE EAST BY A DEVELOPED MULTI-FAMILY RESIDENTIAL, TO THE SOUTH BY DEVELOPED COMMERCIAL LOT, AND TO THE WEST BY ALCAZAR ST SE. PROPOSED IMPROVEMENTS: THE PROPOSED IMPROVEMENTS INCLUDE A				ni	nist 3 PM	ar	' <b>y</b>
<b>IPS, WALKS &amp; PARKING</b> SET CROSS SLOPE = 1% TO 1.5%. CROSS 2000	Initial Content of the initial of t	50%	DOCUMENTS	MBER: IA 2682	~			DATE: 07/03/2024
5 : 43978	<b>KEYED NOTES</b>							
= 0.95  ACRE $= 0.95  ACRE$ $EXCESS PRECIP:$ $Treatment SF % Precip. Zone 3$ $= 0.67$ $= 0.86$ $= 0.86$ $= 0.86$ $= 0.86$ $= 1.09$ $= 2.58$ $DAD$ $2.36  in.$ $= 8122  CF$	<ol> <li>PROVIDE SMOOTH TRANSITION TO EXISTING PAVEMENT</li> <li>1' (BOTTOM WIDTH) CURB OPENING</li> <li>CONSTRUCT ADA COMPLIANT PARKING SPACES</li> <li>CONSTRUCT ADA COMPLIANT PEDESTRIAN ACCESS WALK AT ELEVATIONS SHOWN</li> <li>CONCRETE DUMPSTER PAD SLOPED TO INTERIOR DRAIN INLET(S).</li> <li>BUILDING EXTENDED STEMWALL REQUIRED TO ACHIEVE GRADES SHOWN.</li> <li>CONSTRUCT 2' WIDE ALLEY GUTTER</li> <li>CONSTRUCT 1.5' (BOTTOM WIDTH) 'U' SHAPED CONCRETE CHANEL THROUGH ISLAND TO PASS WATER</li> </ol>		RAI RA	DI IN	[N	G		
3,560 3.17	PROPOSED 0.1' CONTOUR     PROPOSED SPOT ELEVATION     SURFACE FLOW DIRECTION	SHE	ET N	UM	IBE	R		
4.49 4.1 CFS	FF = 5331.10FINISHED FLOOR ELEVATIONGRAVEL		CG	) — '	1	0'	1	



# **GENERAL NOTES**

- A. EXISTING UTILITY LINES ARE SHOWN IN AN APPROXIMATE MANNER ONLY AND MAY BE INCOMPLETE OR OBSOLETE. SUCH LINES MAY OR MAY NOT EXIST WHERE SHOWN OR NOT SHOWN. ALL UTILITIES SHOULD BE FIELD VERIFIED AND LOCATED BY THE CONTRACTOR PRIOR TO COMMENCEMENT OF ANY CONSTRUCTION. THE CONTRACTOR IS FULLY RESPONSIBLE FOR ANY AND ALL DAMAGE CAUSED BY ITS FAILURE TO LOCATE, IDENTIFY AND PRESERVE ANY AND ALL EXISTING UTILITIES, PIPELINES, AND UNDERGROUND UTILITY LINES.
- CONTRACTOR SHALL NOT USE VIBRATORY COMPACTION EQUIPMENT OR HEAVY VEHICLES OVER EXISTING UTILITIES.
- SITE STORM DRAIN, ELECTRIC LINES & TRANSFORMERS AND GAS LINES ARE SHOWN FOR GENERAL INFORMATION ONLY TO PROVIDE AN OVERVIEW OF SITE UTILITIES AND POTENTIAL CONFLICTS. SEE MECHANICAL PLANS FOR GAS LINE SIZING. SEE CG-101 FOR STORM DRAIN DESIGN.
- ALL WATER FITTINGS SHALL HAVE JOINT RESTRAINTS (LT). SEE RESTRAINED JOINT CRITERIA NOTES THIS SHEET. (LT) LENGTH SHOWN ON KEYED NOTES.
- ALL ABOVE GROUND UTILITY EQUIPMENT AND FITTINGS SHALL BE PAINTED IN COLORS TO MATCH BUILDING COLORS.
- WATERLINES 4" IN DIAMETER OR LARGER SHALL BE PVC PIPE MEETING AWWA C900 DR-18 REQUIREMENTS.
- G. SANITARY SEWER LINE MATERIALS SHALL BE PVC SDR-35 PIPE.
- COORDINATION WITH WATER AUTHORITY CROSS CONNECTION SECTION WILL BE REQUIRED TO ENSURE PROPER BACKFLOW CONTAINMENT IS IN PLACE PRIOR TO RELEASE OF METER FOR THE SITE. CONTACT THE CROSS CONNECTION SECTION AT 505-289-3454.
- COORDINATION WITH THE WATER AUTHORITY PRE-TREATMENT ENGINEER IS REQUIRED TO ENSURE THE SITE COMPLIES WITH WATER AUTHORITY SEWER USE ORDINANCE. CONTACT THE PRE-TREATMENT ENGINEER AT 505-289-3439.
- CONNECTION TO THE 10" STEEL LINE WILL REQUIRE ENGINEERED DETAILS ON THE CONNECTION PERMIT PLAN SUBMITTAL.
- ALL WORK PERFORMED ON PRIVATELY OWNED SEWER LINE AND SERVICE LINES MUST BE INSPECTED BY THE CITY OF ALBUQUERQUE'S CODE ADMINISTRATION DIVISION. IN ORDER THAT INSPECTION BY THE PLANNING DEPARTMENT, CODE ADMINISTRATION DIVISION, PLUMBING SECTION CAN BE EFFICIENTLY HANDLED, WITH A MINIMUM LOSS OF TIME TO CONTRACTOR, THE FOLLOWING SHALL BE NOTED:
- INSPECTION ARRANGEMENTS FOR A SEWER SERVICE LINE SHALL BE MADE BY THE CONTRACTOR CALLING THE CITY OF ALBUQUERQUE, CODE ADMINISTRATION DIVISION, PLUMBING SECTION.
- INSPECTION REQUESTS CALLED IN BETWEEN THE HOURS OF 8:00 A.M. AND 12:00 NOON WILL BE INSPECTED THE SAME AFTERNOON. INSPECTION REQUESTS CALLED IN BETWEEN THE HOURS OF 1:00 AND 5:00 P.M. WILL BE INSPECTED THE FOLLOWING MORNING, EXCEPT IN CASES OF EMERGENCY.

# **KEYED NOTES**

ABCWUA CONNECTION PERMIT ITEMS

- 1. NON-PRESSURE CONNECTION. INSTALL 6" TEE W/ 6" GATE VALVE PER ABCWUA STD DWG #S 2301, 2326, 2328.
- 2. INSTALL PUBLIC 4' BURY FIRE HYDRANT PER ABCWUA STD DWG #2340.
- 3. 3" WATER METER IN VAULT PER ABCWUA STD DWG #2370.
- 4. REMOVE AND DISPOSE EXISTING WATER METER BOX, CLOSE CORP STOP AT MAIN.
- 5. INSTALL 8" WYE ON EXISTING SAS MAIN AND INSTALL NEW 8" SERVICE LINE TO ROW.
- 6. 1" WATER METER PER ABCWUA STD DWGS #2362 & #2366.

- 10. REMOVE EXISTING 6" CAP AND CONNECT NEW 6" WATERLINE.
- 11. PIV (POST INDICATOR VALVE).
- 12.  $\frac{3}{4}$ " ELECTRICAL CONDUIT W/ PULL STRING FROM PIV TO FIRE ROOM.
- 13. WALL MOUNT FDC (FIRE DEPARTMENT CONNECTION).
- 14. REMOVE 3" CAP. INSTALL 4"x3" REDUCER AND CONNECT NEW 4" SERVICE LINE TO BUILDING. SEE MECHANICAL PLAN FOR CONTINUATION.
- 15. 4" 45° BEND (LT = 5')
- 16. TIE TO 1" WATER METER. INSTALL EXPANSION TO TRANSITION FROM 1" TO 1-1/4". INSTALL 1-1/4" WATER SERVICE LINE TO BUILDING. SEE MECHANICAL PLAN FOR CONTINUATION.

#### SEWER KEYED NOTES


20. CONNECT TO 8" SANITARY SEWER SERVICE AT ROW.

- 21. INSTALL 8" WYE.
- 22. INSTALL SINGLE CLEAN OUT PER DETAIL THIS SHEET.
- 23. SEE MECHANICAL PLAN FOR CONTINUATION.

24. INSTALL 8" - 45° BEND

#### $\langle \rangle$ <u>DRY UTILITY KEYED NOTES</u>

- 30. PNM TRANSFORMER. OWNER / CONTRACTOR TO COMPLETE AND SUBMIT A COMMERCIAL SERVICE APPLICATION TO PNM. PNM REPRESENTATIVE TO TO PROVIDE ONSITE ELECTRICAL SERVICE LINE LOCATION.
- 31. NEW MEXICO GAS COMPANY GAS MAIN. OWNER / CONTRACTOR TO COMPLETE AND SUBMIT A COMMERCIAL SERVICE APPLICATION TO NMGCO.
- 32. GAS METER LOCATION TO BE DETERMINED BY OWNER AND NMGCO.

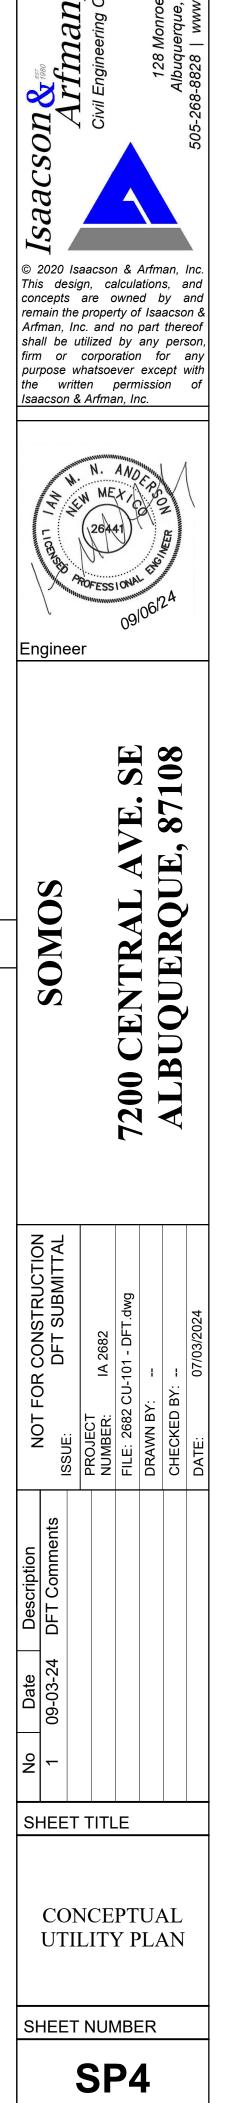

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#### Hollow Metal Door Orange Decorative Lighting Composite Window White Metal Trellis Glass Storefront NORTH ELEVATION (CENTRAL AVE FACING FACADE) 3/32" = 1'-0"

2



3

WEST ELEVATION (ALCAZAR STREET FACING FACADE) 3/32" = 1'-0"

2

1

#### Width, maximum: 50% of building frontage width Height of message surface, maximum: letters and images must located on vertical surfaces, which may not exceed 18 in. height.

Commercial Signage Maximum Size Based Off IDO (Table 5-12-3): Number, maximum: 1 / establishment frontage

4

Vinyl Window White Metal Coping Orange 13' - 6 1/2" 32' - 3" FACE RECEDES 20'-0" Approx. 17' - 4"

3

## Office/Main Entry Lobby Beyond

RelocatedExisting Tile Pillar Monument

- Metal Awening at Main Entry Door

Sun Shelf

20

Custom trellis (optional)

Metal Sunshade (optional)

Illuminated Raised Signage 49 SF (less than 15%)

Roof Deck (Optional)

facade area, inclusive of door and window openings: MX-M: 15%. Location: Where there is no side setback between 2 establishment frontages in the same or abutting buildings, no wall sign may extend closer than 2 feet to the shared edge of the frontage.

Area, maximum: Shall not exceed the following percentages of

Wall Sign Maximum Size Based Off IDO (Table 5-12-3): Number, maximum: N/A.

- Wall Mural (Image to be determined - 150sf min)

# STREET ELEVATIONS TRANSPARENCY CALCULATIONS

977SF OF TRANSPARENT DOORS AND WINDOWS PROVIDED. 32% PROVIDED > 30% REQUIRED

254'-6" LENGHT X 12' HEIGHT = 3,054SF OF FACADE SURFACE AREA FOR THE FIRST 12 FEET OF BUILDING HEIGHT. 30% REQUIRED TRANSPARENT DOORS AND WINDOWS FOR THE FIRST 12 OF BUILDING HEIGHT.

TOTAL NORTH FACADE LENGTH: 103'-6"

ALCAZAR ST ELEVATION

429SF OF TRANSPARENT DOORS AND WINDOWS PROVIDED. 34.5% PROVIDED > 30% REQUIRED

30% REQUIRED TRANSPARENT DOORS AND WINDOWS FOR THE FIRST 12 OF BUILDING HEIGHT.

TOTAL NORTH FACADE LENGTH:103'-6"

CENTRAL AVE ELEVATION

# **GENERAL SHEET NOTES**

- Building mounted signs shall meet IDO Section 5-12(E)(5)(c) Mixed Use and Nona. Residential Zone Districts and Table 5-12-3. The sign area shall not exceed 25% of the façade area, inclusive of door and window openings. Building design shall meet IDO Section 5-11(E) Multi-family Residential Development in b.
- UC-MS-PT Areas and Mixed Use and Non-Residential development in Mixed-Use Zone Districts. Per IDO 5-11(E) (1) the ground floor height shall have a minimum clear height of 10 feet. C. Per IDO Section 5-11( E)(2)(a), the façade design shall provide a sense of human scale d. and shall incorporate features along at least 30 percent of the length of the façade, distributed along the facade so that at least 1 of the features occurs every 40 feet. The
- elevations provide windows on the upper floors and awnings over windows as shown. The facades facing Central Avenue and Alcazar incorporate changes in color more than 20% of the horizontal length of the facade and wall plane projections or recesses of at least 1 foot in depth every 100 feet of the façade length and extending for at least 25 percent of the length of the façade. Per 5-11(E)(2)(b), windows on the upper floors shall be recessed by a minimum of 2-
- inches and the ground floor of the Central and Alcazar facades shall contain a minimum of 30 percent of its surface in transparent windows and/or doors. For the commercial and office use, the interior spaces shall be visible to a minimum depth of 6 feet from the façade.




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103'-6" LENGHT X 12' HEIGHT = 1.242SF OF FACADE SURFACE AREA FOR THE FIRST 12 FEET OF BUILDING HEIGHT.

429SF / 1,242SF = 34.5% OF FACADE SURFACE AREA IS TRANSPARENT DOORS AND WINDOWS FOR THE FIRST 12 FEET OF BUILDING HEIGHT.

977SF / 3,0542SF = 32% OF FACADE SURFACE AREA IS TRANSPARENT DOORS AND WINDOWS FOR THE FIRST 12 FEET OF BUILDING HEIGHT.

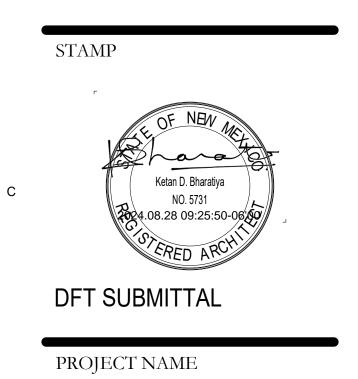

SOMOS

#### 7200 CENTRAL AVE SE, ALBUQUERQUE, NEW MEXICO 87108

## SOMOS APARTMENTS LIMITED PARTNERSHIP LLLP

В

REVISIONS

01	09/03/24	DFT COMMENTS	
NO.	DATE	DESCRIPTION	
Copyright: Design Group			

Drawn by	JJ/VM
Checked by	KB
Date	August 12, 2024
Project number	2735

SHEET TITLE




SHEET NUMBER

**SP-8** 

5



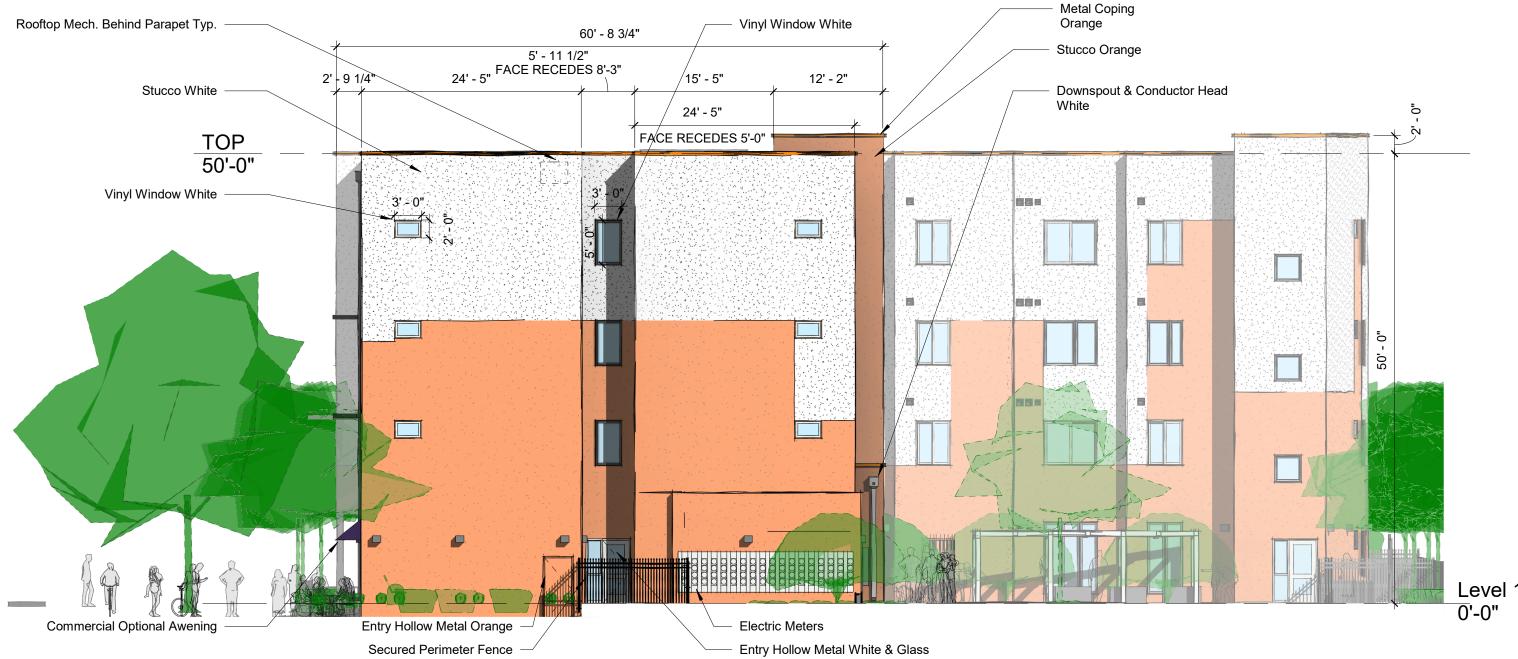

# SOUTH ELEVATION (INTERIOR FACING FACADE) 0' 5' 10'

3/32" = 1'-0"


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# EAST ELEVATION (INTERIOR FACING FACADE) 3/32" = 1'-0"

2

1

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# SOUTH ELEVATION (INTERIOR FACING FACADE) 3/32" = 1'-0"

4

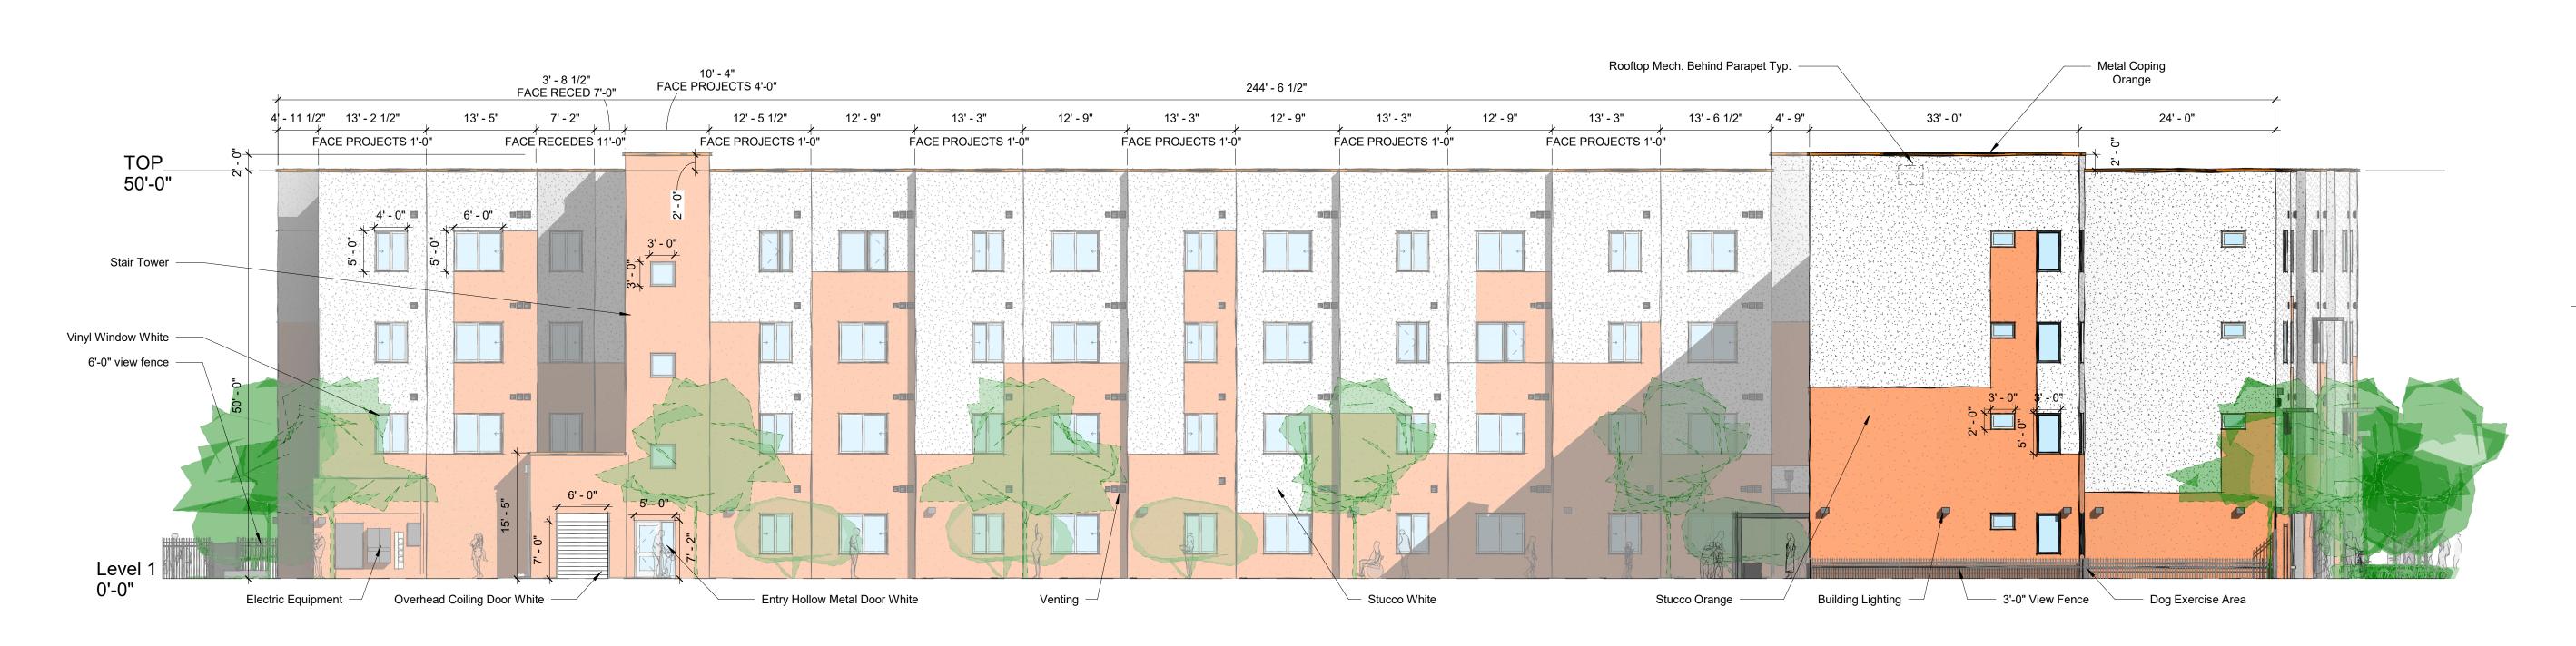

4

3

## **GENERAL SHEET NOTES** Building mounted signs shall meet IDO Section 5-12(E)(5)(c) Mixed Use and Non-Residential Zone Districts and Table 5-12-3. The sign area shall not exceed 25% of the a. façade area, inclusive of door and window openings. Building design shall meet IDO Section 5-11(E) Multi-family Residential Development in UC-MS-PT Areas and Mixed Use and Non-Residential development in Mixed-Use Zone b. Districts.

- Per IDO 5-11(E) (1) the ground floor height shall have a minimum clear height of 10 feet. Per IDO Section 5-11( E)(2)(a), the façade design shall provide a sense of human scale d. and shall incorporate features along at least 30 percent of the length of the façade, distributed along the facade so that at least 1 of the features occurs every 40 feet. The elevations provide windows on the upper floors and awnings over windows as shown. The facades facing Central Avenue and Alcazar incorporate changes in color more than 20% of the horizontal length of the façade and wall plane projections or recesses of at least 1 foot in depth every 100 feet of the façade length and extending for at least 25 percent of the length of the façade. e.
- Per 5-11(E)(2)(b), windows on the upper floors shall be recessed by a minimum of 2inches and the ground floor of the Central and Alcazar facades shall contain a minimum of 30 percent of its surface in transparent windows and/or doors.




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5' 10'

5



## SOMOS

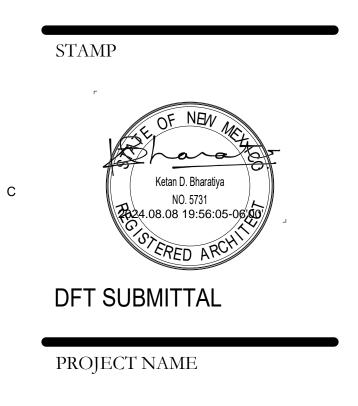REVISIONS

7200 CENTRAL AVE SE, ALBUQUERQUE, NEW MEXICO 87108

## SOMOS APARTMENTS LIMITED PARTNERSHIP LLLP

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NO.	DATE	DESCRIPTION
Copyrigh	nt: Design Grou	p
Drawn b	У	VM

214	V
Checked by	К
Date	AUGUST 12, 202
Project number	273

SHEET TITLE

**BUILDING ELEVATIONS -**DFT SUBMITTAL

SHEET NUMBER

SP-9

А

1

2


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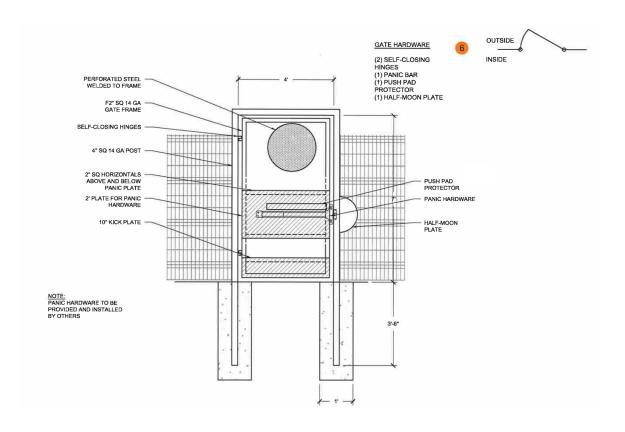
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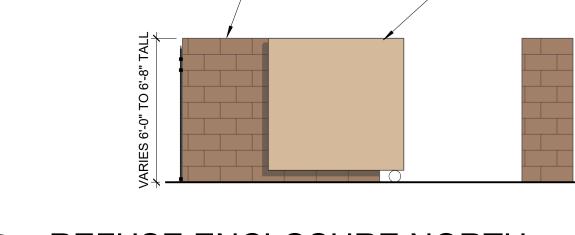
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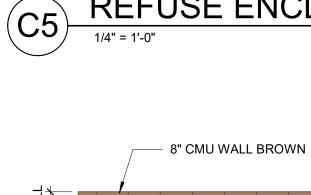
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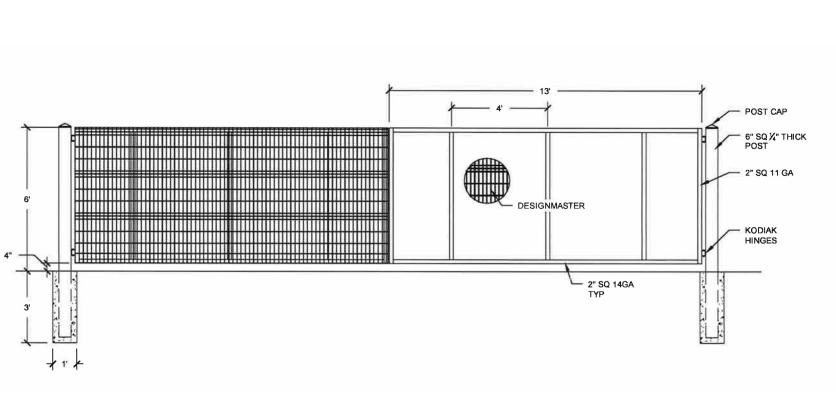










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4
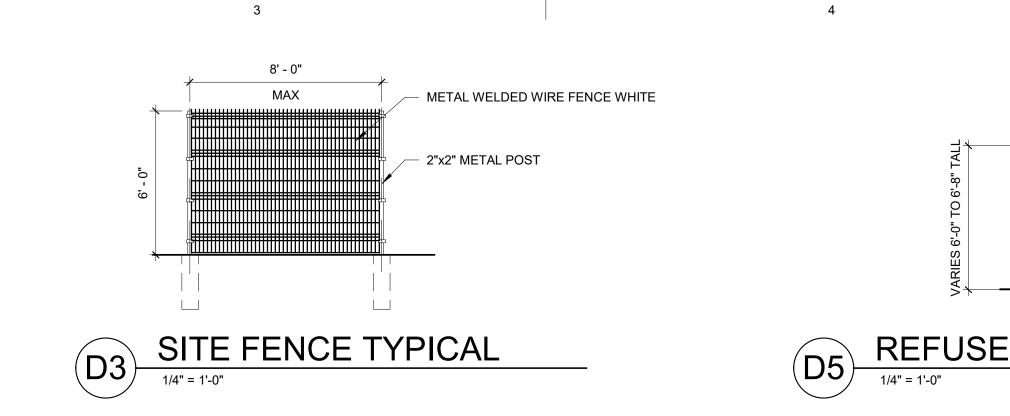
# - 8" CMU WALL BROWN



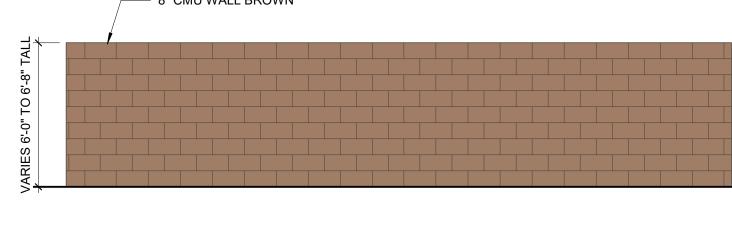


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- 8" CMU WALL BROWN - STEEL SLIDING GATE LIGHT BROWN
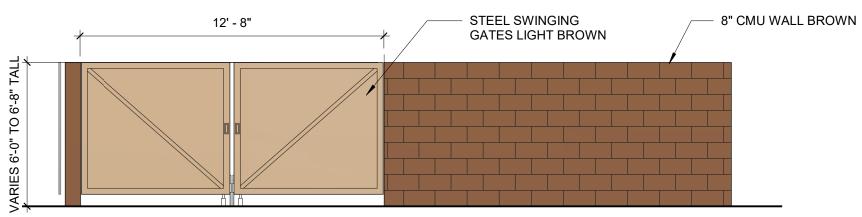
# **REFUSE ENCLOSURE NORTH**

5

В
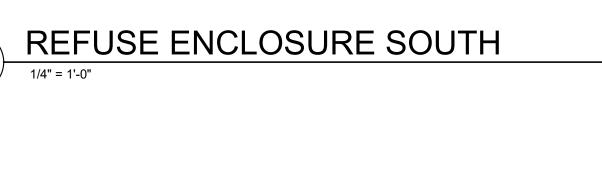
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## SOMOS APARTMENTS LIMITED PARTNERSHIP LLLP

NO. DATE DESCRIPTION

VM

KB

2735

AUGUST 12, 2024

7200 CENTRAL AVE SE, ALBUQUERQUE, NEW MEXICO 87108



REVISIONS

Copyright: Design Group

Drawn by

Checked by

Project number

SHEET TITLE

SUBMITTAL

SHEET NUMBER

SITE DETAILS - DFT


**SP-10** 


Date

PROJECT NAME

DFT SUBMITTAL

Ketan D. Bharatiya NO. 5731

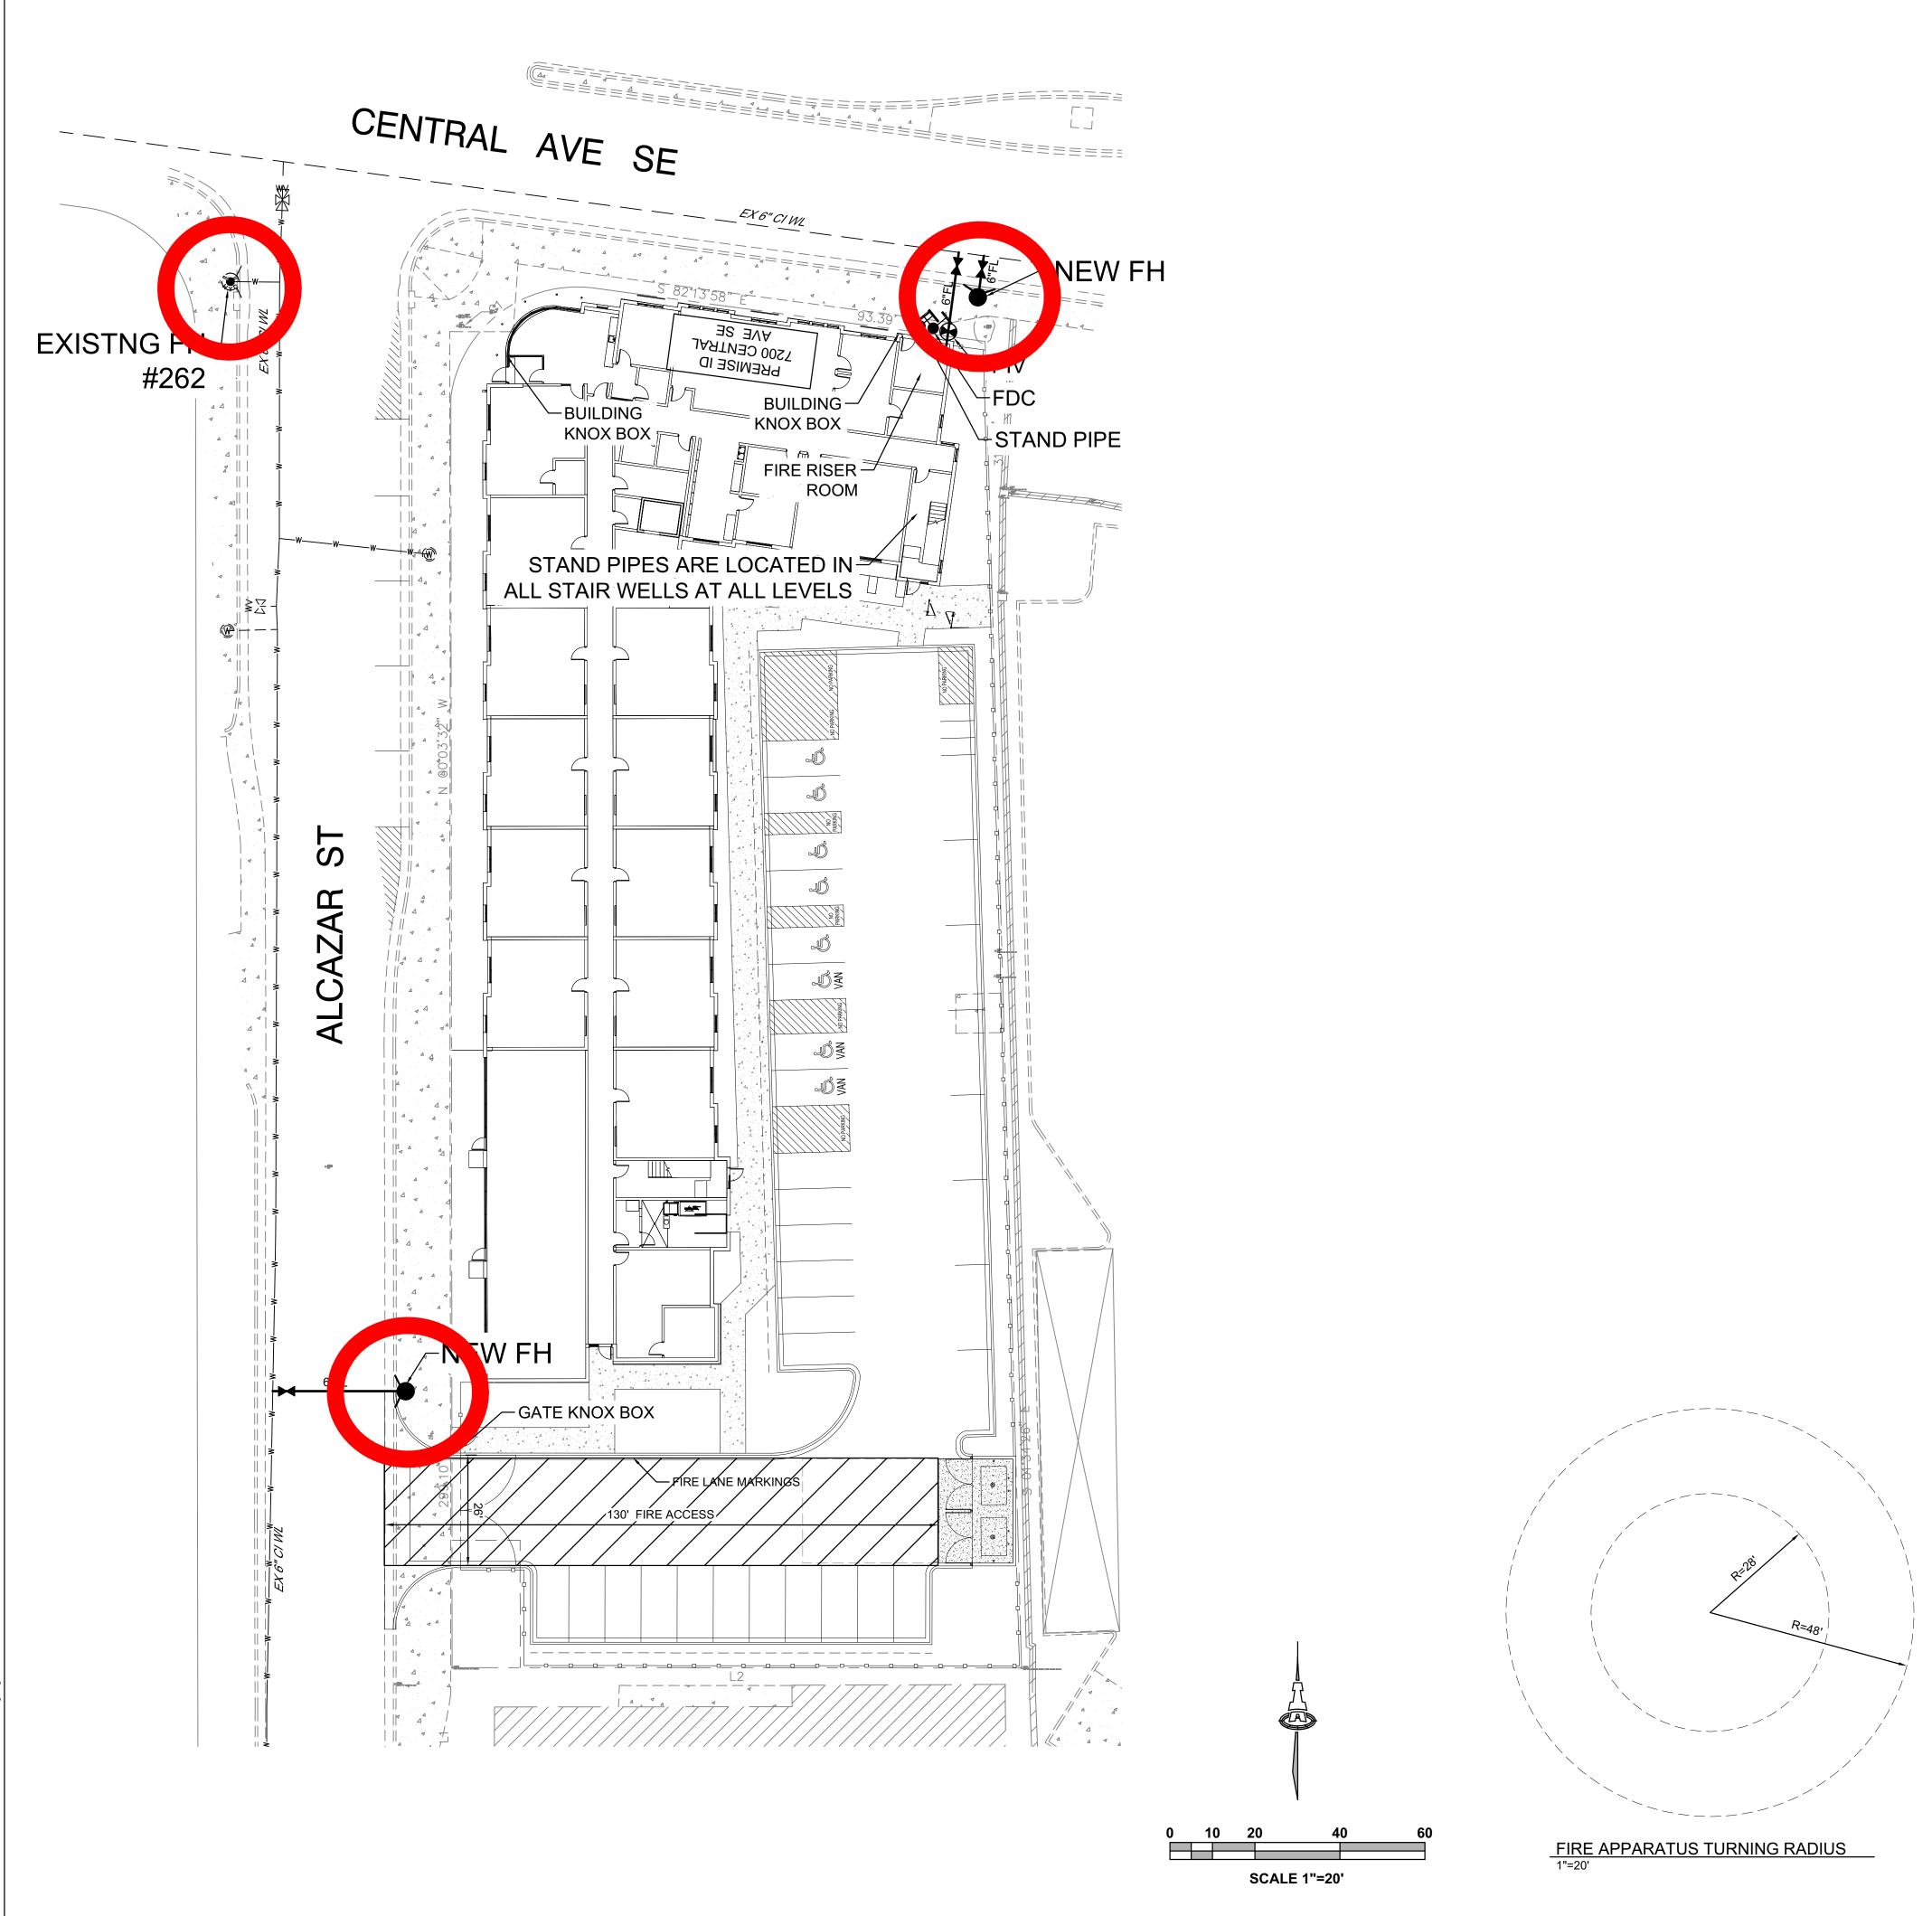

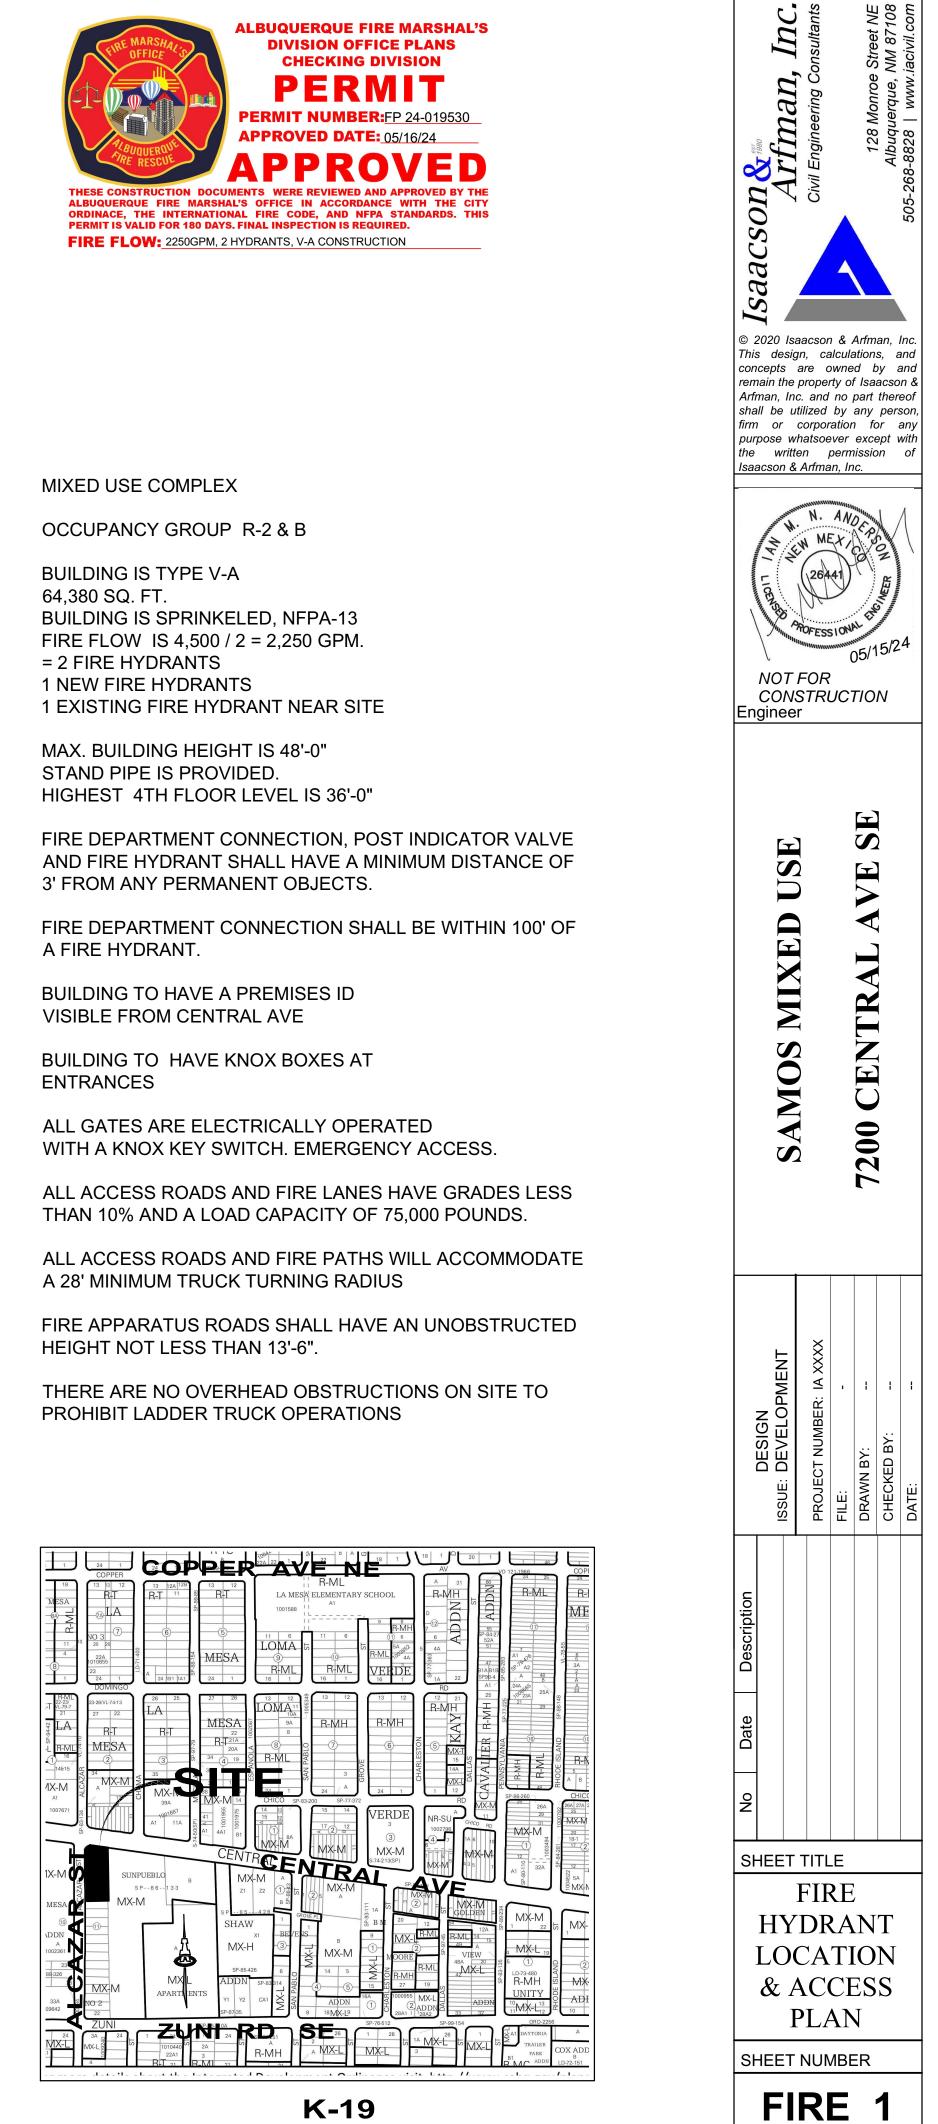

K-19

FP-24-019530