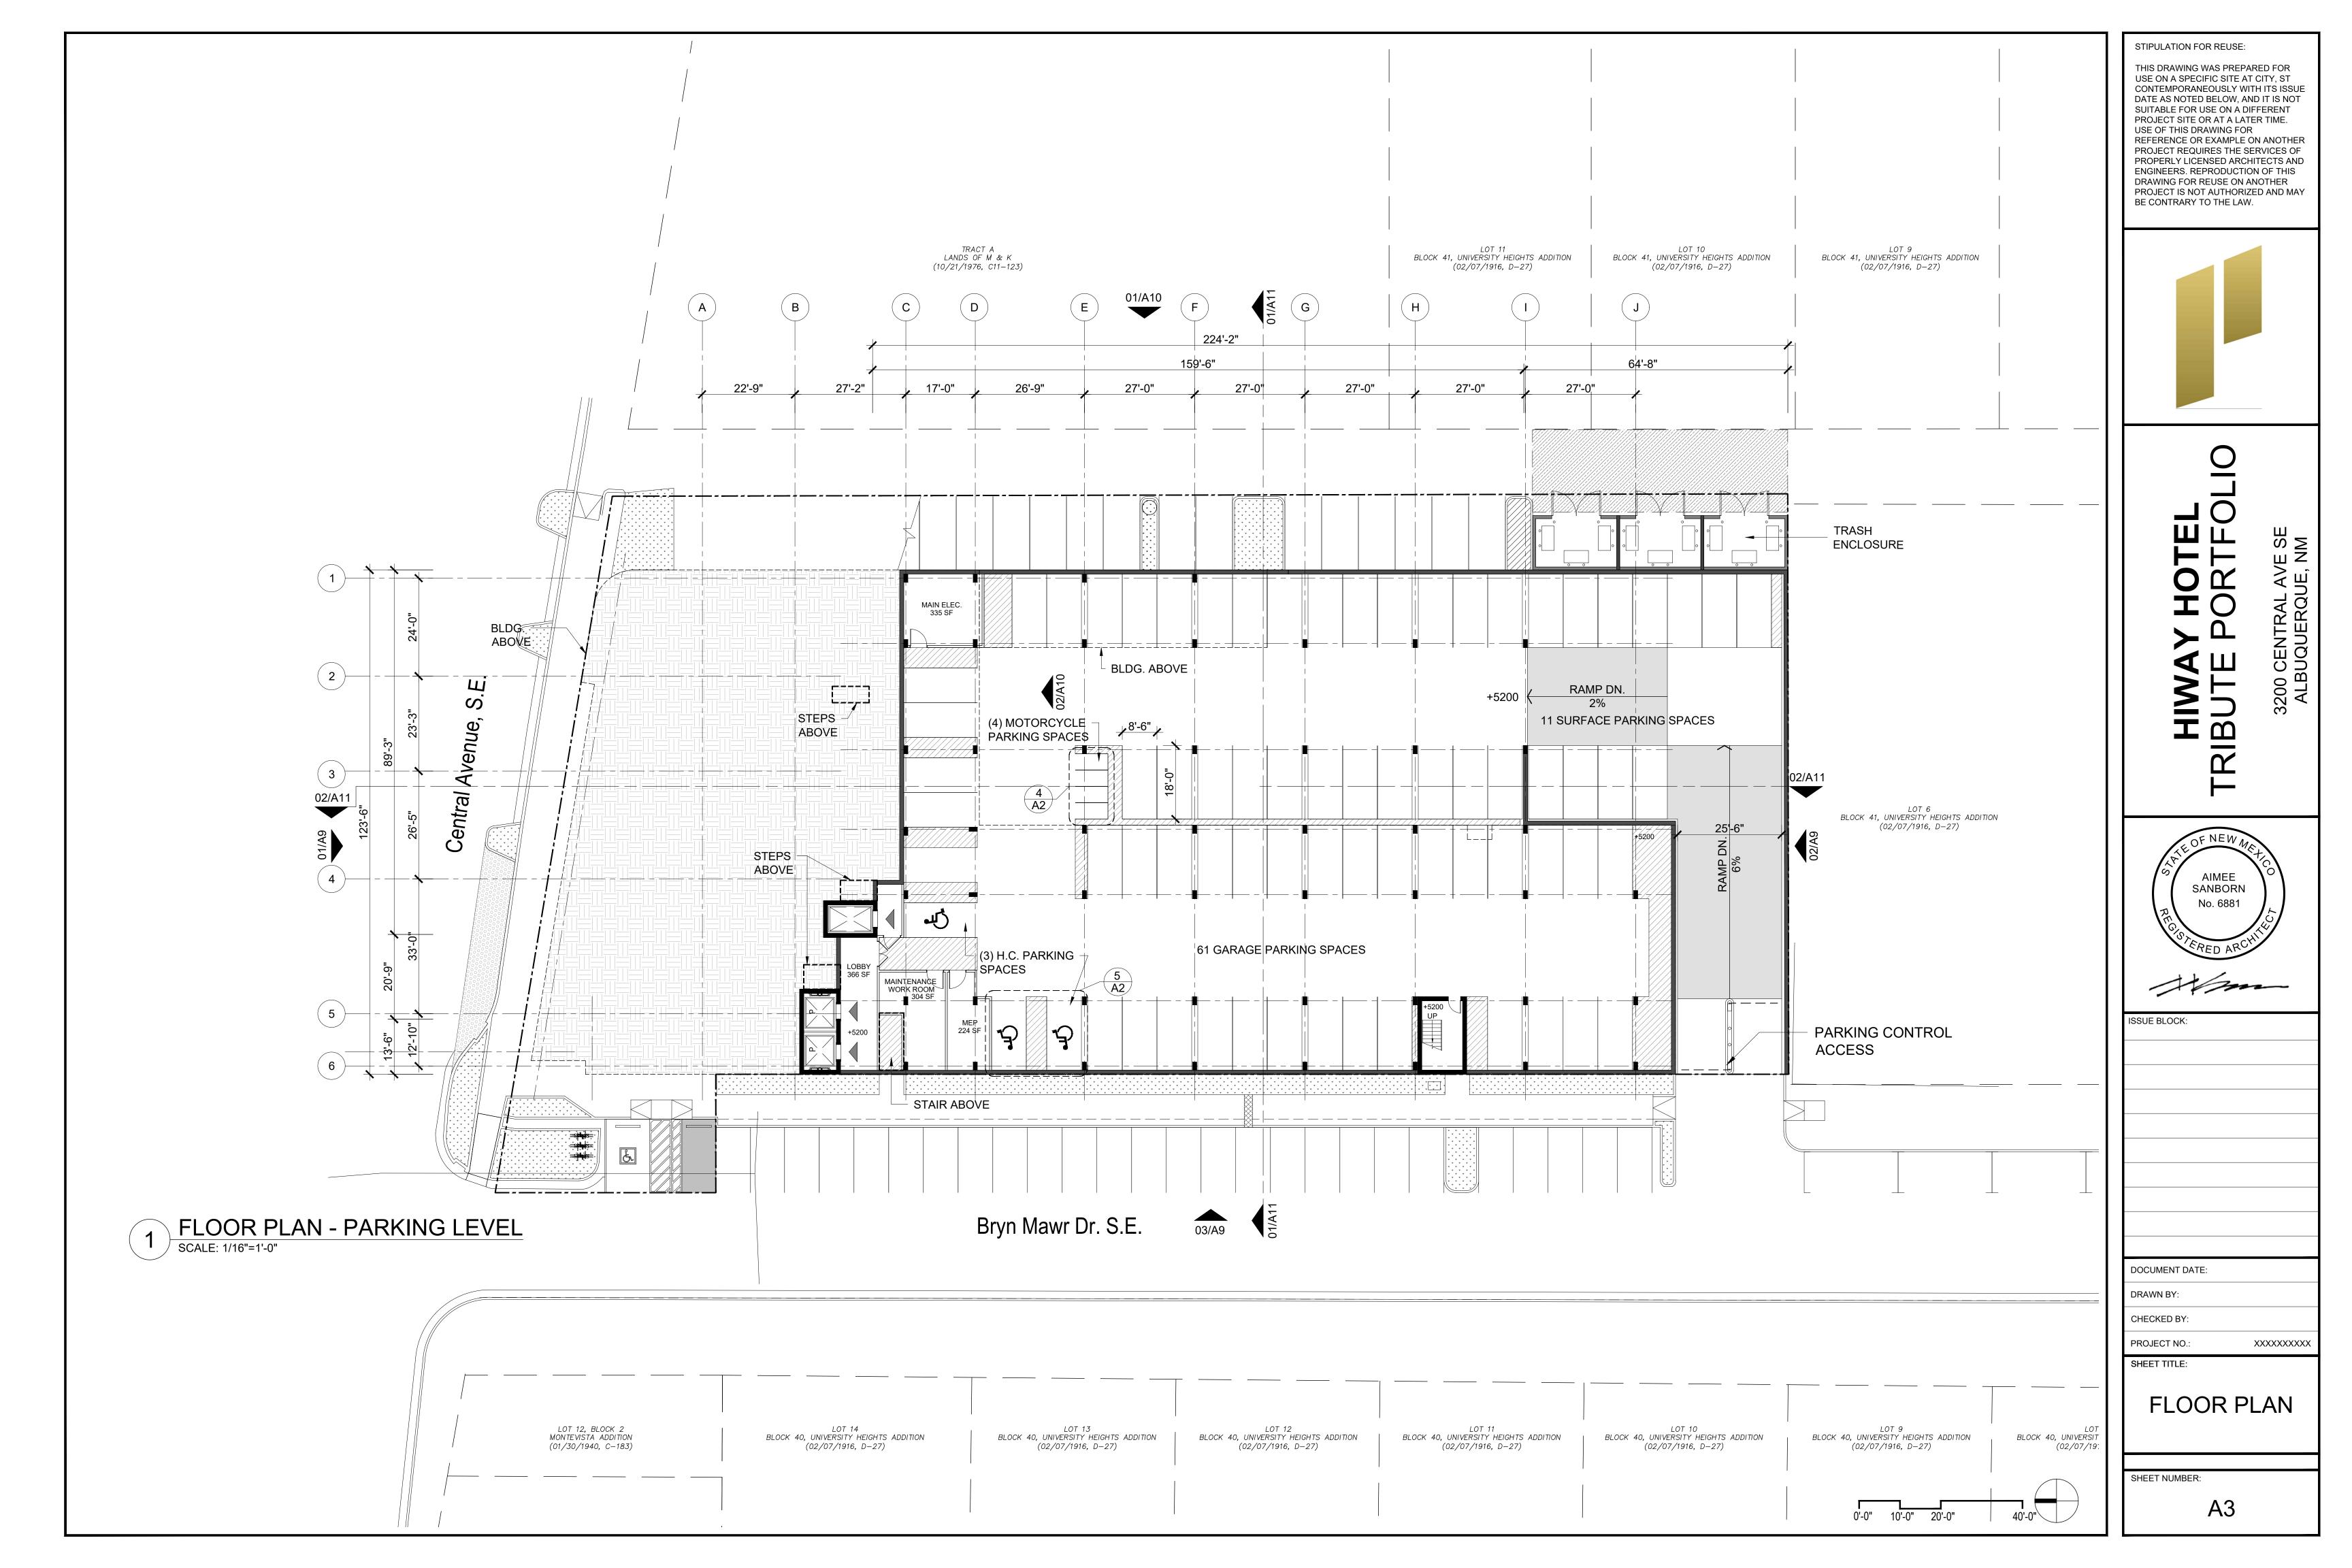
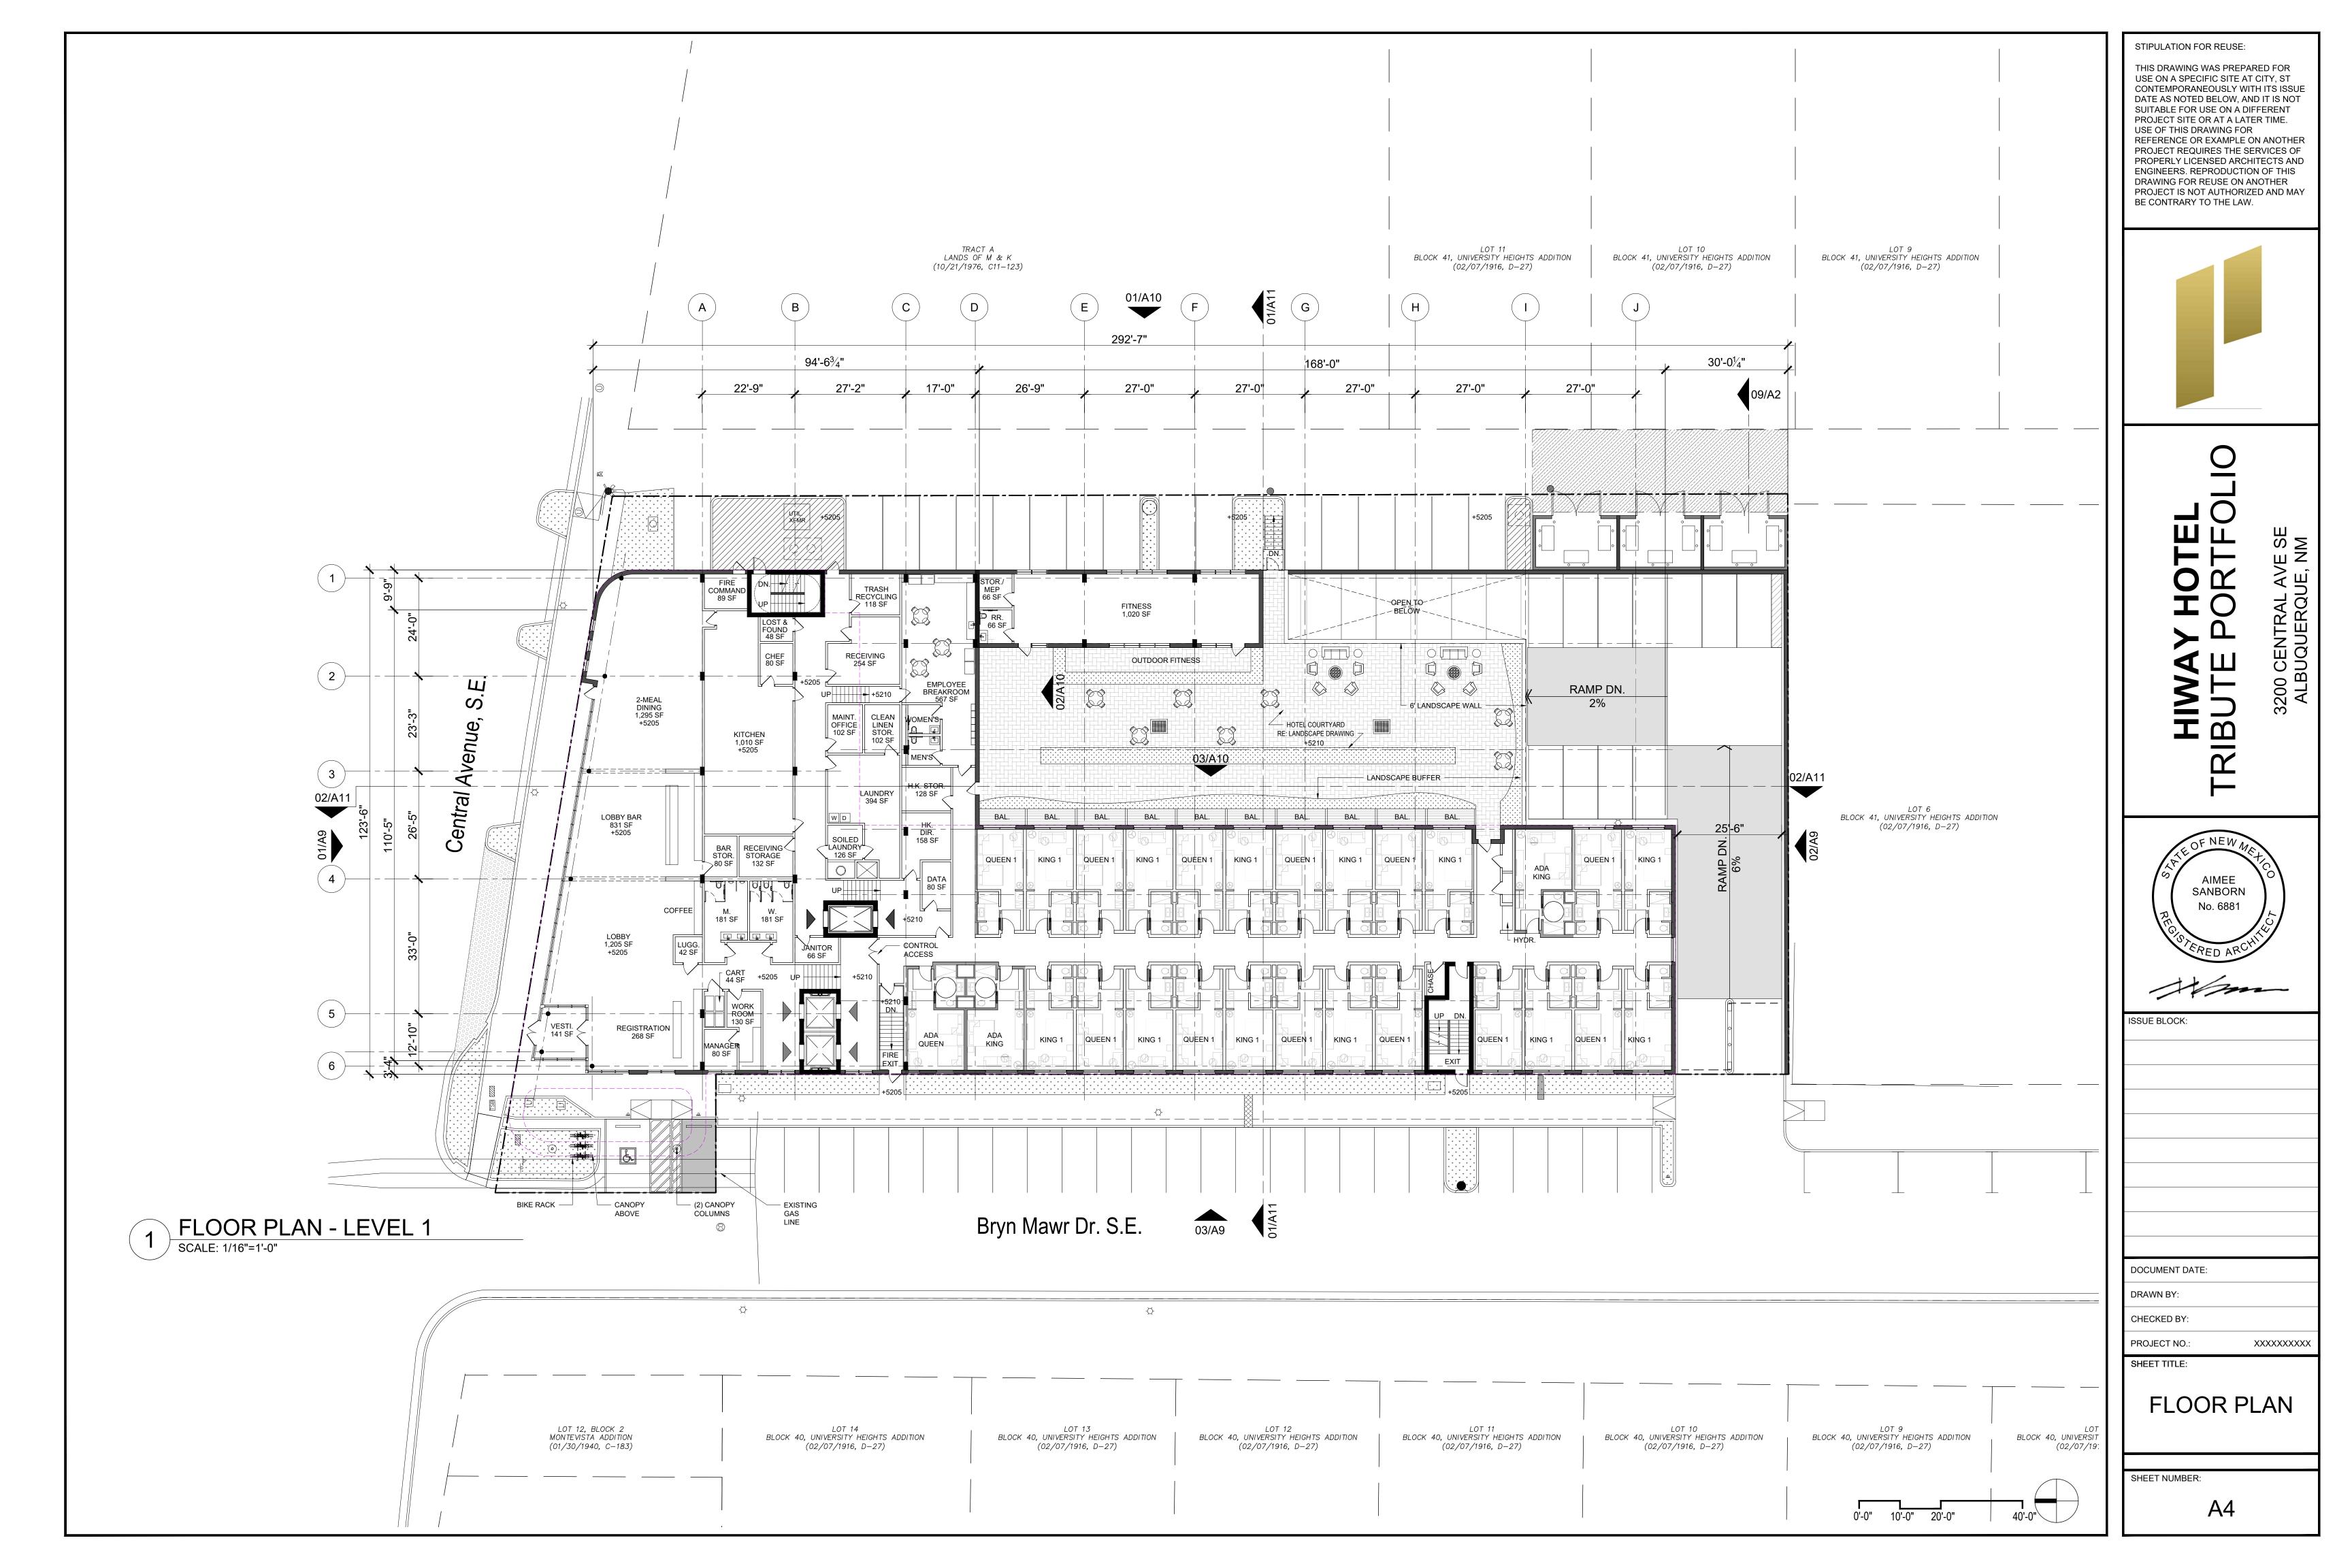
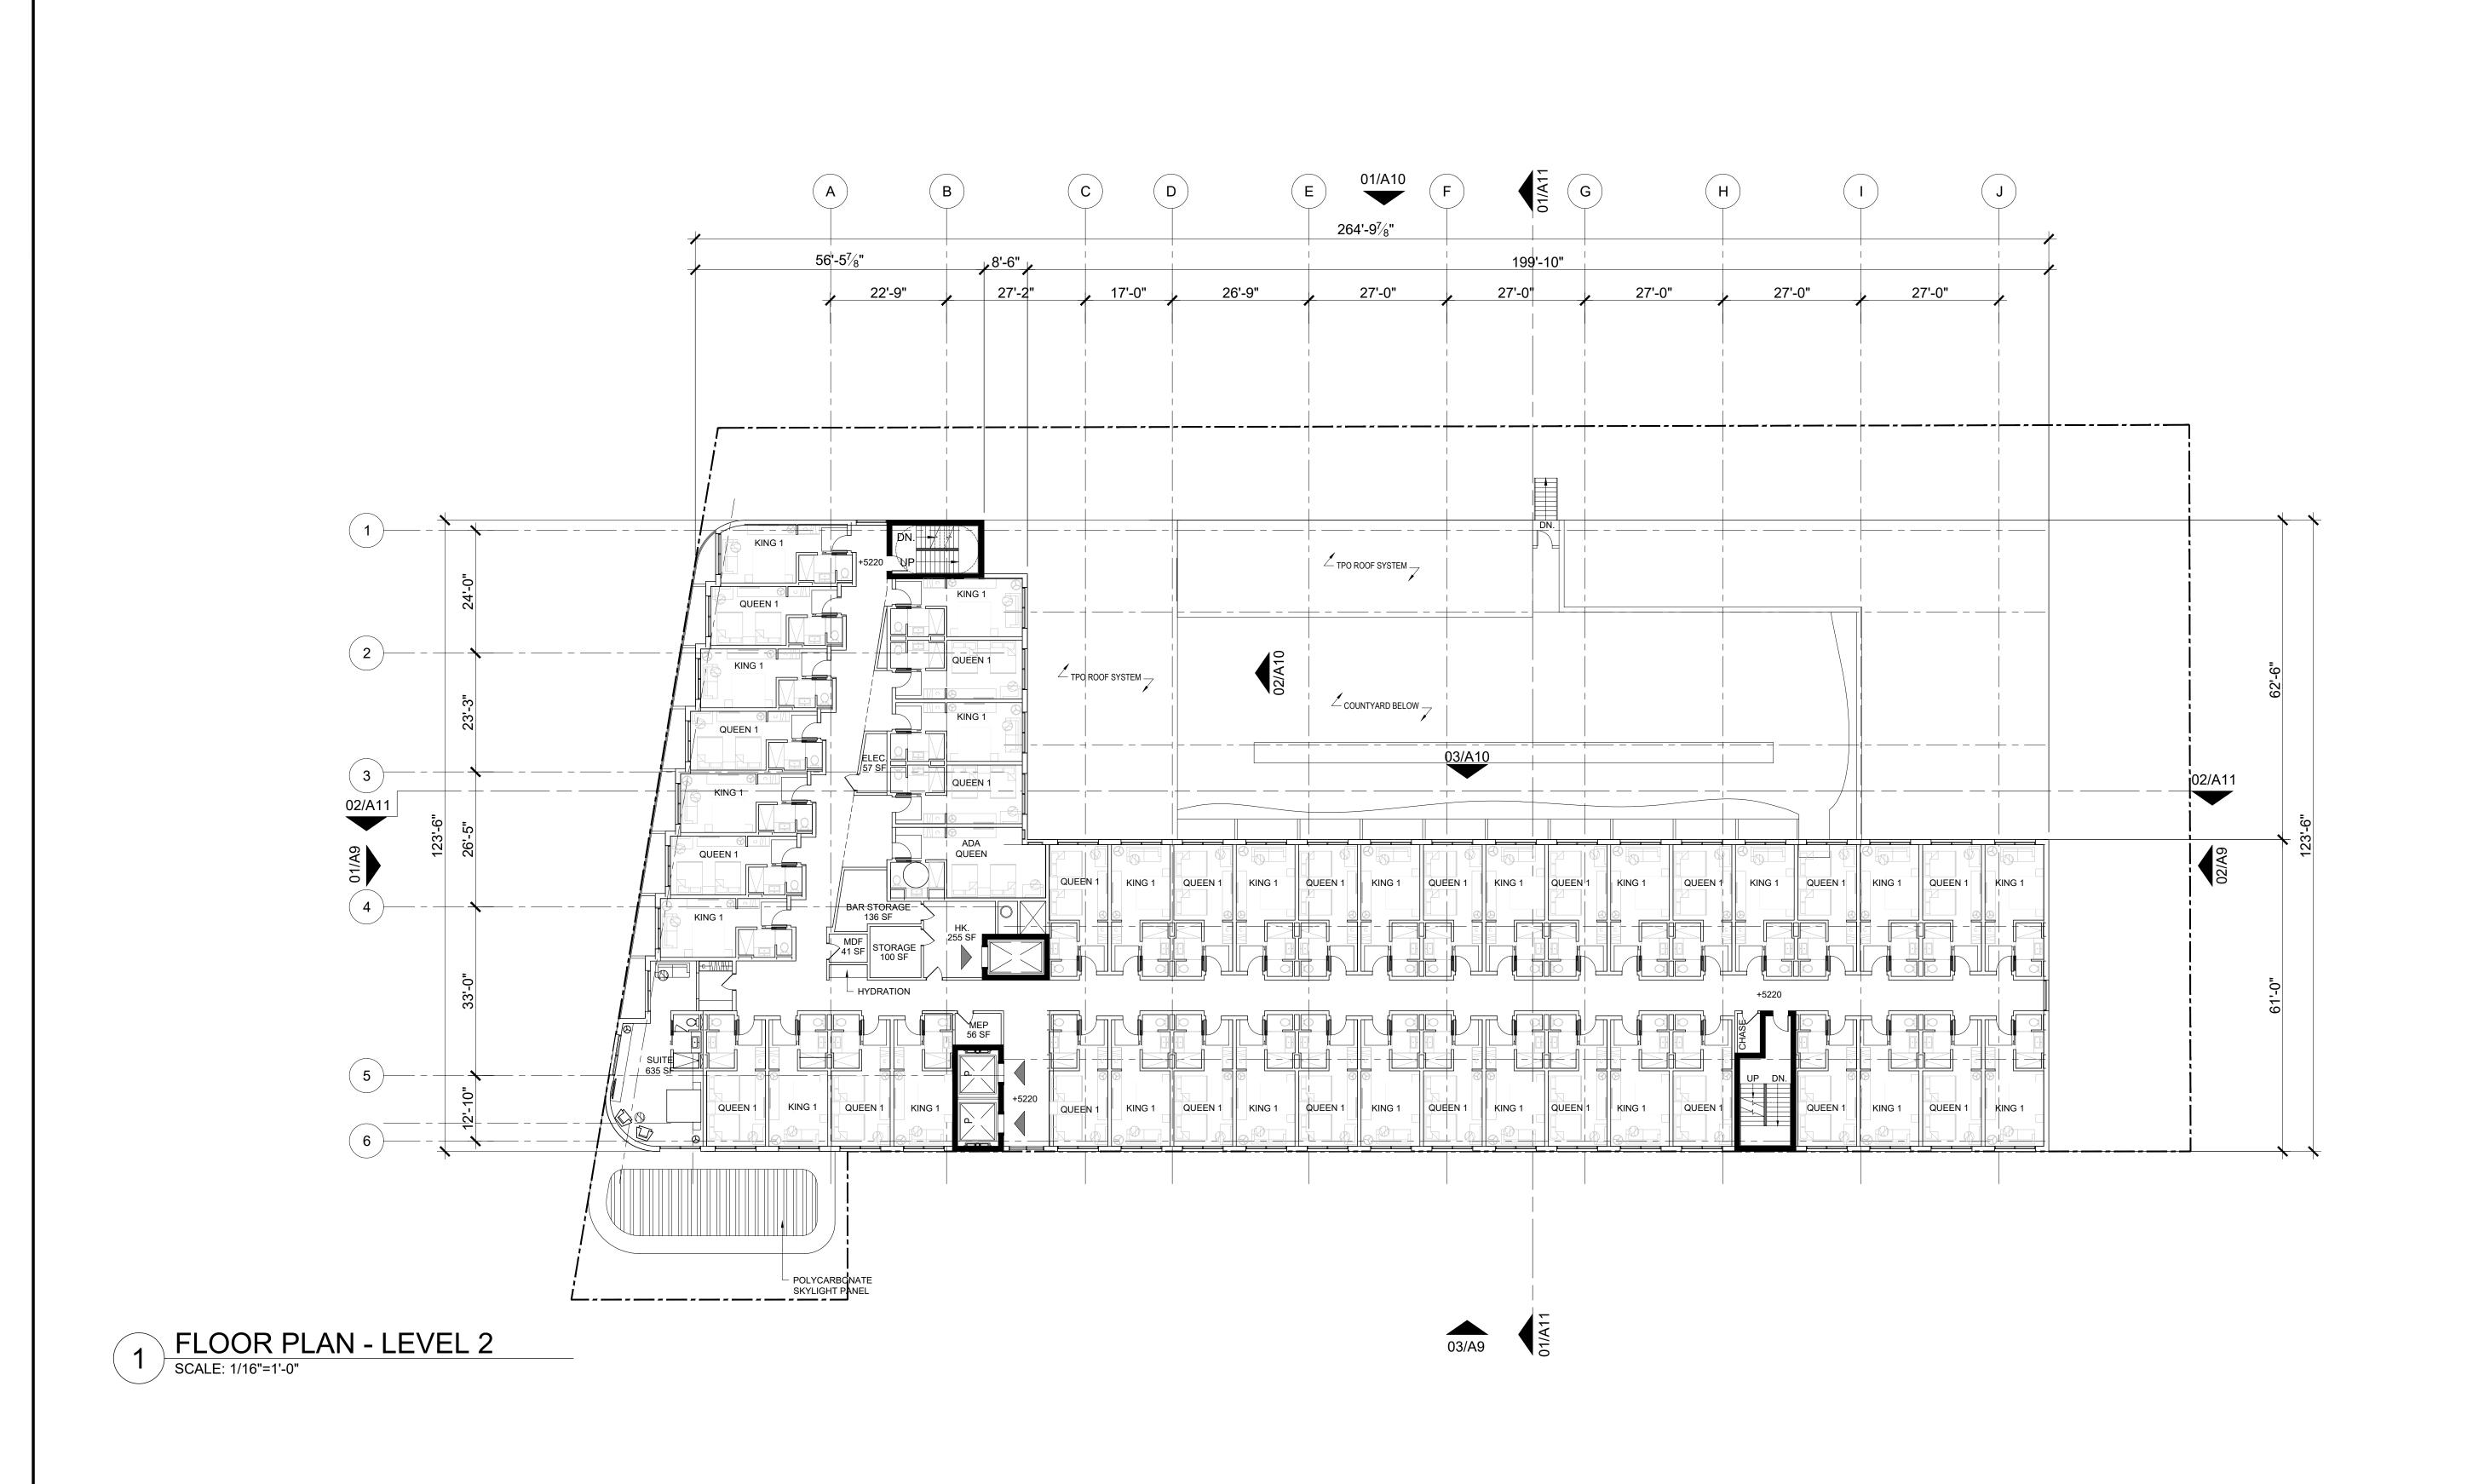


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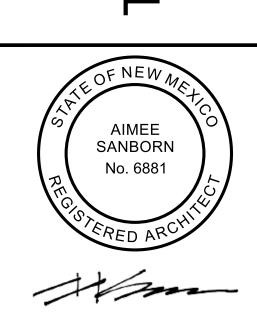


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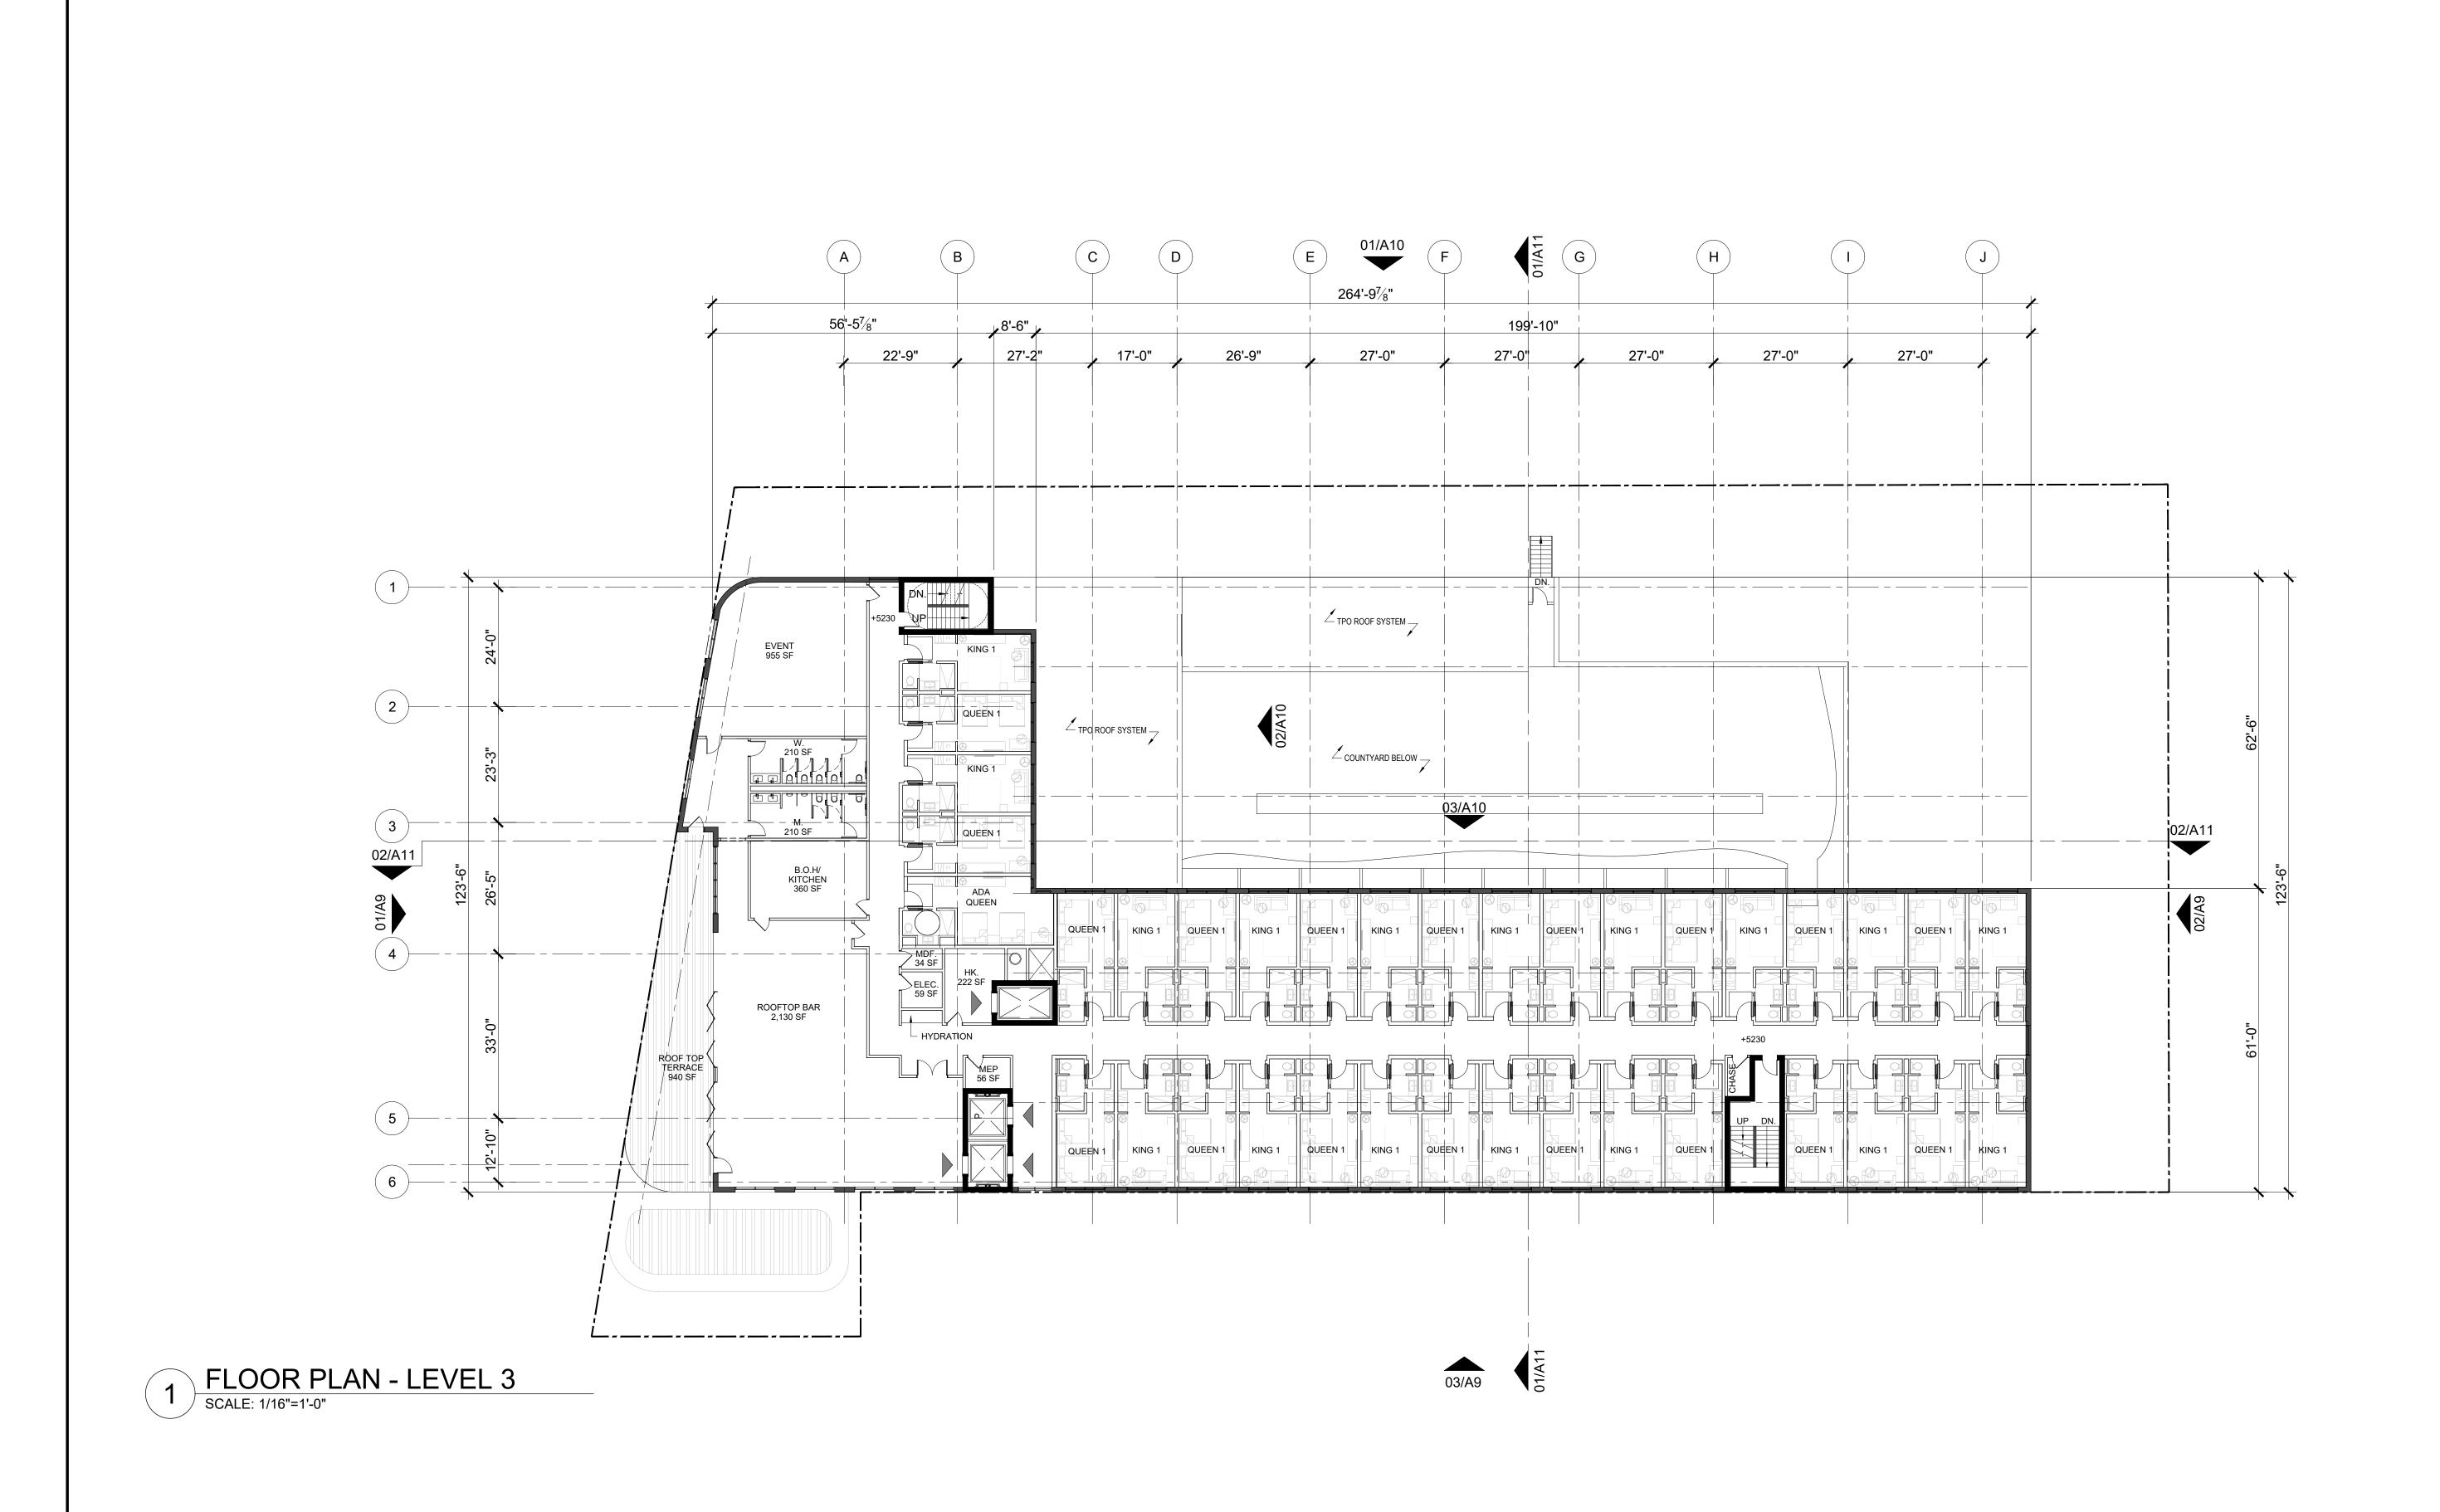
FLOOR PLAN

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SHEET NUMBER:

A5

-0" 10'-0" 20'-0" 40'-0"




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FLOOR PLAN

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SHEET NUMBER:

A6

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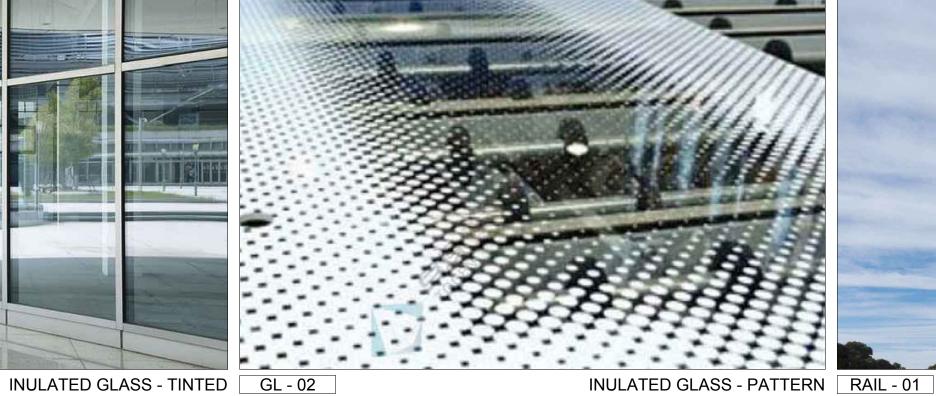


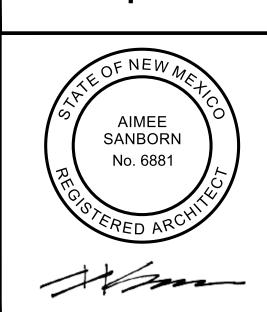






















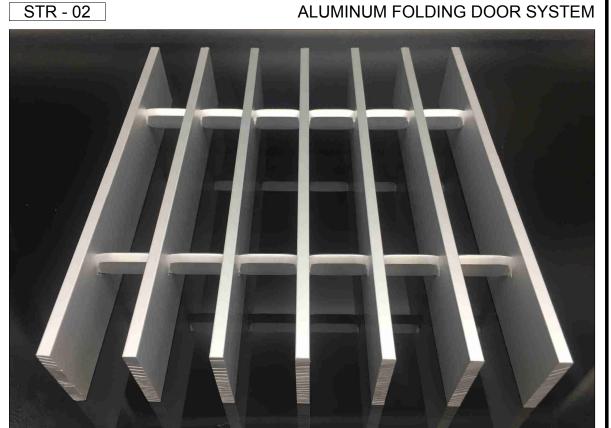





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3200 CENTRAL AVE ALBUQUERQUE, N

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ISSUE BLOCK:

MATERIALS

05.21.2025

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SHEET NUMBER:











POLYCARBONATE ROOF PANEL AG - 01

METAL PANEL (VERTICAL SLATS - WOOD TEXTURE) PC - 01

ALUMINUM GRATE

CHECKED BY: PROJECT NO.:

SHEET TITLE:

LEGEND

SANBORN No. 6881

A8



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INTERIM REVIEW NOT FOR REGULATORY APPROVAL PERMITTING OR CONSTRUCTION

REVISIONS:

Description

DOCUMENT DATE: DRAWN BY: CHECKED BY:

PROJECT NUMBER: THA024NA10001 SHEET TITLE:

ELEVATIONS

SHEET NUMBER:

1.00

EVENT +5231' GUESTROOM GUEST ROOM - LEVEL 3 126' - 0" GUESTROOM +5220'-6" GUESTROOM +5220'-6" GUEST ROOM - LEVEL 2 115' - 6" HK STOR. +5210' <u>GUEST ROOM - LEVEL 1</u> 105' - 0" GUEST ROOM - LEVEL 1 105' - 0" BOH BOH +5205' +5205' - LOBBY BAR -+5205' LAUNDRY +5205' PUBLIC SPACE - LEVEL 1 100' - 0" PUBLIC SPACE - LEVEL 1 GARAGE +5200' GARAGE LEVEL 95' - 0"

> GUESTROOM +5231' GUESTROOM +5231' <u>GUEST ROOM - LEVEL 3</u> 126' - 0" GUEST ROOM - LEVEL 3 126' - 0" GUESTROOM +5220'-6" GUESTROOM +5220'-6" GUEST ROOM - LEVEL 2 GUEST ROOM - LEVEL 2 115' - 6" GUESTROOM +5210' GUESTROOM +5210' GUEST ROOM - LEVEL 1 105' - 0" GUEST ROOM - LEVEL 1 105' - 0" PUBLIC SPACE - LEVEL 1 100' - 0" PUBLIC SPACE - LEVEL 1 GARAGE +5200' GARAGE LEVEL 95' - 0" GARAGE LEVEL 95' - 0"

OVERALL BUILDING SECTION:

LATITUDINAL

Scale: 3/32" = 1'-0"

OVERALL BUILDING SECTION:

2 LONGITUDINAL
Scale: 3/32" = 1'-0"

SHEET NUMBER: 2.00

THIS DRAWING WAS PREPARED FOR USE ON A SPECIFIC SITE AT ALBUQUERQUE, NM CONTEMPORANEOUSLY WITH ITS ISSUE DATE AS NOTED BELOW, AND IT IS NOT SUITABLE FOR USE ON A DIFFERENT PROJECT SITE OR AT A LATER TIME. USE OF THIS DRAWING FOR REFERENCE OR EXAMPLE ON ANOTHER PROJECT REQUIRES THE SERVICES OF PROPERLY LICENSED ARCHITECTS AND ENGINEERS. REPRODUCTION OF THIS DRAWING FOR REUSE ON ANOTHER PROJECT IS NOT AUTHORIZED AND MAY BE CONTRARY TO THE LAW.



CONSULTANTS:

HIWAY HOTEL
TITAN DEVELOPMENT

NOT FOR
REGULATORY
APPROVAL
PERMITTING OR
CONSTRUCTION

Description Date

DOCUMENT DATE: 08/22/2025

DRAWN BY: Author


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PROJECT NUMBER: THA024NA1
SHEET TITLE:

SECTIONS

SECTIONS



AREA (SF) - MINIMUM 10 % OF NET LOT AREA* TOTAL VEGETATIVE COVERAGE (SF) @ PLANT MATURITY (75% OF LANDSCAPE AREA) VEGETATIVE COVERAGE (SF) OF GROUND-LEVEL PLANTS (25% OF TOTAL, MINIMUM) *PER IDO 14-16-5-6(C)(2)(b), IN DT-UC-MS-PT AREAS, MINIMUM IS 10% OF NET LOT AREA. *FOR MULTI-FAMILY DWELLING, MINIMUM IS 25% OF NET LOT AREA. SEE 14-16-4-3(B)(8) FOR DETAILS. PLANTING AREA MULCH GRAVEL OR CRUSHER FINES (SF) *PER IDO 14-15-5-6(C)(5) The use of gravel or crusher fines as ground cover is limited to a maximum 50 percent in DT-UC-MS areas. STREET TREES - 1 PER 25 LF STREET FRONTAGE (143 LF) STREET TREES *PER IDO 14-15-5-6(D)(1)(a) TREES THAT ARE PLANTED WITHIN 20 FEET OF THE BACK OF CURB OF THE ABUTTING STREET MAY FULFILL THIS REQUIRED. REQUIRED PRODUIRED PRODUIRED *PER IDO 14-15-5-6(D)(1)(a) TREES THAT ARE PLANTED WITHIN 20 FEET OF THE BACK OF CURB OF THE ABUTTING STREET MAY FULFILL THIS REQUIREMENT. **TOTALS** **REQUIRED PRODUIRED		
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AREA (SF) - MINIMUM 10 % OF NET LOT AREA* TOTAL VEGETATIVE COVERAGE (SF) @ PLANT MATURITY (75% OF LANDSCAPE AREA) VEGETATIVE COVERAGE (SF) OF GROUND-LEVEL PLANTS (25% OF TOTAL, MINIMUM) *PER IDO 14-16-5-6(C)(2)(b), IN DT-UC-MS-PT AREAS, MINIMUM IS 10% OF NET LOT AREA. *FOR MULTI-FAMILY DWELLING, MINIMUM IS 25% OF NET LOT AREA. SEE 14-16-4-3(B)(8) FOR DETAILS. PLANTING AREA MULCH GRAVEL OR CRUSHER FINES (SF) *PER IDO 14-15-5-6(C)(5) The use of gravel or crusher fines as ground cover is limited to a maximum 50 percent in DT-UC-MS areas. STREET TREES - 1 PER 25 LF STREET FRONTAGE (143 LF) STREET TREES *PER IDO 14-15-5-6(D)(1)(a) TREES THAT ARE PLANTED WITHIN 20 FEET OF THE BACK OF CURB OF THE ABUTTING STREET MAY FULFILL THIS REQUIRED. *REQUIRED PRODUIRED PRODUIRED *PER IDO 14-15-5-6(D)(1)(a) TREES THAT ARE PLANTED WITHIN 20 FEET OF THE BACK OF CURB OF THE ABUTTING STREET MAY FULFILL THIS REQUIREMENT. **TOTALS** **REQUIRED PRODUIRED PRODUI		
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TOTALS REQUIRED PRO		
	·	
	VIDED	
TREES 5 6		

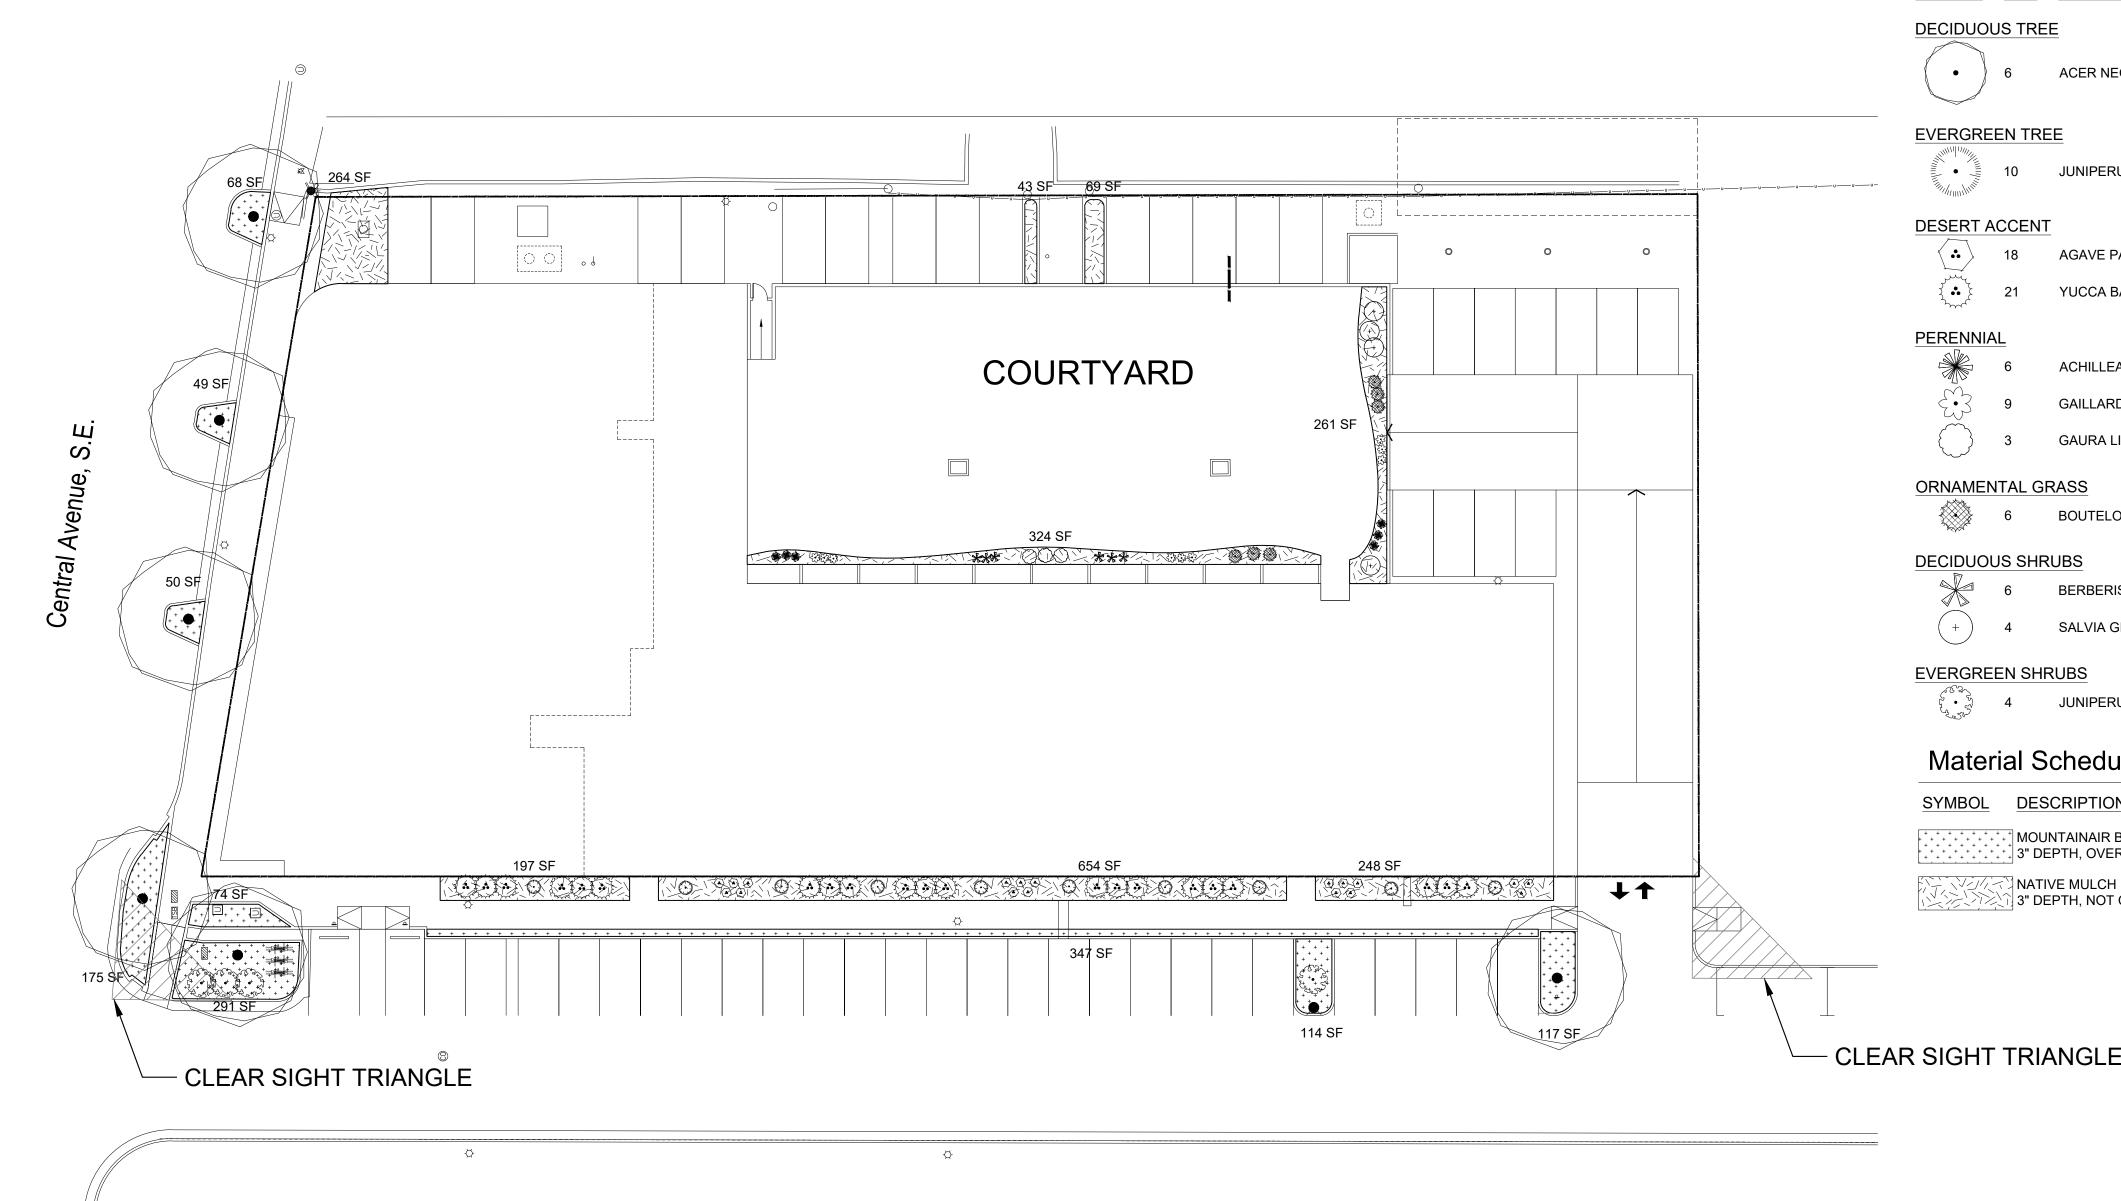GENERAL NOTES

- 1. IN CASE OF DISCREPANCIES IN PLANT QUANTITIES SHOWN ON THE PLANT SCHEDULE AND THOSE SHOWN ON THE PLAN, THE QUANTITIES SHOWN ON THE PLAN SHALL PREVAIL. CONTRACTOR SHALL VERIFY ALL QUANTITIES PRIOR TO BID AND INSTALLATION.
- 2. POSITIVE DRAINAGE AWAY FROM ALL STRUCTURES SHALL BE PROVIDED TO THE LANDSCAPE CONTRACTOR AND SHALL BE MAINTAINED BY THE LANDSCAPE CONTRACTOR THROUGHOUT THE DURATION OF THE PROJECT.
- 3. GRADING OF THE SITE PER THE GRADING PLAN IS NOT INCLUDED IN THE SCOPE OF WORK OF THE LANDSCAPE CONTRACTOR. GRADES PER
- THE GRADING PLAN SHALL BE PROVIDED TO THE LANDSCAPE CONTRACTOR +/- 1/10TH OF A FOOT, BY OTHERS. 4. ALL MAINTENANCE OF THE LANDSCAPE AND IRRIGATION SYSTEMS SHALL BE PROVIDED BY OWNER. NO CONTRACTUAL MAINTENANCE SHALL
- BE INCLUDED UNLESS OTHERWISE SPECIFIED IN THE BIDDING DOCUMENTS.
- 5. WATER MANAGEMENT IS THE SOLE RESPONSIBILITY OF THE PROPERTY OWNER. THE LANDSCAPE ARCHITECT IS NOT RESPONSIBLE FOR
- ANY RESTRICTIONS OF IRRIGATION WATER USE BY ANY GOVERNING BODY. 6. PER 5-6(C)(4)(a) A MINIMUM OF 5 SPECIES MUST BE USED IN THE LANDSCAPED AREA.
- 7. PER 5-6(C)(4)(b) ONLY TREES AND SHRUBS SELECTED FROM THE OFFICIAL ALBUQUERQUE PLANT PALETTE OF LOW WATER USE, DROUGHT TOLERANT, OR XERIC SPECIES AND SHOWN ON A LANDSCAPE PLAN CAN COUNT TOWARD THE REQUIREMENTS OF THIS SUBSECTION 14-16-5-6(C) (GENERAL LANDSCAPING STANDARDS), EXCEPT THAT, UPON PRESENTATION OF EVIDENCE, THE RELEVANT DECISION-MAKING BODY MAY AUTHORIZE ALTERNATIVE SPECIES OR CULTIVARS THAT MEET ALL OF THE FOLLOWING REQUIREMENTS:
- 1.MEET THE INTENDED PURPOSE OF THAT TYPE OF LANDSCAPING. 2.ARE NOT HAZARDOUS.
- 3.ARE NOT IDENTIFIED AS INVASIVE ON A CITY OR STATE PLANT LIST.
- 4.ARE NOT LISTED IN THE CITY'S WEED IDENTIFICATION HANDBOOK. 5.ARE EQUALLY HARDY TO THE NEW MEXICO CLIMATE.
- 8. PER 5-3(D)(3)(a) 3, SHADE TREES ALONG REQUIRED PEDESTRIAN WALKWAYS ARE REQUIRED PURSUANT TO SUBSECTION 14-16-5-6(C)(4)(i) (REQUIRED PLANT MATERIALS AND SITE AMENITIES). 5-6(C)(4)(i) SHADE TREES PLANTED APPROXIMATELY 25 FEET ON-CENTER ARE REQUIRED ALONG ALL REQUIRED PEDESTRIAN WALKWAYS. IF THE WALKWAY IS LESS THAN FEET LONG, AT LEAST ONE TREE IS REQUIRED, OR, WHERE THERE IS INSUFFICIENT SPACE FOR A TREE, A TRELLIS OF AT LEAST 8 FEET HIGH FOR AT LEAST 5 FEET ALONG THE WALKWAY SHALL BE PROVIDED.
- 9. PER 5-6(F)(1)(i) 1 OF THE IDO, ANY PARKING LOT LOCATED WITHIN 30 FEET OF THE FRONT LOT LINE SHALL BE SCREENED FROM THE STREET EITHER BY A MASONRY WALL CONSTRUCTED OF A MATERIAL SIMILAR IN TEXTURE, APPEARANCE, AND COLOR TO THE STREET-FACING FAÇADE OF THE PRIMARY BUILDING (BUT EXCLUDING EXPOSED CMU BLOCK) AT LEAST 3 BUT NOT MORE THAN 4 FEET IN HEIGHT, OR BY A LANDSCAPE BUFFER AT LEAST 10 FEET IN WIDTH WITH A CONTINUOUS LINE OF EVERGREEN SHRUBBERY 3 FEET IN HEIGHT, OR BY OTHER MEANS THAT THE PLANNING DIRECTOR DETERMINES PROVIDES EQUAL OR BETTER SCREENING OF THE HEADLIGHTS OF PARKED VEHICLES.
- 10. PER 5-6(C)(9)(a), ALL PLANTING OF VEGETATED MATERIAL OR INSTALLATION OF ANY LANDSCAPING, BUFFERING, OR SCREENING MATERIAL IN THE PUBLIC RIGHT-OF-WAY SHALL REQUIRE THE PRIOR APPROVAL OF THE CITY. THE PROPERTY OWNER SHALL BE RESPONSIBLE FOR THE
- MAINTENANCE, REPAIRS, OR LIABILITY FOR ALL THE LANDSCAPING PLACED IN OR OVER THE PUBLIC RIGHT-OF-WAY. 11. PER 5-6(C)(9)(b), ANY TREES THAT OVERHANG A PUBLIC SIDEWALK OR MAJOR PUBLIC OPEN SPACE SHALL BE TRIMMED TO MAINTAIN AN 8 FOOT CLEARANCE OVER THE SIDEWALK. ANY TREES THAT OVERHANG A PUBLIC STREET SHALL BE TRIMMED TO MAINTAIN A 9' CLEARANCE
- OVER THE STREET SURFACE. 12. PURSUANT TO 5-6(C)(5)(e), BARK MULCH AREAS CLEARLY DELINEATED ON PLANS FOR LANDSCAPE AREAS AND 5' RADIUS RINGS AROUND
- 13. PURSUANT TO 5-6(C)(7)(a), ALL VEGETATION HAS BEEN LOCATED A MINIMUM OF 3' IN ANY DIRECTION FROM FIRE HYDRANTS, VALVE VAULTS, HOSE BIBS, MANHOLES, HYDRANTS AND FIRE DEPARTMENT CONNECTIONS.
- 14. PURSUANT TO 5-6(C)(10)(a), TREES AND SHRUBS SHALL NOT BE PLANTED IN UTILITY EASEMENTS UNLESS THERE IS NO OTHER PRACTICABLE LOCATION ON THE LOT WHERE THE LANDSCAPING WOULD ACHIEVE ITS INTENDED PURPOSE.
- 15. PURSUANT TO 5-6(C)(10)(b), TREES SHALL NOT BE PLANTED WITHIN 10' IN ANY DIRECTION OF THE CENTERLINE OF A SEWER OR WATER LINE. 16. CLEAR SIGHT TRIANGLE NOTE: LANDSCAPING, SIGNAGE, WALLS, FENCES, TREES, AND SHRUBBERIES BETWEEN 3' AND 8' TALL (AS MEASURED FROM THE GUTTER PAN) ARE NOT ALLOWED WITHIN THE CLEAR SIGHT TRIANGLE.

Plant Schedule

SYMBOL	QTY	BOTANICAL / COMMON NAME	SIZE	<u>H X W</u>	COVERAGE
DECIDUO	US TRE	<u>E</u>			
	6	ACER NEGUNDO `SENSATION` / SENSATION BOX ELDER MAPLE	2" B&B	40` X 30`	707
EVERGRE	EN TRE	<u>:E</u>			
	10	JUNIPERUS SCOPULORUM `BLUE ARROW` / BLUE ARROW JUNIPER	6`	15' X 3'	7
DESERT A	ACCENT	- -			
••	18	AGAVE PARRYI / PARRY`S AGAVE	5 GAL	2` X 2`	3
**	21	YUCCA BACCATA / BANANA YUCCA	5 GAL	4` X 5`	20
PERENNIA	<u>AL</u>				
	6	ACHILLEA X `MOONSHINE` / MOONSHINE YARROW	1 GAL	2` X 2`	3
£3	9	GAILLARDIA X GRANDIFLORA / BLANKETFLOWER	1 GAL	2` X 2`	3
	3	GAURA LINDHEIMERI 'WHIRLING BUTTERFLIES' / WHIRLING BUTTERFLIES GAURA	1 GAL	3, X 3,	7
ORNAMENTAL GRASS					
	6	BOUTELOUA GRACILIS 'BLONDE AMBITION' / BLONDE AMBITION BLUE GRAMA	1 GAL	3, X 3,	7
DECIDUOUS SHRUBS					
	6	BERBERIS THUNBERGII `CRIMSON PYGMY` / CRIMSON PYGMY BARBERRY	5 GAL	2` X 2`	3
+	4	SALVIA GREGGII / AUTUMN SAGE CHERRY	5 GAL	3` X 4`	13
EVERGREEN SHRUBS					
* * * * * * * * * * * * * * * * * * *	4	JUNIPERUS SABINA 'BUFFALO' / BUFFALO JUNIPER	5 GAL	1' X 6'	28

Material Schedule

SYMBOL	DESCRIPTIO

MOUNTAINAIR BLUSH 7/8" GRAVEL 3" DEPTH, OVER FILTER FABRIC

NATIVE MULCH ☐ 3" DEPTH, NOT OVER WEED BARRIER


CENTRAL LEADER (IF EXISTING) TO BE LEFT UNPRUNED LIGHT PRUNING IF NEEDED. RUBBING, CROSSED OR DAMAGED BRANCHES TO BE REMOVED REMOVE PLANT IDENTIFICATION TAGS BEFORE JOB IS COMPLETE TRUNK TO BE STAKED WITH (2) WOODEN TREE STAKES WITH RUBBER PROTECTION AT TRUNK. STAKES AND TIES TO BE REMOVED AFTER ONE YEAR FEATHER ORGANIC MULCH TO A 2" DEPTH OVER PLANT ROOTBALL 5' RADIUS FROM TRUNK, KEEP MULCH 2" AWAY FROM TRUNK.

NO WEED BARRIER OVER ROOTBALL. BURY DEPTH OF TREE IS AT ROOT FLARE AND HOLE BERM EXCAVATED SOIL AROUND EDGE OF PLANTING PIT TO AID IN

ALL ROPES REMOVED, TOP HALF OF BURLAP AND WIRE BASKET REMOVED, BURLAP SLIT FOR ROOT EXTENSION PLANTING PIT TO BE 2-3 TIMES WIDTH OF ROOT BALL, DEPTH OF PIT TO BE SAME AS ROOT BALL HEIGHT. SIDES OF PIT NOT TO BE OVERLY COMPACTED TO ALLOW ROOT GROWTH BEYOND PLANTING PIT 2/3 NATIVE SOIL AND 1/3 COMPOSTED SOIL AMENDMENT TO BE USED AS BACKFILL. AMENDMENT TO BE WELL COMPOSTED AND FREE OF DEBRIS OR DELETERIOUS MATERIALS.


UNDISTURBED PIT BOTTOM FOR ROOTBALL BASE

TREE PLANTING DETAIL

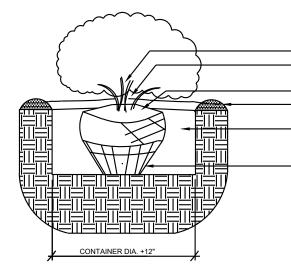


REMOVE PLANT IDENTIFICATION TAGS BEFORE JOB IS COMPLETE FEATHER MULICH TO A 2" DEPTH OVER PLANT ROOTBALL KEEP MULICH 2" AWAY FROM CENTER OF SHRUB. NO WEED BARRIER OVER ROOTBALL SET SHRUB ON UNDISTURBED PIT BOTTOM PLUMB AND STRAIGHT BERM REMOVED SOIL AT EDGE OF PLANTING PIT TO AID IN 2/3 NATIVE SOIL AND 1/3 COMPOSTED SOIL AMENDMENT TO BE USED AS BACKFILL. AMENDMENT TO BE WELL COMPOSTED AND FREE OF DEBRIS OR DELETERIOUS MATERIALS. IF EXCESSIVE ROOTS ARE PRESENT ON ROOTBALL SCORE THE SIDES OF ROOTBALL TO DISCOURAGE ROOT CIRCLING

SHRUB PLANTING DETAIL

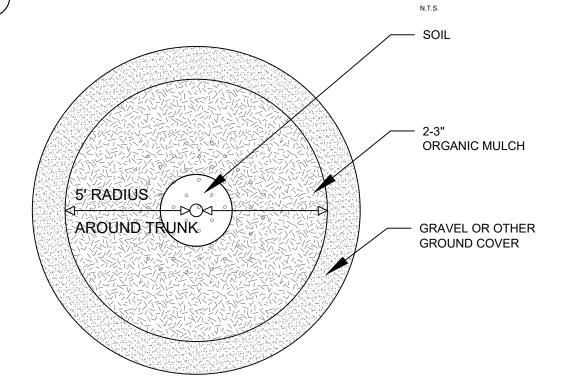


TREE DETAIL

www.yellowstonelandscape.com PO Box 10597 Albuquerque, NM 87184 505.898.9615 design@yellowstonelandscape.com

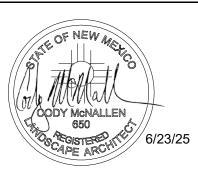


Date: 01/06/2025 Revisions: 01/21/2025 05/23/2025

Drawn by: Pl Reviewed by: CM

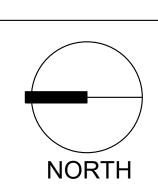

Albuque


Scale: 1" = 20'

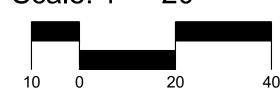

Sheet Title: Landscape Plan

Sheet Number:



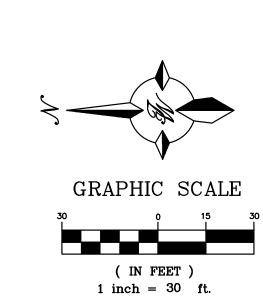



3200 CENTRAL AVE SE CITY OF ALBUQUERQUE, BERNALILLO COUNTY HOTEL/RESTAURANT OCCUPANCY R-1 HOTEL

LOT AREA: 42542 SF (0.977 ACRES) 63418 SF (GROSS BUILDING AREA BUILDING AREA: 3 STORIES)

CONSTRUCTION TYPE: FULLY SPRINKLED TYPE II-B

MAX BUILDING HEIGHT

FIRE FLOW 2625 gpm (5250 gpm W/50% REDUCTION)

FIRE HYDRANTS REQUIRED FIRE HYDRANTS PROVIDED

<u>NOTES</u>

1. ON SITE FIRE LANE ROAD SHALL BE MARKED ON BOTH SIDES, AS DIRECTED BY FIRE MARSHALL

2. FIRE APPARATUS ACCESS ROADS SHALL NOT EXCEED 10 PERCENT IN GRADE AND SHALL HAVE AN ALL WEATHER DRIVING SURFACE CAPABLE OF SUPPORTING THE IMPOSED LOAD OF FIRE APPARATUS WEIGHING AT LEAST 75000 LBS

3. KEY BOX (KNOX BOX) SHALL BE MOUNTED BETWEEN 4 AND 6 FEET ABOVE GRADE AND SHALL BE ILLUMINATED.



THE ALBUQUERQUE FIRE MARSHAL'S OFFICE IN ACCORDANCE WITH THE CITY ORDINANCE, THE INTERNATIONAL FIRE CODE, AND NFPA STANDARDS. THIS PERMIT IS VALID FOR 180 DAYS. FINAL INSPECTION IS REQUIRED. FIRE FLOW: 2625GPM, 3HYDRANTS

LEGEND

	BOUNDARY LINE
	BUILDING
	EXISTING CURB & GUTTER
\bowtie	EXISTING GATE VALVE
	EXISTING WATERLINE
U	EXISTING OVERHEAD POWER LINE
•	EXISTING POWER POLE
\$	EXISTING LIGHT POLE

---- FIRE LANE

KEYED NOTES

1 FDC

2 BUILDING ADDRESS

3 EXISTING FIRE HYDRANT

4 PROPOSED FIRE HYDRANT 6" WL, 6" GATE VALVE

5 EXIST 6" CI WL

(6) EXIST 8" SAS VCP

7 EXIST 6" STEEL WL

8 EXIST 12" STL WL

9 EXIST OVERHEAD POWER LINE

10 GREASE TRAP

(11) 6" SAS SERVICE

(12) 3" DOMESTIC WL SERVICE

13 6" FIRE LINE

(14) KNOX BOX

(15) 2" IRRIGATION SERVICE

16) TRANSFORMER

17) EXIST SAS MH


18) NOT USED

19 NOT USED

20) NEW 6" GATE VALVE

21) EXIST TRAFFIC CONTROL AND POWER CABINETS

(22) EXIST PULL BOX

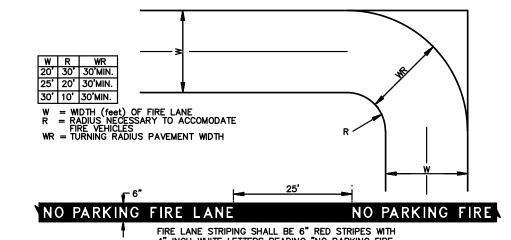

FIRE LANE STRIPING SHALL BE 6" RED STRIPES WITH 4" INCH WHITE LETTERS READING "NO PARKING FIRE LANE" STRIPING SHALL BE PLACED ON THE TOP EDGE OF THE SIDEWALK ABUTTING THE PAVED DRIVE OR AS SPECIFIED BY LOCAL REQUIREMENTS. NO PARKING FIRE NO PARKING FIRE LANE

FIRE LANE MARKING N.T.S.

ENGINEER'S SEAL	3200 CENTRAL AVE SE ALBUQUERQUE, NM
DR. BOHANA ON MEXICO Z 7868	HIGHWAY HOUSE FIRE ONE
ETTS SONAL ENGINE	TIERRA WEST, LLC
8-11-25	T 5571 MIDWAY PARK PL NE ALBUQUERQUE, NEW MEXICO 87109
RONALD R. BOHANNAN P.E. #7868	(505) 858-3100 www.tierrawestllc.com

DRAWN BY

pm

DATE

8-18-25


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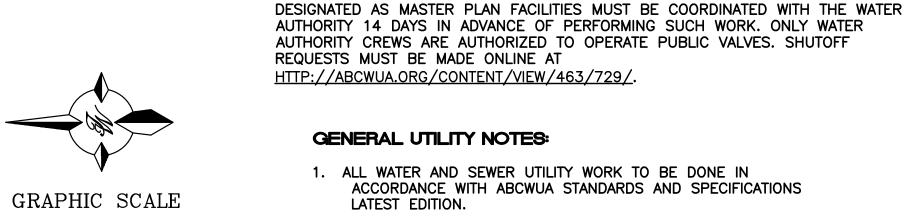
SHEET #

FO-1

JOB # 2024042





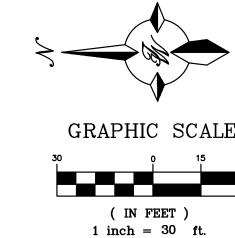

HTTP://ABCWUA.ORG/CONTENT/VIEW/463/729/.

THE CONTRACTOR SHALL COORDINATE WITH THE WATER AUTHORITY SEVEN (7) DAYS

IN ADVANCE OF PERFORMING WORK THAT WILL AFFECT THE PUBLIC WATER OR SANITARY SEWER INFRASTRUCTURE. WORK REQUIRING SHUTOFF OF FACILITIES

SHUOFF VALVES 922 AND 1022

GENERAL UTILITY NOTES:

WATER SHUOFF

- 1. ALL WATER AND SEWER UTILITY WORK TO BE DONE IN ACCORDANCE WITH ABCWUA STANDARDS AND SPECIFICATIONS
- 2. 4' MINIMUM BURY REQUIRED FOR ALL UTILITIES UNLESS OTHERWISE NOTED.
- 3. REFERENCE PLUMBING PLANS FOR WATER LINE RISER LOCATIONS. BACKFLOW PREVENTOR LOCATED INSIDE BUILDING
- 4. CLEAN OUTS ARE TO BE BUILT PER UNIFORM PLUMBING CODE STANDARDS AT LOCATIONS INDICATED AND AT MID RUN IF LONGER THAN 100'
- 5. ALL PLUMBING PIPE MATERIAL TO BE USED PER UPC.
- 6. FIRE LINE AND DOMESTIC WATERLINE MUST HAVE BACKFLOW PREVENTORS PER UPC. TO BE PROVIDED IN THE BUILDING
- 7. ALL EX. SD INLETS AND MH'S SHALL HAVE CONCRETE COLLARS POURED AND BE ADJUSTED TO FINISHED GRADE.
- 8. ALL EXCAVATION, TRENCHING AND SHORING ACTIVITIES MUST BE CARRIED-OUT IN ACCORDANCE WITH OSHA 29 CFR 1926.650 SUBPART P.
- 9. ALL UTILITY DISTANCES SHOWN ARE FOR REFERENCE ONLY.
- 10. PNM HAS NUMEROUS ELECTRIC FACILITIES AT THIS SITE CURRENTLY SERVING EXISTING CUSTOMERS. THE APPLICANT SHALL COORDINATE WITH PNM REGARDING THESE EXISTING FACILITIES. ANY RELOCATION, CHANGES OR REALIGNMENT OF EXISTING ELECTRIC UTILITIES WILL BE THE DEVELOPER EXPENSE. IN SOME CASES, RELOCATION OR CHANGES TO EXISTING FACILITIES MAY NOT BE FEASIBLE DUE TO PHYSICAL, USE OR SAFETY CLEARANCE CONSTRAINTS.
- 11. PNM WILL REVIEW ALL TECHNICAL NEEDS, ISSUES AND SAFETY CLEARANCES FOR ITS ELECTRIC POWER SYSTEMS. ANY EXISTING AND PROPOSED PUBLIC UTILITY EASEMENTS SHALL BE INDICATED ON THE SITE PLAN UTILITY SHEET PRIOR TO DRB REVIEW. PNM'S STANDARD FOR PUBLIC UTILITY EASEMENTS IS 10 FEET IN WIDTH TO ENSURE ADEQUATE, SAFE CLEARANCES.
- 12. SCREENING SHALL BE DESIGNED TO ALLOW FOR ACCESS TO UTILITY FACILITIES. IT IS NECESSARY TO PROVIDE ADEQUATE CLEARANCE OF TEN FEET SURROUNDING ALL GROUND-MOUNTED UTILITIES FOR SAFE OPERATION, MAINTENANCE AND REPAIR PURPOSES.

INSPECTION NOTE

CONTRACTOR SHALL CONSULT THE LOCAL BUILDING DEPARTMENT OFFICIALS FOR ANY PLAN REVIEW, PERMITTING REQUIREMENTS OR BUILDING CODE INSPECTIONS THAT MAY BE REQUIRED TO ENFORCE LOCAL, STATE OR NATIONAL BUILDING CODES PRIOR TO CONSTRUCTING IMPROVEMENTS

LEGEND

	BOUNDARY LINE
	BUILDING
	EXISTING CURB & GUTTER
\bowtie	EXISTING GATE VALVE
	EXISTING WATERLINE
U	EXISTING OVERHEAD POWER LINI
	EXISTING POWER POLE

EXISTING LIGHT POLE

10 GREASE TRAP

(12) 3" WM VAULT

(13) 6" FIRE LINE

(14) NOT USED

(11) 6" SAS SERVICE

KEYED NOTES	
1 FDC	15) 2" IRRIGATION SERVICE
2 BUILDING ADDRESS	16 TRANSFORMER PAD W/ BOLLARDS
3 EXISTING FIRE HYDRANT	17) EXIST SAS MH
PROPOSED FIRE HYDRANT (PUBLIC) 6" WL, 6" GATE VALVE	(18) NOT USED
5 EXIST 6" CI WL	19 CLEAN OUT
6 EXIST 8" SAS VCP	20 NEW 6" GATE VALVE (PUBLIC)
7 EXIST 6" STEEL WL	21) EXIST TRAFFIC CONTROL AND POWER CABINETS
8 EXIST 12" STL WL	(22) EXIST PULL BOX
9 EXIST OVERHEAD POWER LINE	23) PIV
_	_

24) NEW POWER POLE

(25) DRAIN IN DUMPSTER PAD


(26) CONNECT TO EXISTING WL


CAUTION

ALL EXISTING UTILITIES SHOWN WERE OBTAINED FROM RESEARCH, AS-BUILTS, SURVEYS OR INFORMATION PROVIDED BY OTHERS. IT SHALL BE THE SOLE RESPONSIBILITY OF THE CONTRACTOR TO CONDUCT ALL NECESSARY FIELD INVESTIGATIONS PRIOR TO AND INCLUDING ANY EXCAVATION, TO DETERMINE THE ACTUAL LOCATION OF UTILITIES AND OTHER IMPROVEMENTS, PRIOR TO STARTING THE WORK. ANY CHANGES FROM THIS PLAN SHALL BE COORDINATED WITH AND APPROVED BY THE ENGINEER.

ENGINEER'S SEAL	3
ON MEXICO Z	
((7868))	1
PROTEINS JONAL ENGIN	
Fn 18-11-25	

ENGINEER'S SEAL	3200 CENTRAL AVE SE ALBUQUERQUE, NM	<i>DRAWN BY</i> pm
DR. BOH	ALBOQULI IQUL, INIVI	DATE
OR. BOHANA PAR	HIGHWAY HOTEL	8-18-25
	MASTER UTILITY PLAN	DRAWING
PROTESSIONAL ENGIN		SHEET #
8-11-25	5571 MIDWAY PARK PL NE ALBUQUERQUE, NEW MEXICO 87109	MU-1
RONALD R. BOHANNAN P.E. #7868	(505) 858-3100 www.tierrawestllc.com	<i>JOB #</i> 2024042

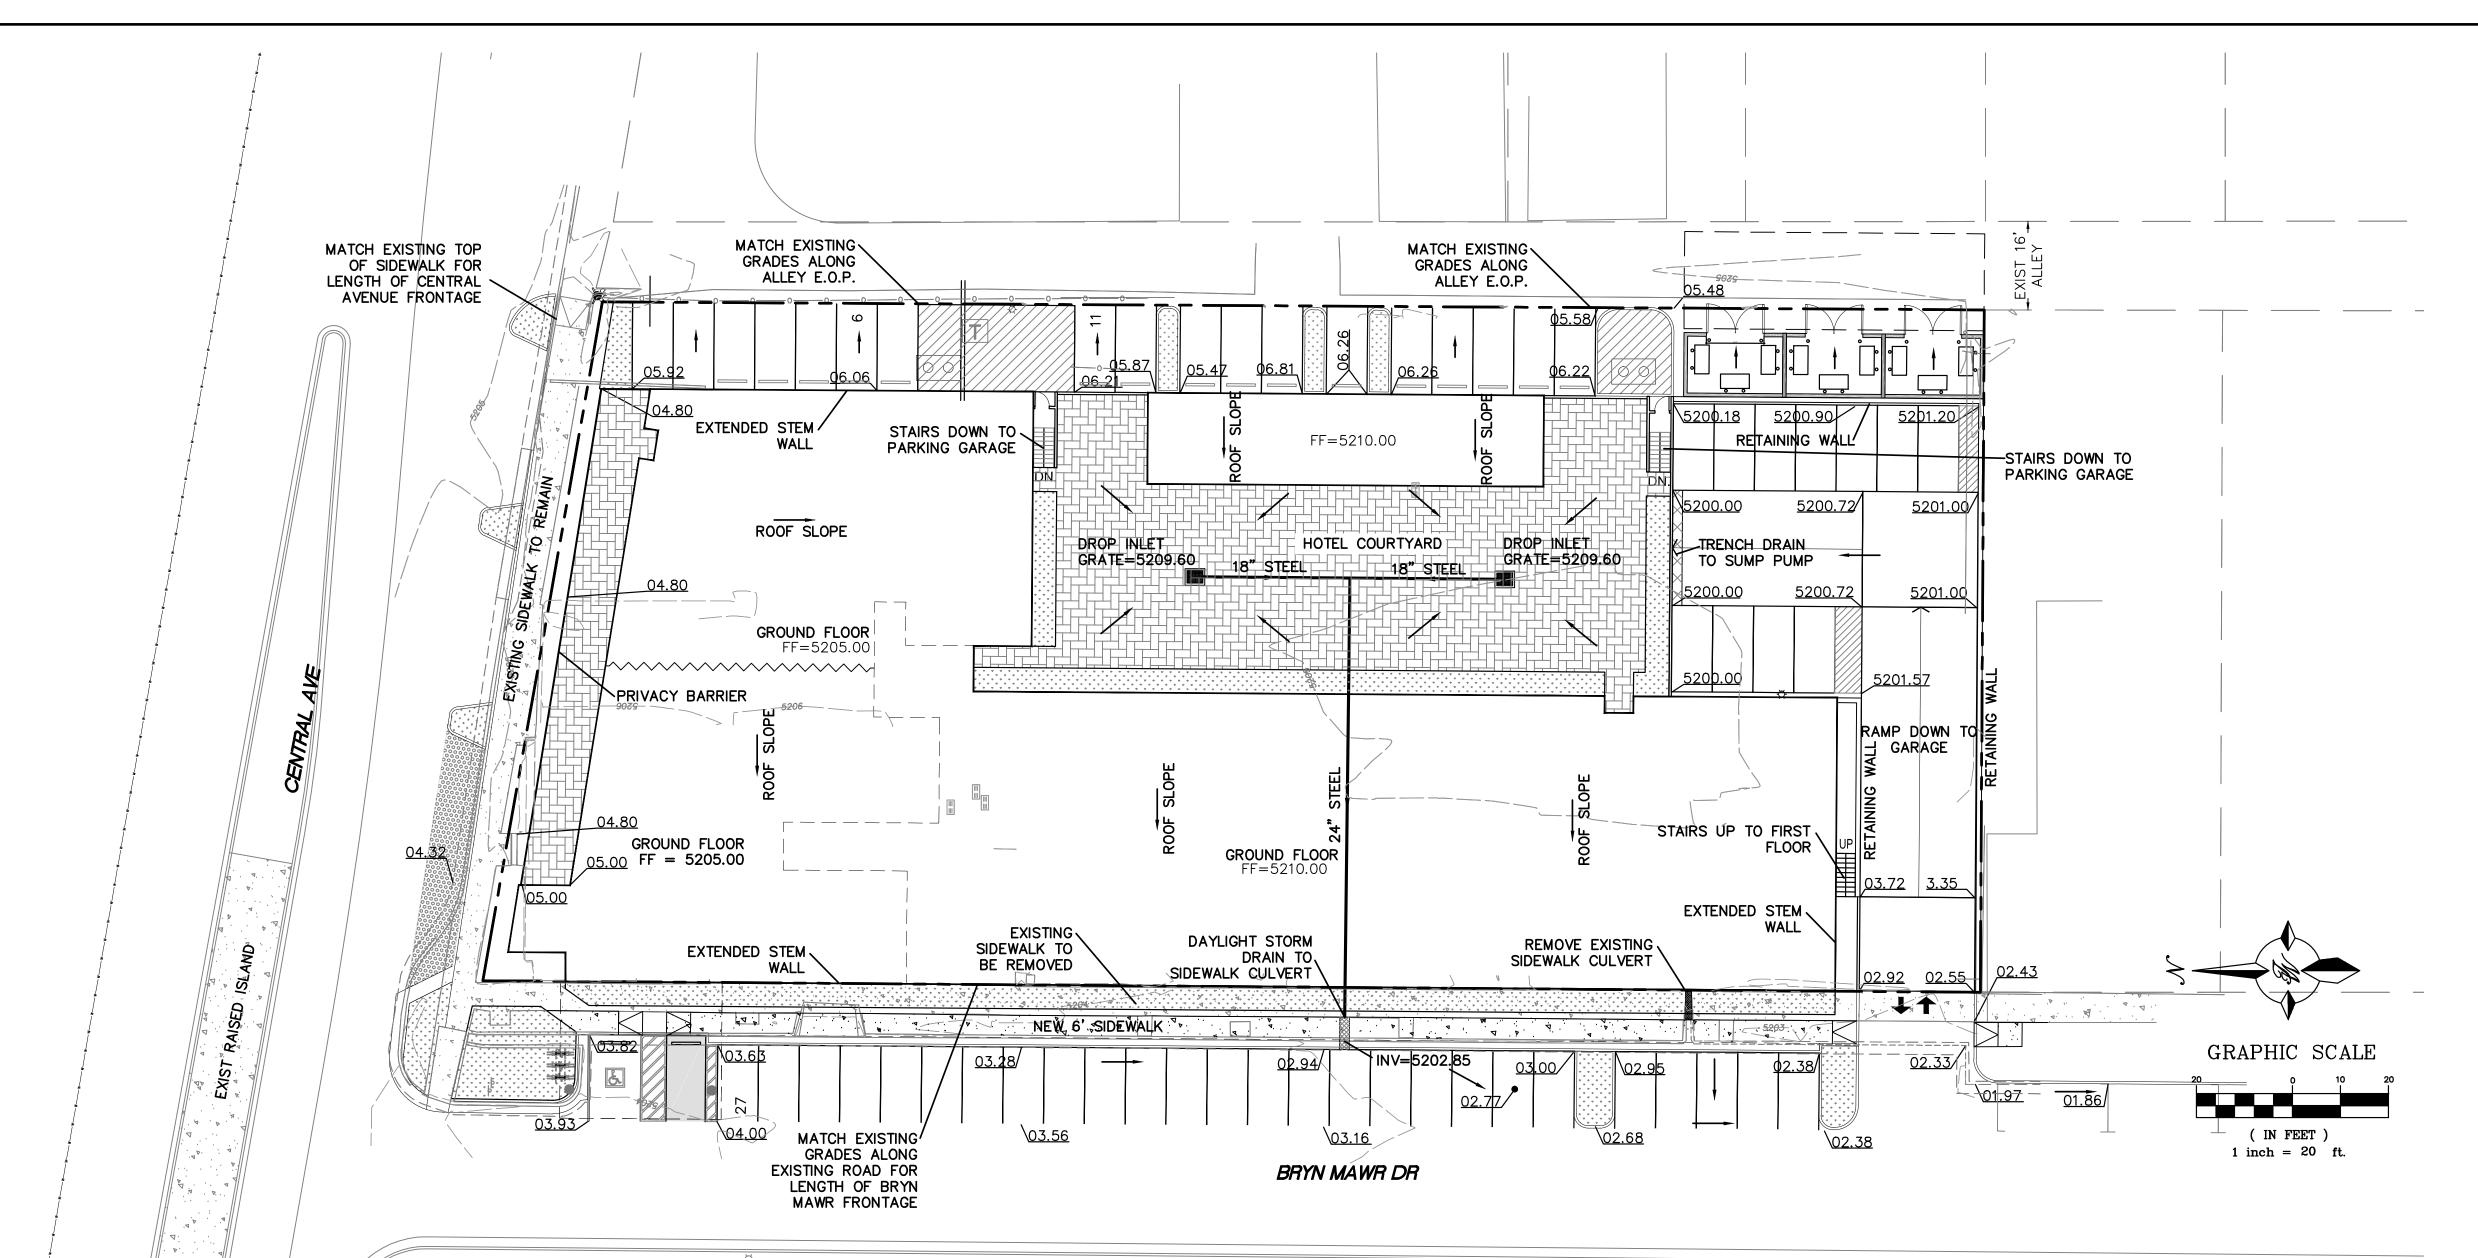

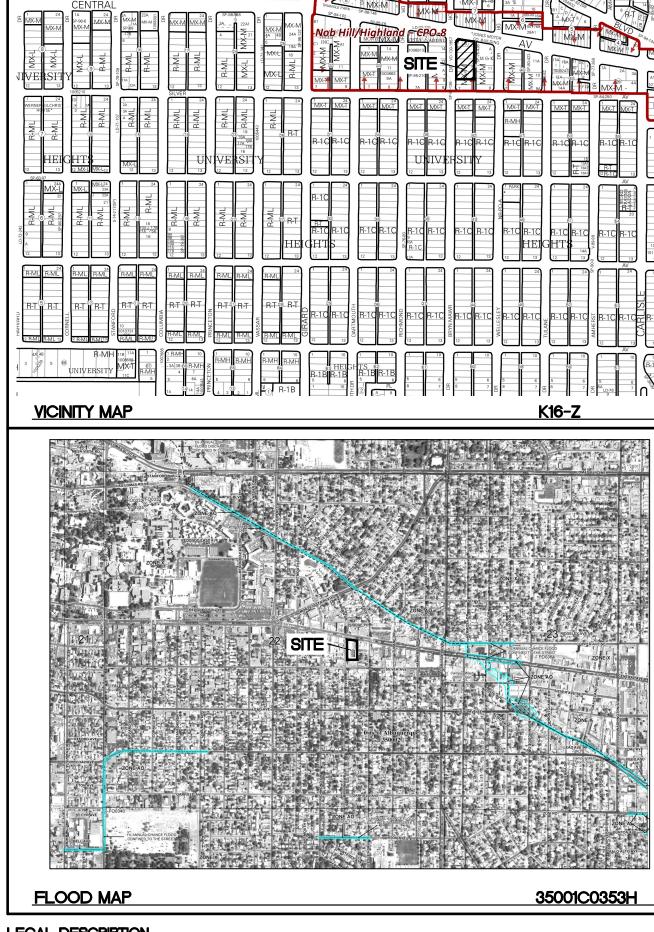

LEGAL DESCRIPTION

LOTS 1-5, BLOCK 41, UNIVERSITY HEIGHTS ADDITION AND LOT 1, BLOCK 3, MONTE VISTA ADDITION

LEGEND

CURB & GUTTER ——— — BOUNDARY LINE — — — EASEMENT - CENTERLINE ---- RIGHT-OF-WAY BUILDING SIDEWALK — — — EXISTING CURB & GUTTER ---- EXISTING BOUNDARY LINE

->>>> GRADE BREAK PROPOSED STORM SEWER

LANDSCAPING

HOTEL COURTYARD

DROP INLET

NOTICE TO CONTRACTORS

- 1. AN EXCAVATION/CONSTRUCTION PERMIT WILL BE REQUIRED BEFORE BEGINNING ANY WORK WITHIN CITY RIGHT-OF-WAY.
- 2. ALL WORK DETAILED ON THESE PLANS TO BE PERFORMED, EXCEPT AS OTHERWISE STATED OR PROVIDED HERON, SHALL BE CONSTRUCTED IN ACCORDANCE WITH CITY OF ALBUQUERQUE INTERIM STANDARD SPECIFICATIONS FOR PUBLIC WORKS CONSTRUCTION, 1985.
- 3. TWO WORKING DAYS PRIOR TO ANY EXCAVATION, CONTRACTOR MUST CONTACT LINE LOCATING SERVICE, 765-1234, FOR LOCATION OF EXISTING UTILITIES.
- 4. PRIOR TO CONSTRUCTION, THE CONTRACTOR SHALL EXCAVATE AND VERIFY THE HORIZONTAL AND VERTICAL LOCATIONS OF ALL CONNECTIONS. SHOULD A CONFLICT EXIST, THE CONTRACTOR SHALL NOTIFY THE ENGINEER SO THAT THE CONFLICT CAN BE RESOLVED WITH A MINIMUM AMOUNT OF DELAY.
- 5. BACKFILL COMPACTION SHALL BE ACCORDING TO TRAFFIC/STREET USE.
- 6. MAINTENANCE OF THESE FACILITIES SHALL BE THE RESPONSIBILITY OF THE OWNER OF THE PROPERTY SERVED.
- 7. WORK ON ARTERIAL STREETS SHALL BE PERFORMED ON A 24-HOUR BASIS.

EROSION CONTROL NOTES:

- 1. CONTRACTOR IS RESPONSIBLE FOR OBTAINING A TOPSOIL DISTURBANCE PERMIT PRIOR TO BEGINNING WORK.
- 2. CONTRACTOR IS RESPONSIBLE FOR MAINTAINING RUN-OFF ON SITE DURING CONSTRUCTION.
- 3. CONTRACTOR IS RESPONSIBLE FOR CLEANING ALL SEDIMENT THAT GETS INTO EXISTING RIGHT-OF-WAY.
- 4. REPAIR OF DAMAGED FACILITIES AND CLEANUP OF SEDIMENT ACCUMULATIONS ON ADJACENT PROPERTIES AND IN PUBLIC FACILITIES IS THE RESPONSIBILITY OF THE CONTRACTOR.
- 5. ALL EXPOSED EARTH SURFACES MUST BE PROTECTED FROM WIND AND WATER EROSION PRIOR TO FINAL (CITY) ACCEPTANCE OF ANY PROJECT.
- 6. ALL SLOPES NOT STABILIZED AT THE END OF THE PROJECT SHALL BE STABILIZED IN ACCORDANCE WITH COA SPECS OR 3" GRAVEL

DRAINAGE MANAGEMENT PLAN

HIWAY HOTEL IS A REDEVELOPMENT OF AN EXISTING HOTEL. THE EXISTING STRUCTURES WILL BE DEMOLISHED AND A NEW HOTEL AND RESTAURANT WILL BE CONSTRUCTED IN ITS PLACE. THE NEW STRUCTURE WILL BE THREE STORIES PLUS AN UNDERGROUND PARKING GARAGE. PER THE PREVIOUS APPROVED GRADING AND DRAINAGE PLAN PREPARED BY LEE ENGINEERING (ENGINEER'S STAMP DATE 11/5/96) THE SITE FREE DISCHARGES TO THE ADJACENT EXISTING BRYN MAWR DR TO THE WEST AND TO THE ADJACENT EXISTING ALLEY WAY TO THE EAST. THE PEAK DISCHARGE FROM THE SITE NOTED ON THE PREVIOUSLY APPROVED PLAN IS 4.68 CFS FOR A 100-YEAR, 6-HOUR DESIGN STORM.

THE PROPOSED REDEVELOPED SITE WILL CONTINUE TO DRAIN TO BRYN MAWR DR AND TO THE EXISTING ALLEY WAY. THE PROPOSED IMPERVIOUS AND LANDSCAPED AREAS WILL BE ESSENTIALLY EQUAL TO EXISTING VALUES AND RUNOFF FROM THE SITE WILL BE MAINTAINED AT HISTORIC VALUES. NO DRAINAGE PONDING IS PROPOSED FOR THE REDEVELOPED SITE, MIMICKING THE PREVIOUSLY APPROVED GRADING AND DRAINAGE PLAN.



CAUTION

ALL EXISTING UTILITIES SHOWN WERE OBTAINED FROM RESEARCH, AS-BUILTS, SURVEYS OR INFORMATION PROVIDED BY OTHERS. IT SHALL BE THE SOLE RESPONSIBILITY OF THE CONTRACTOR TO CONDUCT ALL NECESSARY FIELD INVESTIGATIONS PRIOR TO AND INCLUDING ANY EXCAVATION, TO DETERMINE THE ACTUAL LOCATION OF UTILITIES AND OTHER IMPROVEMENTS, PRIOR TO STARTING THE WORK. ANY CHANGES FROM THIS PLAN SHALL BE COORDINATED WITH AND APPROVED BY THE ENGINEER.

ENGINEER'S SEAL	3200 CENTRAL AVE S
DR. BOHA	ALDOGOLI IGOL, INIVI
DR. BOHANA ON MEXICO 7868	CONCEPTUAL GRAD PLAN
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RONALD R. BOHANNAN P.E. #7868	(505) 858-3100 www.tierrawestllc.com

DRAWN BY

1-8-25


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SHEET #

JOB # 2024042

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87109



GENERAL NOTES

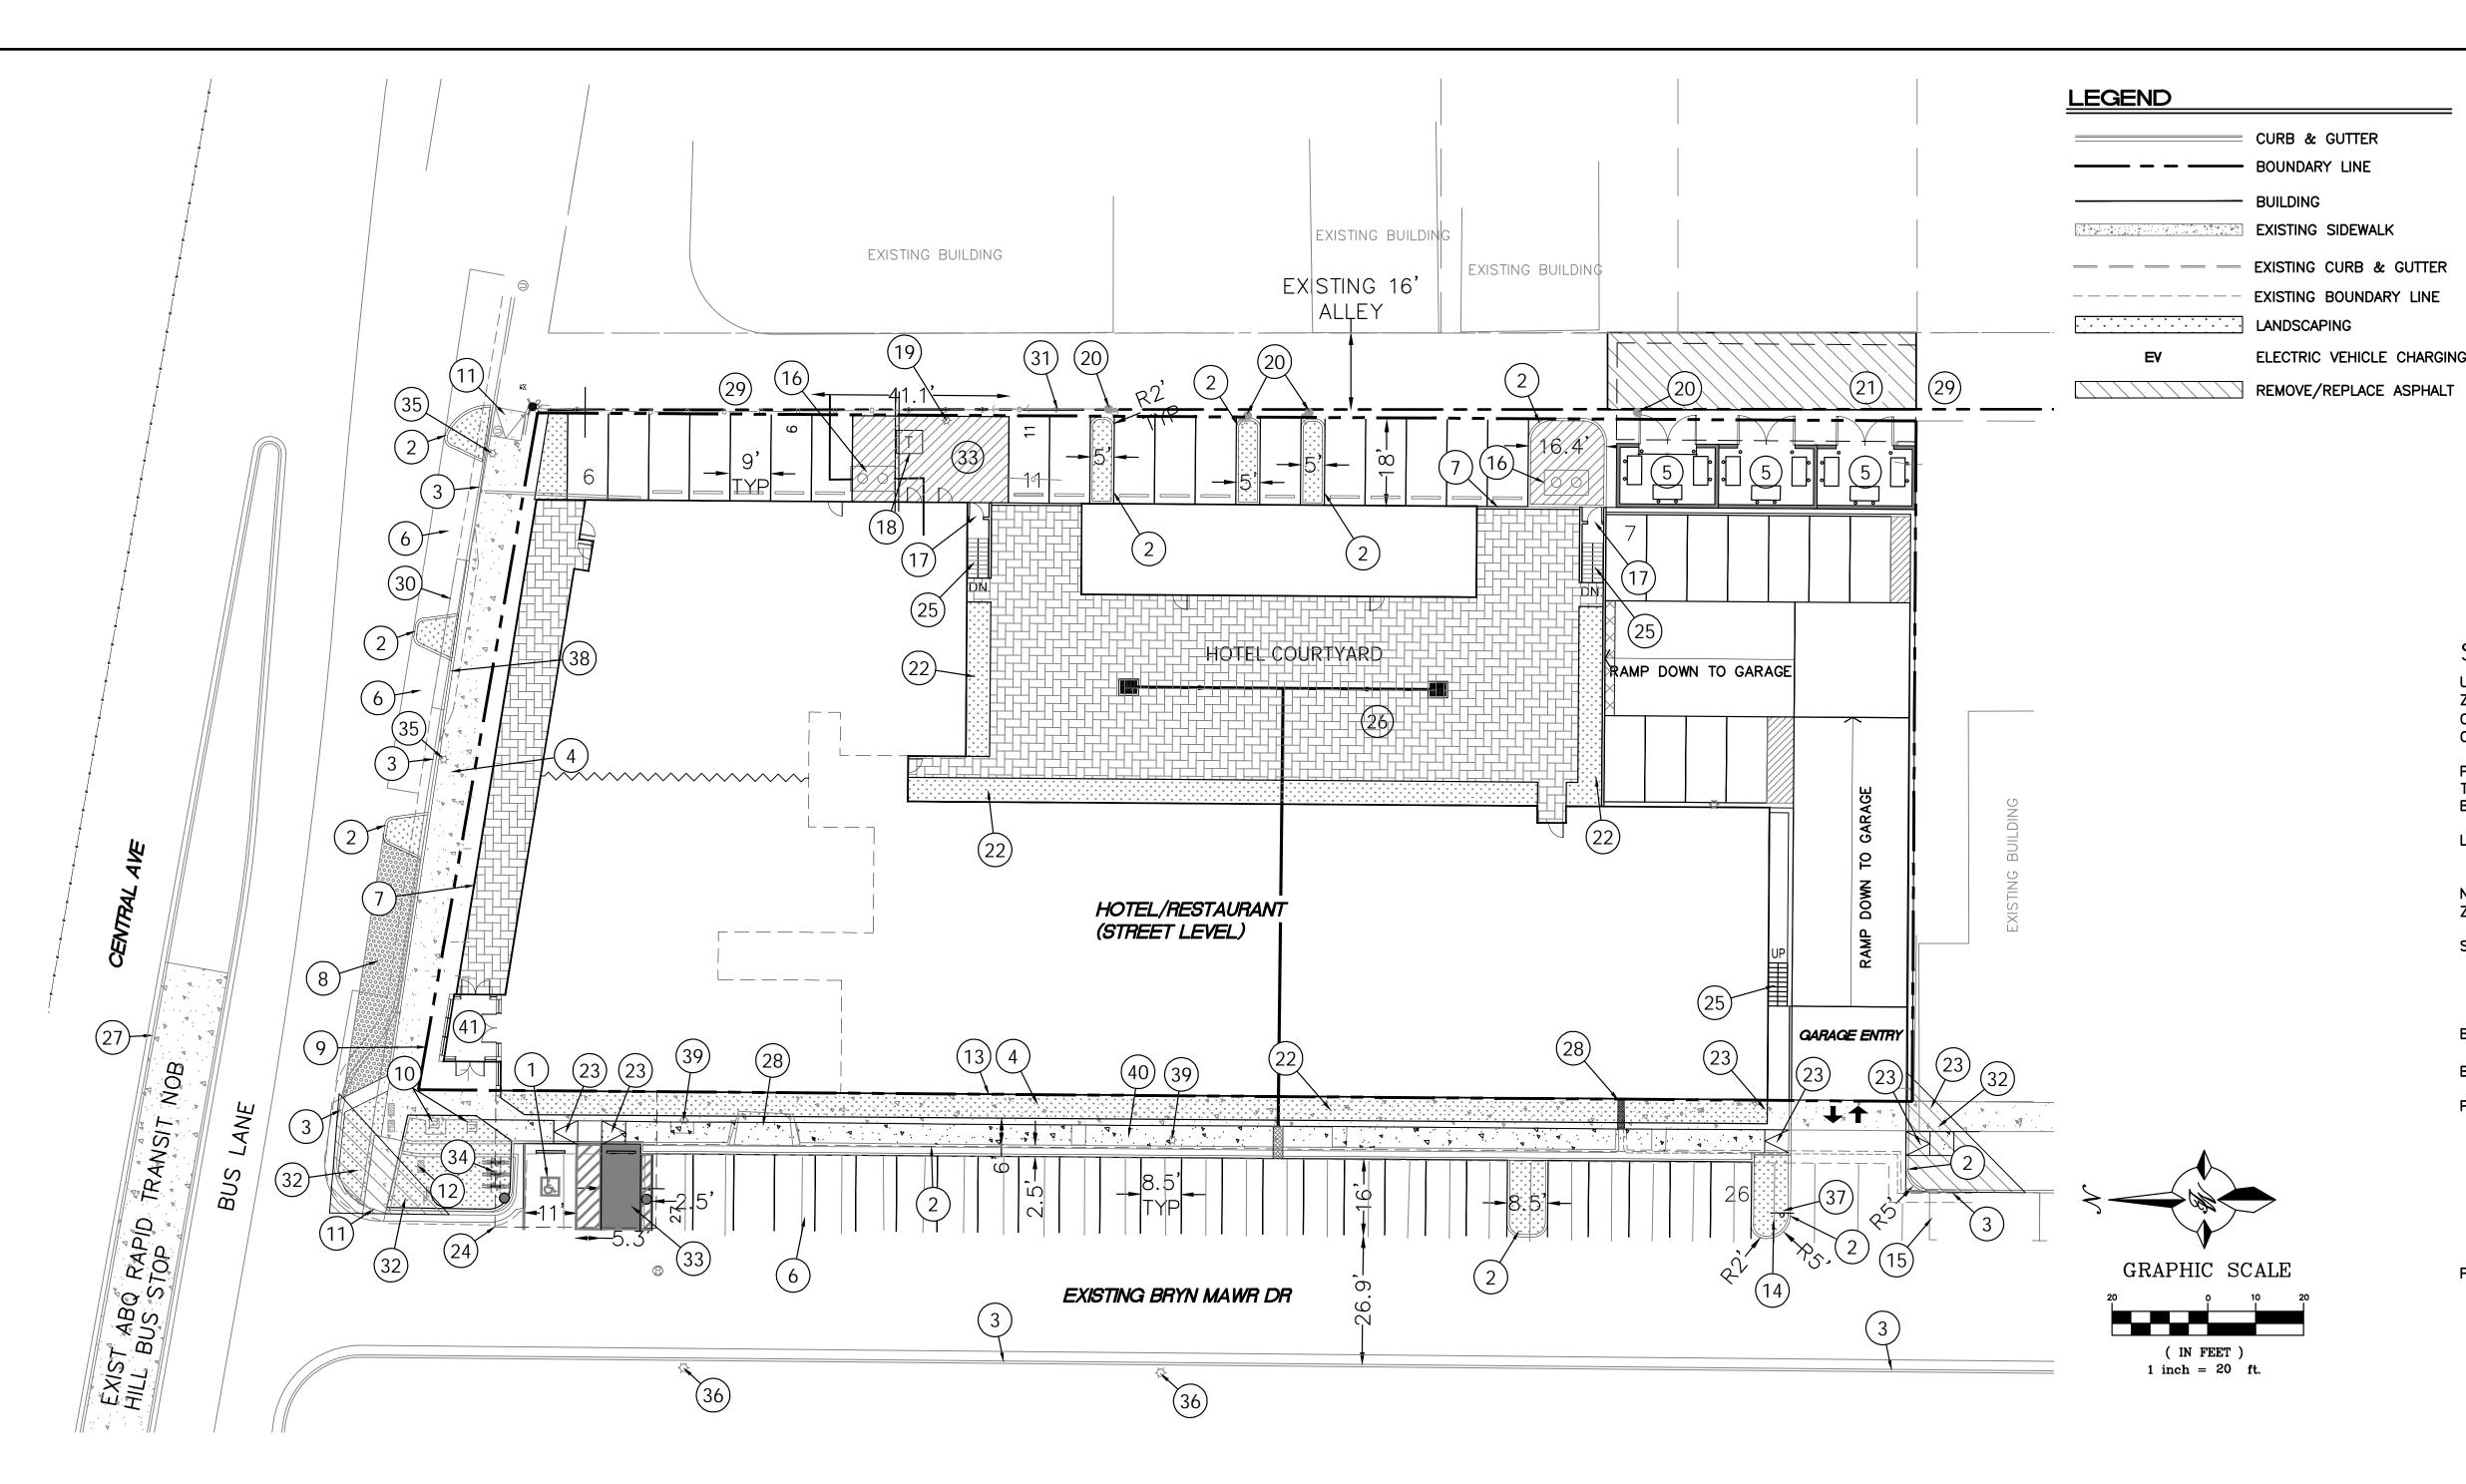- 1. ALL EXISTING SIDEWALKS, CURBS, DRIVE PADS, WALL AND ANYTHING THAT INFLUENCES THE PARKING AND CIRCULATION ARE IDENTIFIED ON THE SITE PLAN.
- 2. LANDSCAPING, FENCING, AND SIGNAGE WILL NOT INTERFERE WITH CLEAR SIGHT REQUIREMENTS. THEREFORE, SIGNS, WALLS, TREES, AND SHRUBBERY BETWEEN 3 AND 8 FEET TALL (AS MEASURED FROM THE GUTTER PAN) WILL NOT BE ACCEPTABLE IN THE CLEAR SIGHT
- 3. ALL UNUSED CURB CUTS SHALL BE REPLACED WITH NEW CURB & GUTTER AND
- 4. ALL BROKEN OR CRACKED SIDEWALK TO BE REPLACED WITH SIDEWALK, CURBS AND
- 5. A 6FT. WIDE ADA ACCESSIBLE PEDESTRIAN PATHWAY WILL BE PROVIDED FROM THE PUBLIC
- SIDEWALK TO THE BUILDING ENTRANCES.
- 6. SIGNAGE SHALL BE PERMITTED SEPARATELY AND SHALL COMPLY WITH IDO MX-M REQUIREMENTS.
- 7. EQUIPMENT SCREENING WILL COMPLY WITH SCREENING REQUIREMENTS IN SECTION 14-16-5-6 OF THE CITY OF ALBUQUERQUE ZONING CODE.

EXECUTIVE SUMMARY

THE SITE IS LOCATED IN KNOB HILL OFF CENTRAL AVE. IT IS BORDERD BY BRYN MAWR STREET TO THE WEST AND BY AN EXISTING 16' ALLEYWAY TO THE EAST. THE EXISTING HOTEL STRUCTURE IS BEING REPLACED WITH A NEW HOTEL AND RESTAURANT ON THE 1.08 ACRES PROPERTY. AN UNDERGROUND PARKING STRUCTURE WILL BE CONSTRUCTED AS PART OF THE DEVELOPMENT. ACCESS TO THE GARAGE WILL BE OFF BRYN MAWR DR AT THE SOUTHWEST CORNER OF THE SITE FOR USE BY THE DEVELOMENT. THE MAJORITY OF THE EXISTING ONSTREET PARKING IN BRYN MAWR DR WILL REMAIN FOR USE BY THE PUBLIC AND NEW PARKING WILL BE ADDED ADJACENT TO THE EXISTING ALLEY WAY FOR USE BY THE DEVELOPMENT. A DROP OF AREA WILL BE PROVIDED ON CENTRAL FOR ACCESS TO THE HOTEL LOBBY ALONG WITH PUBLIC PARKING ALONG CENTRAL IN FRONT OF THE DEVELOPMENT.

KEYED NOTES

WITH SIGN


- 1) ACCESSIBLE SPACE PER ADA REQUIREMENTS
- (2) 6" CURB AND GUTTER (TYP) PER COA STD DWG 2415A
- (3) EXISTING CURB AND GUTTER TO REMAIN
- (4) EXISTING SIDEWALK TO BE REMOVED
- (5) TRASH ENCLOSURE
- (6) PUBLIC PARKING
- (7) PRIVACY BARRIER ALONG PROPERTY LINE
- (8) HOTEL DROP-OFF
- 9 BUILDING ABOVE
- (10) CONTROL BOX
- (11) EXISTING HC RAMP TO REMAIN
- (12) EXISTING PULL BOX
- (13) ZERO SETBACK
- (14) DIRECTIONAL SIGN

KEYED NOTES

- (15) EXISTING PARALLEL PARKING TO REMAIN
- (16) GREASE TRAP
- (17) PRIVACY GATE KEY CARD ACCESS ONLY
- (18) TRANSFORMER
- (19) NEW POWER POLE
- (20) EXISTING POWER POLE
- (21) ALLEYWAY ASPHALT TO BE REPAVED DIRECTLY IN FRONT OF TRASH ENCLOSURES
- (22) LANDSCAPE BARRIER
- (23) UNIDIRECTIONAL HC RAMP
- 24) CANOPY
- 25) STAIRWAY
- (26) HOTEL COURTYARD
- (27) EXISTING RAISED MEDIAN AND BUS PLATFORM

KEYED NOTES

- (28) REMOVE EXISTING SIDEWALK CULVERT/CONCRETE PAD
- (29) EXISTING ASHPALT PAVING TO REMAIN
- (30) REMOVE EXISTING DRIVE PAD
- (31) RELOCATE EXISTING GUY WIRES
- (32) 25' X 25' SIGHT VISIBILITY TRIANGLE
- (33) HOTEL LOADING ZONE
- (34) BIKE RACK (3 SPACES)
- (35) EXIST CABQ LIGHTS TO REMAIN
- (36) EXIST STREET LIGHT TO REMAIN
- (37) STOP SIGN
- (38) 32 LF NEW CURB AND GUTTER
- (39) EXIST LIGHT TO BE REMOVED
- (40) NEW CONCRETE SIDEWALK
- (41) VESTIBULE

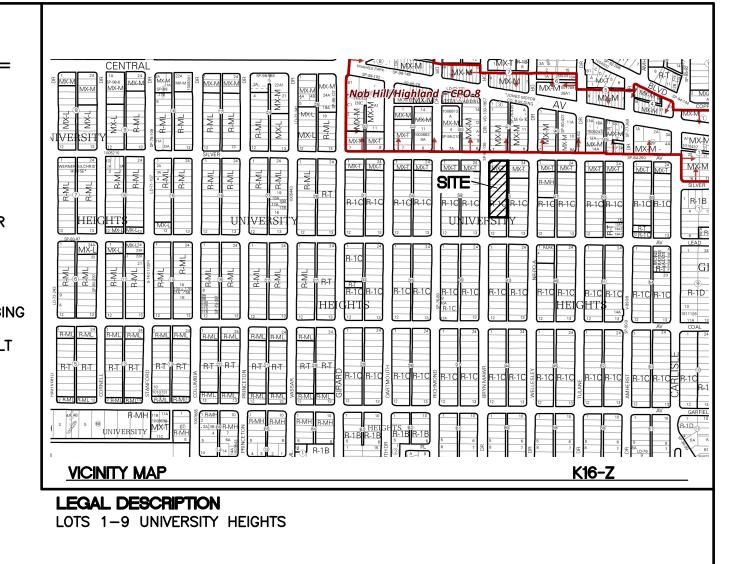

SITE DATA

USE: MIXED USE - HOTEL (112 ROOMS), BAR, AND RESTAURANT

ZONING: OVERLAY: NOB HILL/HIGHLAND CPO-8

CENTERS AND CORRIDORS: MAIN STREET AND MAJOR TRANSIT - CENTRAL

PREMIUM TRANSIT STATION: NOB HILL ART STATION ROUTES 66, 16, 766, AND 777

BICYCLE FACILITIES: SILVER AVENUE BICYCLE BOULEVARD LOTS 1 - 5, BLOCK 41 UNIVERSITY HEIGHTS ADDITION AND LEGAL DESCRIPTION:

BLOCK 3 MONTE VISTA ADDITION

42,571 SF (1.08 ACRES) NET SITE AREA:

ZONE ATLAS PAGE:

FRONT: O FEET MINIMUM, 15 FOOT MAXIMUM SETBACKS: SIDE: O FEET MINIMUM, 15 FOOT MAXIMUM

STREET SIDE: 0 FEET MINIMUM, 15 FOOT MAXIMUM REAR: 0 FEET

ALLOWED (WITH STRUCTURED PARKING BONUS): 42 FEET

PROVIDED (WITH STRUCTURED PARKING): 40 FEET BUILDING FOOTPRINT: 25,784 SF

PARKING:

P.E. #7868

REQUIRED (UC-MS-PT): HOTEL = 2 SPACES/3 ROOMS = 74 SPACES

BAR = 5/1,000 SF = 9 SPACESRESTAURANT = 3.5/1.000 SF = 15 SPACES

TOTAL REQUIRED: 98 SPACES LESS TRANSIT REDUCTION* @ 40% -39 SPACES

TOTAL (AFTER REDUCTIONS) 59 SPACES

*5-5(C)(5)(D) 1 AND 2

PROVIDED: PARKING STRUCTURE: 73 SPACES **ALLEY SPACES:** 18 SPACES TOTAL 91 SPACES

MOTORCYCLE SPACES REQUIRED 3 SPACES


MOTORCYCLE SPACES PROVIDED 4 SPACES IN GARAGE

3 SPACES BICYCLE SPACES REQUIRED

BICYCLE SPACES PROVIDED 3 SPACES

ENGINEER'S 3200 CENTRAL AVE SE DRAWN BY SEAL pm ALBUQUERQUE, NM DATE 1-13-25 TRAFFIC CIRCULATION MEX DRAWING **PLAN** (7868) SHEET # TOS/ONAL EN TIERRA WEST, LLC 5571 MIDWAY PARK PL NE ALBUQUERQUE, NEW MEXICO 87109 1-13-25 (505) 858-3100 JOB # RONALD R. BOHANNAN www.tierrawestllc.com

2024042

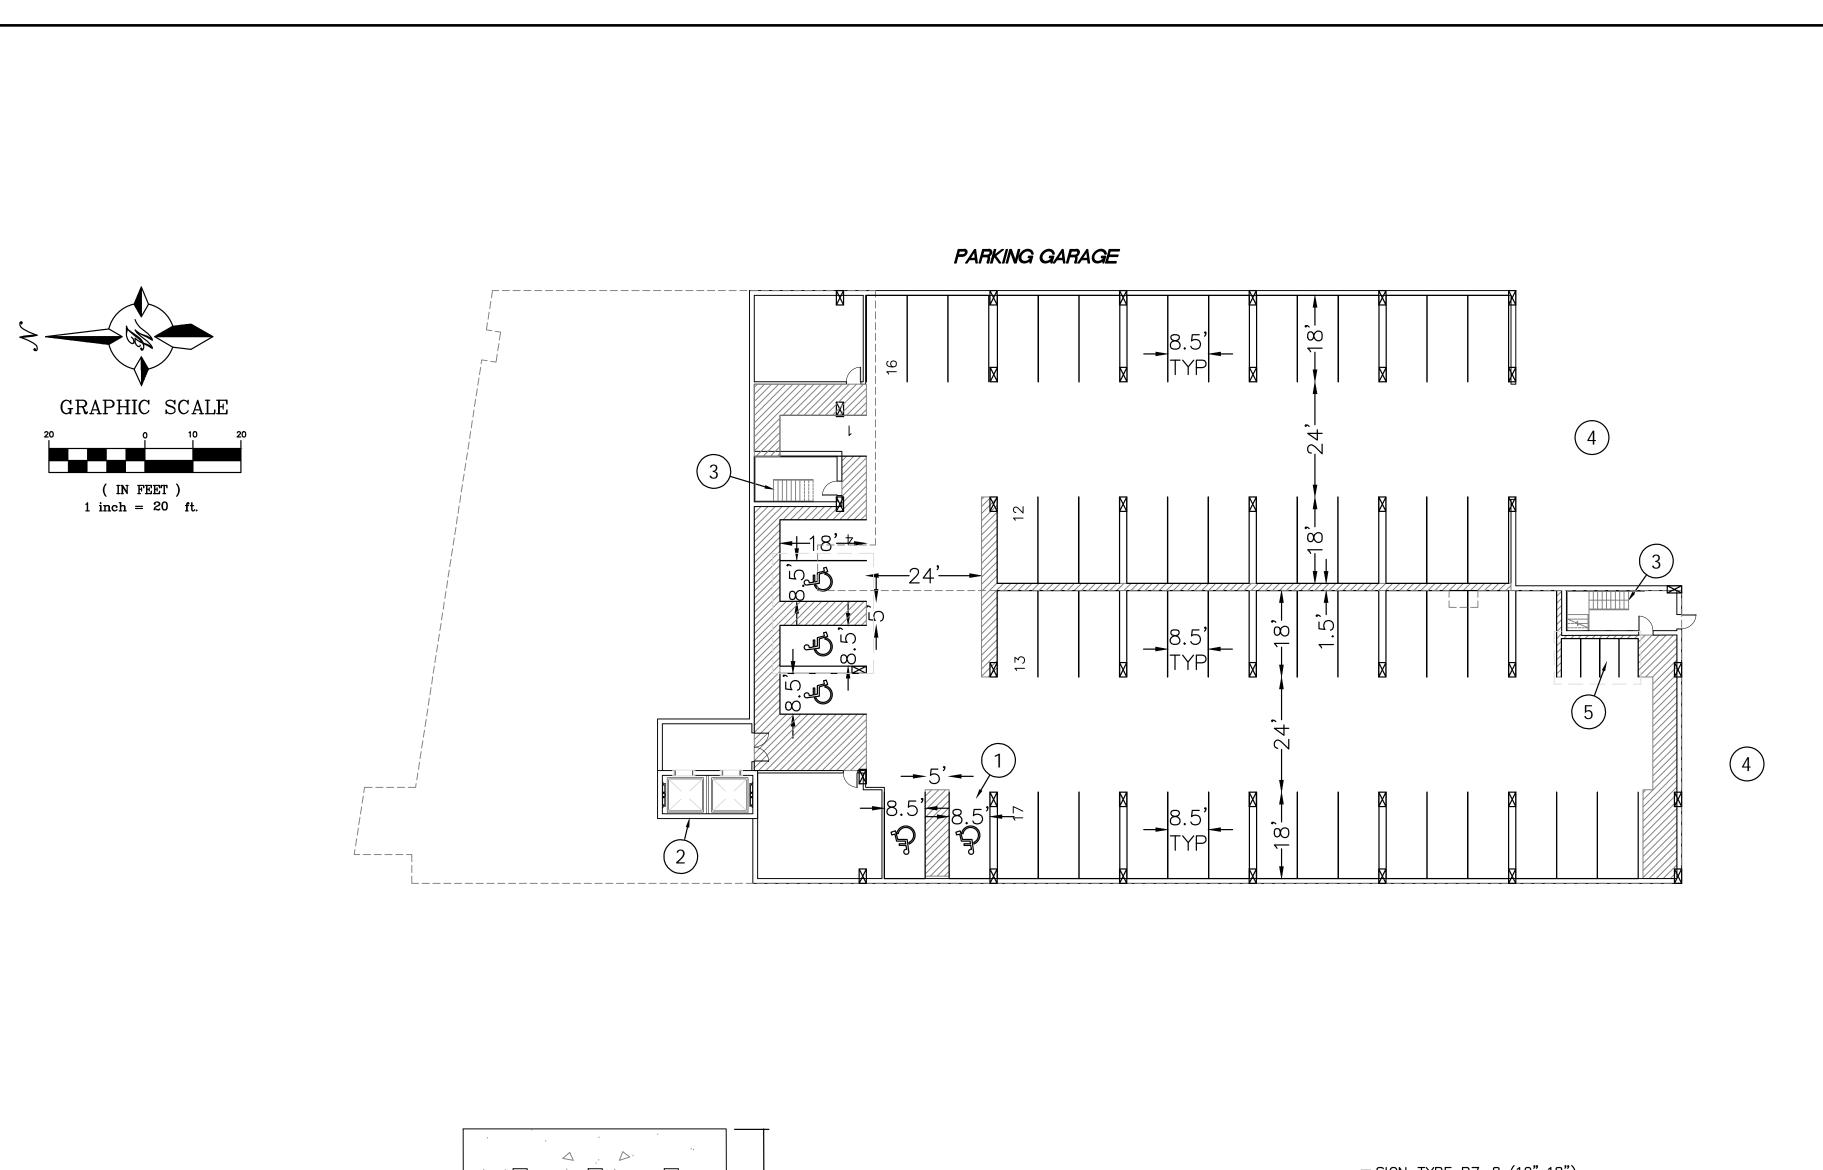

2.0 2.0

PLAN VIEW

Ø 2 3/8" STEEL TUBING——

CHECK DESIRED MOUNT

BIKE RACK DETAIL

SCALE: NONE

GRADE

MADRAX DIVISION

GRABER MANUFACTURING, INC.

CONCRETE

□ SURFACE FLANGE MOUNT (SF)

NUTES;
INSTALL BIKE RACKS ACCORDING TO MANUFACTURER'S SPECIFICATIONS.
CONSULTANT TO SELECT COLOR (FINISH), SEE MANUFACTURER'S SPECIFICATIONS.
SEE SITE PLAN FOR LOCATION OR CONSULT OWNER.
BIKE RACK SHALL HAVE A 1-FOOT CLEAR ZONE ALL AROUND.
SEACH BIKE RACK SPACE SHALL BE AT LEAST 6 FEET LONG AND 2 FEET WIDE.

HANDER MAINT ACTIONNY, INC.

1080 UNIEK DRIVE
WAUNAKEE, WI 53597
P(800) 448-7931, P(608) 849-1080, F(608) 849-1081
WWW.MADRAX.CDM, E-MAIL: SALES@MADRAX.CDM

21 7/8

☐ IN GROUND MOUNT (IG)

2 BIKE, SURFACE OR IN GROUND MOUNT

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----- BUILDING


STRIPED AREA


VICINITY MAP

LEGAL DESCRIPTION LOTS 1-9 UNIVERSITY HEIGHTS

KEYED NOTES

- 1 ACCESSIBLE SPACE PER ADA REQUIREMENTS WITH SIGN (TYP.)
- 2 ELEVATOR
- 3 STAIRS
- 4 SEE TCL-1 FOR ADJACENT PARKING/GARAGE ACCESS RAMPS
 5 4'X8' MOTORCYCLE SPACES

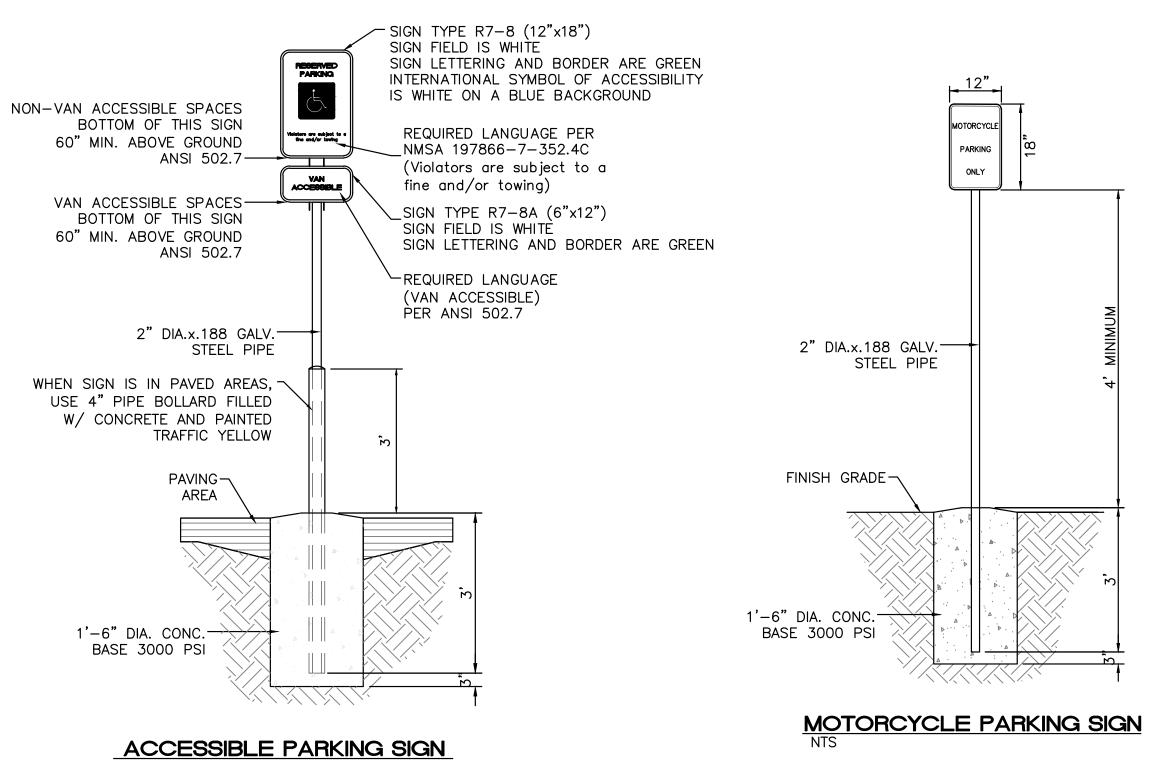


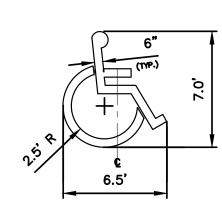

ACCESSIBLE PARKING SYMBOL

ENGINEER'S SEAL	3
DR. BOHANNAN MEXICO 7868 PROPESSIONAL ENGINEERS	
RONALD R. BOHANNAN P.E. #7868	

? <i>'S</i>	3200 CENTRAL AVE SE ALBUQUERQUE, NM	<i>DRAWN BY</i> pm
420	ALBOQUERQUE, INIVI	DATE
TA WAN	TRAFFIC CIRCULATION	1-13-25
))	PLAN	DRAWING
A JANA		SHEET #
	TIERRA WEST, LLC 5571 MIDWAY PARK PL NE	TCL-2
-13-25	ALBUQUERQUE, NEW MEXICO 87109	
OHANNAN	(505) 858-3100 www.tierrawestllc.com	<i>JOB #</i> 2024042

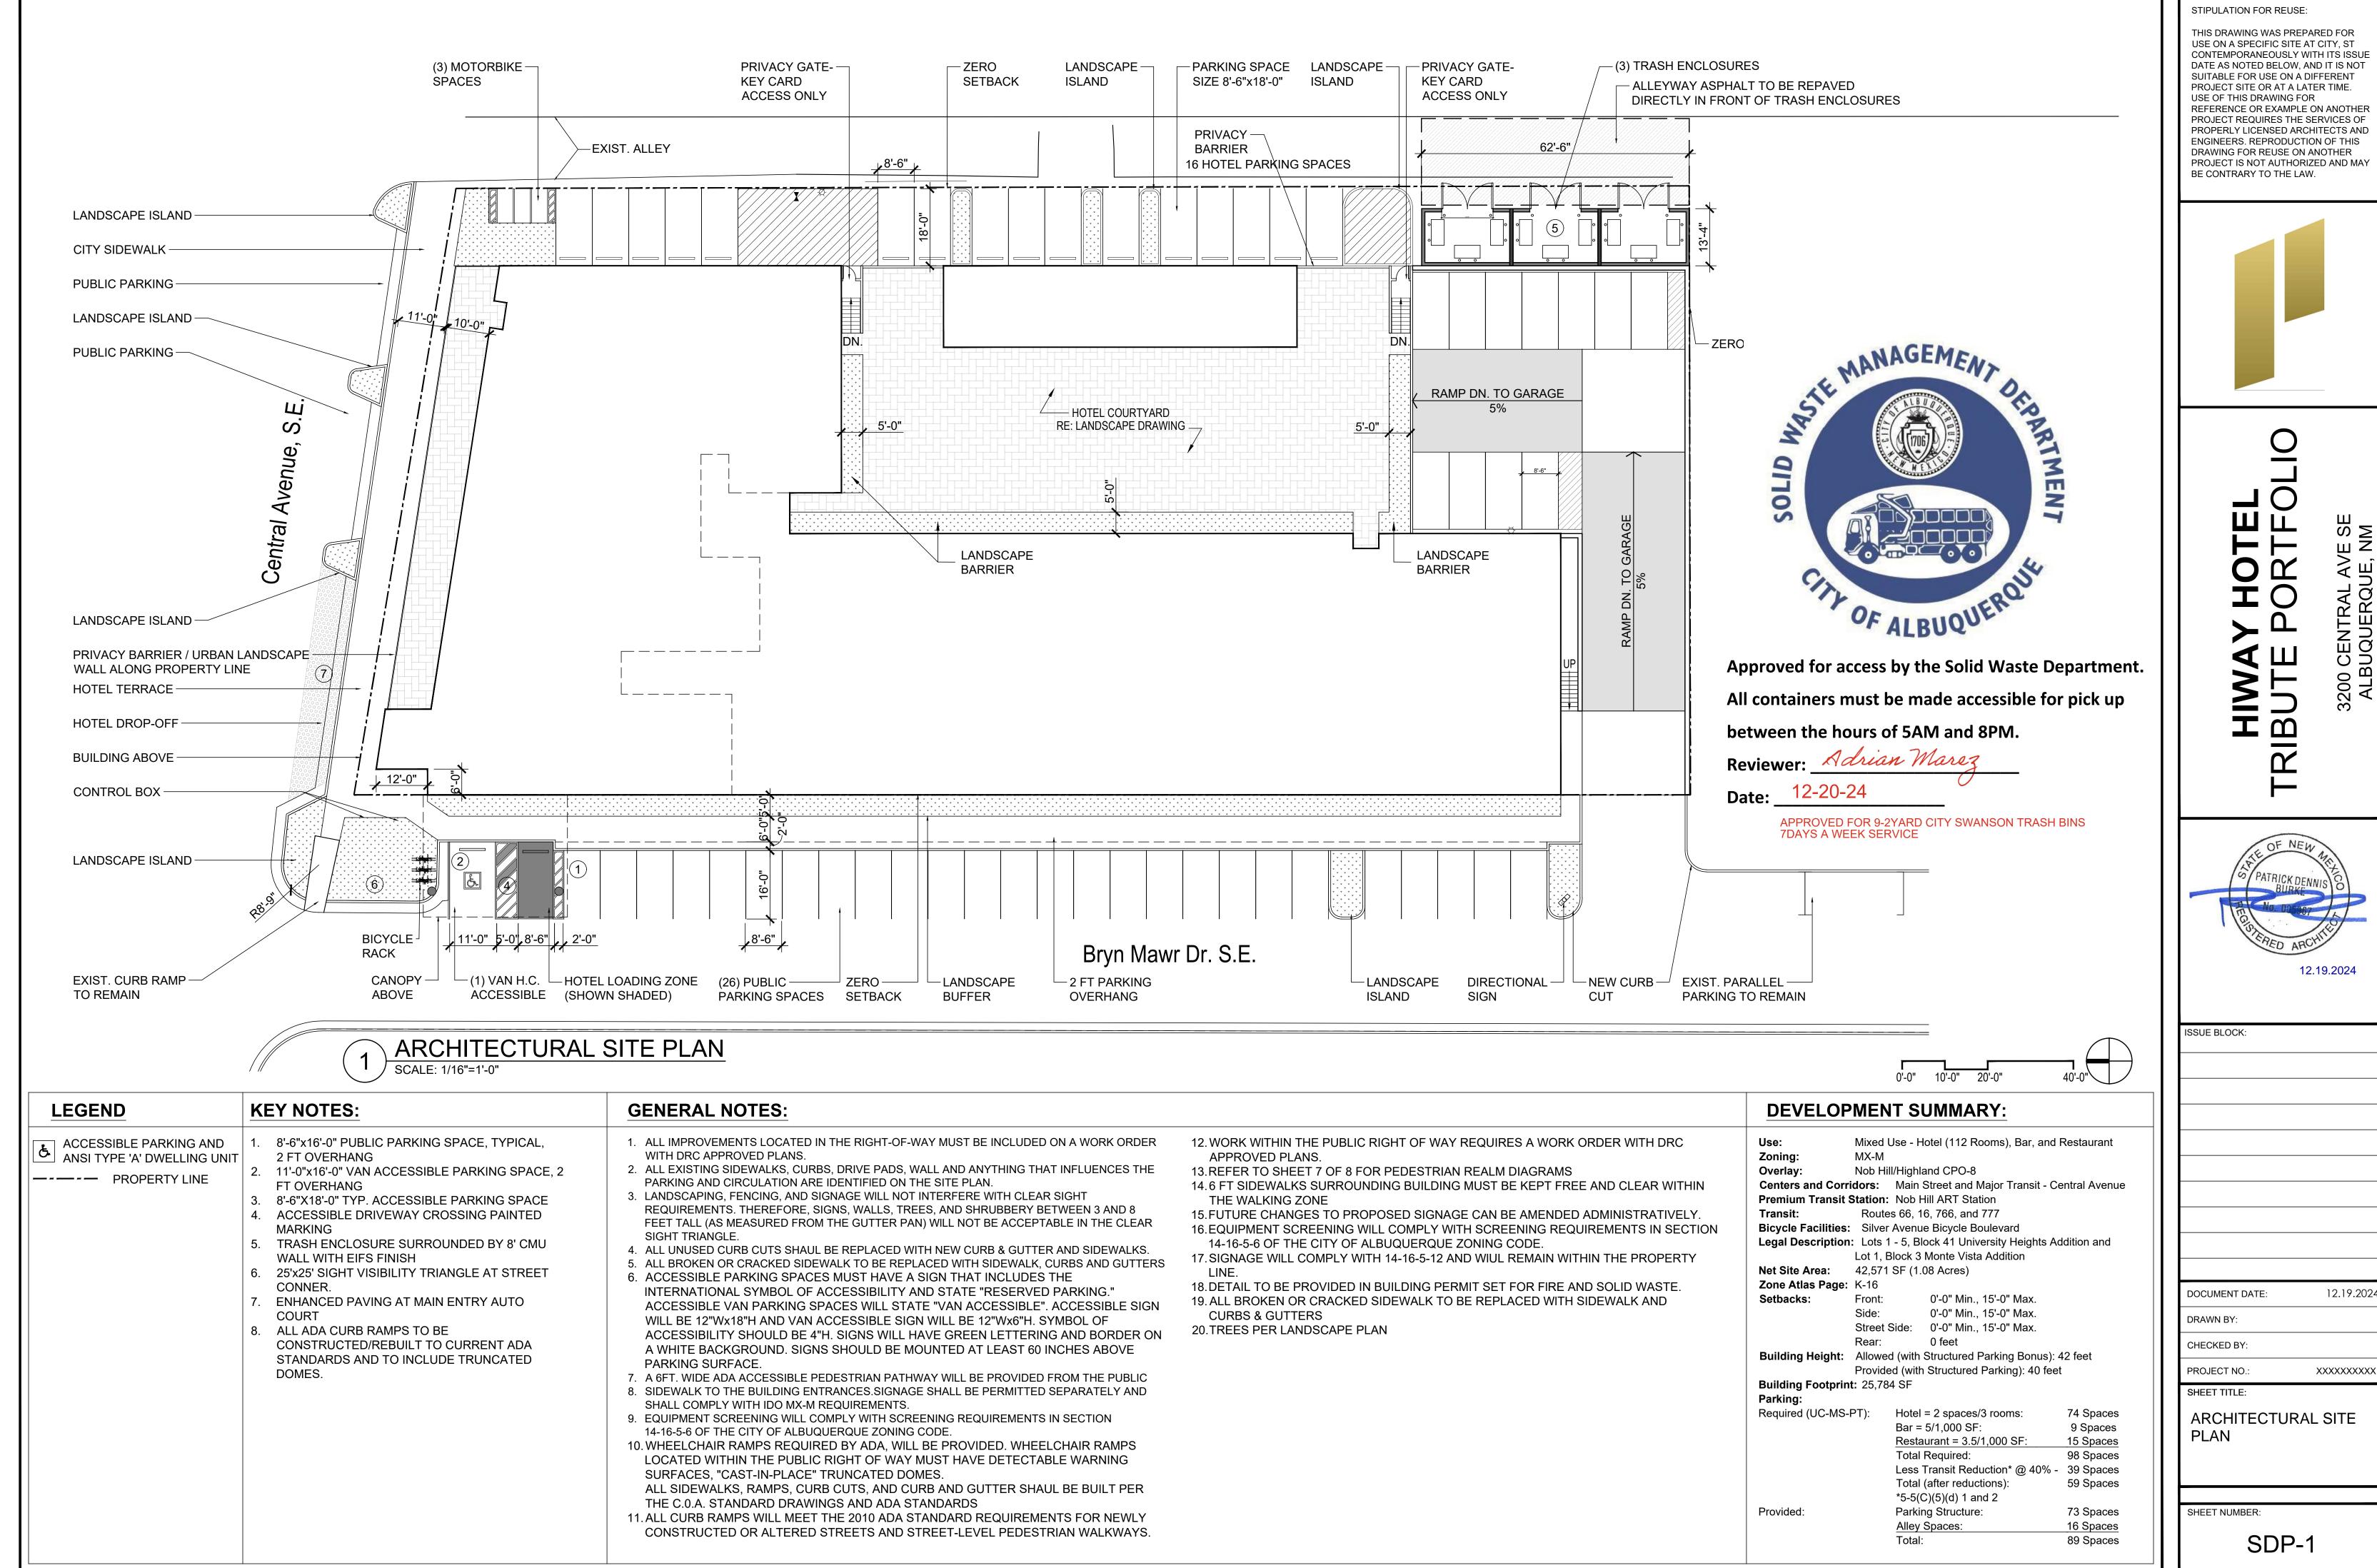



12.19.202