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UPC: 101005652542410601 LEGAL: TRACT 155 UNIT 6 ATRISCO GRANT ZONING: MX-T ZONE ATLAS PAGE: L-10 & L-11

GROSS LOT AREA = 5.66 AC = 246,549 SF BUILDING FOOTPRINT = 78,498 SF NET LOT AREA = 168,051 SF

REQUIRED LANDSCAPE AREA @ 15% = 25,207 SF; 55,501 SF PROVIDED

IDO TABLE 5-5-1 PARKING : MULTI-FAMILY 1 BEDROOM: 108 EACH X 1.2 SPACES = 129.6 SPACES 2 BEDROOM: 12 EACH X 1.6 SPACES = 19.2 SPACES 3 BEDROOM: 30 EACH X 1.8 SPACES = 54 SPACES TOTAL SPACES REQUIRED: 202.8 SPACES

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TOTAL REQUIRED = 18,330 SF

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THE SLOPE LEADING TO THE TRASH ENCLOSURE/DUMPSTER SHALL BE NO GREATER THAN 1/8" PER FOOT ON THE APPROACH.

THERE IS NO FOOD SERVICE FOR THIS PROJECT.

RECYCLING CONTAINERS LOCATED ADJACENT TO THE REFUSE ENCLOSURE, SEE KEYED NOTE.

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BUSINESSES DURING CONSTRUCTION. PROPERTY OWNER RESPONSIBLE FOR PLACING RECYCLING AT DESIGNATED

OWNER SHALL PURCHASE 8 CY REFUSE CONTAINER.

COLLECTION POINT ON COLLECTION DAY.

KEYED NOTES

- 1. NEW DRIVE CUT REF CITY OF ALBUQUERQUE STANDARD DETAIL 2426 FOLLOW
- PARALLEL RAMP DETAIL, NOTE DETAIL 2446 FOR DETECTABLE WARNING SURFACE. 2. 6 SPACE BIKE RACK, REF DETAIL SHEET A-501
- 3. MOTORCYCLE PARKING SIGN REF DETAIL SHEET A-501 4. H.C. PARKING SIGN, REF DETAIL ON SHEET A-501 NEW FIRE HYDRANT
- NEW 6' SIDEWALK, 2% MAX CROSS SLOPE, 1.5% PREFERRED CROSS SLOPE, REFERENCE CITY OF ALBUQUERQUE STANDARD DETAIL 2430
- HC PARKING SYMBOL 8. CURB AND GUTTER, REF COA DETAIL
- 9. EXISTING PROPERTY LINE
- 10. NEW ROLL CURB REF CITY OF ALBUQUERQUE STANDARD DETAIL 2415A. 11. CLEAR SIGHT TRIANGLE. LANDSCAPING, FENCING AND SIGNING WILL NOT INTERFERE WITH CLEAR SIGHT REQUIREMENTS. THEREFORE, SIGNS, WALLS, TREES AND SHRUBBERY BETWEEN 3 AND 8 FT TALL (AS MEASURED FROM THE GUTTER PAN) WILL NOT BE ACCEPTABLE IN THE CLEAR SIGHT TRIANGLE
- 12. CURB RAMP, REFERENCE CITY OF ALBUQUERQUE STANDARD DETAIL 2441, NOTE DETAIL 2446 FOR DETECTABLE WARNING SURFACE
- 13. PARALLEL RAMP, REFERENCE CITY OF ALBUQUERQUE STANDARD DETAIL 2443
- 14. EXISTING BLOCK WALL
- 15. REFUSE CONTAINER, REF DETAIL THIS SHEET
- 16. IDO SETBACK LINE
- 17. APSHALT PAVING 18. RECYCLING CONTAINER STORAGE POINT 19. TRASH ENCLOSURE
- 20. FRONT DOOR 21. RETENTION POND
- 22. NEW 6FT RETENTION WALL 23. NEW METAL FENCE REFERENCE DETAIL ON A-501
- 25. PIV 26. FDC
- 27. 5FT LANDSCAPE BUFFER 28. NEW CROSSWALK

24. EXISTING 5FT SIDEWALK

ALL IMPROVEMENTS LOCATED IN THE RIGHT OF WALL MUST BE INCLUDED ON A PUBLIC WORK ORDER

LEGEND

BUILDING

: CONCRETE

ASPHALT PAVING

CLEAR SIGHT TRIANGLE

LANDSCAPE

Date

Date

Date

Date

Date


Date

Date

No Revision Item			Date
	& associates 2818 4th St NW, Suite scott@sca	ANDERSON s architects C Albuquerque NM 87107 narchitects.com 401.7575	
SAMANA APAR	TMENTS		
6501 BATAAN D	OR SW		
ALBUQUERQUI	E, NM 8710	9	
DRAWING TITLE SITE PL	.AN		
SEAL OF NEW MEY	DESIGNED	PROJECT NO	
COTTEC.	DRAWN	SCALE	
PRIDERSON (NO. 4341)	CHECKED	DRAWING NO	
05/01/2025	REVIEWED	A- 1	00
JOSTERED ARCHITECT	DATE 05/01/2025		OF

CITY OF ALBUQUERQUE

Planning Department Alan Varela, Director

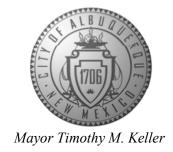

July 7, 2025

Shawn Biazar, P.E. SBS Construction and Engineering, LLC 7632 William Moyers Avenue, NE Albuquerque, NM 87114

RE: Samana Apartments / Townhomes 99999 Bridge SW Grading and Drainage Plan Engineer's Stamp Date: 06/27/2025 Hydrology File: L11D072 Case # HYDR-2025-0235

Dear Mr. Biazar,

PO Box 1293

Based upon the information provided in your submittal received 07/01/2025, the Grading & Drainage Plan is approved for action by the Development Facilitation Team (DFT) on Site Plan for Building Permit or for action by the Development Hearing Officer (DHO) on Preliminary Plat, and for Building Permit, Grading Permit, and SO-19 Permit. Please attach a copy of this approved plan in the construction sets for Building Permit processing along with a copy of this letter.

Albuquerque

PRIOR TO CERTIFICATE OF OCCUPANCY:

NM 87103

1. Engineer's Certification, per the DPM Part 6-14 (F): Engineer's Certification Checklist For Non-Subdivision is required.

www.cabq.gov

2. Please provide the Drainage Covenant with Exhibit A for the stormwater quality ponds per Article 6-15(C) of the DPM prior to Permanent Release of Occupancy. Please submit the original copies along with the \$ 25.00 recording fee check made payable to Bernalillo County to Carrie Compton (cacompton@cabq.gov) on the 4th floor of Plaza de Sol.

If you have any questions, please contact me at 505-924-3314 or amontoya@cabq.gov.

Sincerely,

Anthony Montoya, Jr., P.E., CFM

Senior Engineer, Hydrology

anth Mars

Planning Department, Development Review Services



City of Albuquerque

Planning Department
Development & Building Services Division

DRAINAGE AND TRANSPORTATION INFORMATION SHEET (DTIS)

Project Title: SAMANA APARTMENT/TOWNHOMES	Hydrology File # L11D072
Legal Description: Tract 155, Unit 6, Town of Atrisco Gran	
City Address, UPC, OR Parcel: 101005652542410601	
Applicant/Agent: SBS CONSTRUCTION AND ENGINEERING,	LLC Contact: SHAWN BIAZAR
Address: 7632 WILLIAM MOYERS AVE., NE ALBUQUERQUE, NM 8	
Email: AECLLC@AOL.COM	
ALi	Contact
Applicant/Owner:Address:	
Email:	
(Please note that a DFT SITE is one that needs Site Plan Ap	pproval & ADMIN SITE is one that does not need it.)
TYPE OF DEVELOPMENT: PLAT (#of lots)	RESIDENCE
DFT SITE	ADMIN SITE
	<u> </u>
RE-SUBMITTAL: YES 🖊 NO	
DEPARTMENT: TRANSPORTATION	HYDROLOGY/DRAINAGE
DEFARTMENT: TRANSPORTATION	THI DROLOG I/DRAINAGE
Check all that apply under Both the Type of Submittal	and the Type of Approval Sought:
TYPE OF SUBMITTAL:	TYPE OF APPROVAL SOUGHT:
ENGINEER/ARCHITECT CERTIFICATION	✓ BUILDING PERMIT APPROVAL
PAD CERTIFICATION	CERTIFICATE OF OCCUPANCY
CONCEPTUAL G&D PLAN	CONCEPTUAL TCL DFT APPROVAL
GRADING & DRAINAGE PLAN	PRELIMINARY PLAT APPROVAL
V DRAINAGE REPORT	FINAL PLAT APPROVAL
DRAINAGE MASTER PLAN	SITE PLAN FOR BLDG PERMIT DFT
CLOMR/LOMR	APPROVAL
TRAFFIC CIRCULATION LAYOUT (TCL)	SIA/RELEASE OF FINANCIAL GUARANTEE
ADMINISTRATIVE	FOUNDATION PERMIT APPROVAL
TRAFFIC CIRCULATION LAYOUT FOR DFT	GRADING PERMIT APPROVAL
APPROVAL	SO-19 APPROVAL
TRAFFIC IMPACT STUDY (TIS)	PAVING PERMIT APPROVAL
STREET LIGHT LAYOUT	GRADING PAD CERTIFICATION
OTHER (SPECIFY)	WORK ORDER APPROVAL
	CLOMR/LOMR
	OTHER (SPECIFY)
DATE SUBMITTED: <u>6-27-25</u>	

REV. 09/13/23

LOCATION

This site is located at northwest corner of Eucariz Ave., SW and Bataan Dr., SW. See attached Vicinity map for location location.

The purpose of the plan to provide show the grading and drainage plan for the proposed town homes and apartments.

EXISTING DRAINAGE CONDITIONS

nor sidewalk. No other water drains enters into this site.

The site drains from west to east into Bataan Dr., SW. The site is souroundad on three sides by Coors Road, SW, Eucariz Avenue and Bridge on the south side and Bataan Drive on the east side. There is existing subdivision to the north that is separated from this site by block wall. Batann Drive is a developed Street with curb and gutter and sidewalk. Eucariz has also curb and gutter and sidewalk along the property. Bridge is only paved toad with no curb and gutter

PROPOSED CONDITIONS

This site falls within SAD 221 development area. The site is part of Bataan Drive, SW area which contains 64.60 acres, see attached highlighted zone atlas page L-11 from the SAD 221 report. As part of the this SAD 221, this site is allowed to drain into the existing storm drain system based on the proposed percentage shown on the volume summary page which is also attached from the report. The report shows the site is allowed to free discharge at 42% Treatment D and 58% Treatment B. See calculation under allowable section. The existing pattern on drainage will stay the same. We will be ponding the proposed condition minus the allowable condition. There are several ponds proposed for this site and also depressed landscaping area. The water will drain into Eucariz and Bataan via sidewalk proposed sidewalk culverts. Total pond volume requirement is (proposed condition 56,875.05 CF minus allowable condition 42,664.45 CF) 14,210.60 CF. We have provided total pond volume of 21,383.75 CF.

FIRST FLUSH VOLUME CALCULATION

First Volume requirement = (0.42/12*151820.00) = 5,313.70

Total Ponding Volume Provided = 21,383.75

VOLUME CALCULATIONS FOR 10 DAY STORM

 $\overline{AA + AB + AC + AD}$

BASIN	AREA	(SF)	AREA	(AC)	AREA	(MI²)
ON-SITE	244,8	68.18	5.62	214	0.00	8783
= EA(AA) + EB(AB) + EC(AC) + ED(AD)						

V-360 = E(AA + AB + AC + AD)

EA = 0.55EB = 0.73EC = 0.95ED = 2.24

P-60 = 1.69P-360 = 2.17

FF=5031.00 \

1 FF=5029.50 1

P-1440 = 2.49

P-10 Day = 3.90

V-360 =

AA = 0.00%AB = 58.00%AC = 0.00%AD = 42.00%

AD = 0.00%0.5500 IN 1.3642 IN 0.2576 AC-FT V-360 =0.6391 AC-FT 0.0000~AC2.3610 AC V-10 DAY = 0.2576 AC-FTV-10 DAY = 0.9794 AC-FTV-10 DAY= 11,223.19 CF V-10 DAY= 42,664.45 CF

ALLOWABLE CONDITION SAD 221

V (REQUIRED) = V (PROPOSED) - V (ALLOWABLE) = 56,875.05 - 42,664.45

V (REQUIRED) = 14,210.60 CF

EXISTING CONDITION

AA = 100.00%

AB = 0.00%

AC = 0.00%

TOTAL PONDING PROVIDED = 19,379.25 CF

		PONDING AF	REA CALC.		
POND NO.	TOP AREA	BOTTOM AREA	TOTAL AREA	DEPTH	TOTAL VOLUME
A	3050.00	1990.00	5040.00	1.50	3780.00
В	1890.00	1065.00	2955.00	1.00	1477.50
С	1306.00	615.00	1921.00	1.00	960.50
D	760.00	320.00	1080.00	1.00	540.00
Е	3140.00	1930.00	5070.00	2.00	5070.00
F	1480.00	400.00	1880.00	1.00	940.00
G	750.00	300.00	1050.00	1.00	525.00
Н	6200.00	2780.00	8980.00	0.75	3367.50
I	1550.00	875.00	2425.00	1.50	1818.75
J	1650.00	750.00	2400.00	0.75	900.00
DEPRESSED	LANDSCAP	ING AREA			2004.50
TOTAL PON	DDING PRO	VIDED			21383.75

FF=5026.25

| FF=5025.25 | FF=5024.25

KEYED NOTES

1. DEPRESSED 6" LANDSCAPING AREA.

2. NEW DRIVEWAY PER COA. STD. DWG. 2426.

PROPOSED CONDITION

1.7146 IN

3.4853 AC

V-10 DAY = 1.3057 AC-FT

V-10 DAY= 56,875.05 CF

0.8032 AC-FT

AA = 0.00%

AB = 16.00%

AC = 22.00%

AD = 62.00%

AD =

3. PROPOSED 2-24" SIDEWALK CULVER.

4. PROPOSED 1-24" SIDEWALK CULVER.

5. EXISTING SIDEWALK.

6. EXISTING CURB AND GUTTER.

7. PROPOSED STANDARD CURB AND GUTTER PER COA. STD. DWG. 2415A.

FF=5021.50

SIDEWALK CULVERT CALCULATION

H = 1.00', C = 2.95, L=24" (2.00')

 $2.95*2*(1.00)^{1/2} = 2.958*2*0.548418636$

Use 2-2' Sidwalk Culvert (2x5.9=11.80 cfs)

24" Sidewalk Culvert 12" High Headerwall Using Weir Equation

8. PROPOSED SIDEWALK PER COA. STD. DWG. 2430.


9. EXISTING DROP INLETS.

10. PROVIDE 2' CURB OPENING.

FF=5023.00

FF=5022.25

FF=5023.50

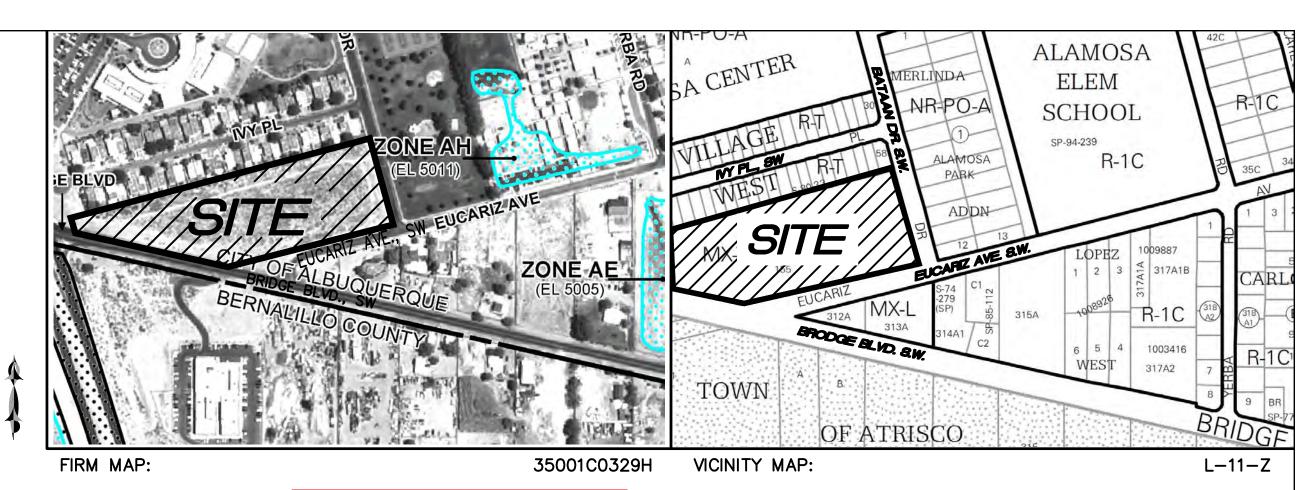

City of Albuquerque **Planning Department Development Review Services HYDROLOGY SECTION APPROVED**

7/7/2025 anth Mars HydroTrans # L11D072 THE APPROVAL OF THESE PLANS/REPORTS SHALL NOT BE CONSTRUED TO PERMIT VIOLATIONS OF ANY CITY ORDINANCE OR STATE LAW, AND SHALL NOT PREVENT THE CITY OF ALBUQUERQUE FROM REQUIRING CORRECTIONS FOR ERRORS OR DIMENSIONS IN PLANS, SPECIFICATIONS, OR CONSTRUCTION DOCUMENTS. SUCH APPROVED PLANS/REPORTS SHALL NOT BE CHANGED, MODIFIED OR ALTERED WITHOUT AUTHORIZATION. THE APPROVAL OF THESE PLANS/REPORTS SHALL EXPIRE TWO (2) YEARS AFTER THE APPROVAL DATE IF NO BUILDING PERMIT HAS BEEN PULLED ON THE DEVELOPMENT.

LEGAL DESCRIPTION:

TRACT 155, UNIT 6, OF VARIOUS LOTS ALLOTED, TOWN OF ATRISCO GRANT, UNIT 3 CONTAINING 5.6214 ACRES.

ADDRESS:

XXXX BATAAN DRIVE, SW

GENERAL NOTES:

1: CONTOUR INTERVAL IS HALF (1.00) FOOT.

2: UTILITIES SHOWN HEREON ARE IN THEIR APPROXIMATE LOCATION BASED ONLY ON ABOVE GROUND EVIDENCE FOUND IN THE FIELD AND AS-BUILT INFORMATION PROVIDED BY THE CLIENT. UTILITIES SHOWN HEREON, WHETHER INDICATED AS ABANDONED OR NOT, SHALL BE VERIFIED BY OTHERS FOR EXACT LOCATION AND / OR DEPTH PRIOR TO EXCAVATION OR DESIGN CON-SIDERATIONS.

3: THIS IS <u>NOT</u> A BOUNDARY SURVEY, BEARINGS ARE ASSUMED, DISTANCES AND FOUND PROPERTY CORNERS ARE FOR <u>INFORMATIONAL PURPOSES ONLY.</u>

4: SLOPES ARE AT 3:1 MAXIMUM.

5: ADD 5000 TO ALL PROPOSED SPOT ELEVATIONS.

LEGEND

---5030--- EXISTING CONTOUR (MAJOR) EXISTING CONTOUR (MINOR) BOUNDARY LINE PROPOSED SPOT ELEVATION X 28.50 EXISTING GRADE \times 5029.16 EXISTING FLOWLINE ELEVATION \times 5075.65 PROPOSED RETAINING WALL BC = 89.08BOTTOM OF CHANEL TF=28.50 TOP OF FOOTING

TRW=28.00 TOP OF RETAINING WALL HIGH POINT

AS-BUILT GRADES

X 5325.64 AS-BUILT SPOT ELEVATIONS *FF=5317.85* FP=5317.85

SBS CONSTRUCTION AND ENGINEERING, LLC

l **O**F 1

10209 SNOWFLAKE CT., NW ALBUQUERQUE, NEW MEXICO 871114

DRAWING:

REZA AFAGHPOUR P.E. #11814

SCALE: 1"=50"

GRAPHIC SCALE

SAMANA APARTMENTS/TOWNHOMES GRADING AND DRAINAGE PLAN DRAWN BY: DATE: SHEET # 12-28-2019

SBB

EUCARIZ Private Drainage Facilities within City Right-of-Way Notice to (Special Order 19 ~ "SO-19") 1. Build sidewalk culvert per COA STD DWG 2236. 2. Contact Storm Maintenance at (505) 857-8033 to schedule a meeting prior to forming.

FF=5018.00

F\$\&\\$5019.00

FF=5020.00

3. An excavation permit will be required before beginning any work within City Right-Of-Way.

4. All work on this project shall be performed in accordance with applicable federal, state and local laws, rules and regulations concerning construction safety and health.

5. Two working days prior to any excavation, the contractor must contact New Mexico One Call, dial "811" [or (505) 260-1990] for the location of existing utilities.

6. Prior to construction, the contractor shall excavate and verify the locations of all obstructions. Should a conflict exist, the contractor shall notify the engineer so that the conflict can be resolved with a minimum amount of delay.

7. Backfill compaction shall be according to traffic/street use. 8. Maintenance of the facility shall be the responsibility of the owner of the property being served.

9. Work on arterial streets may be required on a 24-hour basis. 10. Contractor must contact Storm Maintenance at (505) 857-8033 to schedule a construction inspection. For excavating and barricading inspections, contact Construction Coordination at (505)

924-3416.

CITY OF ALBUQUERQUE

Planning Department Alan Varela, Director



Mayor Timothy M. Keller

May 19, 2025

Scott Anderson, RA Scott Anderson & Associates Architects 5009 Royene NE Albuquerque, NM 87110

scott@scaarchitects.com

Re: Samana Apartments 6501 Bataan SW

Traffic Circulation Layout

Engineer's Stamp 5-1-25 (L11D072) TRANS-2025-00131

Dear Mr. Anderson,

The TCL submittal received 5-12-2025 is approved for Building Permit by Transportation. A copy of the stamped and signed plan will be needed for each of the building permit plans. Please keep the original to be used for certification of the site for final C.O. for Transportation.

Albuquerque

PO Box 1293

When the site construction is completed and an inspection for Certificate of Occupancy (C.O.) is requested, use the original City stamped approved TCL for certification. Redline any minor changes and adjustments that were made in the field. A NM registered architect or engineer must stamp, sign, and date the certification TCL along with indicating that the development was built in "substantial compliance" with the TCL. Submit this certification, and the TCL to the <u>ABQ-PLAN</u> for log in and evaluation by Transportation.

NM 87103

Once verification of certification is completed and approved, notification will be made to Building Safety to issue Final C.O. To confirm that a final C.O. has been issued, call Building Safety at 924-3690.


www.cabq.gov

Sincerely,

Sertil A. Kanbar

Sertil Kanbar, PhD,PE,CFM Sr. Engineer, Planning Dept. Development Review Services

C: CO Clerk, File

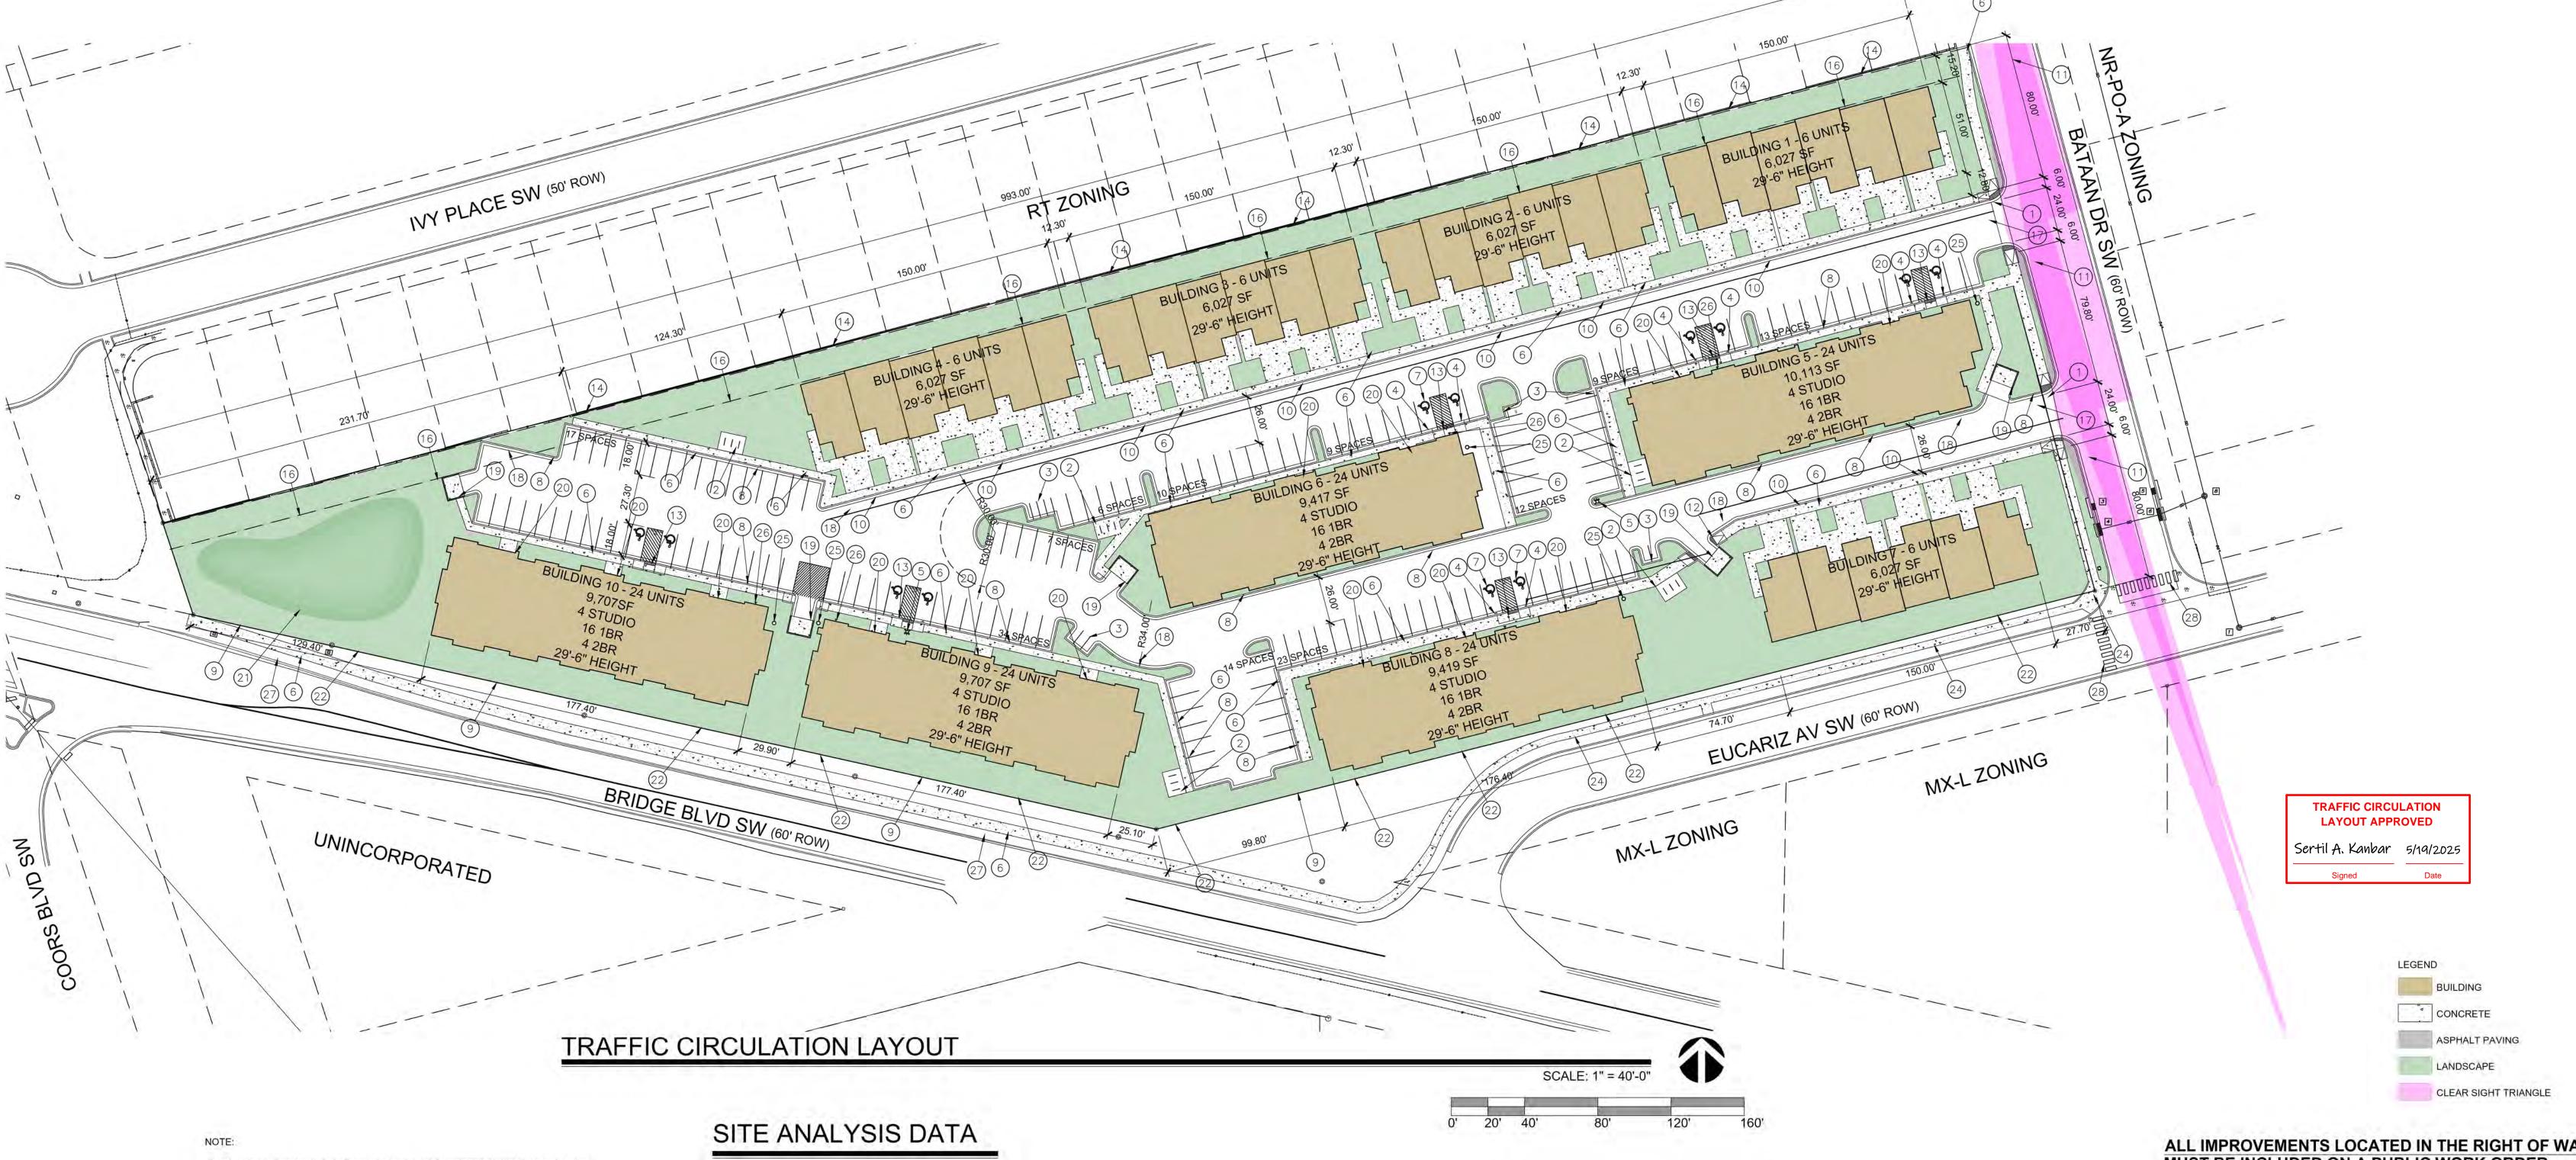

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COLLECTION POINT ON COLLECTION DAY.

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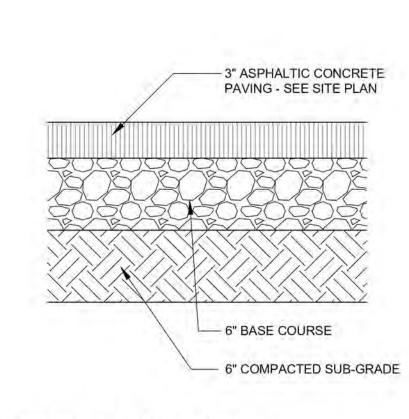
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- 7. HC PARKING SYMBOL 8. CURB AND GUTTER, REF COA DETAIL
- 9. EXISTING PROPERTY LINE 10. NEW ROLL CURB REF CITY OF ALBUQUERQUE STANDARD DETAIL 2415A.
- 11. CLEAR SIGHT TRIANGLE, LANDSCAPING, FENCING AND SIGNING WILL NOT INTERFERE WITH CLEAR SIGHT REQUIREMENTS. THEREFORE, SIGNS, WALLS, TREES AND SHRUBBERY BETWEEN 3 AND 8 FT TALL (AS MEASURED FROM THE GUTTER PAN) WILL NOT BE ACCEPTABLE IN THE CLEAR SIGHT TRIANGLE
- 12. CURB RAMP, REFERENCE CITY OF ALBUQUERQUE STANDARD DETAIL 2441, NOTE DETAIL 2446 FOR DETECTABLE WARNING SURFACE
- 13. PARALLEL RAMP, REFERENCE CITY OF ALBUQUERQUE STANDARD DETAIL 2443
- 14. EXISTING BLOCK WALL 15. REFUSE CONTAINER, REF DETAIL THIS SHEET
- 17. APSHALT PAVING 18. RECYCLING CONTAINER STORAGE POINT


IDO SETBACK LINE


- 19. TRASH ENCLOSURE 20. FRONT DOOR
- 21. RETENTION POND 22. NEW 6FT RETENTION WALL
- 23. NEW METAL FENCE REFERENCE DETAIL ON A-501 24. EXISTING 5FT SIDEWALK
- 25. PIV 26. FDC
- 27. 5FT LANDSCAPE BUFFER 28. NEW CROSSWALK


ALL IMPROVEMENTS LOCATED IN THE RIGHT OF WALL

No Revision Ite	m		Date
	& assoc	C. ANDERSON iates architects V. Soute C. Albuquerque NM 87107 of the C. Albuquerque NM 87107 505.401.7575	
CAMANIA ADA	ARTMENTS	3	
6501 BATAAN ALBUQUERG	N DR SW		
6501 BATAAN ALBUQUERG DRAWING TITLE	N DR SW QUE, NM 87		OUT
6501 BATAAN ALBUQUERG DRAWING TITLE TRAF	N DR SW QUE, NM 87	7109	OUT
6501 BATAAN ALBUQUERG DRAWING TITLE TRAF	N DR SW QUE, NM 87	7109 JLATION LAY	OUT
6501 BATAAN ALBUQUERG DRAWING TITLE TRAF	N DR SW QUE, NM 87 FIC CIRCL	7109 JLATION LAY PROJECT NO	



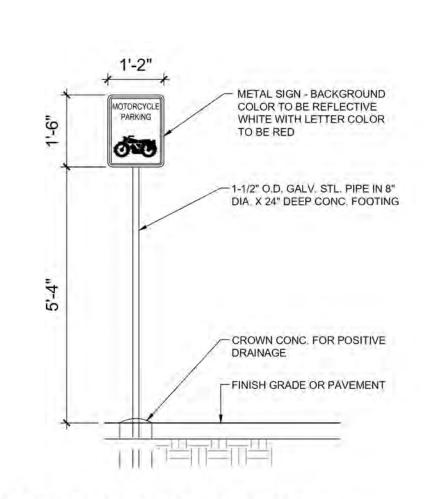

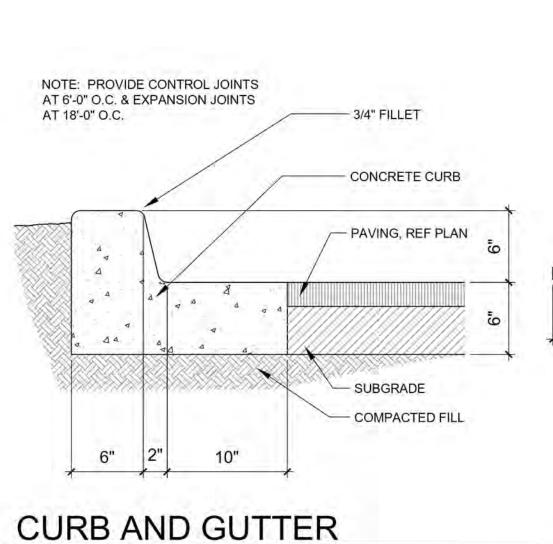


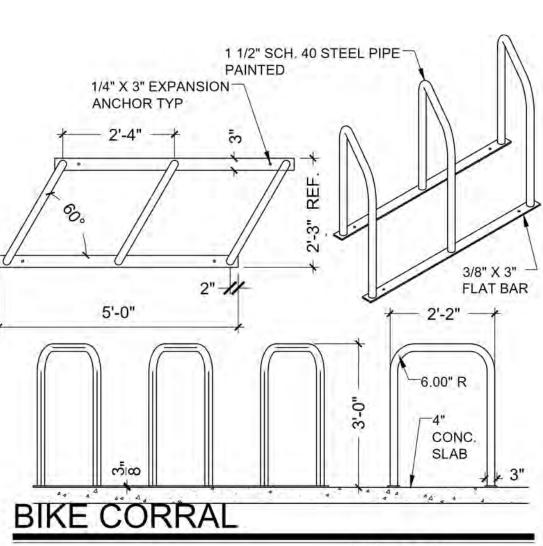


TRAFFIC CIRCULATION LAYOUT APPROVED Sertil A. Kanbar 5/19/2025


PAVING SECTION

SCALE: NTS

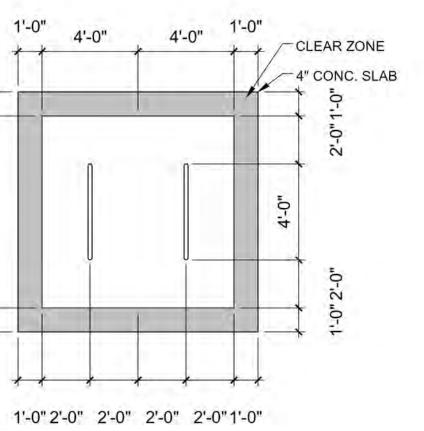


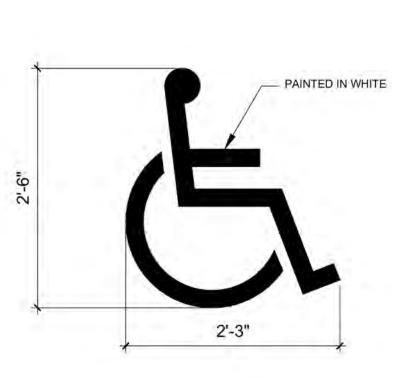

MOTORCYCLE SIGN

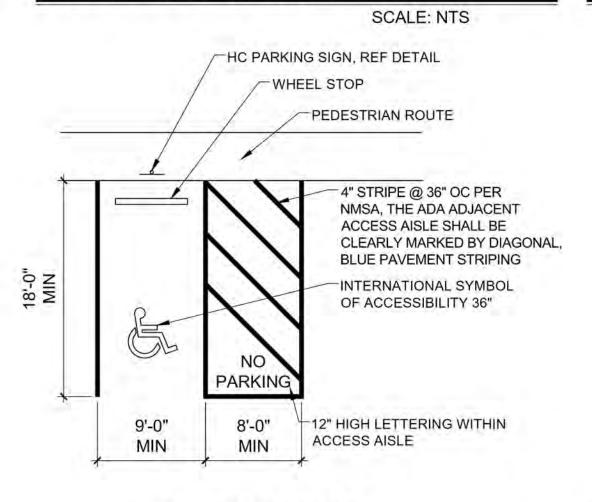

ADA PARKING

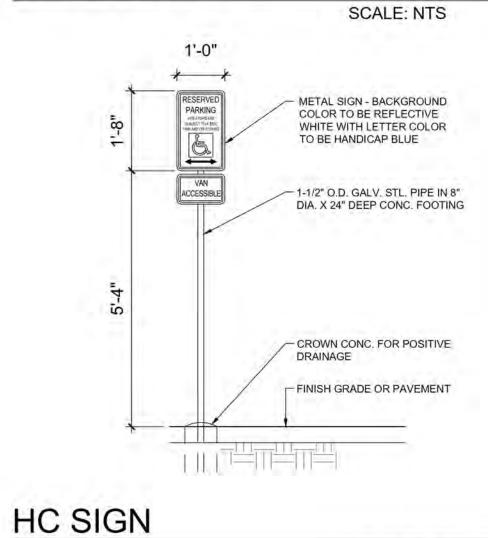

SCALE: NTS

o Revision Item Date SCOTT C. ANDERSON & associates architects 2818 4th St NW, State C. Albuquerque NM 87107 scott@scaarchitects.com 505.401.7575 SAMANA APARTMENTS 6501 BATAAN DR SW ALBUQUERQUE, NM 87109 SITE DETAILS PROJECT NO SCOTT C. AIDERSON MR No. 4341 CHECKED 05/01/2025 REVIEWED DATE 5/1/2025

TRASH ENCLOSURE

12-0" STD, ENCLOSURE 4'-6" 3'-0" 4'-6"

CONCRETE SLAB, 6* THICK 4,000 PSI, * AGGREGATE WITH 6X6 - 10/10 WWM OR

SEPARATE BOLARDS FOR GATES

6" THICK, 4,000 PSI 3/4" AGGREGATE WITH 5X6 -10 / 10 WWM OR EOUAL 12"-0" X 8"-0" WITH 1/2" EXPANSION JOINT

APRON REQUIRED IN FRONT OF EACH ENCLOSURE (6" WITH REINFORCING TO WITHSTAND 57,000 LIBS)

CROWNED CONC.
TOP BOND BM W/
(1)-#4 CONT.
BEYOND
STEEL ENCLOSURE DOOR

FOOTING AS REQUIRED BY DESIGN

#5 @ 32" O.C. IN FILLED CMU

- SIDE BOLLARDS MAY BE REQUIRED BOLLARDS ARE TO BE 6" FROM WALL

DRILL HOLES FOR GATE PIN

6" OUTSIDE DIAMETER
CONGRETE FILLED
STEEL PIPE SHALL BE
BEYOND ENCASED IN 12"
CONGRETE ALL AROUND
PAVEMENT AND EMBEDDED 2"-0"

BARS, FABRICATED FROM 2"X2"X³" HSS.
MITER, WELD, AND GRIND SMOOTH,
WELD 16GA B DECK TO GATE FRAME.
PAINT TO MATCH THE COLOR OF THE
BUILDING'S EXTERIOR DOOR FRAMES

SCALE: 1/8" = 1'-0"

BIKE PARKING

SCALE: 1/4" = 1'-0"

HC PAVEMENT MARKING

SCALE: NTS

SCALE: 1/2" = 1'-0"

SCALE: 1" = 1'-0"




SHEET FOR ASPHALT PAVING DATA

FIRE DEPT. HYDRANT & ACCESS PERMIT REVIEW CHECKLIST


DIGITAL COPIES PROVIDED

FIRE

PLAN

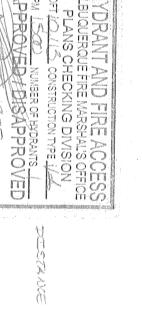



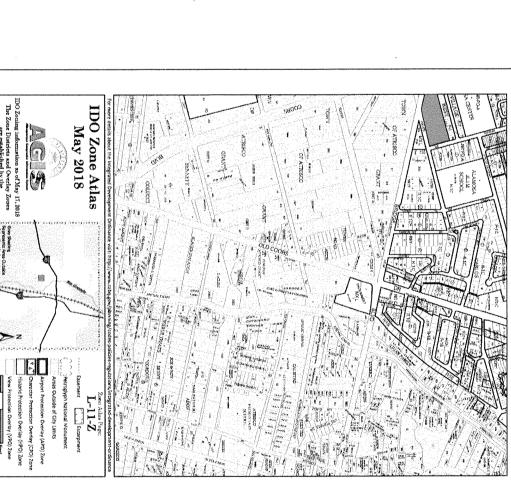

AREA MAP

SCALE:NTS

DATE 01/17/2025

FIRE CALCULATIONS

BUILDING HEIGHT = 28'-0", 2 STORY

PAVING SHALL SUPPORT 75,000 LBS. HYDRANTS REQUIRED PER IFC TABLE C105.1 = 1 HYDRANT @ 250FT MAX TYPE V - A - SPRINKLERED CONSTRUCTION

120'

160'

FIRE FLOW CALCULATION IFC 2021 APPENDIX B TABLE B105.1: IFC B105.1 CONSTRUCTION TYPE V-A-S 20,226 = FLOW @ 1,500 GPM FOR 2 HR

UPC: 101005652542410601 LEGAL: TRACT 155 UNIT 6 ATRISCO GRANT ZONING: MX-T ZONE ATLAS PAGE: L-10 & L-11

AREA: 5	AREA: 5.66 ACRES		
N _O	Revision Item		Date
	//	SCOTT C. ANDERSON	
	& as	& associates architects	i innyani kam
	2818 4ਜ਼	2818 4th St NW, Suite C Albuquerque NM 87107 scott@scaarchitects.com	
		505 401 7575	

SAMANA APARTMENTS 6501 BATAAN DR SW ALBUQUERQUE, NM 87109 FIRE 1

01/17/2025	No. 4341	Collection	C OF NEW MET
REVIEWED	CHECKED	DRAWN	DESIGNED
エスT	DRAWING NO	SCALE	PROJECT NO

