# CITY OF ALBUQUERQUE

Planning Department Alan Varela, Director



Mayor Timothy M. Keller

March 31, 2023

Craig Hagelgantz, P.E. ABQ Engineering Inc. 8102 Menaul Blvd NE, Suite D Albuquerque, NM, 87120

### RE: Wagoner Building Grading & Drainage Plan Engineer's Stamp Date: 03/23/23 Hydrology File: M15D008

Dear Mr. Hagelgantz:

Based upon the information provided in your submittal received 03/24/2023, the Grading & Drainage Plan is approved for Building Permit and Grading Permit. Please attach a copy of this approved plan in the construction sets for Building Permit processing along with a copy of this letter.

### PRIOR TO CERTIFICATE OF OCCUPANCY:

- Albuquerque 1. Engineer's Certification, per the DPM Part 6-14 (F): *Engineer's Certification Checklist For Non-Subdivision* is required.
- NM 87103
  Please provide the executed paper Drainage Covenant (latest revision) printed on one-side only with Exhibit A and a check for \$25.00 made out to "Bernalillo County" for the stormwater quality ponds per Article 6-15(C) of the DPM to Hydrology for review at Plaza de Sol.

www.cabq.gov

PO Box 1293

As a reminder, if the project total area of disturbance (including the staging area and any work within the adjacent Right-of-Way) is 1 acre or more, then an Erosion and Sediment Control (ESC) Plan and Owner's certified Notice of Intent (NOI) is required to be submitted to the Stormwater Quality Engineer (Doug Hughes, PE, jhughes@cabq.gov, 924-3420) 14 days prior to any earth disturbance.

If you have any questions, please contact me at 924-3995 or <u>rbrissette@cabq.gov</u>.

Sincerely,

Renée C. Brissette

Renée C. Brissette, P.E. CFM Senior Engineer, Hydrology Planning Department



# **City of Albuquerque**


Planning Department

Development & Building Services Division

### DRAINAGE AND TRANSPORTATION INFORMATION SHEET

TYPE OF DEVELOPMENT:    PLAT (#of lots)    RESIDENCEDRB SITEADMIN SITE:      RE-SUBMITTAL:    YES ✓ NO      DEPARTMENT:    TRANSPORTATION ✓ HYDROLOGY/DRAINAGE      Check all that apply:    TYPE OF SUBMITTAL:      TYPE OF SUBMITTAL:    TYPE OF APPROVAL/ACCEPTANCE SOUGHT:     ENGINEER/ARCHITECT CERTIFICATION    ✓ BUILDING PERMIT APPROVAL     PAD CERTIFICATION    CERTIFICATE OF OCCUPANCY     CONCEPTUAL G&D PLAN    CONCEPTUAL TCL DRB APPROVAL	Project Title: Wagoner Building	_Building Permit #	Hydrology File #
Applicant/Agent:    ABQ Engineering Inc.    Contact:    Craig Hagelgantz      Address:    8102 Menaul Blvd. NE, Suite D    Phone:    505-255-7802      Email:    chagelgantz@abqeng.com    Contact:    Matt Wagoner      Applicant/Owner:    LOE Investments LLC    Contact:    Matt Wagoner      Address:    23811Washington Ave.,Suite C-110132, Murrieta, CA 92562    Phone:    951-712-1394      Email:    matt@eastleyinc.com    Phone:    951-712-1394      TYPE OF DEVELOPMENT:   PLAT (#of lots)    RESIDENCE _DRB SITE ADMIN SITE:    ✓      RE-SUBMITTAL:    YES ✓ NO    PAPROVAL/ACCEPTANCE SOUGHT:    ✓      ENGINEER/ARCHTECT CERTIFICATION    ✓    HYDROLOGY/DRAINAGE    ✓      Check all that apply:    TYPE OF AUBMITTAL:    TYPE OF APPROVAL/ACCEPTANCE SOUGHT:    ✓      ENGINEER/ARCHTECT CERTIFICATION    ✓    BUILDING PERMIT APROVAL    ✓      PAD CERTIFICATION    ✓    CONCEPTUAL G&D PLAN    CONCEPTUAL TCL DRB APPROVAL      PAD CERTIFICATION     CONCEPTUAL TCL DR APPROVAL    SITE PLAN FOR SUB'D APPROVAL      GRADING PLAN    SITE PLAN FOR SUB'D APPROVAL    SITE PLAN FOR SUB'D APPROVAL    SITE PLAN FOR SUB'D APPROVAL			
Applicant/Agent:    ABQ Engineering Inc.    Contact:    Craig Hagelgantz      Address:    8102 Menaul Blvd. NE, Suite D    Phone:    505-255-7802      Email:    chagelgantz@abqeng.com    Contact:    Matt Wagoner      Applicant/Owner:    LOE Investments LLC    Contact:    Matt Wagoner      Address:    23811Washington Ave.,Suite C-110132, Murrieta, CA 92562    Phone:    951-712-1394      Email:    matt@eastleyinc.com    Phone:    951-712-1394      TYPE OF DEVELOPMENT:   PLAT (#of lots)    RESIDENCE _DRB SITE ADMIN SITE:    ✓      RE-SUBMITTAL:    YES ✓ NO    PAPROVAL/ACCEPTANCE SOUGHT:    ✓      ENGINEER/ARCHTECT CERTIFICATION    ✓    HYDROLOGY/DRAINAGE    ✓      Check all that apply:    TYPE OF AUBMITTAL:    TYPE OF APPROVAL/ACCEPTANCE SOUGHT:    ✓      ENGINEER/ARCHTECT CERTIFICATION    ✓    BUILDING PERMIT APROVAL    ✓      PAD CERTIFICATION    ✓    CONCEPTUAL G&D PLAN    CONCEPTUAL TCL DRB APPROVAL      PAD CERTIFICATION     CONCEPTUAL TCL DR APPROVAL    SITE PLAN FOR SUB'D APPROVAL      GRADING PLAN    SITE PLAN FOR SUB'D APPROVAL    SITE PLAN FOR SUB'D APPROVAL    SITE PLAN FOR SUB'D APPROVAL	Legal Description: Lot DIA NEWPORT INDUSTRIAL PARK- GROWNEY II SUBDIVISION CONT 1.3499	AC City Address	OR Parcel 1800 Randolph Rd. SE
Address:    8102 Menaul Blvd. NE, Suite D    Phone:    505-255-7802      Email:    chagelgantz@abqeng.com    Phone:    505-255-7802      Adplicant/Owner:    LOE Investments LLC    Contact:    Matt Wagoner      Address:    23811Washington Ave.,Suite C-110132, Murrieta, CA 92562    Phone:    951-712-1394      Email:    matt@eastleyinc.com    951-712-1394      FYPE OF DEVELOPMENT:    PLAT (#of lots)    RESIDENCE    DRB SITE    ADMIN SITE:      RE-SUBMITTAL:    YES    ✓    NO      DEPARTMENT:    TRANSPORTATION    ✓    HYDROLOGY/DRAINAGE      Check all that apply:    TYPE OF SUBMITTAL:    TYPE OF APPROVAL/ACCEPTANCE SOUGHT:     ENGINEER/ARCHITECT CERTIFICATION    ✓    BUILDING PERMIT APPROVAL     ADA CERTIFICATION    ✓    BUILDING PERMIT APPROVAL     ADA CERTIFICATION    ✓    BUILDING PERMIT APPROVAL     ARADINA GE REPORT    SITE PLAN FOR BLDE PROVAL    SITE PLAN FOR BLDE PERMIT APPROVAL     FLOOD PLAN DEVELOPMENT PERMIT APP.    FINAL PLAT APPROVAL    GRADING PERMIT APPROVAL     FLOOD PLAN DEVELOPMENT PERMIT APP.   FINAL PLAT APPROVAL    GRADING PERMIT APPROVAL     FLOOD PLAN DEVELOPMENT			
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		(011	)

DATE SUBMITTED: 3/24/23

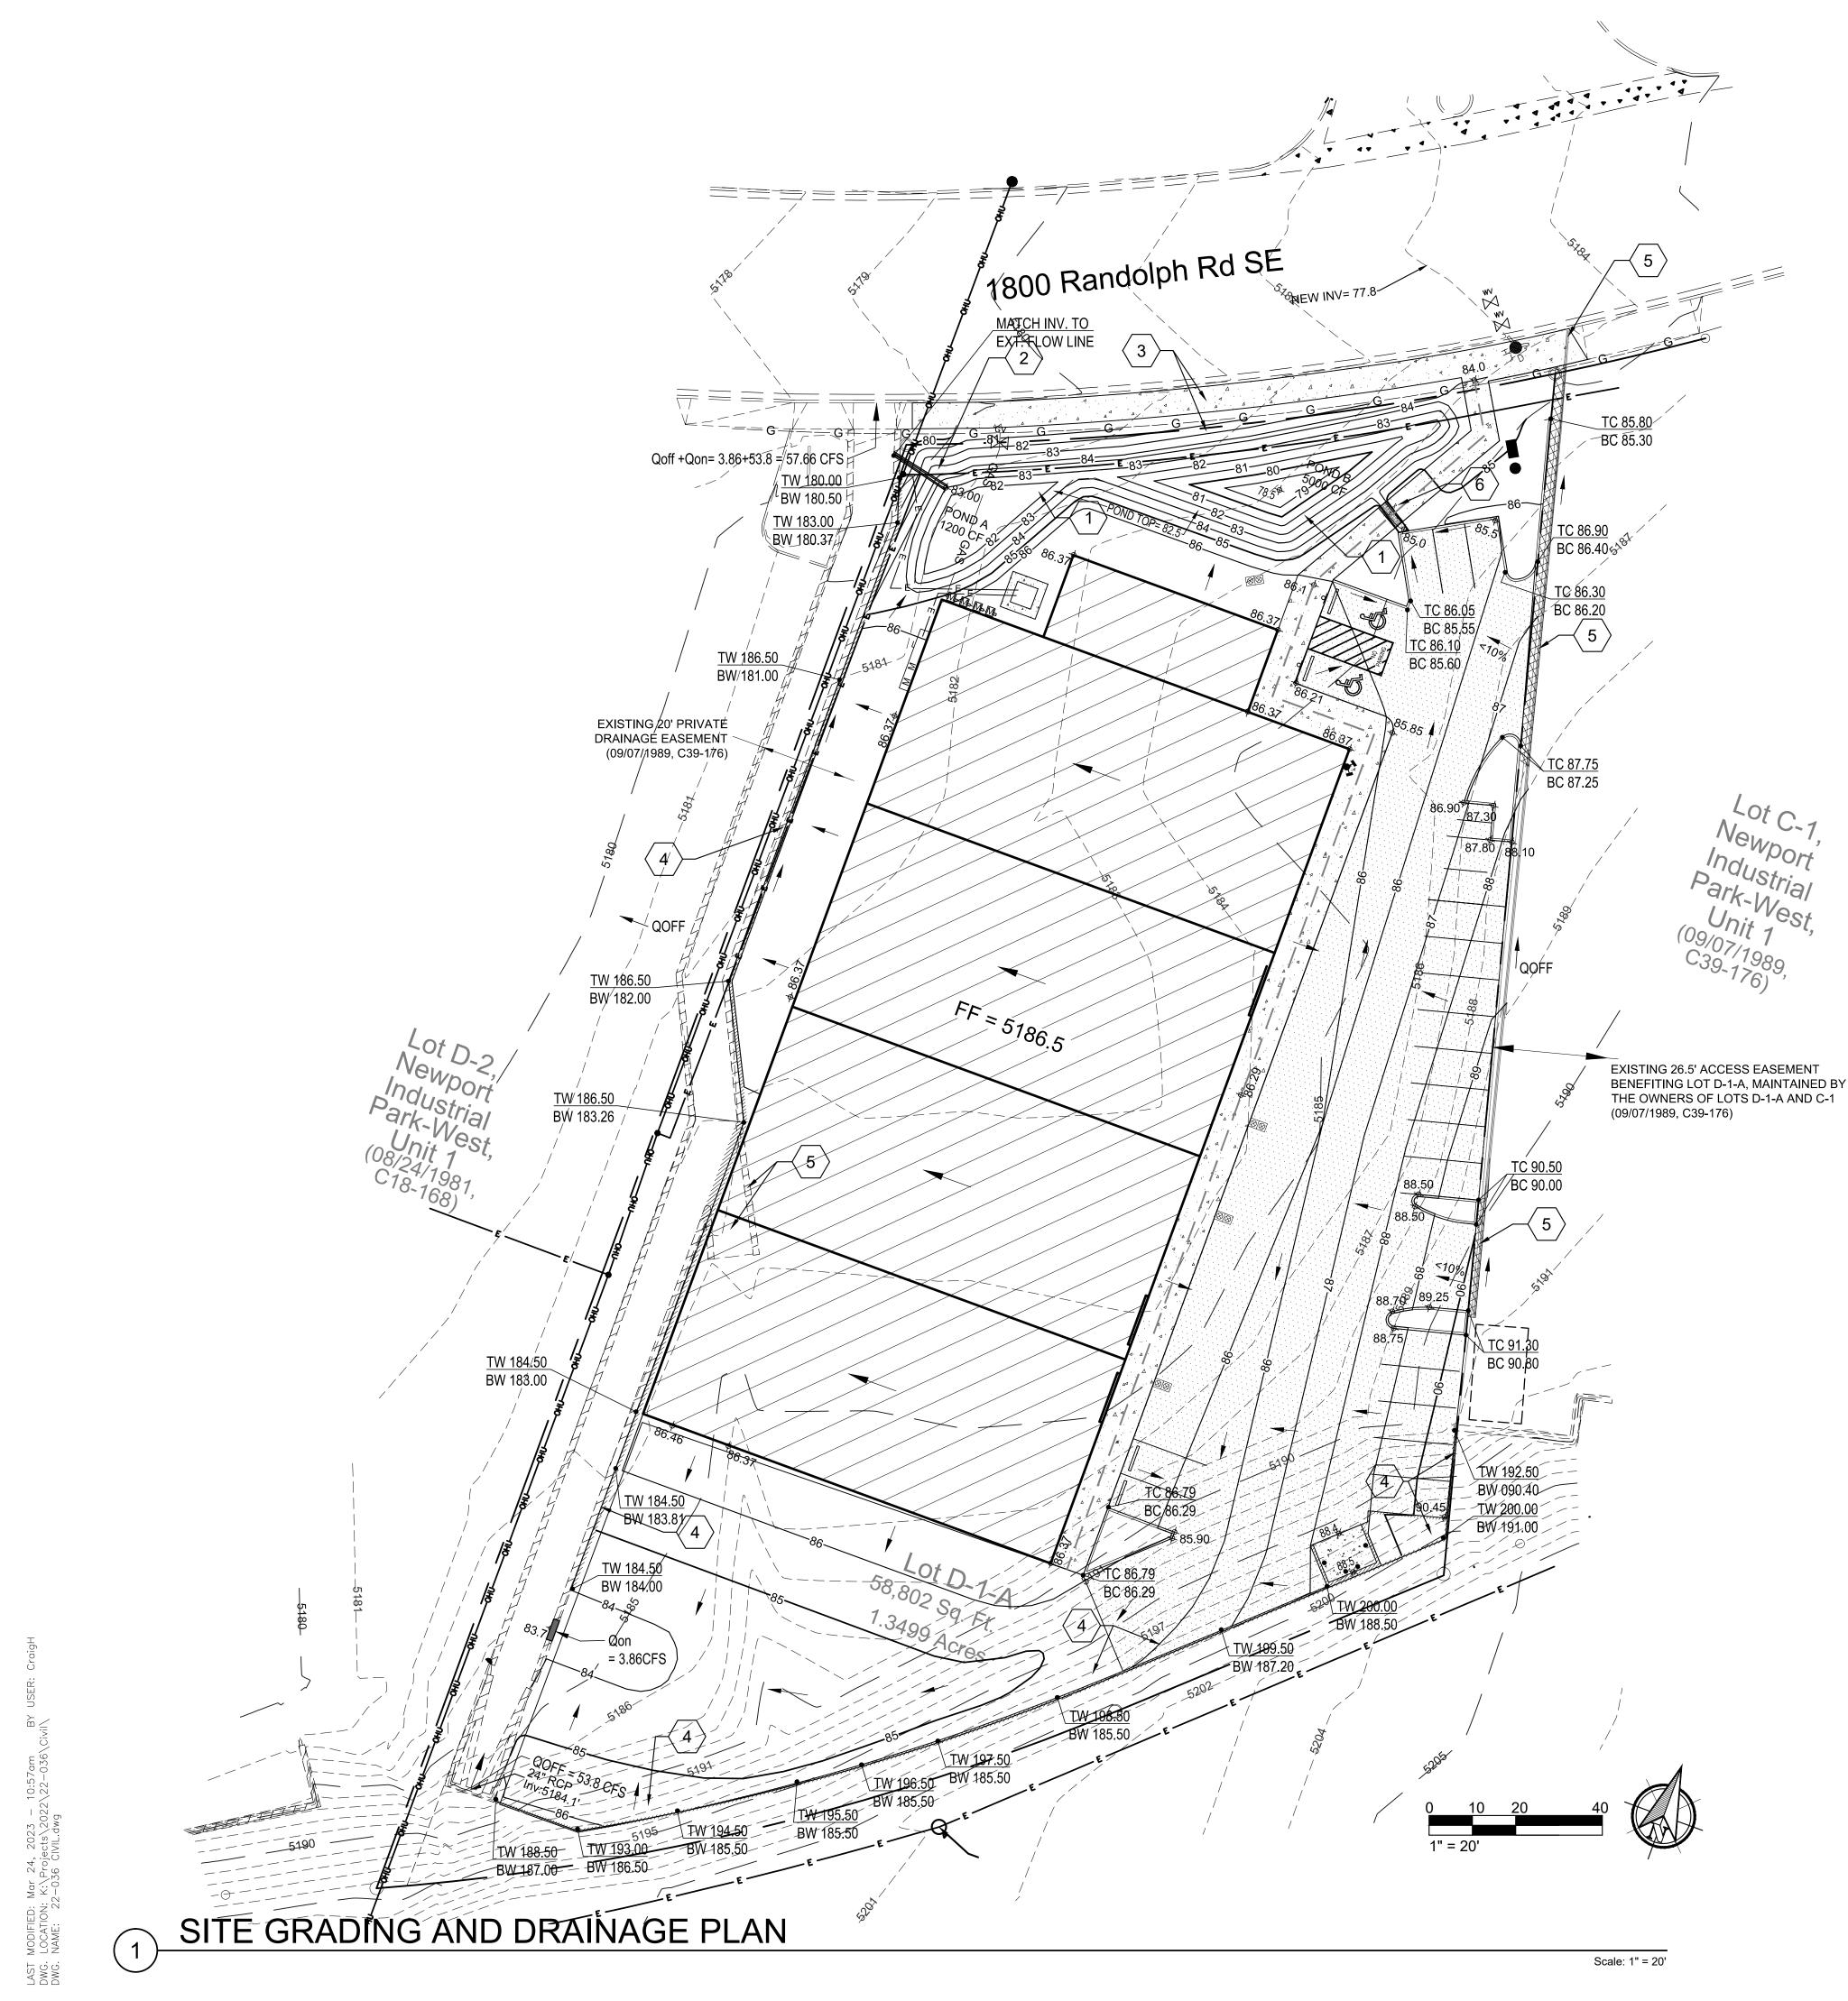

### DPM - Volume 2, Section 22.2.Hydrology Precipitation Zone 100 Year Storm Depth, P (360) reatment Area Excess Precipitation Factors Peak Discharge Factors and Treatment Area Type "A" (Native Grass, weeds and Type "B" (Native Grass,>20% Slope Type "C" (Desert Landscaping, rock Type "D" (Impervious, Roof, Pavem otal (Acres) Excess Precipitation(in) Volume (100), cf Volume (10),cf Q (100), cfs Q (10), cfs

Hydrology Calculations

P (360) Ponding Volume ,cf = V(10

### DRAINAGE NARRATIVE

THIS SITE IS LOCATED AT 1800 RANDOLPH RD SE, IN ALBUQUERQUE, BERNALILLO COUNTY, NEW MEXICO. THIS SITE IS LOCATED ON THE NATIONAL FLOOD INSURANCE RATE MAP NO. 35001C0342G EFFECTIVE ON 09/26/2008, AND LIES WITHIN ZONE X, WITH NO PORTION OF THE SITE LOCATED WITHIN A 100 YEAR FLOOD PLAIN.

THE EXISTING SITE CONSISTED OF A VACANT LOT. THE EXISTING SITE SURFACE TREATMENT HAS HISTORICALLY BEEN COVERAGE TYPE "A" (NATIVE GRASS, WEEDS AND SHRUBS). THE EXISTING SITE RUNOFF SHEET FLOWS ACROSS THE PROPERTY FROM THE SOUTHEAST TO THE NORTHWEST. THE SITE CURRENTLY DIRECTS OFFSITE DRAINAGE ALONG THE SOUTH PROPERTY LINE NORTHWARD AND ULTIMATELY INTO RANDOLPH RD SE AND ASSOCIATED STORM DRAINS. THE EXISTING CONCRETE DRAINAGE STRUCTURE ALONG THE WEST PROPERTY LINE THAT DIRECTS OFF-SITE FLOW. THE EXISTING OFF-SITE FLOW HAS BEEN DETERMINED AS QOFF = 53.8 CFS AND THE OFF-SITE TRIBUTARY AREA FOR THE EXISTING DRAINAGE STRUCTURE IS SHOWN ON COA DOCUMENTS FOR PROJECT M15-6. THE NORTH, SOUTH AND EAST SITE DOES NOT ACCEPT OFF-SITE FLOW ONTO THE PROPERTY. THE DRAINAGE STRUCTURE ALSO ACCEPTS A PORTION OF THE SHEET FLOW FROM THE EXISTING SITE

THIS PROPOSED DEVELOPMENT INVOLVES THE ADDITION OF A NEW BUILDING AND PAVED PARKING AREA. THIS PROJECT DISTURBS APPROXIMATELY 1.215 ACRES OF A 1.3499 ACRE SITE. THE PROPOSED GRADING HONORS EXISTING OFFSITE DRAINAGE PATTERNS AND DIRECTS ALL OFFSITE RUNOFF AWAY FROM THE BUILDING. A NEW SHALLOW PONDING AREA (WATER QUALITY AND 100 YEAR STORM) WILL BE LOCATED NEAR AND ADJACENT TO RANDOLPH RD SE SIDEWALK. THE PONDING AREA WILL OVERFLOW TO THE EXISTING DRAINAGE STRUCTURE CURB FLOW LINE AND ULTIMATELY INTO RANDOLPH RD SE. THE SITE WILL HAVE THE DEVELOPED STORM WATER QUALITY RUNOFF WATER DRAIN DIRECTLY INTO THE PONDS, THE TOP OF WATER SURFACE IS SHOWN IN PLAN. THE TOP OF THE POND SURFACE IS BORDERED AND CONTAINED BY A EARTHEN BERM WITH A TOP ELEVATION THAT IS HIGHER THAN THE ELEVATION OF THE ADJACENT SIDEWALK AND TOP OF POND. (SEE PLAN SHEET C1.1 AND CALCULATIONS BELOW) FINISHED FLOOR ELEVATION OF THE PROPOSED BUILDING IS THE HIGH POINT OF THE SURROUNDING PARKING AREA AND THE BUILDING HAS POSITIVE DRAINAGE AWAY FROM THE PERIMETER. DEVELOPED ONSITE RUNOFF SHEET FLOWS ACROSS THE PROPOSED ASPHALT PARKING AREA AND IS DIRECTED BY DRAINAGE STRUCTURES AND CURBS INTO TO THE ON-SITE STORM WATER QUALITY POND AND SITE POND. THE HIGHER PORTION OF THE EAST SIDE OF THE PROPERTY WILL CONTINUE TO NOT ACCEPT OFF-SITE FLOW FROM ADJACENT PROPERTY BY THE USE OF CURBS AND ASPHALT WATER BREAKS.

# ONSITE STORM WATER QUALITY PONDING VOLUME

CURB CUT WEIR CAPACITIES

# $Q = C L H^{3/2} = 2.75 X 5 X 0.5^{3/2} = 4.86 CFS > Q(10) = 3.86 CFS$

# **KEYED NOTES**

### LEGEND

	EX
6509	ΕX
10	N
09	N
	N
<del></del>	N
	N
	ΕX
Qoff = XX.X	0
Qon = XX.X	0

	2	1		
	2.35			
	A	В	с	D
	0.53	0.78	1.13	2.12
	1.56	2.28	3.14	4.70
þ.	Acres	Existing	Allowable	Proposed
Is	hrubs)	1.215		0.000
e)		0.135		0.135
k/	olastic)	0.000		0.169
ne	nt)	0.000		1.046
		1.3499	<u></u>	1.3499
		0.56		1.86
		2720		9124
		1822		6113
		2.20		5.75
		1.48		3.86
0)	proposed-	/(10)Allowable	ŧ	4291
2	ΑΤΙΛ	/F		

### STORM WATER QUALITY STORAGE REQUIRED BY COA HYDROLOGY:

PROVIDE STORAGE FOR STORM WATER QUALITY PER SECTION 6 - 12 OF DPM USE 0.26 IN

STORM WATER QUALITY (IN) APPLIED OVER IMPERVIOUS AREAS (ACRES) VOLUME DRAINING DIRECTLY INTO PONDING AREAS THEREFORE (0.26 / 12) X 1.181 X 43560 = 1115CF

### PIPE DRAIN CAPACITIES AT CURB CUT

SEE KEYED NOTE 2 AND PLAN FOR LOCATIONS OF TWO 4" PVC PIPES AT EXISTING DRAINAGE STRUCTURE BACK OF CURB FLOW LINE Q = (1.486AR<sup>2</sup>/3xS<sup>0.5</sup>)/N = ((1.486 X 0.0873 X 0.0833)<sup>2</sup>/3 X 0.02<sup>0.5</sup>)/0.0090 = 0.7668 CFS / 4" PIPE

CURB DRAIN IS 2~4"Ø PIPES -> Q=1.54CFS = 92.4CFM = 5544CFH

TIME TO DRAIN EQUIVALENT WATER QUALITY VOLUME = 5544CFH/1115CF = 5 HOURS

SEE PLAN FOR LOCATION OF PROPOSED WEIR (5' WIDE X 0.5' DEEP ) AT EXISTING CONCRETE CHANNEL CURB.

1. CONSTRUCT PONDING AREA. SEE STORM WATER QUALITY CALCULATIONS THIS SHEET.

2. CONSTRUCT 2 - 4" PVC PIPE CURB DRAIN FOR OVERFLOW DRAINAGE. SEE CALCULATIONS & COA STD. DETAIL #2235

3. TOP OF WATER SURFACE OF THE STORM WATER QUALITY POND IS LOWER THAN THE TOP OF THE ADJACENT BERM LOCATED BETWEEN THE SIDEWALK AND THE POND.

4. CONSTRUCT SITE RETAINING WALLS SEE SHEET C1.1A FOR WALL INFORMATION AND SECTIONS.


5. DEMOLISH AND REMOVE EXISTING ASPHALT CURB. CONSTRUCT NEW ASPHALT TRANSITION BETWEEN THE NEW WORK AND EXISTING ASPHALT SURFACE IN A SMOOTH AND WORKMANLIKE MANNER. PER DETAIL 9/S5.1

6. CONSTRUCT SIDEWALK CULVERT FOR DRAINAGE PER COA DETAIL 2236.

XISTING INDEX CONTOUR EXISTING SANITARY SEWER MANHOLE EXISTING INTERIM CONTOUR NEW SANITARY SEWER MANHOLE NEW SANITARY SEWER CLEANOUTS NEW INDEX CONTOUR  $\otimes \otimes$ NEW INTERIM CONTOUR DIRECTION OF FLOW NEW WATER SURFACE EXISTING FIRE HYDRANT NEW SPOT ELEVATION (F.G. OR B.C.) **EXISTING GATE VALVE** NEW CONCRETE SIDEWALK EXISTING BUILDING EXISTING CONCRETE SIDEWALK **NEW BUILDING OFF-SITE FLOW** FINISH FLOOR ELEVATION FF ON-SITE FLOW C Engineering Civil Structural Mechanical Plumbing Electrical

8102 Menaul Blvd. NE, Suite D, Albuquerque, NM 87110

tele: 505.255.7802 Proj. No.: 22-036 www.abqeng.com

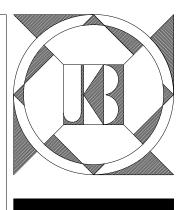








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DRAWN BY: JCH DATE: 03-23-23

C1.1

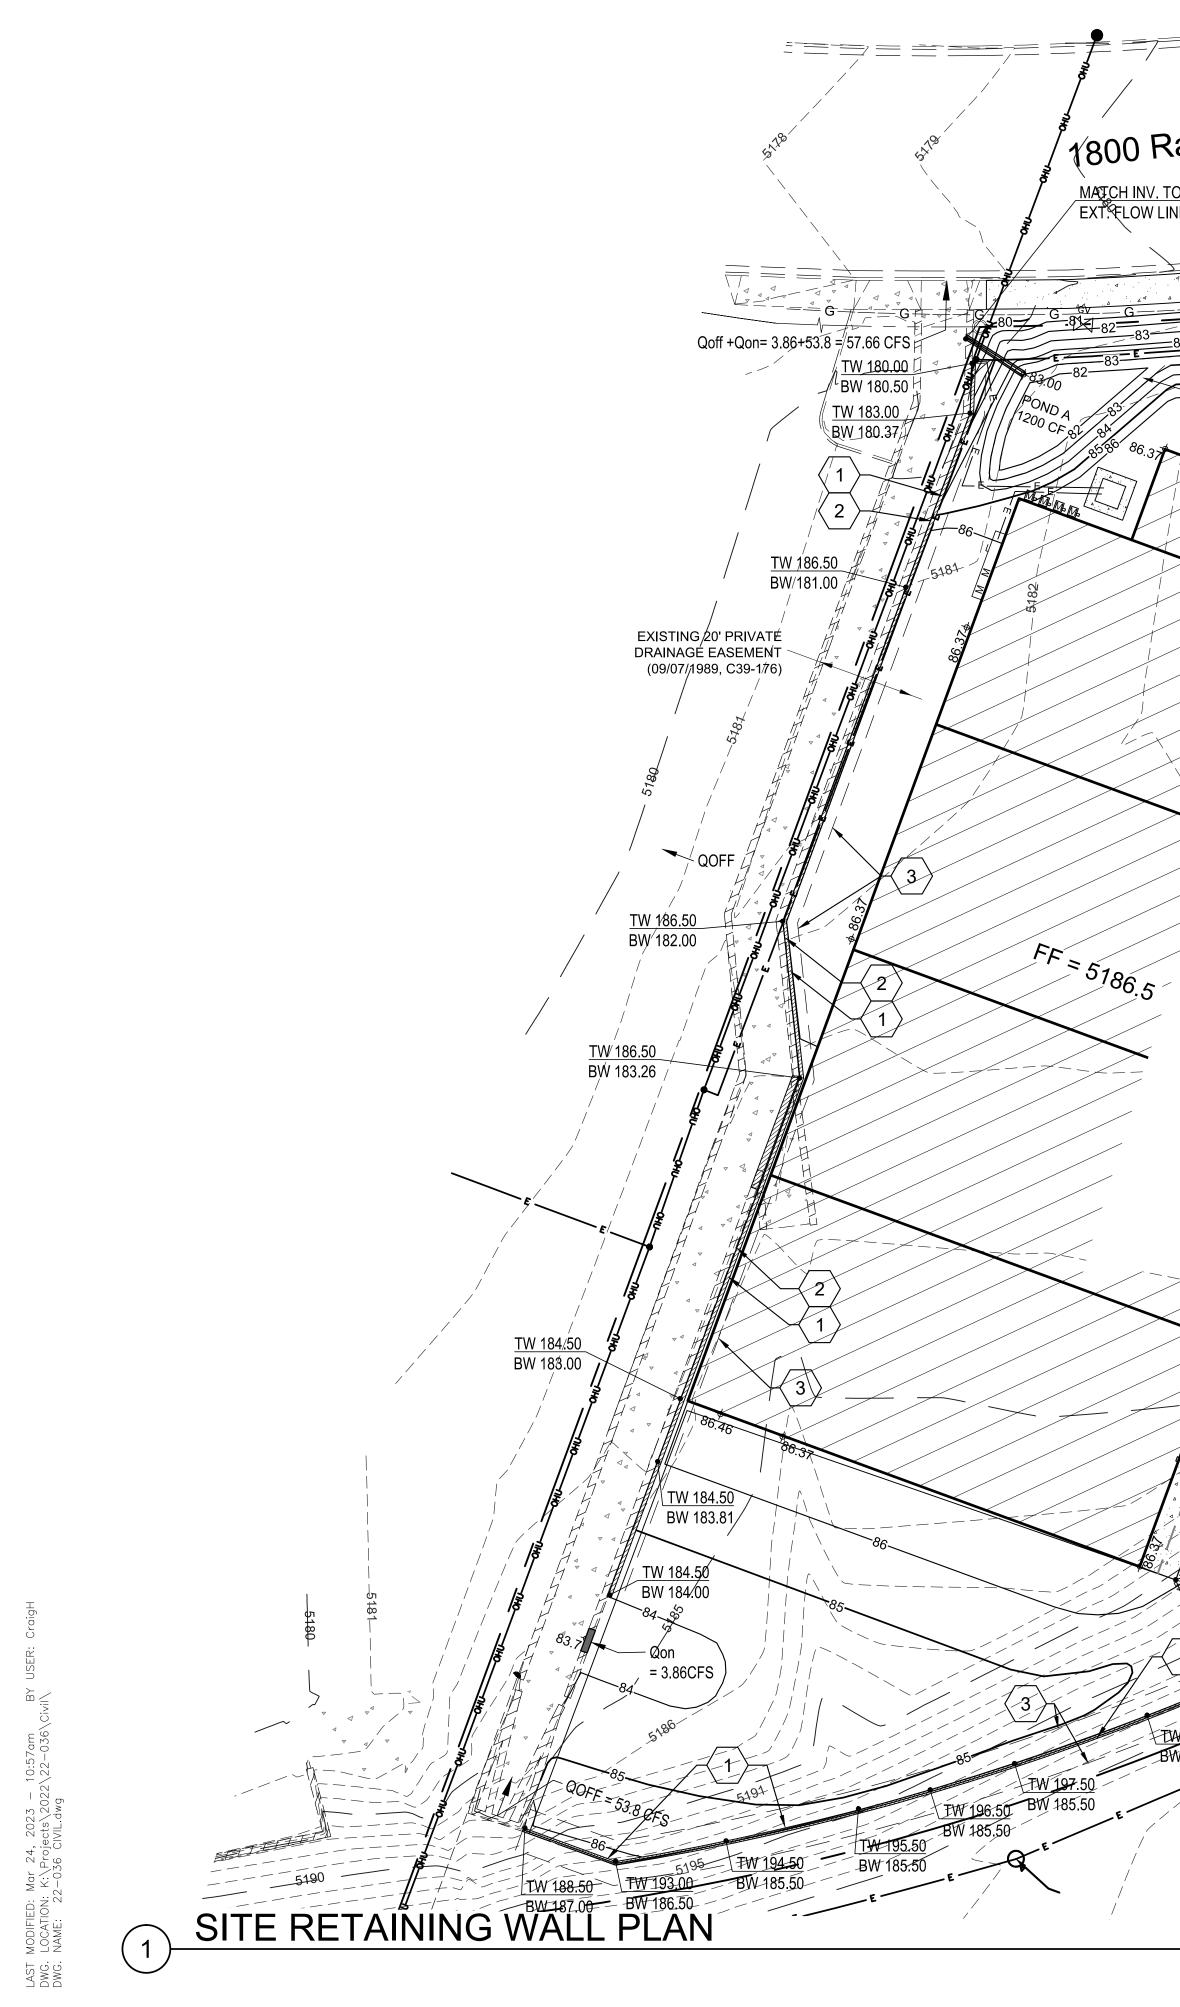


1800 Randolph Rd SE

BC/86 29

BC 86 29

MATCH INV. TO EXT. ELOW LINE

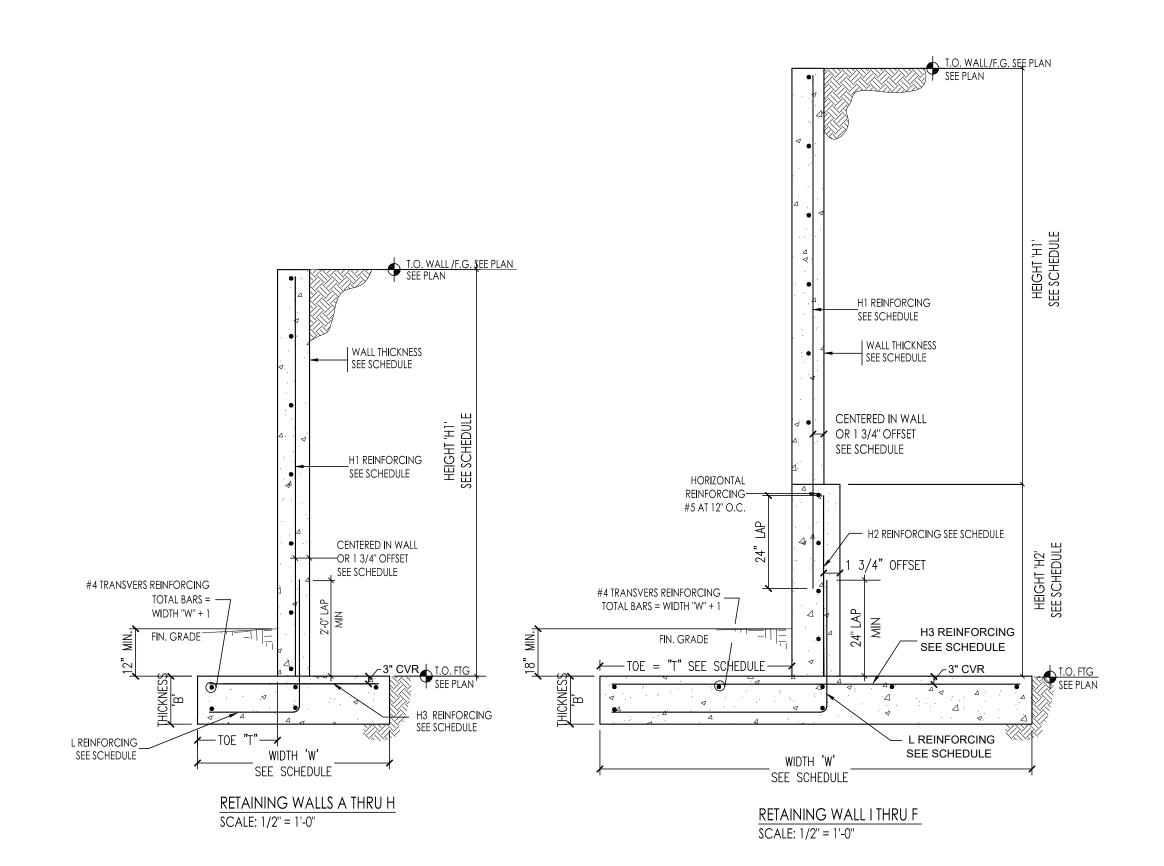

DETAIL	WALL HEIGHT F.G T.O.F		TOE	DE WALL THICKNESS		FOOTING WIDTH 'W'	FOOTING THICKNESS 'B'	H1 REINFORCING	H1 WALL	L	H2 REINFORCING	H3 REINFORCING	
	TOTAL	H1	H2	T	H1	H2							
A	3'-0''	3'-0''	-		8"	-	2'-0''	12"	#5 @ 18" O.C.	CENTER	#5 @ 18" O.C.	-	#5 @ 18" O.C.
В	4'-0''	4'-0''	-		8"	I	3'-0''	12"	#5 @ 18" O.C.	CENTER	#5 @ 18" O.C.	-	#5 @ 18" O.C.
С	5'-0''	5'-0''	-		8"	-	3'-6"	12"	#5 @ 18" O.C.	CENTER	#5 @ 18" O.C.	-	#5 @ 18" O.C.
D	6'-0''	6'-0''	-		8"	-	3'-6"	12"	#5 @ 18" O.C.	CENTER	#5 @ 18" O.C.	-	#5 @ 18'' O.C.
E	7'-0''	7'-0''	-		8"	-	4'-0''	12"	#5 @ 18 O.C.	CENTER	#5 @ 18 O.C.	-	#5 @ 18" O.C.
F	8'-0''	8'-0"	-		8"	I	4'-6''	12"	#5 @ 12" O.C.	CENTER	#5 @ 12" O.C.	-	#5 @ 18" O.C.
G	9'-0''	9'-0"	-		8"	-	5'-6''	14"	#5 @ 8" O.C.	CENTER	#5 @ 8" O.C.	-	#5 @ 18" O.C.
Н	10'-0''	10'-0"	-		8"	-	6'-9''	14"	#5 @ 8" O.C.	OFFSET	#5 @ 8" O.C.	-	#5 @ 12" O.C.
	12'-0"	9'-6"	2'-6"		8"	10"	8'-0''	14"	#5 @ 12" O.C.	OFFSET	#5 @ 8" O.C.	#5 @ 8" O.C.	#5 @ 12" O.C.
J	14'-0"	11-0"	3'-0"		8"	10"	9'-0''	16"	#5 @ 8" O.C.	OFFSET	#6 @ 6" O.C.	#6 @ 6" O.C.	#5 @ 6" O.C.

### CONCRETE RETAINING WALL DETAIL AND SCHEDULE Scale: N.T.S.




2. RETAINING WALL FOOTING IN THIS AREA TO HAVE A TOE LENGTH OF 0'-0". THE FACE OF WALL AND FOOTING WILL ALIGN WITH EDGE OF CONCRETE DRAINAGE STRUCTURE.

WIDTHS.


# LEGEND

	 -651
	 650
	—10-
	-09-

**⊕22** 

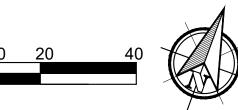



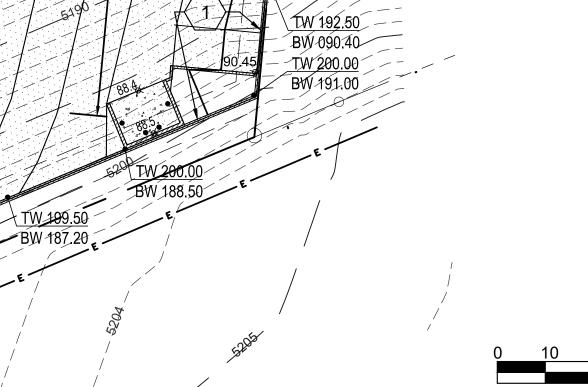

BC 90.8




1. CONSTRUCT SITE RETAINING WALLS PER RETAINING WALL SCHEDULE THIS SHEET

3. APPROXIMATE WIDTH OF FOOTING BELOW GRADE. SEE SCHEDULE FOR REQUIRED MIN. FOOTING

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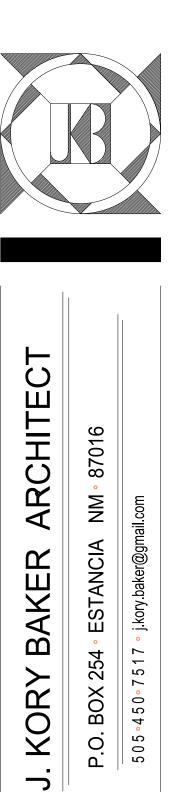
EXISTING INDEX CONTOUR
EXISTING INTERIM CONTOUR
NEW INDEX CONTOUR
NEW INTERIM CONTOUR
NEW WATER SURFACE
NEW SPOT ELEVATION
NEW CONCRETE SIDEWALK
EXISTING CONCRETE SIDEWALK
EXISTING SANITARY SEWER MANHOLE
NEW SANITARY SEWER MANHOLE
NEW SANITARY SEWER CLEANOUTS
Щ

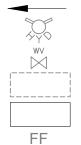

DIRECTION OF FLOW EXISTING FIRE HYDRANT EXISTING GATE VALVE EXISTING BUILDING NEW BUILDING FINISH FLOOR ELEVATION

**ABQ** Engineering

Civil • Structural • Mechanical • Plumbing • Electrical 8102 Menaul Blvd. NE, Suite D, Albuquerque, NM 87110 tele: 505.255.7802 Proj. No.: 22-036 www.abqeng.com








PLAN

WALL

DRAWN BY: JCH DATE: 03-23-23  $| \land$ 

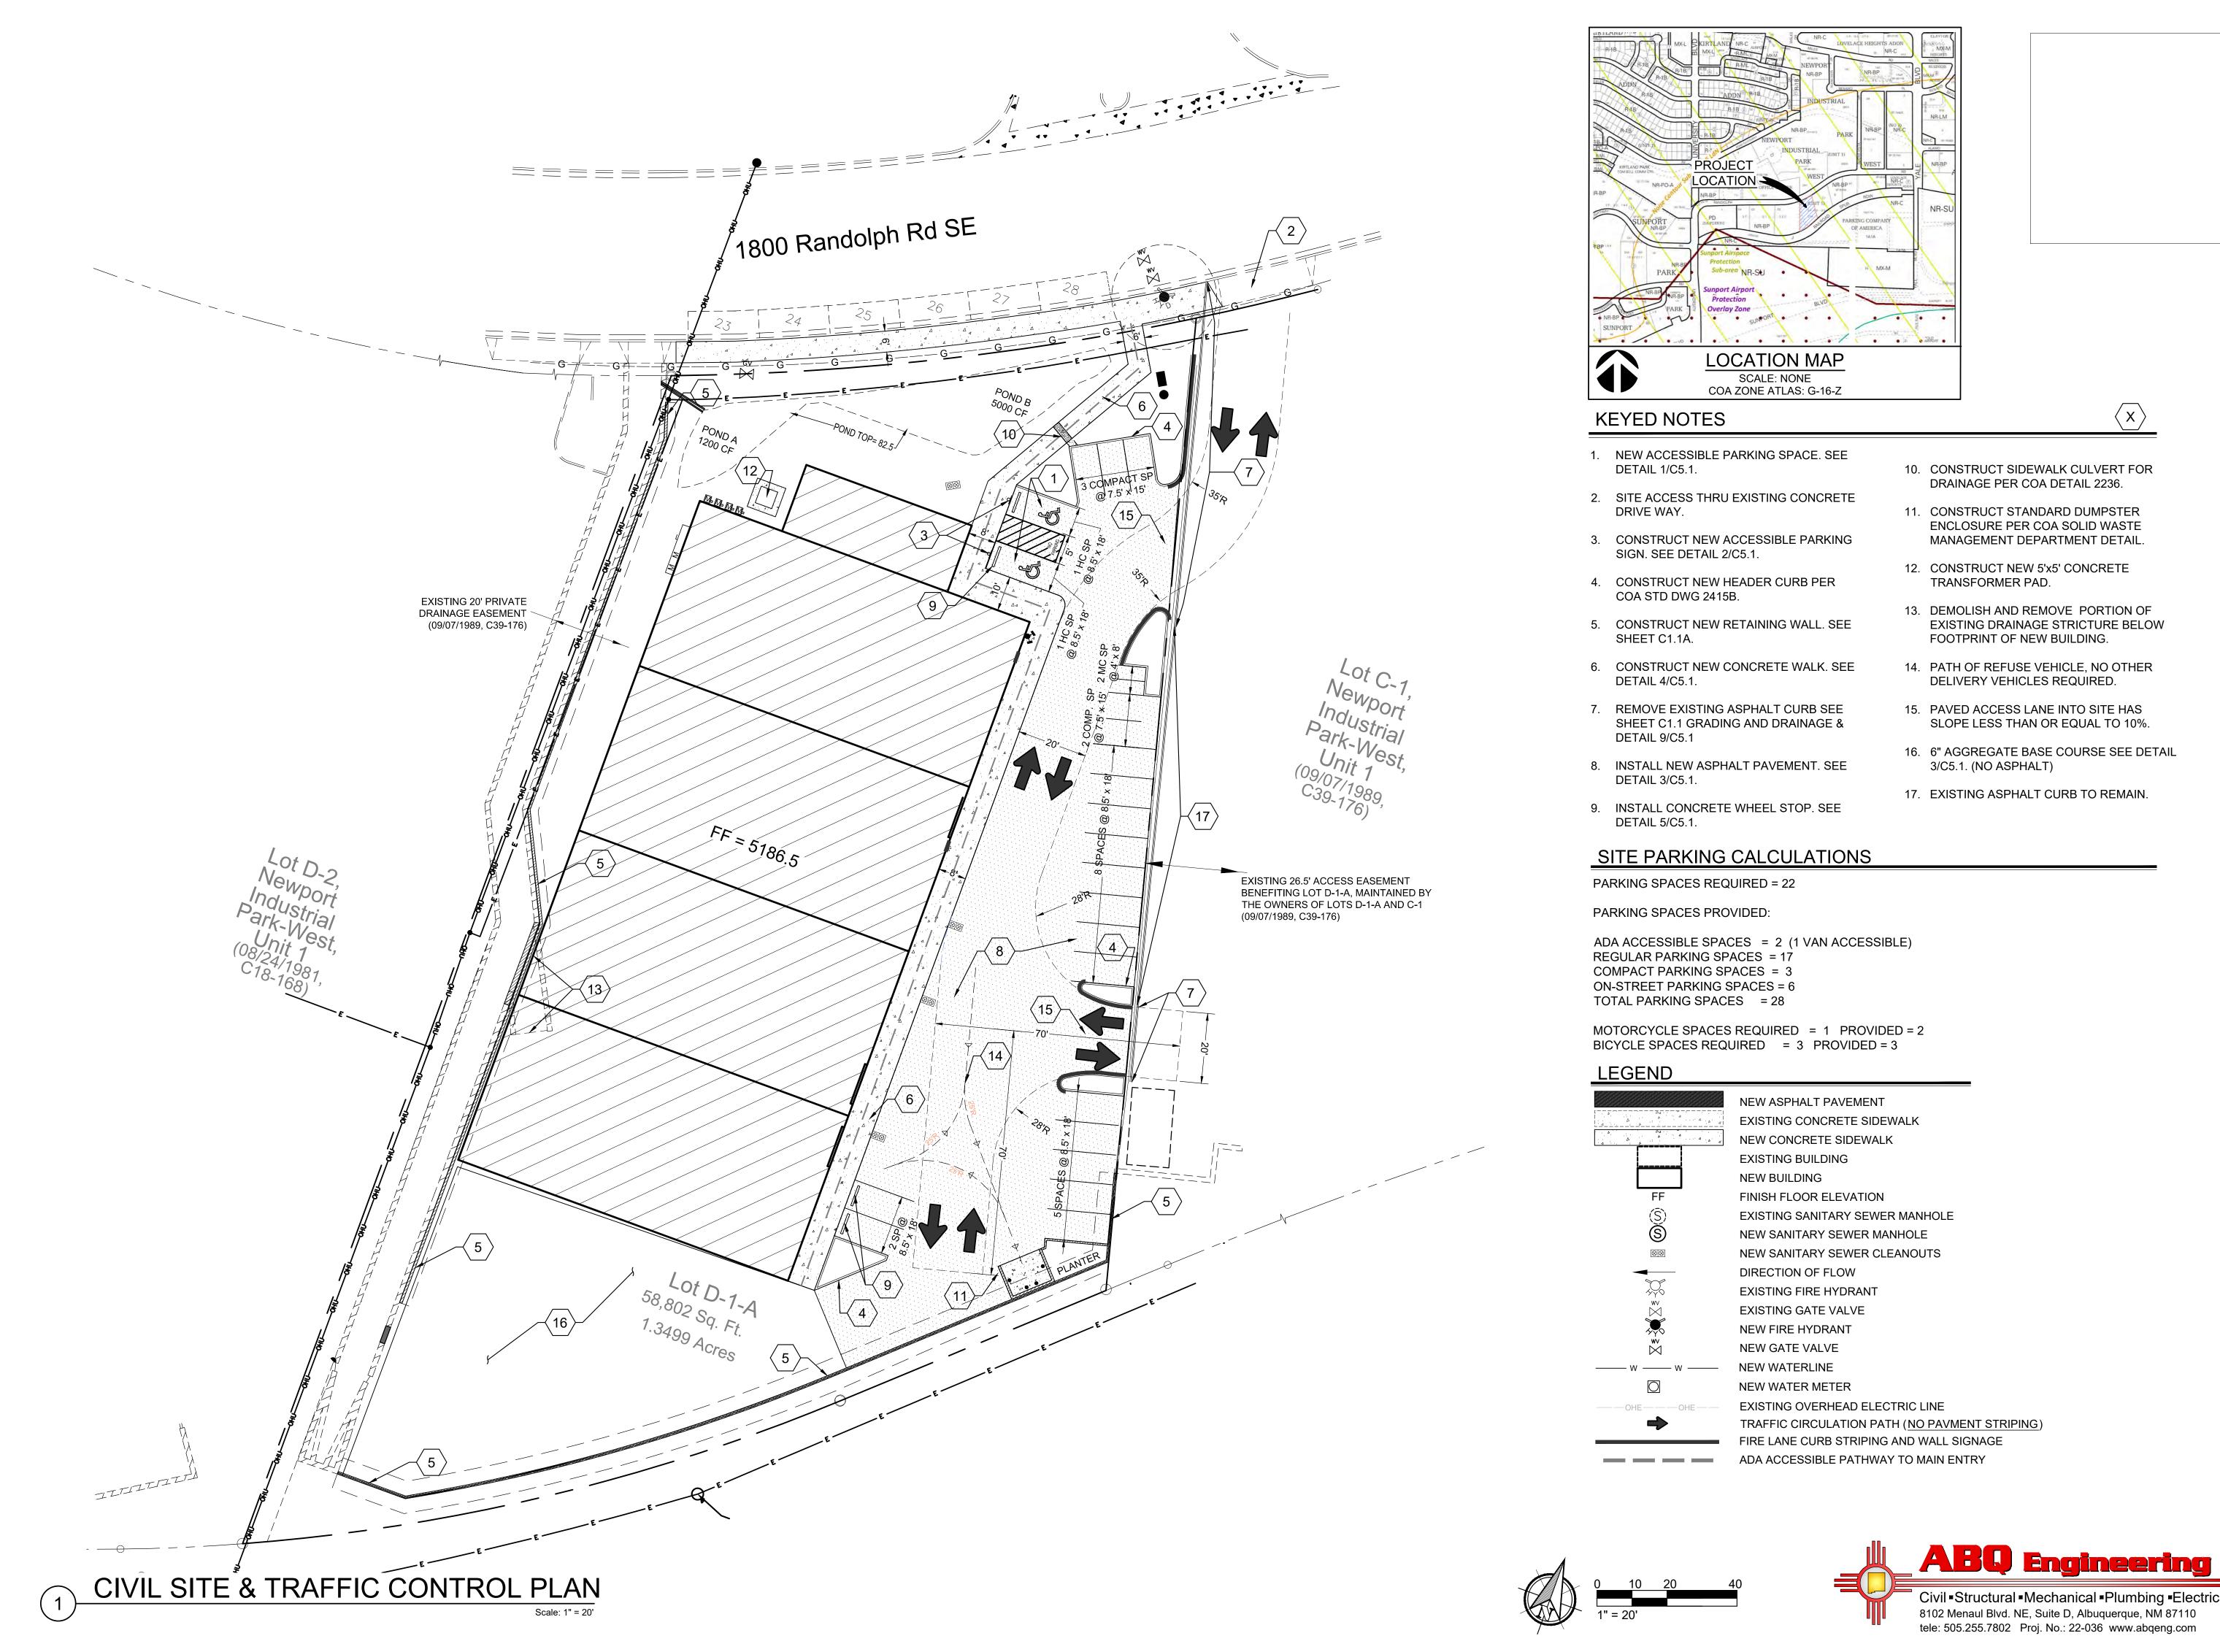


LAST DWG. DWG.

TRAFFIC CIRCULATION PATH (NO PAVMENT STRIPING) FIRE LANE CURB STRIPING AND WALL SIGNAGE

- ADA ACCESSIBLE PATHWAY TO MAIN ENTRY

- 10. CONSTRUCT SIDEWALK CULVERT FOR DRAINAGE PER COA DETAIL 2236.
- 11. CONSTRUCT STANDARD DUMPSTER ENCLOSURE PER COA SOLID WASTE MANAGEMENT DEPARTMENT DETAIL.
- 12. CONSTRUCT NEW 5'x5' CONCRETE TRANSFORMER PAD.
- 13. DEMOLISH AND REMOVE PORTION OF EXISTING DRAINAGE STRICTURE BELOW FOOTPRINT OF NEW BUILDING.
- 14. PATH OF REFUSE VEHICLE, NO OTHER DELIVERY VEHICLES REQUIRED.
- 15. PAVED ACCESS LANE INTO SITE HAS SLOPE LESS THAN OR EQUAL TO 10%.
- 16. 6" AGGREGATE BASE COURSE SEE DETAIL 3/C5.1. (NO ASPHALT)
- 17. EXISTING ASPHALT CURB TO REMAIN.

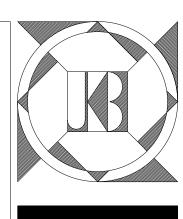





PLAN

CONTROL

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TRAFFIC

8

SITE

CIVIL


BUILDING WAGONER


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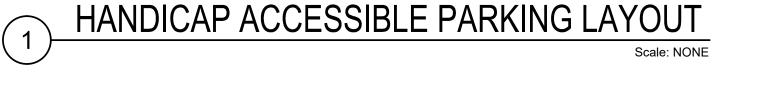
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C1.2







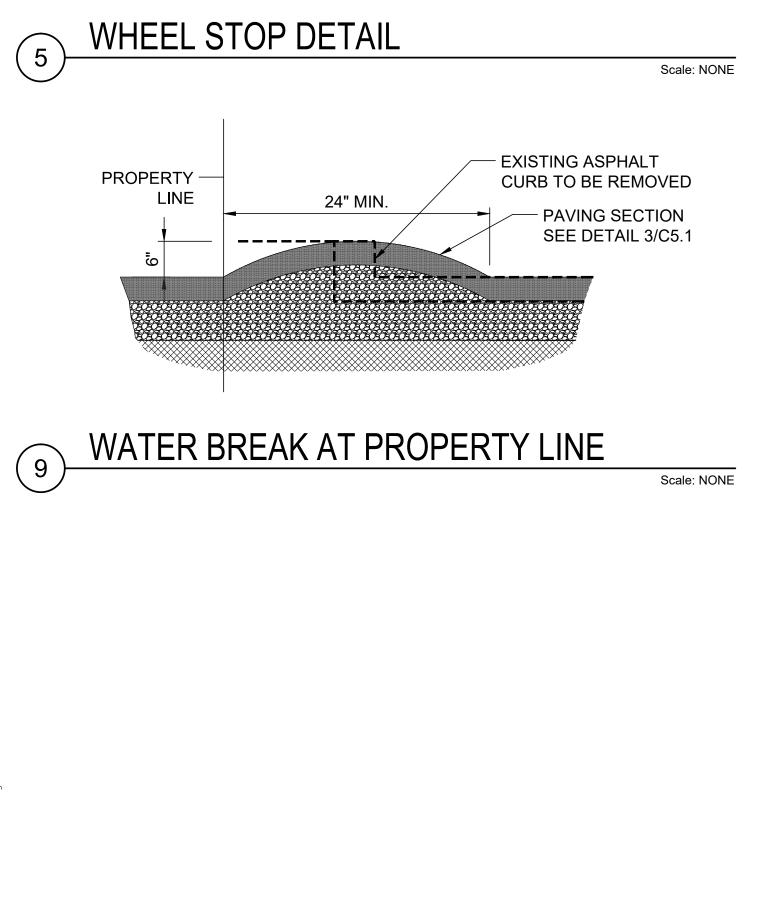

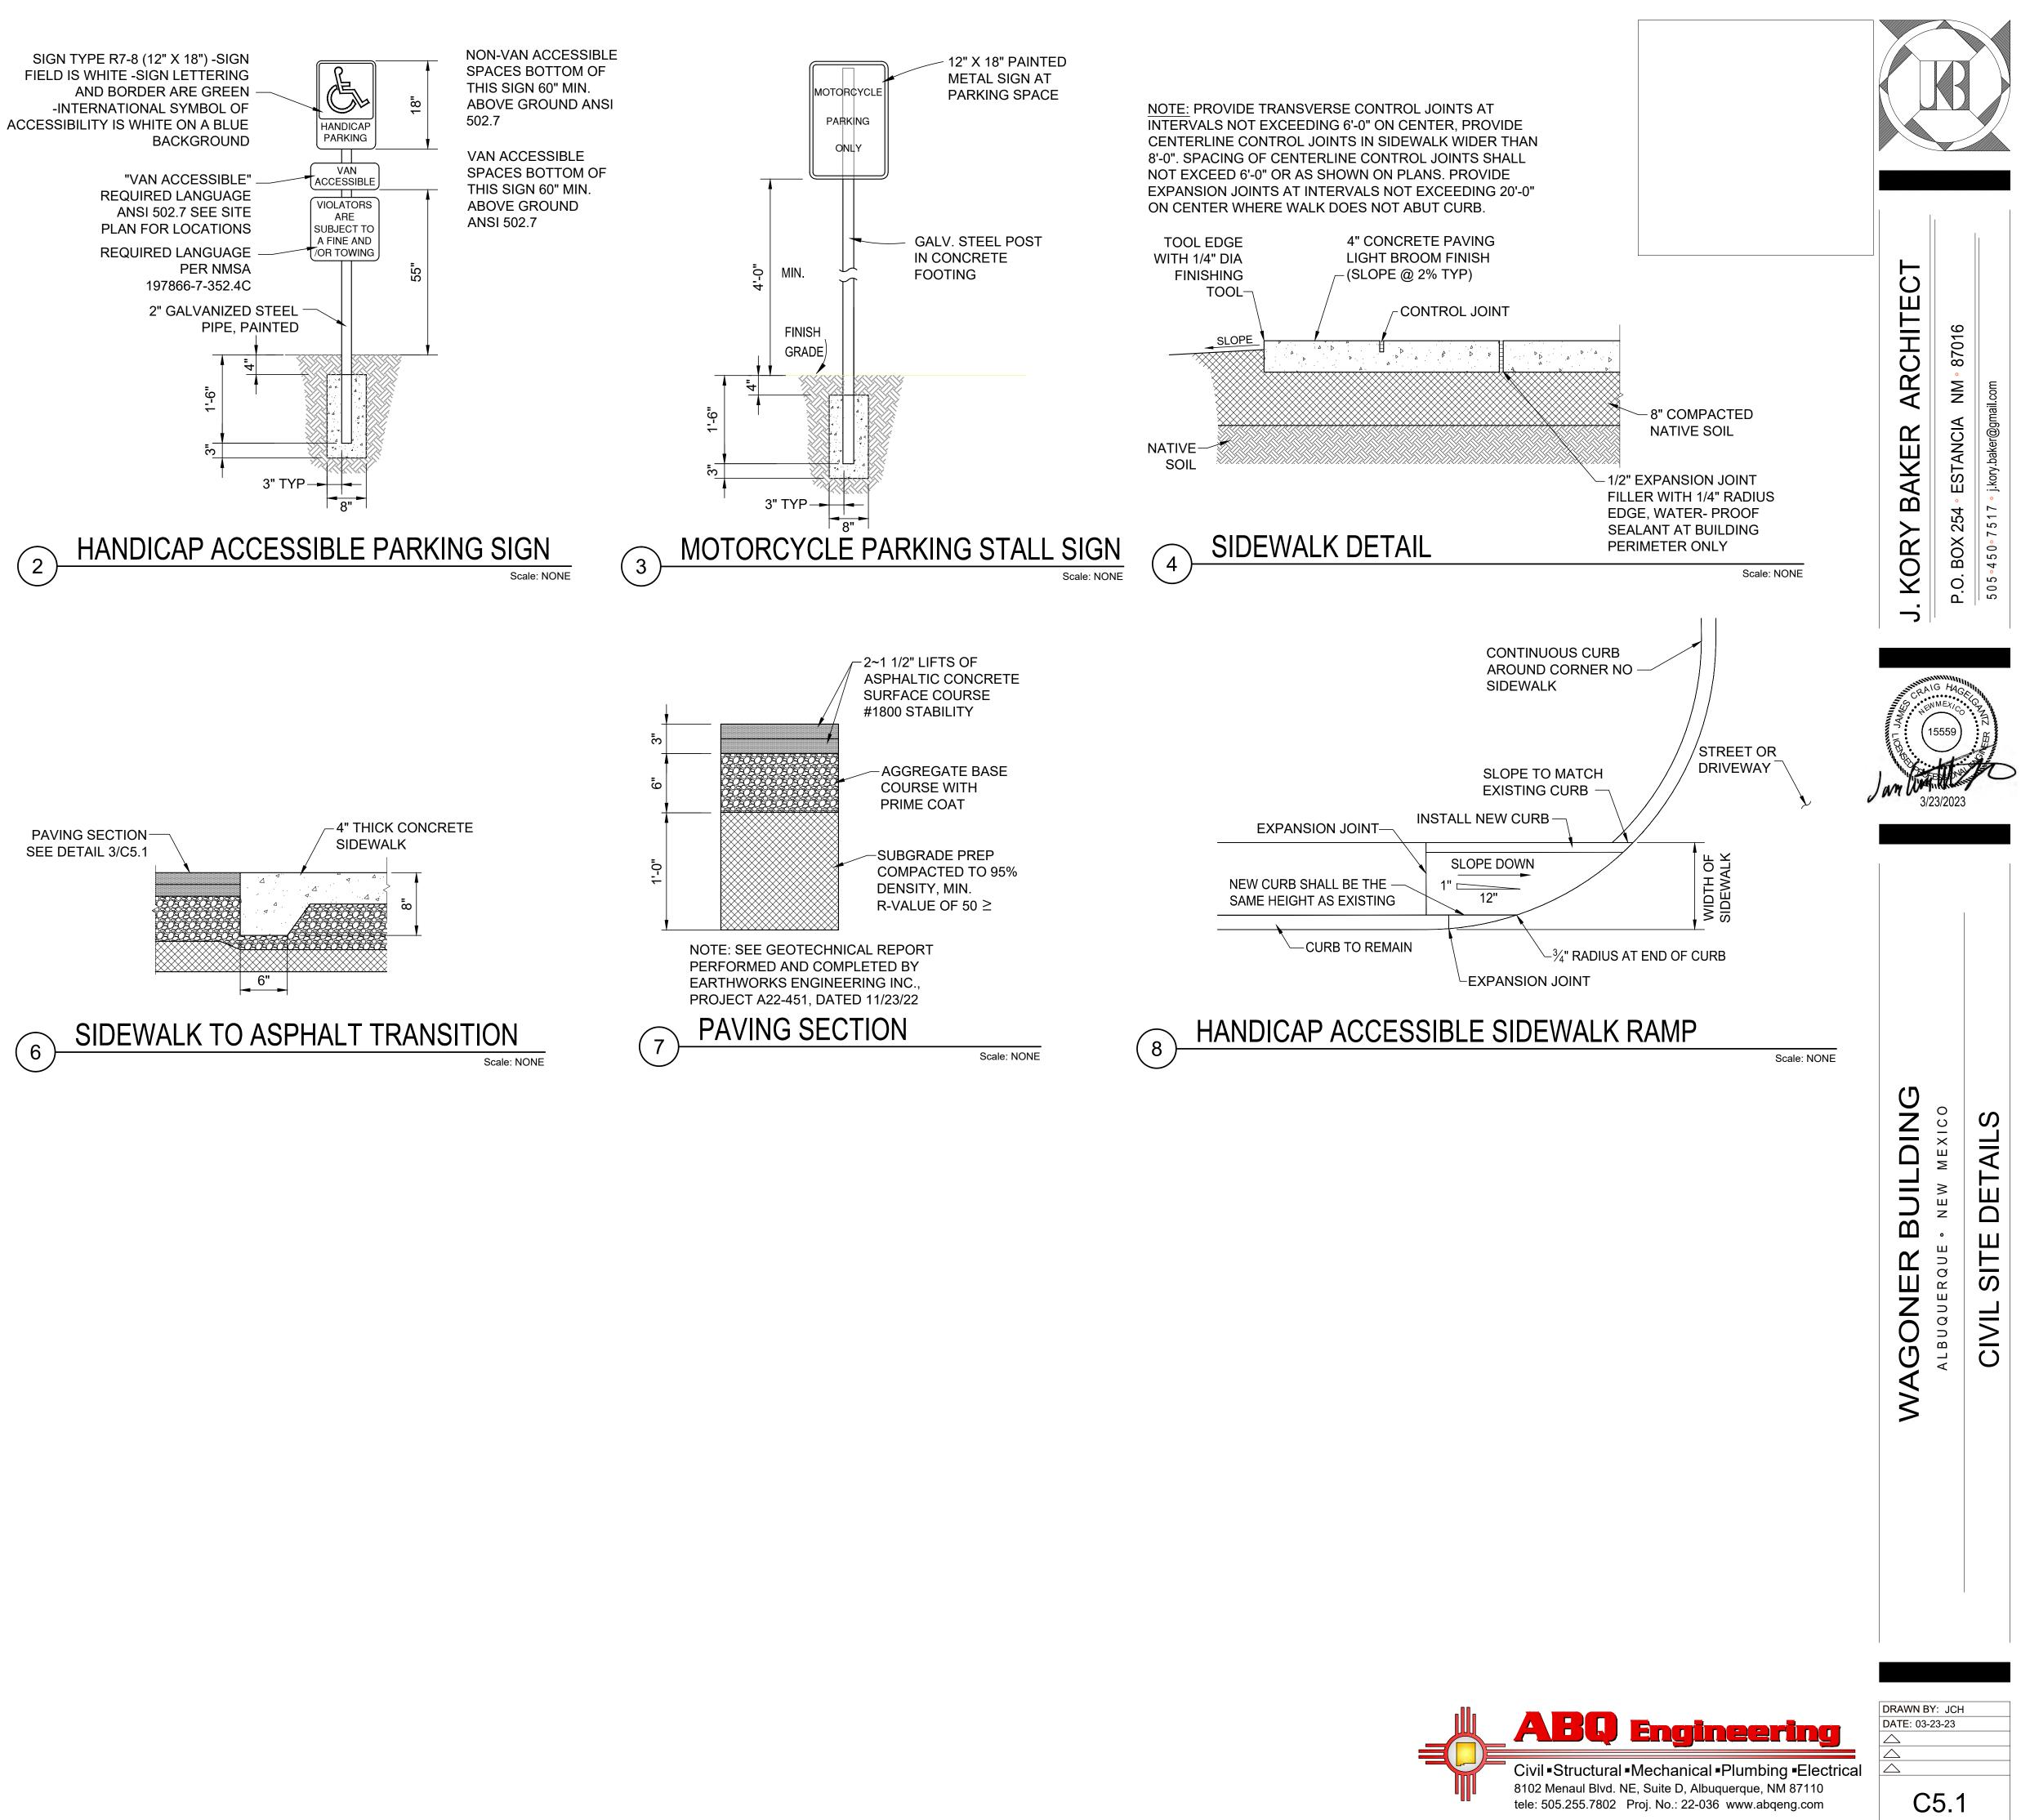6"x 6" PRECAST CONCRETE

BEVEL-

CORNERS

AS SHOWN

WHEEL STOP

-#5 REBAR DOWELED 2'-0" MINIMUM

THRU CONCRETE PAVING


-BEVEL CORNERS

AS SHOWN

- 3~#5 CONTINUOUS

HORIZONTALLY

<u>•</u>⊙∖

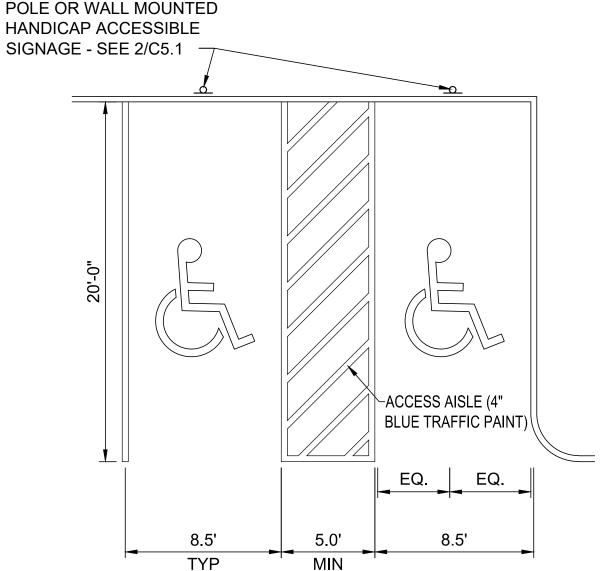

POLE OR WALL MOUNTED HANDICAP ACCESSIBLE