CITY OF ALBUQUERQUE

Planning Department Alan Varela, Director



Mayor Timothy M. Keller

September 13, 2022

Ronald Bohannan, PE Tierra West, LLC 5571 Midway Park Pl. NE Albuquerque, NM 87109

Re: Take 5 Oil Change

Unser Blvd. and Crown Rd.

Conceptual Traffic Circulation Layout for DRB Approval

Engineer's Stamp 07-12-22 (A11-D018)

Dear Mr. Bohannan,

The conceptual TCL submittal received 08-11-2022 is approved for DRB submittal. When submitting this project through the building permit process, please provide a copy of the approved DRB Site plan along with a more detailed site plan for construction purposes through a second Traffic Circulation Layout submittal process. The detailed plan will be compared against the approved DRB site plan to ensure that all previously approved site infrastructure is shown with exact paving layout, dimensioning, and parking capacity. Ultimately, a copy of the approved DRB Site Plan and the more detailed stamped and signed plan will both be needed for each of the building permit plans. Please keep these originals to be used for certification of the site for final C.O. for Transportation. A recorded/approved plat shall be provided for final DRB approval.

Albuquerque

PO Box 1293

NM 87103

www.cabq.gov

When the site construction is completed and an inspection for Certificate of Occupancy (C.O.) is requested, use the original City stamped approved TCL for certification. Redline any minor changes and adjustments that were made in the field. A NM registered architect or engineer must stamp, sign, and date the certification TCL along with indicating that the development was built in "substantial compliance" with the TCL. Submit this certification, the TCL, and a completed Drainage and Transportation Information Sheet to front counter personnel for log in and evaluation by Transportation.

Once verification of certification is completed and approved, notification will be made to Building Safety to issue Final C.O. To confirm that a final C.O. has been issued, call Building Safety at 924-3690.

Sincerely,

Ernest Armijo, P.E.

Principal Engineer, Planning Dept.

Development Review Services

C: CO Clerk, Fil




City of Albuquerque

Planning Department

Development & Building Services Division

DRAINAGE AND TRANSPORTATION INFORMATION SHEET (REV 6/2018)

Project Title: UNSER DRIVE-THRU OIL CHANGE	_ Building Perm	it #: Hydrology File #:
		Work Order#:
Legal Description: TR 4 PLAT OF TRS 1, 2	2, 3 & 4	UPC 101106638341510104
City Address: Unser Blvd NW Albuquerque,	NM 87114	
Applicant: TIERRA WEST, LLC		Contact: Luis Noriega
Address: 5571 MIDWAY PARK PLACE NE,		
Phone#: 505-858-3100	_ Fax#:	E-mail: LNORIEGA@TIERRAWESTLLC
Other Contact:		Contact:
Address:		
Phone#:	_ Fax#:	E-mail:
TYPE OF DEVELOPMENT:PLAT	(# of lots)	RESIDENCE X DRB SITE ADMIN SITE
IS THIS A RESUBMITTAL? Yes	No	
DEPARTMENT X TRANSPORTATION	HYDR	OLOGY/DRAINAGE
Check all that Apply: TYPE OF SUBMITTAL:		TYPE OF APPROVAL/ACCEPTANCE SOUGHT: BUILDING PERMIT APPROVAL CERTIFICATE OF OCCUPANCY
ENGINEER/ARCHITECT CERTIFICATIO	N	CERTIFICATE OF OCCUPANCY
PAD CERTIFICATION		PRELIMINARY PLAT APPROVAL
CONCEPTUAL G & D PLAN		SITE PLAN FOR SUB'D APPROVAL
GRADING PLAN		SITE PLAN FOR BLDG. PERMIT APPROVAL
DRAINAGE REPORT		FINAL PLAT APPROVAL
DRAINAGE MASTER PLAN		
FLOODPLAIN DEVELOPMENT PERMIT	APPLIC	SIA/ RELEASE OF FINANCIAL GUARANTEE
ELEVATION CERTIFICATE		FOUNDATION PERMIT APPROVAL
CLOMR/LOMR TRAFFIC CIRCULATION LAVOUT (TCL	`	GRADING PERMIT APPROVAL
TRAFFIC CIRCULATION LAYOUT (TCL TRAFFIC IMPACT STUDY (TIS)	.)	SO-19 APPROVAL
STREET LIGHT LAYOUT		PAVING PERMIT APPROVAL
OTHER (SPECIFY)		GRADING/ PAD CERTIFICATION
PRE-DESIGN MEETING?	_	WORK ORDER APPROVAL
THE PESICIVILETING.		CLOMR/LOMR
		FLOODPLAIN DEVELOPMENT PERMIT
		OTHER (SPECIFY)
DATE SUBMITTED: <u>07.12.2022</u>	By: Luis No	priega
COA STAFF:	ELECTRONIC SU	JBMITTAL RECEIVED:
	FEE PAID:	

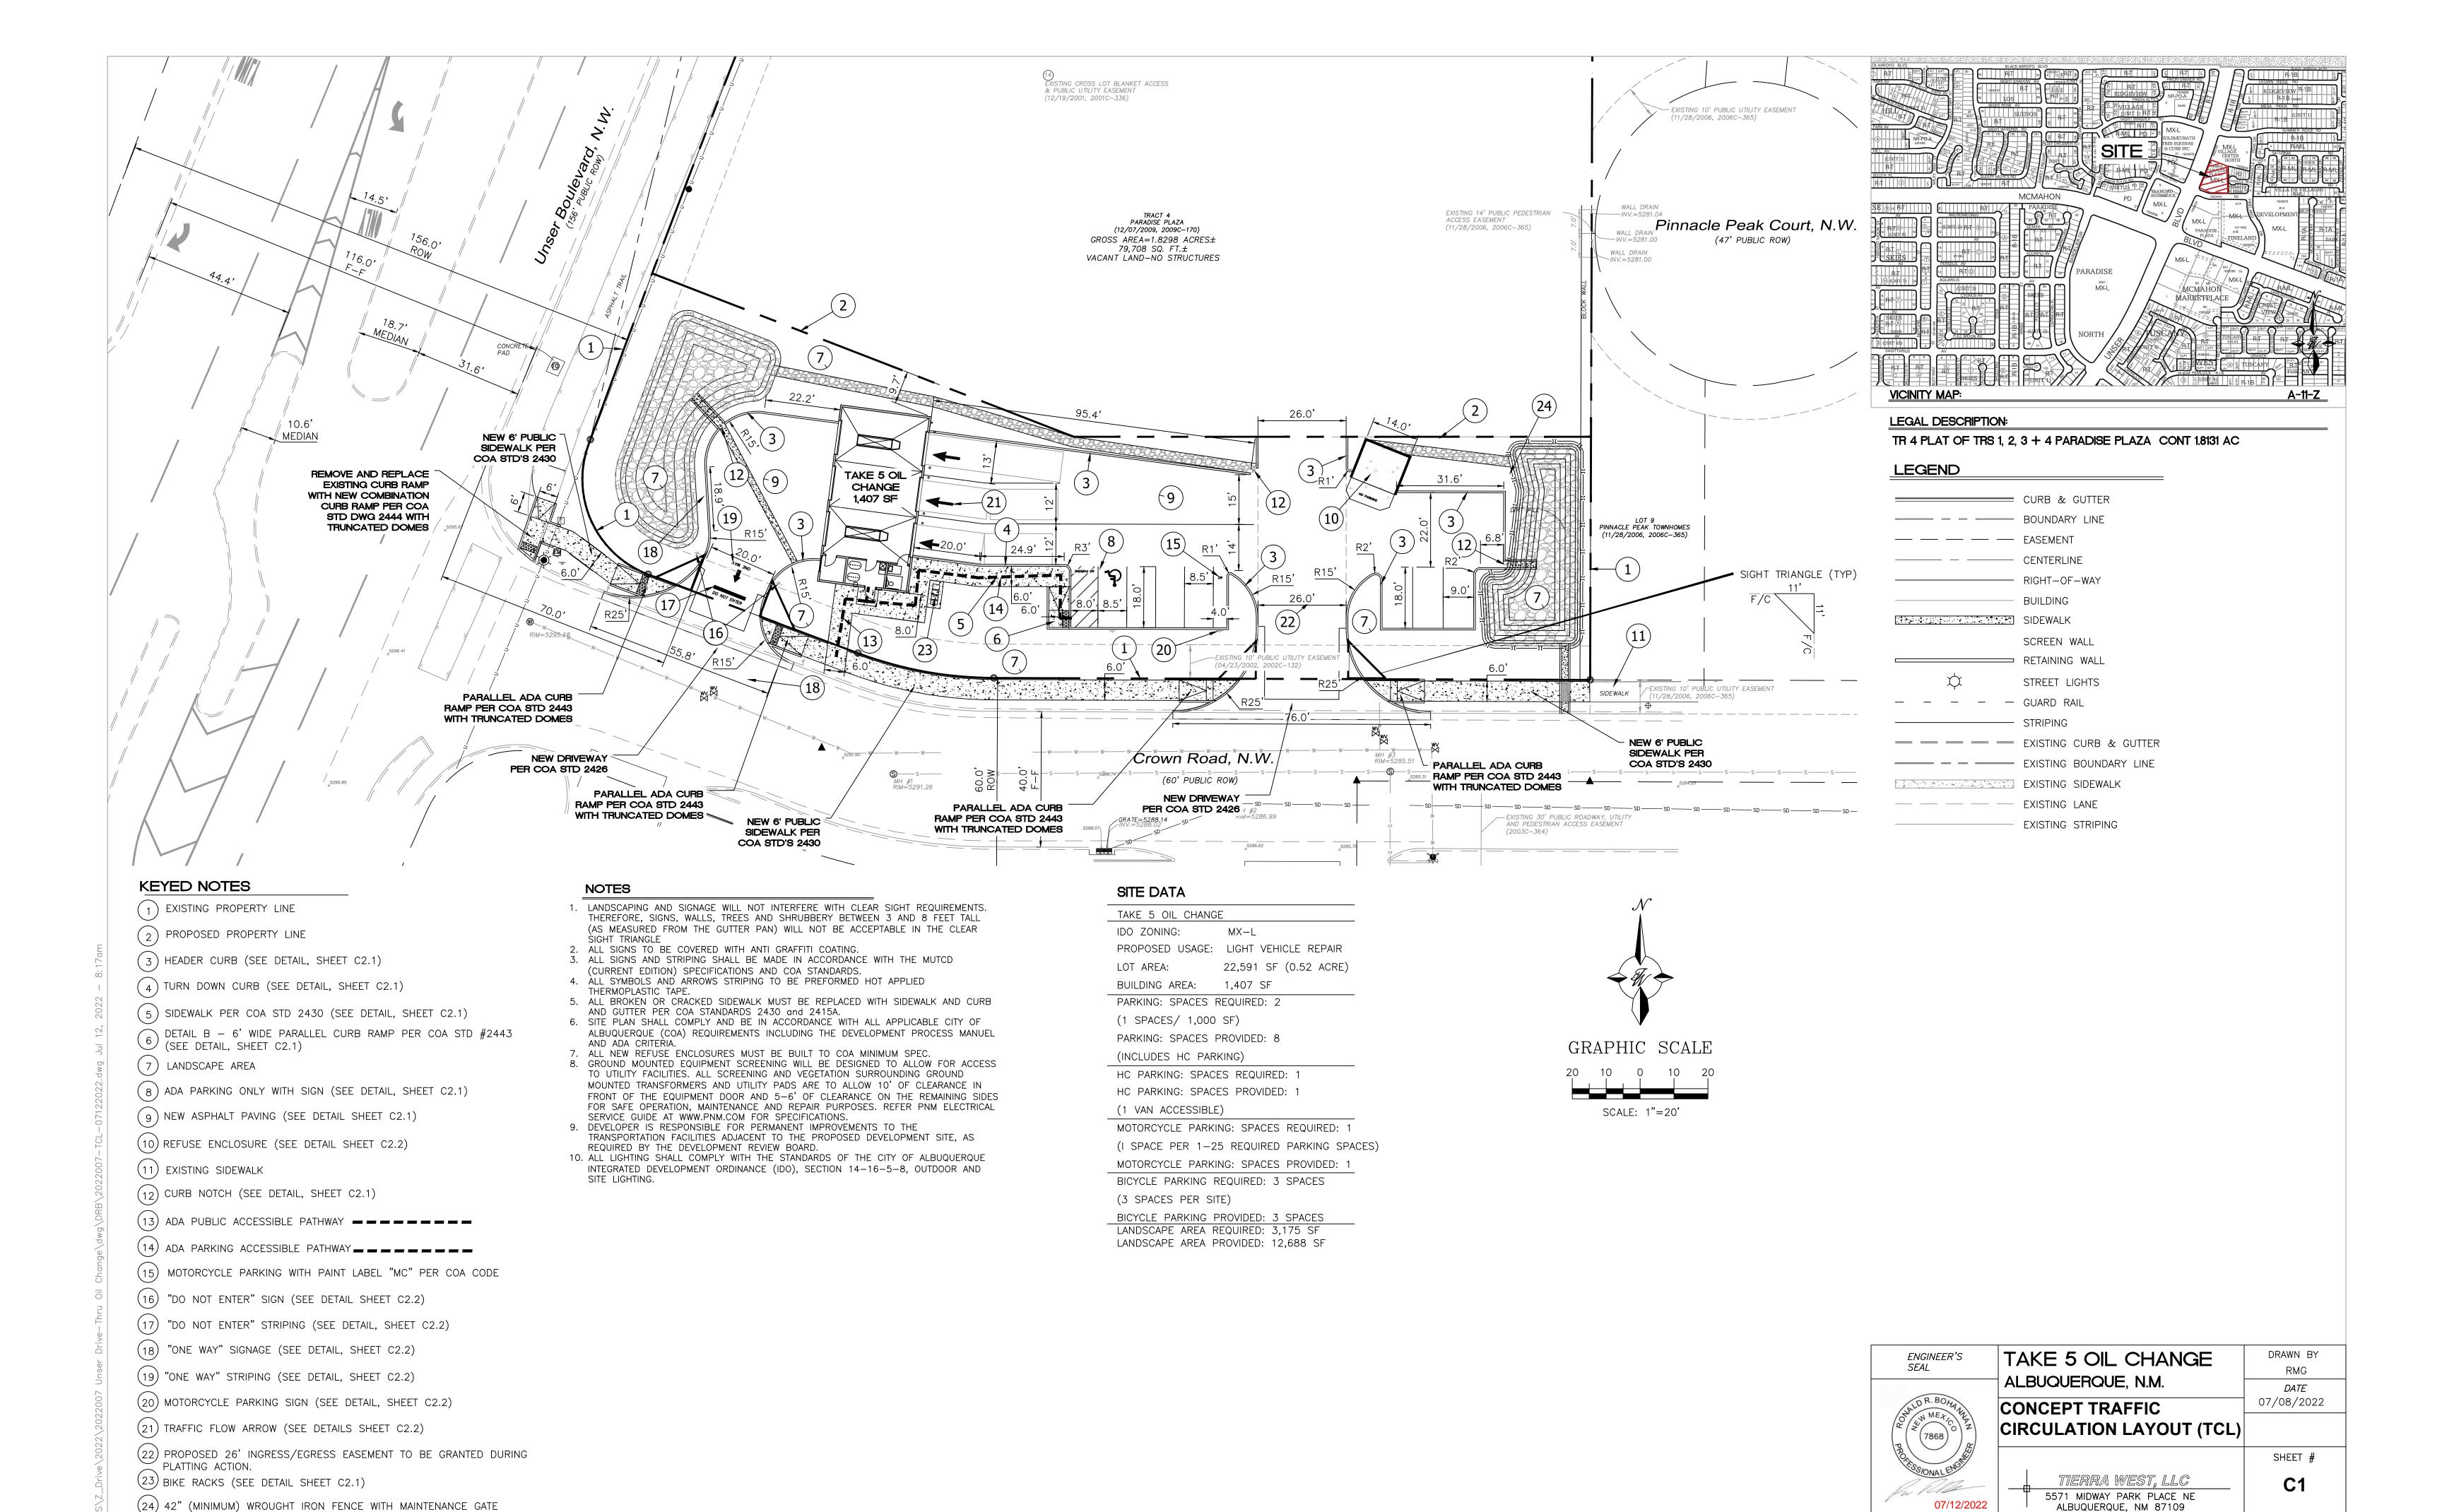

TO BE INSTALLED AROUND PERIMETER OF POND.

(505) 858-3100


www.tierrawestllc.com

RONALD R. BOHANNAN

P.E. #7868


JOB #

2022007

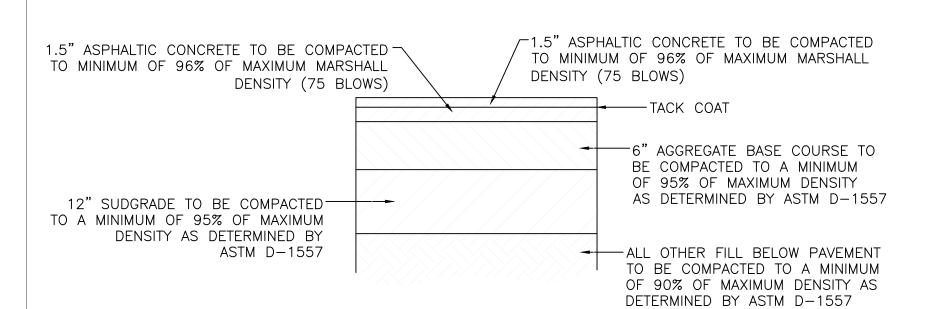


SITE ASPHALT PAVEMENT SECTION

NOTE: CONTRACTOR TO VERIFY WITH OWNER PROVIDED SOILS REPORT.

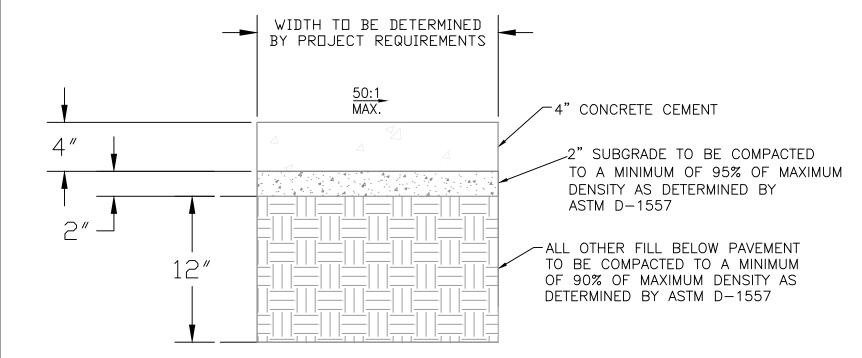

CONCRETE SIDEWALK SECTION

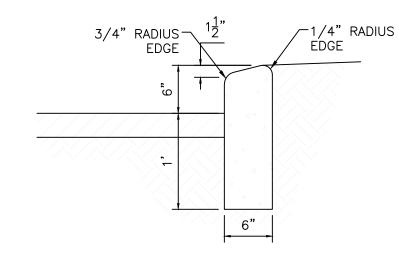

CURB GENERAL NOTES:


1. ALL CURBS TO BE CONSTRUCTED OF PORTLAND CEMENT CONCRETE.

2. PROVIDE CONTRACTION JTS. 12' MAX., SPACING, 1/2" EXP. JTS. AT CURB RETURNS AND AT A MAX. SPACING OF 120' BETWEEN CURB RETURNS AND EACH SIDE OF SEPARATELY CONSTRUCTED DRIVEWAYS. CONTRACTION JTS., SHALL BE EITHER SAWED OR TOOLED A MINIMUM OF 1" DEEP AT FINISHED FACES.

3. ALL EDGES SHALL BE EDGED WITH A 3/8" RADUIS EDGING TOOL.


4. 1/4" ISOLATION JOINT SHALL BE PLACED BETWEEN SIDEWALK AND CURB WHEN CAST ADJACENT TO EACH OTHER.


6" HEADER CURB DETAIL

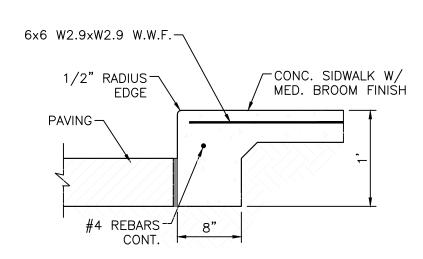

DETAIL-TURNDOWN CURB

NTS

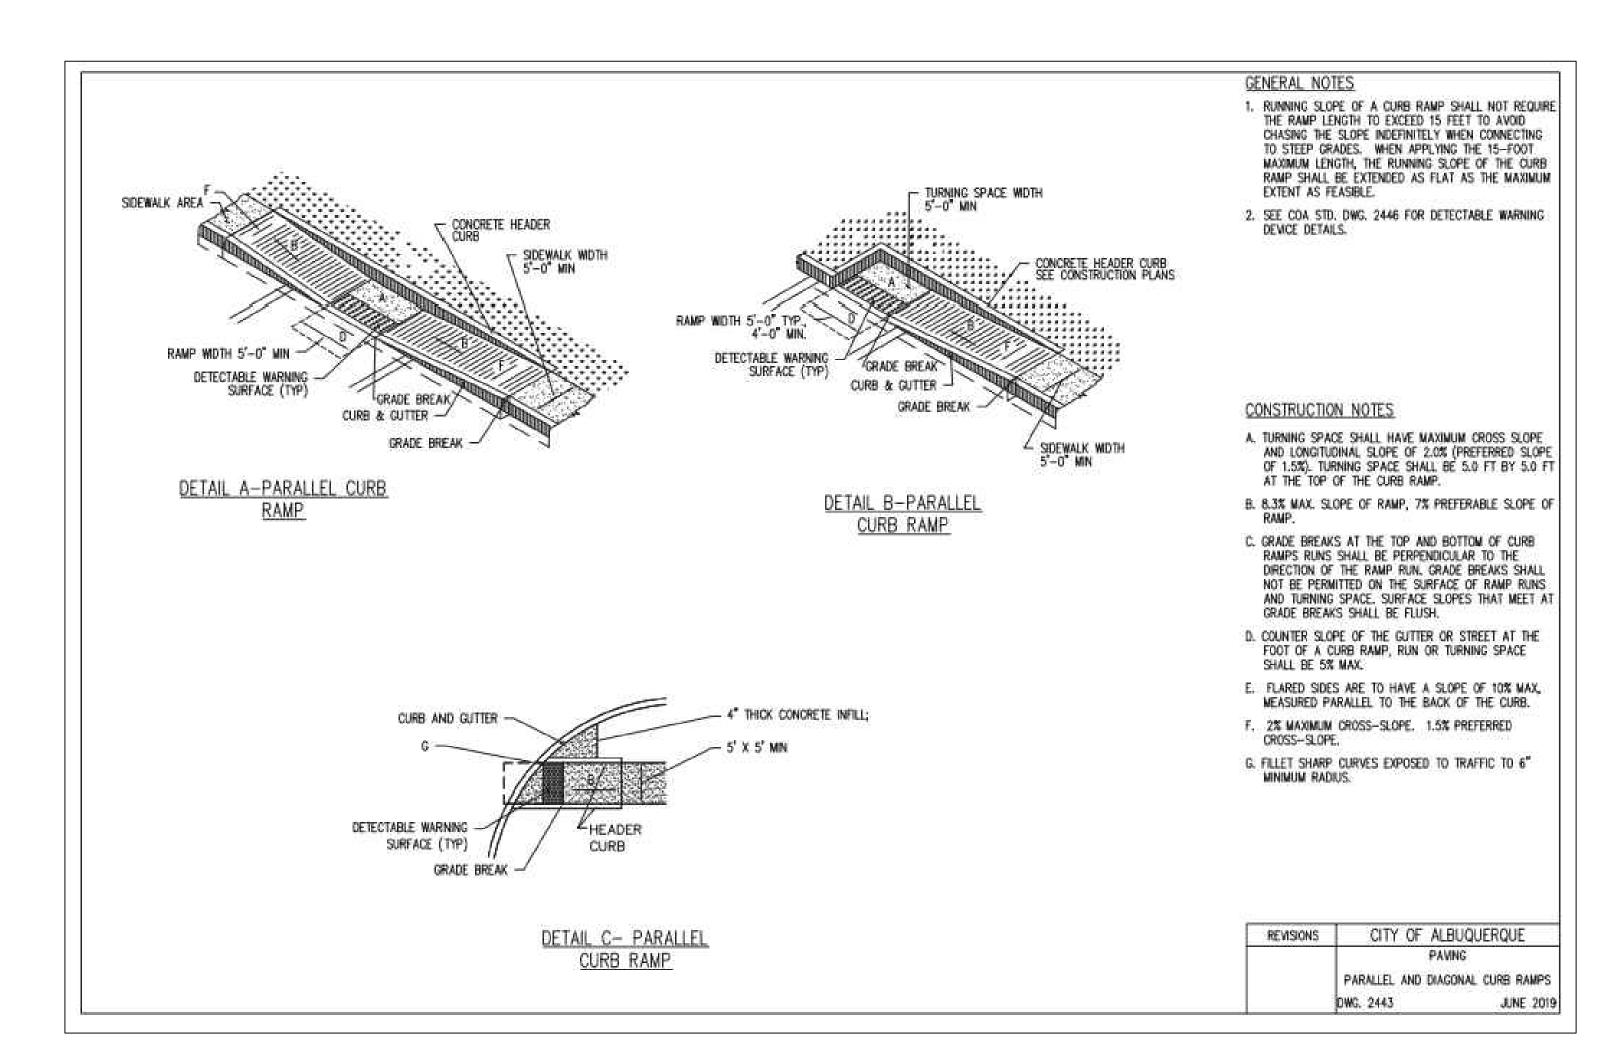

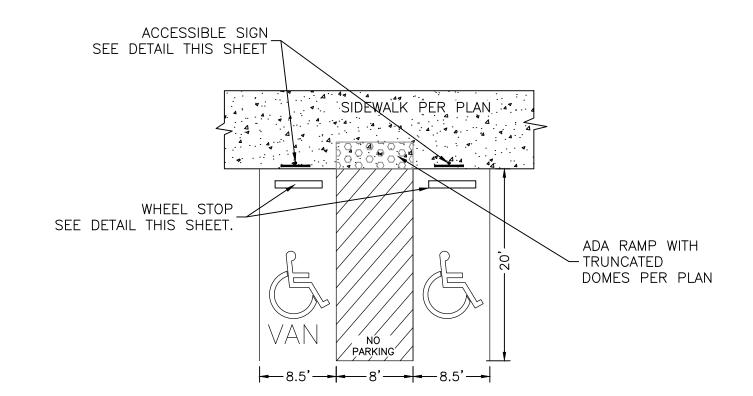

NOTES:

1) International Symbol of Accessibility shall be painted on the pavement at rear of space, white symbol on blue background.


2) Parking space lines and diagonal striping to be painted blue.

3) Access aisle shall have the words "NO PARKING" in capital letters, each of which shall be at least one foot high and at least two inches wide, placed at the rear of the parking space so as to be close to where an adjacent vehicle's rear tires would be placed.

4) ADA parking greas — not to exceed a slope greater than


4)ADA parking areas — not to exceed a slope greater than 2% in any direction

HC PARKING DETAIL SCALE: NTS

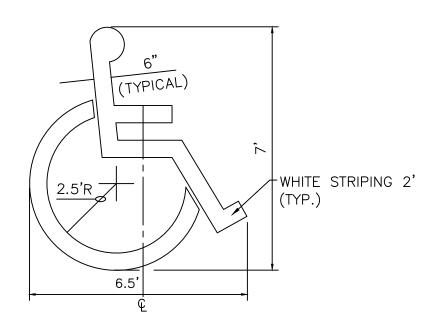


LOCATE AT EDGE OF PARKING SPACE UNLESS ACCOMPANIED BY "VAN" LETTERING


ACCESSIBLE PARKING SYMBOL

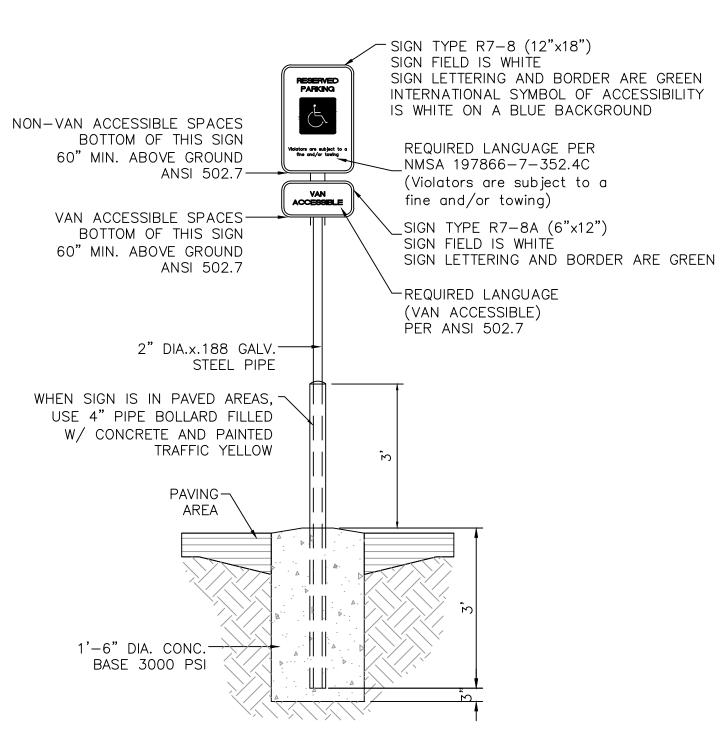


ACCESSIBLE PARKING SIGN


NTS

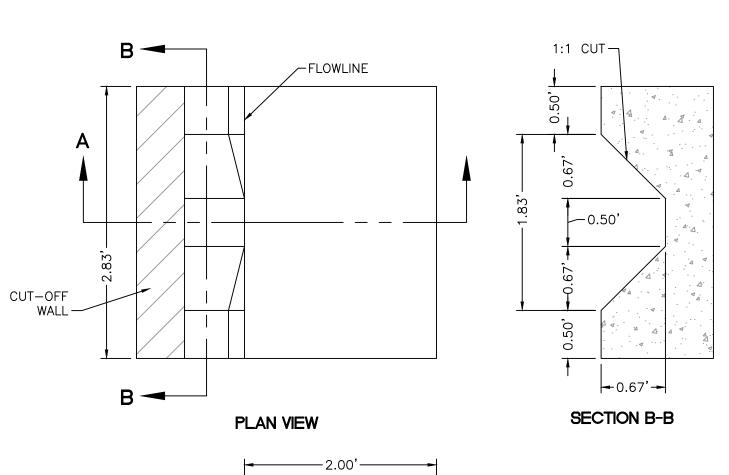

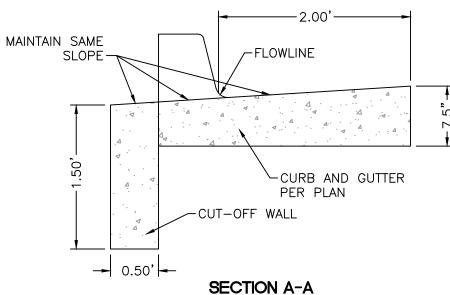



CURB NOTCH DETAIL

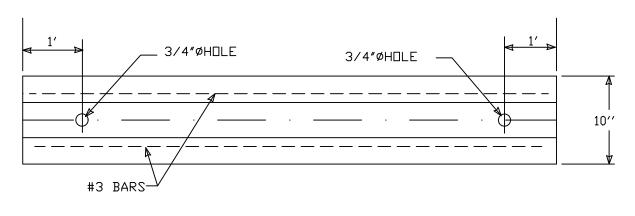

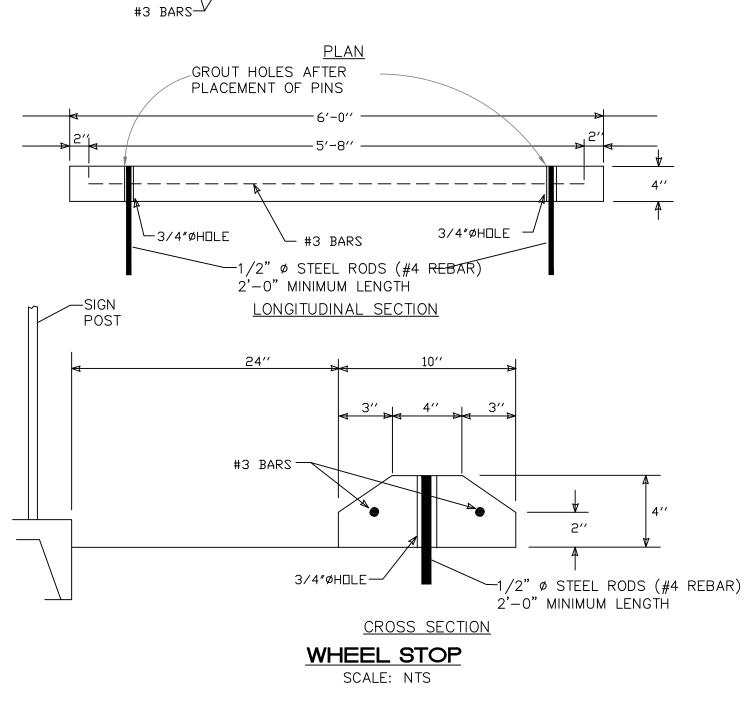

ENGINEER'S SEAL	TAKE 5 OIL CHANGE	DRAWN BY RMG
	ALBUQUERQUE, N.M. CONSTRUCTION DETAILS	<i>DATE</i> 07/08/2022
		SHEET #
	TIERRA WEST, LLC 5571 MIDWAY PARK PLACE NE ALBUQUERQUE, NM 87109	C2.1
RONALD R. BOHANNAN P.E. #7868	(505) 858-3100 www.tierrawestllc.com	ЈОВ # 2022007

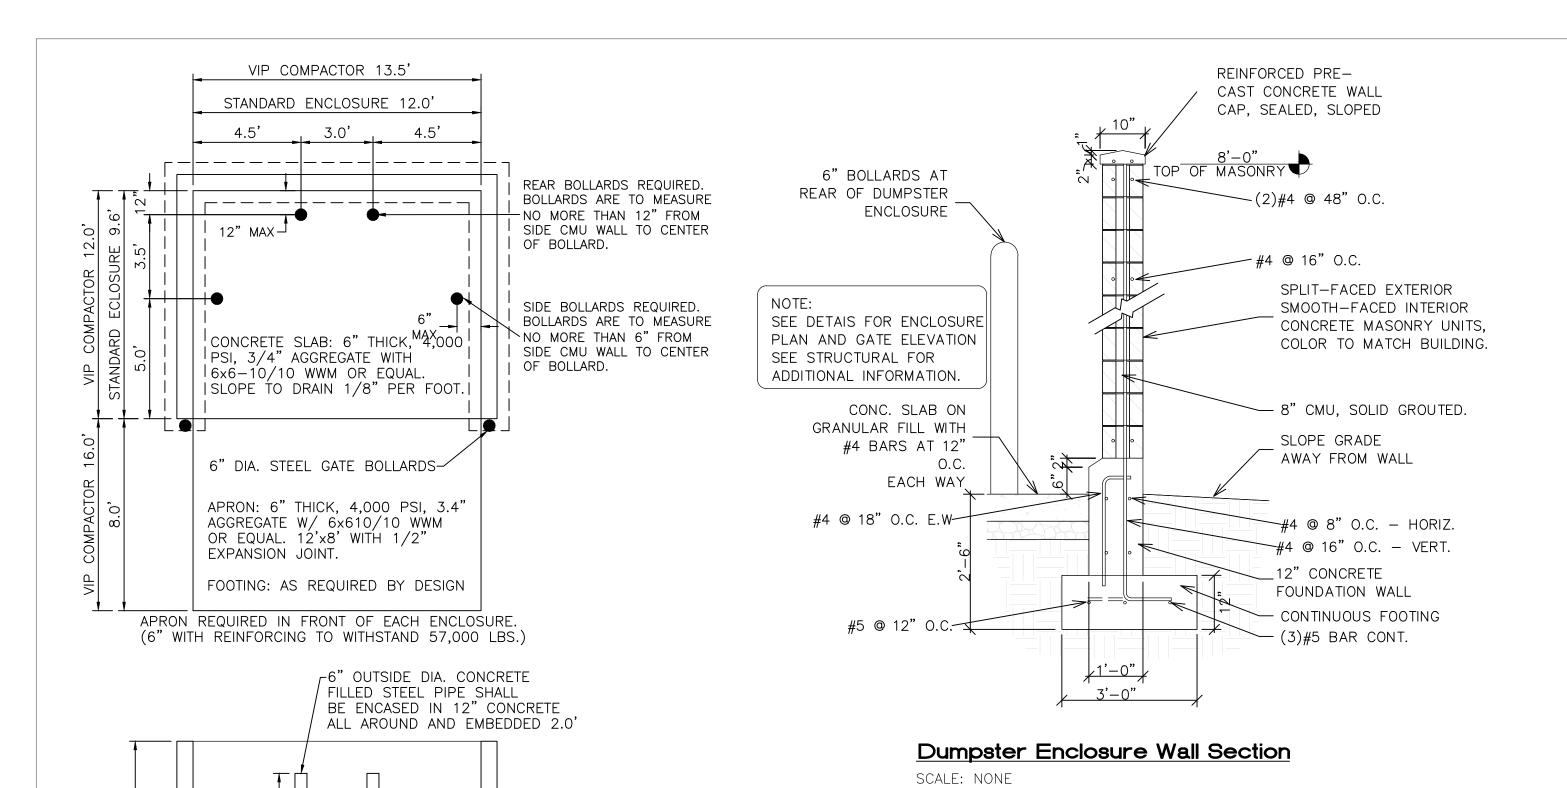

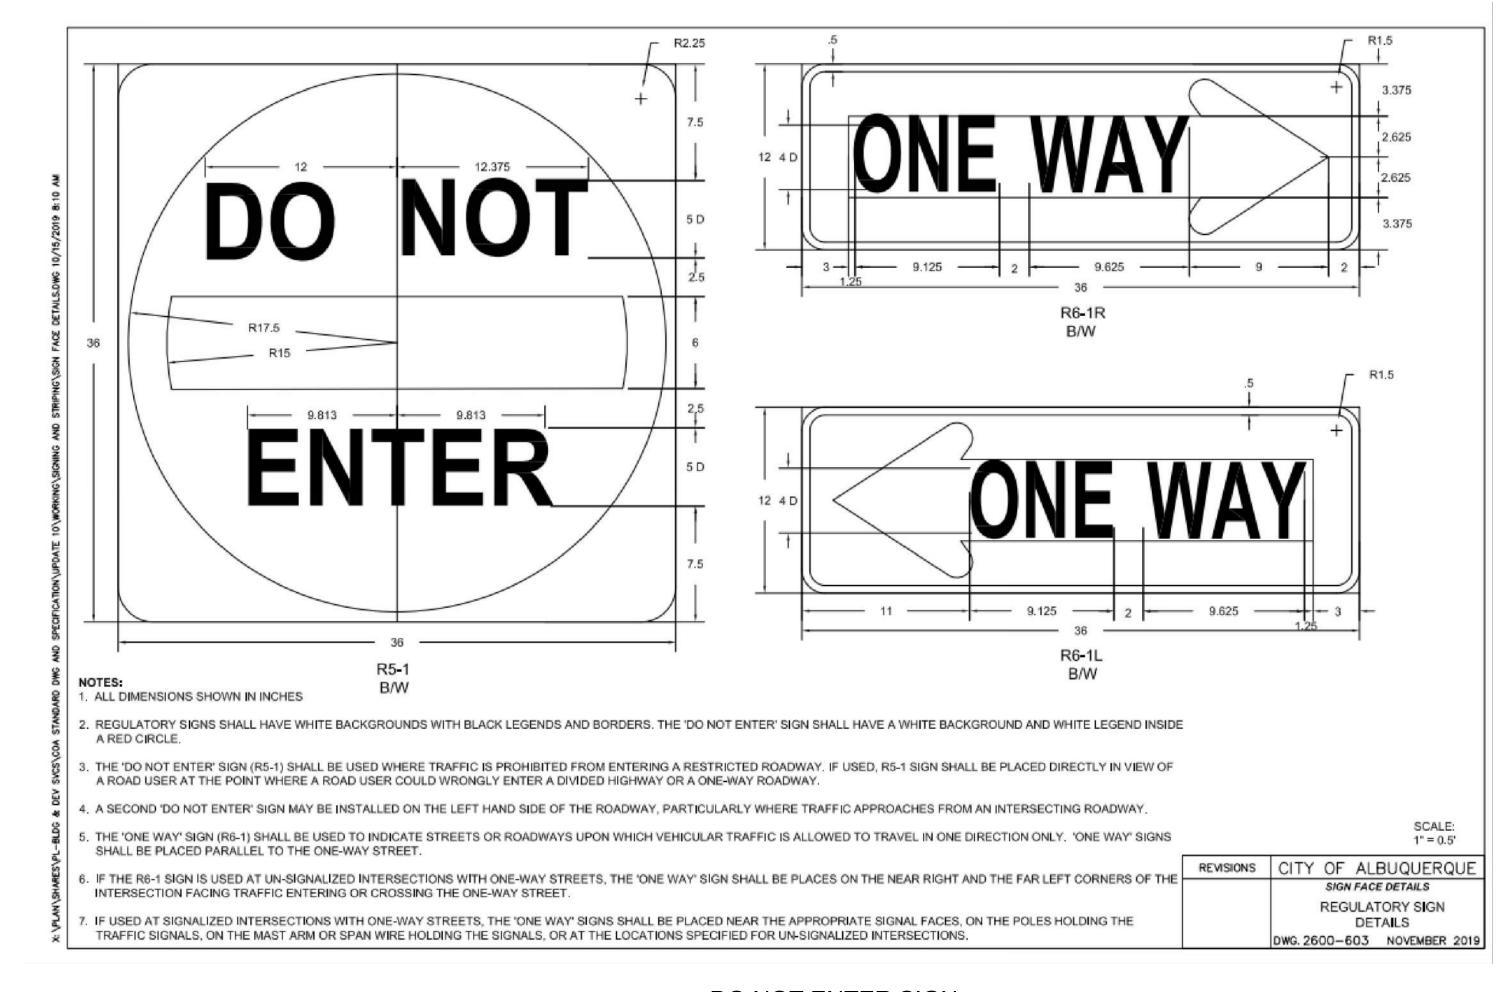


DUMPSTER ENCLOSURE DETAIL

NOTE: THESE ARE THE MINIMUM REQUIREMENTS FOR


FIT THE SELECTED ENCLOSURE.


TRASH ENCLOSURES. DESIGNS MAY VARY TO

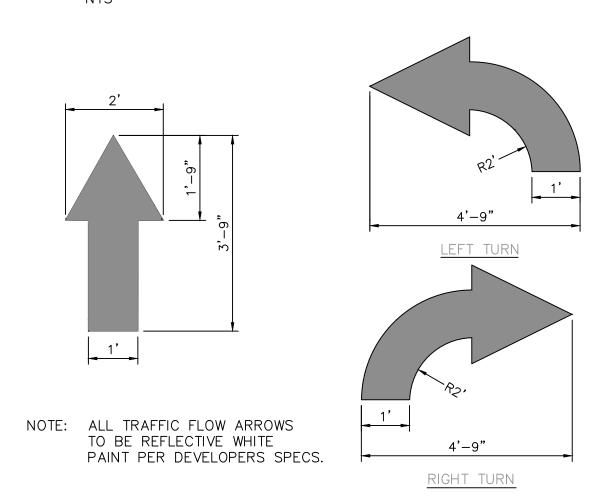

TRAFFIC FLOW ARROW

NOTE: ALL TRAFFIC FLOW STRIPING TO BE SOLID AND REFLECTIVE PER DEVELOPERS SPECIFICATIONS.

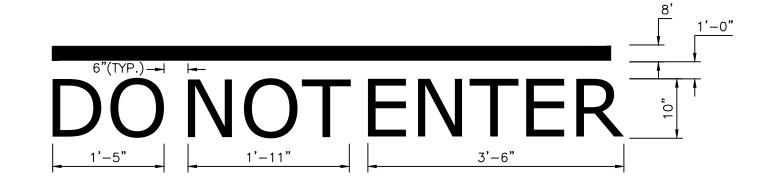

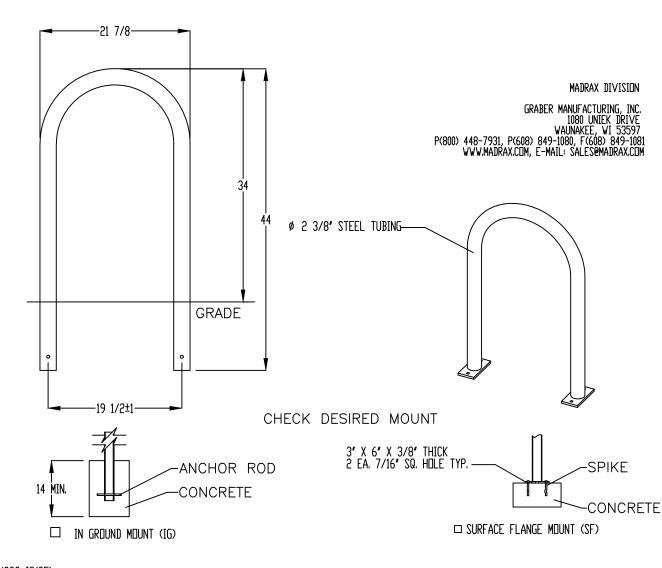


2 BIKE, SURFACE OR IN GROUND MOUNT ©2018 GRABER MANUFACTURING, INC. ALL PROPRIETARY RIGHTS RESERVED.

INSTALL BIKE RACKS ACCORDING TO MANUFACTURER'S SPECIFICATIONS. CONSULTANT TO SELECT COLOR (FINISH), SEE MANUFACTURER'S SPECIFICATIONS. SEE SITE PLAN FOR LOCATION OR CONSULT DWNER. 4. BIKE RACK SHALL HAVE A 1-FOOT CLEAR ZONE ALL AROUND.
5. EACH BIKE RACK SPACE SHALL BE AT LEAST 6 FEET LONG AND 2 FEET WIDE.

PARKING ONLY 2" DIA.x.188 GALV.— STEEL PIPE FINISH GRADE-1'-6" DIA. CONC. BASE 3000 PSI

MOTORCYCLE PARKING SIGN

DO NOT ENTER SIGN

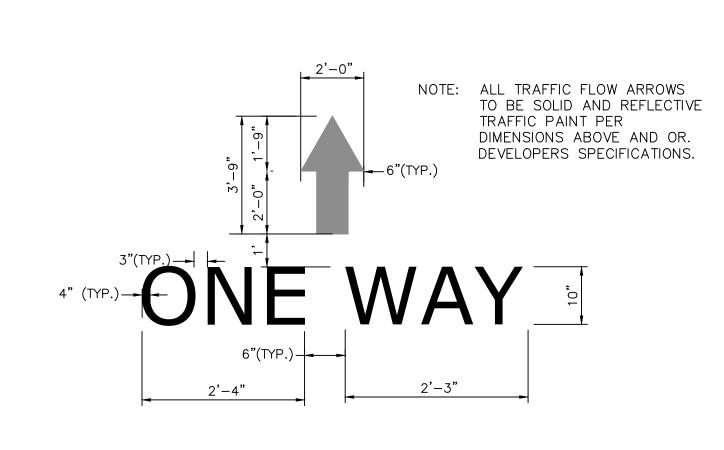

"ONE WAY" PAVEMENT MARKER W/ARROW

RONALD R. BOHANNAN P.E. #7868

ENGINEER'S SEAL	TAKE 5 OIL CHANGE	DRAWN BY RMG
	ALBUQUERQUE, N.M. CONSTRUCTION DETAILS	<i>DATE</i> 07/08/2022
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JOB #

2022007

BIKE RACK SCALE: NONE


DO NOT ENTER PAVEMENT MARKER

ITE Trip Gen Last Updated	11th Edition 6/1/2022		Unser Drive-Thru Oil Change													
				Peak Hour Adj	acent ((AM)				Peak Hour Adj	acent	(PM)			Total AM	1/PM
ITE Trip Type	Land Use Code	IV Value	Average Rate (Total)	Fitted Curve	R ²	Equation	Enter	Exit	Average Rate (Total)	Fitted Curve	R ²	Equation	Enter	Exit	Caclulated Trips	Fitted Curve
Services	941	1.4	8	N/A	N/A	N/A	6	2	12	N/A	N/A	N/A	5	7	20	0
				Weekd	ay											
		'-	Average Rate (Total)	Fitted Curve	R ²	Equation	Enter	Exit								
Services	941	1.4	97	N/A	N/A	N/A	48	49	•							
								Fu	ture Restaura	aunt						
		•		Peak Hour Adja	acent ((AM)		Fu	ture Restaur	aunt Peak Hour Adj	acent	(PM)			Total AM	1/PM
ITE Trip Type	Land Use Code	IV Value	Average Rate (Total)	Peak Hour Adja	_	(AM) Equation	Enter	Fu	Average Rate (Total)		_	(PM) Equation	Enter	Exit	Total AIV	
ITE Trip Type Services	Land Use Code 932	IV Value 4.85	Average Rate (Total)		_		Enter 25			Peak Hour Adj	_	Equation	Enter 27	Exit 17		
				Fitted Curve	R ² N/A	Equation		Exit	Average Rate (Total)	Peak Hour Adj	R ²	Equation			Caclulated Trips	Fitted Curve
				Fitted Curve N/A	R ² N/A ay	Equation		Exit	Average Rate (Total)	Peak Hour Adj	R ²	Equation			Caclulated Trips	Fitted Curve
			46	Fitted Curve N/A Weekd Fitted Curve	R ² N/A ay R ²	Equation N/A	25	Exit 21	Average Rate (Total)	Peak Hour Adj	R ²	Equation			Caclulated Trips	Fitted Curve

Quick Lubrication Vehicle Shop
(941)

Vehicle Trip Ends v: 1600 Sq. Pt. GFA
On a: Weekday,
Pask Hour of Adjacent Street Traffic,
On the Weekday,
Pask Hour of Adjacent Street Traffic,
On the Street Traffic,

Vehicle Trip Generation per 1000 Sq. Ft. GFA						
Average Rate	Range of Rates	Standard Deviation				
5.80	5.60 - 5.60	140				

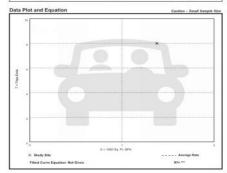


Quick Lubrication Vehicle Shop
(941)

Vehicle Trip Ends vs. 1000 Sq. Pt. GPA

On a Weekday,
Peak Hour of Adjacent Street Traffic,
Den Street Traffic,
Settings Cacation. General Urban-Suburban
Number of Street
Aps. 1000 Sq. Pt. GPA. 1


Description Distriction. 42% entering, 58% eating



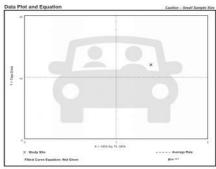

He=

Quick Lubrication Vehicle Shop (941) Vehicle Trip Ends vs. 180 Sq. Ft. GFA On a: Weekday

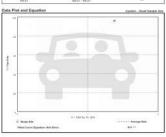


High-Turnover (Sit-Down) Restaurant

(932) Vetácie Trip Ends vz. 1993 Sq. Ft. GFA On A: Weekday


SettingLocation: General Unberdhaburban Number of Studies: 50 Avg. 1000 Sp. Pt. GFA: 5 Directional Distribution: 50% entering, 50% enting

W	Vehicle Trip Generation per 1000 Sq. Ft. GFA						
F	Average Rate	Range of Roses	Standard Deviation				
	187.20	15.04 - 742.41	80.72				

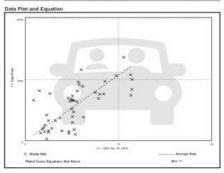

High-Turnover (Sit-Down) Restaurant (932) Vehicle Trip Each xx: 1000 Sq. Pt. CPA One 1000 Sq. Pt. CPA One 1000 Sq. Pt. CPA One 1000 Sq. Pt. CPA Setting Eaceston: General College Special Traffic, One 1000 Sq. Pt. Setting Eaceston: General College Special Special Traffic, One 1000 Sq. Pt. Non-ton of Students 201 Decidents College Sq. Pt. CPA 2 Decidents

Vehicle Trip Generation per 1000 Sq. Ft. GFA						
Avwege Bate	Rouge of Rates	Raynawa Devinaturi				
0.57	0.76 - 162.28	.11.01				

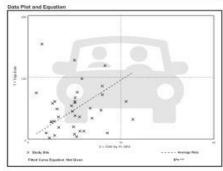


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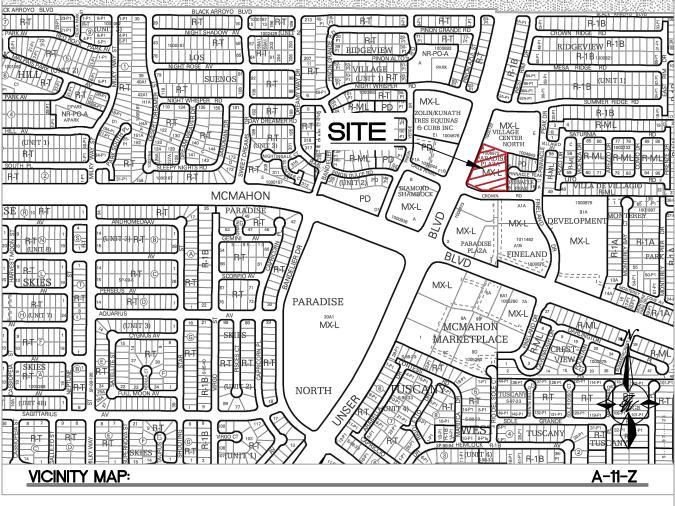
General Urban/Substitute and Panal (Land Uses 800-599) 679

474 Trig Seneration Manual 11th Edition - Volume 5

hes



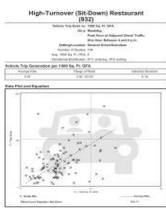



LEGAL DESCRIPTION:

TR 4 PLAT OF TRS 1, 2, 3 + 4 PARADISE PLAZA CONT 1.8131 AC

ENGINEER'S SEAL	TAKE 5 OIL CHANGE ALBUQUERQUE, N.M.	DRAWN BY RMG DATE
	INTERSECTION SIGHT LINE EXHIBIT	07/08/2022
	TIERRA WEST, LLC 5571 MIDWAY PARK PLACE NE ALBUQUERQUE, NM 87109	SHEET #
RONALD R. BOHANNAN P.E. #7868	(505) 858-3100 www.tierrawestllc.com	ЈОВ # 2022007