
## CITY OF ALBUQUERQUE

Planning Department Alan Varela, Director

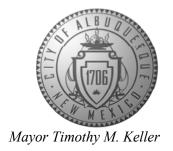

June 16, 2022

David Soule, P.E. Rio Grande Engineering P.O. Box 93924 Albuquerque, NM 87199

**RE:** 10538 Dover St. NW

 $2^{nd}\ Revised\ Grading\ and\ Drainage\ Plan$ 

Engineer's Stamp Date: 06/07/22

**Hydrology File: A12D031** 

Dear Mr. Soule:

PO Box 1293

Based upon the information provided in your submittal received 06/06/2022, the 2<sup>nd</sup> Revised Grading and Drainage Plan is approved for Building Permit. Please attach a copy of this approved plan in the construction sets for Building Permit processing along with a copy of this letter.

Albuquerque

#### PRIOR TO CERTIFICATE OF OCCUPANCY:

NM 87103

1. Engineer's Certification, per the DPM Part 6-14 (G): Engineer's Certification Checklist for Subdivision and Part 6-14 (H): Required Certification Language is required.

If you have any questions, please contact me at 924-3995 or rbrissette@cabq.gov.

www.cabq.gov

Sincerely,

Renée C. Brissette, P.E. CFM Senior Engineer, Hydrology Planning Department

Renée C. Brissette



# City of Albuquerque

#### Planning Department

#### Development & Building Services Division

#### DRAINAGE AND TRANSPORTATION INFORMATION SHEET (REV 6/2018)

Project Title: 10538 DOVER Building Permit #:			Hydrol	_ Hydrology File #:	
DRB#:	EPC#:		Work	_ Work Order#:	
Legal Description: LOT 22 BLOCK	17 PARADISE	HEIGHTS UN	IT 1	<del></del> -	
City Address: 10538 DOVER			****	70	
Applicant:			Contact:		
Address:					
Phone#:	Fax#:		E-mail:		
Other Contact: RIO GRANDE ENGIN	EERING		Contact:	DAVID SOULE	
Address: PO BOX 93924 ALB NM	8/199	0000		lavid@riograndeengineering gor	
Phone#: 505.321.9099					
TYPE OF DEVELOPMENT: PLAT	X RESIDE	NCE DR	B SITE	_ ADMIN SITE	
Check all that Apply:					
DEPARTMENT:  X HYDROLOGY/ DRAINAGE TRAFFIC/ TRANSPORTATION		TYPE OF APPRO  BUILDING PI  CERTIFICAT	ERMIT APPI		
TYPE OF SUBMITTAL:  ENGINEER/ARCHITECT CERTIFICATION PAD CERTIFICATION CONCEPTUAL G & D PLAN GRADING PLAN DRAINAGE REPORT DRAINAGE MASTER PLAN FLOODPLAIN DEVELOPMENT PERMIT ELEVATION CERTIFICATE CLOMR/LOMR TRAFFIC CIRCULATION LAYOUT (TCI TRAFFIC IMPACT STUDY (TIS)	APPLIC	FINAL PLAT	FOR SUB'D OF SUB'D OF SUB'D OF SUB OF FINAL SUB OF	APPROVAL PERMIT APPROVAL L NCIAL GUARANTEE APPROVAL ROVAL	
STREET LIGHT LAYOUT		WORK ORDE		L	
OTHER (SPECIFY)PRE-DESIGN MEETING?	<u> </u>	CLOMR/LOM		MENT PERMIT	
IS THIS A RESUBMITTAL?: X Yes1	No	OTHER (SPE			
DATE SUBMITTED:	*				
COA STAFF:	ELECTRONIC SUE	BMITTAL RECEIVED:		-	

#### 

Weighted E Method

#### **Equations:**

Weighted E = Ea\*Aa + Eb\*Ab + Ec\*Ac + Ed\*Ad / (Total Area)

Volume = Weighted D \* Total Area

Flow = Qa \* Aa + Qb \* Ab + Qc \* Ac + Qd \* Ad

Where for 100-year, 6-hour storm- zone 1

Ea= 0.44 Qa= 1.29 Eb= 0.67 Qb= 2.03 Ec= 0.99 Qc= 2.87

Ed= 1.97

ONSITE Conditions

This site is an infill lot within an fully developed subdivision. The existing lots all free discahrge. Due to existing graded slopes, the existing lot drate to the rear. The plan will direct the majority of the developed flow to the adjacent roadway. The developed site will pond in excess of the water quality volume generated by the site. Upland flows do not effect the site.

The site currently dishcarges at a peak rate of 0.38 cfs to the rear. The propose discharge to the rear is reduced to 0.22 cfs

Qd= 4.37

### EROSION CONTROL NOTES:


- 1. CONTRACTOR IS RESPONSIBLE FOR OBTAINING A TOPSOIL DISTURBANCE PERMIT PRIOR TO BEGINNING WORK.
- 2. CONTRACTOR IS RESPONSIBLE FOR MAINTAINING RUN-OFF ON SITE DURING CONSTRUCTION.
- 3. CONTRACTOR IS RESPONSIBLE FOR CLEANING ALL SEDIMENT THAT GETS INTO EXISTING RIGHT-OF-WAY.
- 4. REPAIR OF DAMAGED FACILITIES AND CLEANUP OF SEDIMENT ACCUMULATIONS ON ADJACENT PROPERTIES AND IN PUBLIC FACILITIES IS THE RESPONSIBILITY OF THE CONTRACTOR.
- 5. ALL EXPOSED EARTH SURFACES MUST BE PROTECTED FROM WIND AND WATER EROSION PRIOR TO FINAL ACCEPTANCE OF ANY PROJECT.

RAISED RETAINING WALL
AND LEVELED BACK YARD

SCALE: 1"=20'

8/16/21

2 REVISED DRIVEWAY, UPDATED PONDS

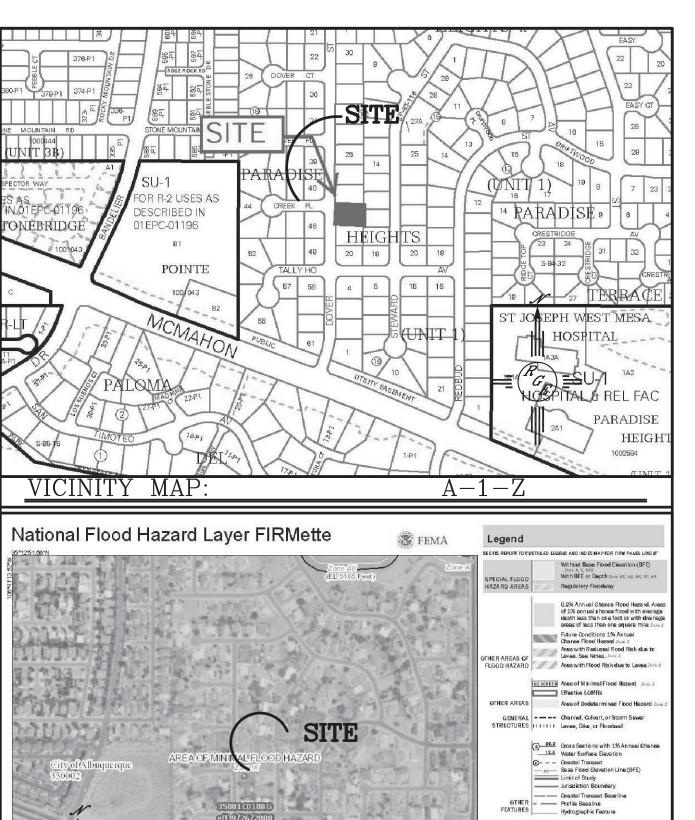

Digital Data Available

This map complies with FEMA's standards for the use of digital flood maps if it is not void as described below. The basemap shown complies with FEMA's basemap accuracy standards.

The flood hazard information is derived directly from the eathorisetive NFHL web services provided by FEMA. This may wes exported on 8/20/20/30 at 309402 PM and does not reflect changes or emeriments subsequent to this date and time. The NFHL emerifectual information may change or become superseded by new date over time.

This map image is void if the one or more of the following m elements do not up pear: beasemap imagery, flood zone labels, legand, scale bar, map creation date, community identifiers; FIRM panel number, and FIRM effective date. Map images for unmapped and unmodernized areas cannot be used for regulatory purposes.

No Digital Data Available

The pindisplayed on the map is an approximate point selected by the user and does not represe

# LEGAL DESCRIPTION:

Lot 22, Block 17, Paradise Heights Unit 1

#### NOTES:

FIRM MAP:


1. ALL SPOT ELEVATIONS REPRESENT FLOWLINE ELEVATION UNLESS OTHERWISE NOTED.

2. ALL SLOPES SHALL BE 3:1 MAX. AND GRAVEL OR NATIVE SEEDING PRIOR TO CO.

3. HOUSE SHALL HAVE ROOF GUTTER SYSTEM TO DRAIN TO WEST. REAR PORCH TO DRAIN TO REAR

## LEGEND

ENGINEER'S SEAL	10538 DOVER	DRAWN BY WCWJ
AVID SOU		DATE
OF THE MEXICAL TO	GRADING AND	8-21-19
APOFESSIONER	DRAINAGE PLAN	2109068-LAYOUT-8-21-
POFESSIONAL	Rio Grande	SHEET #
6/7/22 8/16/21	Engineering	_
8/21/19	1606 CENTRAL AVENUE SE	
DAVID SOULE	SUITE 201 ALBUQUERQUE, NM 87106	JOB #
P.E. #14522	(505) 872-0999	2109068

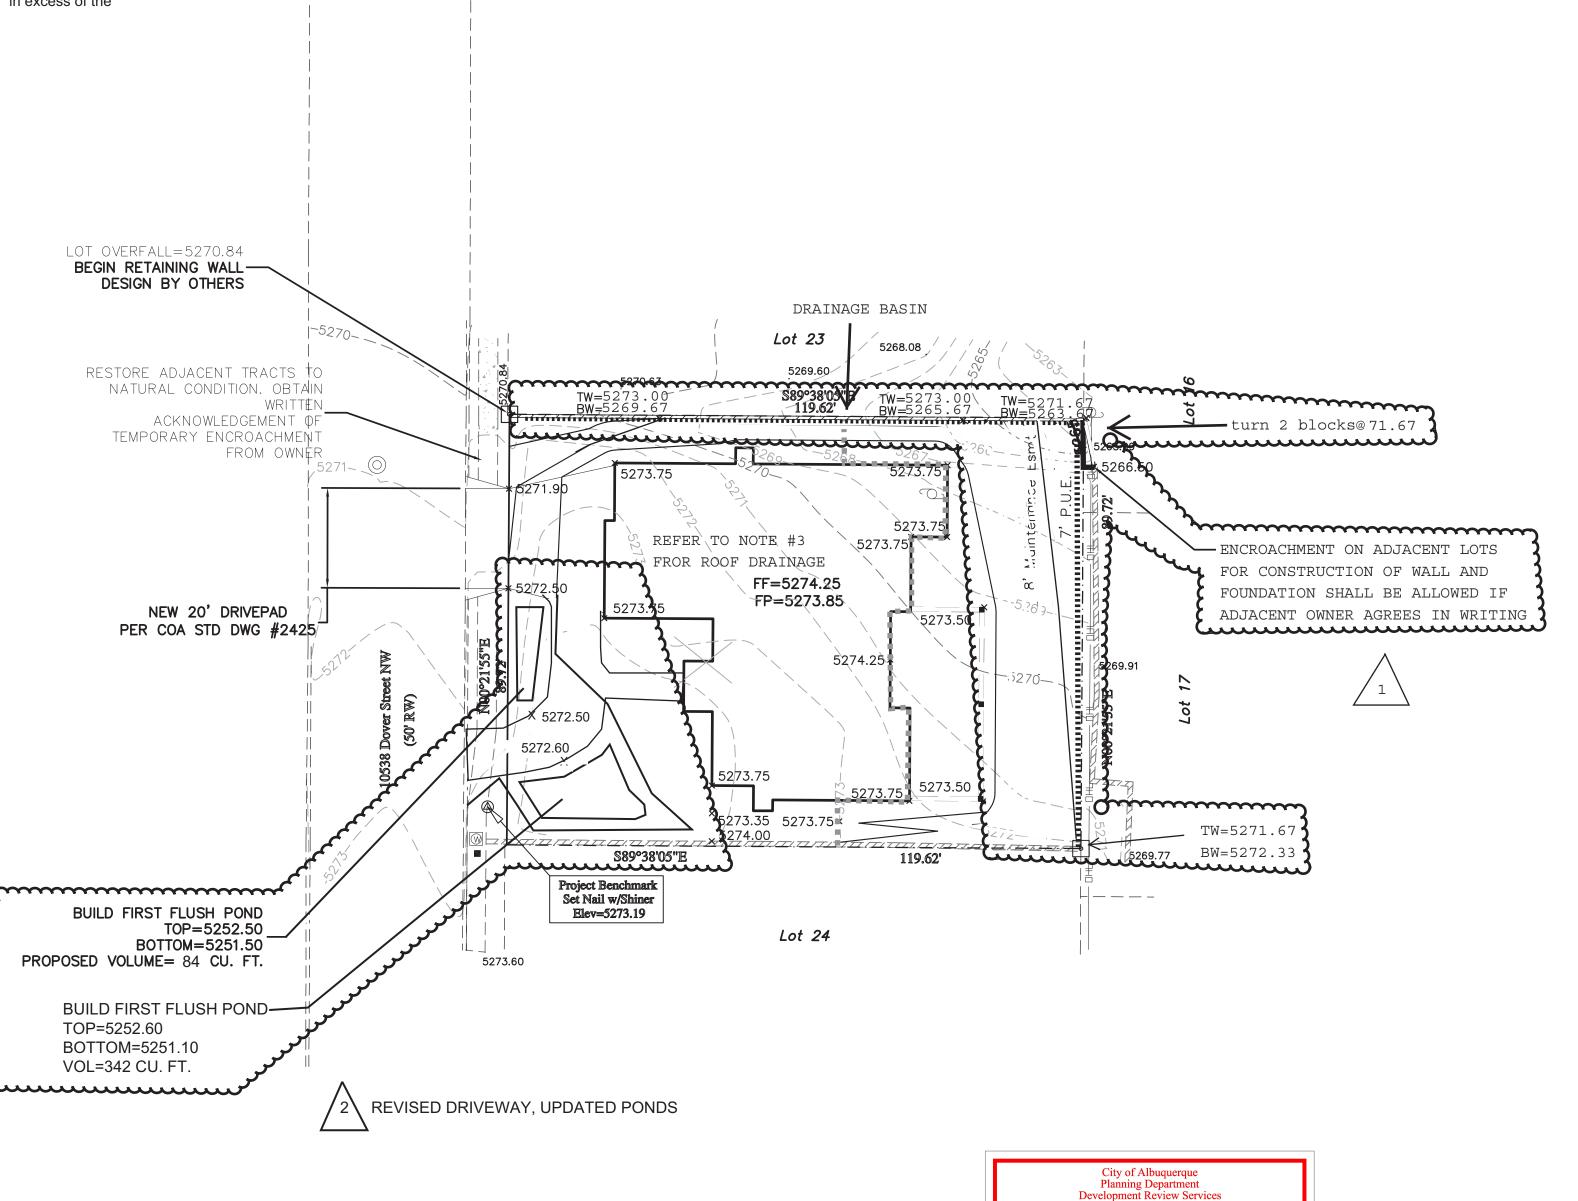

HYDROLOGY SECTION

**APPROVED** 

DATE: 06/16/22
BY: Bressette
HydroTrans # A12D031

#### CATIMICAT

CAUTION:

EXISTING UTILITIES ARE NOT SHOWN.

IT SHALL BE THE SOLE RESPONSIBILITY

OF THE CONTRACTOR TO CONDUCT ALL

NECESSARY FIELD INVESTIGATIONS PRIOR

TO ANY EXCAVATION TO DETERMINE THE

ACTUAL LOCATION OF UTILITIES & OTHER

IMPROVEMENTS.