
# CITY OF ALBUQUERQ

Planning Department Brennon Williams, Director

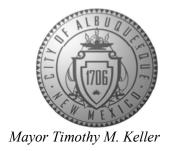

November 5, 2020

David Soule, P.E. **Rio Grande Engineering** P.O. Box 93924 Albuquerque, NM 87199

RE: 10800 Olympic St. NW **Grading and Drainage Plan** Engineer's Stamp Date: 10/21/20

**Hydrology File: A12D032** 

Dear Mr. Soule:

Based upon the information provided in your submittal received 10/22/20, the Grading and Drainage Plan is approved for Building Permit.

PO Box 1293

Once the grading is complete, a pad certification will be required prior to release of Building Permit. Please attach a copy of this approved plan in the construction sets for Building Permit

processing along with a copy of this letter and the pad certification approval letter.

Prior to approval in support of Permanent Release of Occupancy by Hydrology, Engineer Certification per the DPM checklist will be required.

If you have any questions, please contact me at 924-3995 or rbrissette@cabq.gov.

www.cabq.gov

Albuquerque

NM 87103

Sincerely,

Renée C. Brissette, P.E. CFM Senior Engineer, Hydrology Planning Department

Renée C. Brissette



# City of Albuquerque

### Planning Department

### Development & Building Services Division

## DRAINAGE AND TRANSPORTATION INFORMATION SHEET (REV 6/2018)

Project Title: 10800 Olympic	Building Permit #:	Hydrology File	e #:
DRB#:	EPC#:	Work Order#:	
DRB#: Legal Description. LOT 4 BLOCK 10	PARADISE HEIGHTS	UNIT 1	
City Address: 10800 olympic	- mp.		
Applicant: summer tree homes		Contact:	
Address:			
Phone#:			
Other Contact: RIO GRANDE ENGINE			
Address: PO BOX 93924 ALB NM	87199		
Phone#: 505.321.9099	Fax#: 505.872.0999	E-mail: david@r	iograndeengineering.com
TYPE OF DEVELOPMENT: PLAT			
Check all that Apply:			
DEPARTMENT:  X HYDROLOGY/ DRAINAGE TRAFFIC/ TRANSPORTATION  TYPE OF SUBMITTAL: ENGINEER/ARCHITECT CERTIFICATION PAD CERTIFICATION CONCEPTUAL G & D PLAN X GRADING PLAN DRAINAGE REPORT DRAINAGE MASTER PLAN FLOODPLAIN DEVELOPMENT PERMIT A ELEVATION CERTIFICATE CLOMR/LOMR TRAFFIC CIRCULATION LAYOUT (TCL) TRAFFIC IMPACT STUDY (TIS) STREET LIGHT LAYOUT OTHER (SPECIFY) PRE-DESIGN MEETING?  IS THIS A RESUBMITTAL?: Yes X No	X BUILD CERTI  N PRELI SITE F SITE F FINAL  SIA/ R FOUN GRAD SO-19 PAVIN X GRAD WORK CLOM FILOOI OTHE	OPLAIN DEVELOPMENT P R (SPECIFY)	L VAL APPROVAL GUARANTEE VAL N ERMIT
DATE SUBMITTED:	*		
COA STAFF:	ELECTRONIC SUBMITTAL RECE	VED:	

FEE PAID:\_\_\_\_\_

olympic 100-Year, 6-hr. Area | Treatment A | Treatment B | Treatment C | Treatment D Weighted | Volume Basin (acres) % (acres) % (acres) % (acres) % (acres) (ac-ft) EXISTING 10235.00 | 0.235 | 100% | 0.235 | 0% | 0.000 | 38% | 0.0893 | 2% | 0.005 | 0.856 | 0.017 PROPOSED FRONT 6355.00 0.146 0% 0 26% 0.038 13% 0.019 61% 0.089 1.505 0.52

3880.00 0.089 0% 0 40% 0.036 48% 0.0428 12% 0.011 0.980 0.007

0.24

Weighted E Method

PROPOSED REAR

total

Weighted  $E = Ea^*Aa + Eb^*Ab + Ec^*Ac + Ed^*Ad / (Total Area)$ 

Volume = Weighted D \* Total Area

Flow = Qa \* Aa + Qb \* Ab + Qc \* Ac + Qd \* Ad

Where for 100-year, 6-hour storm-zone 1


Qa= 1.29 Eb= 0.67 Qb= 2.03 Ec= 0.99 Qc= 2.87 Ed= 1.97 Qd= 4.37

### ONSITE Conditions

EXISTING DISCHARGE TO PARK 0.58 CFS PROPOSED DISCHARGE TO PARK 0.24 CFS PROPOSED DISCHARGE TO STRE 0.52 CFS

Narrative

This site is an infill lot within an fully developed subdivision. The existing lots all free discahrge. Due to existing graded slopes, the existing lot drains to the rear. The plan will direct as much of the roof flow as possible to the adjacent roadway. The roadway drains south to a swale inpark to the

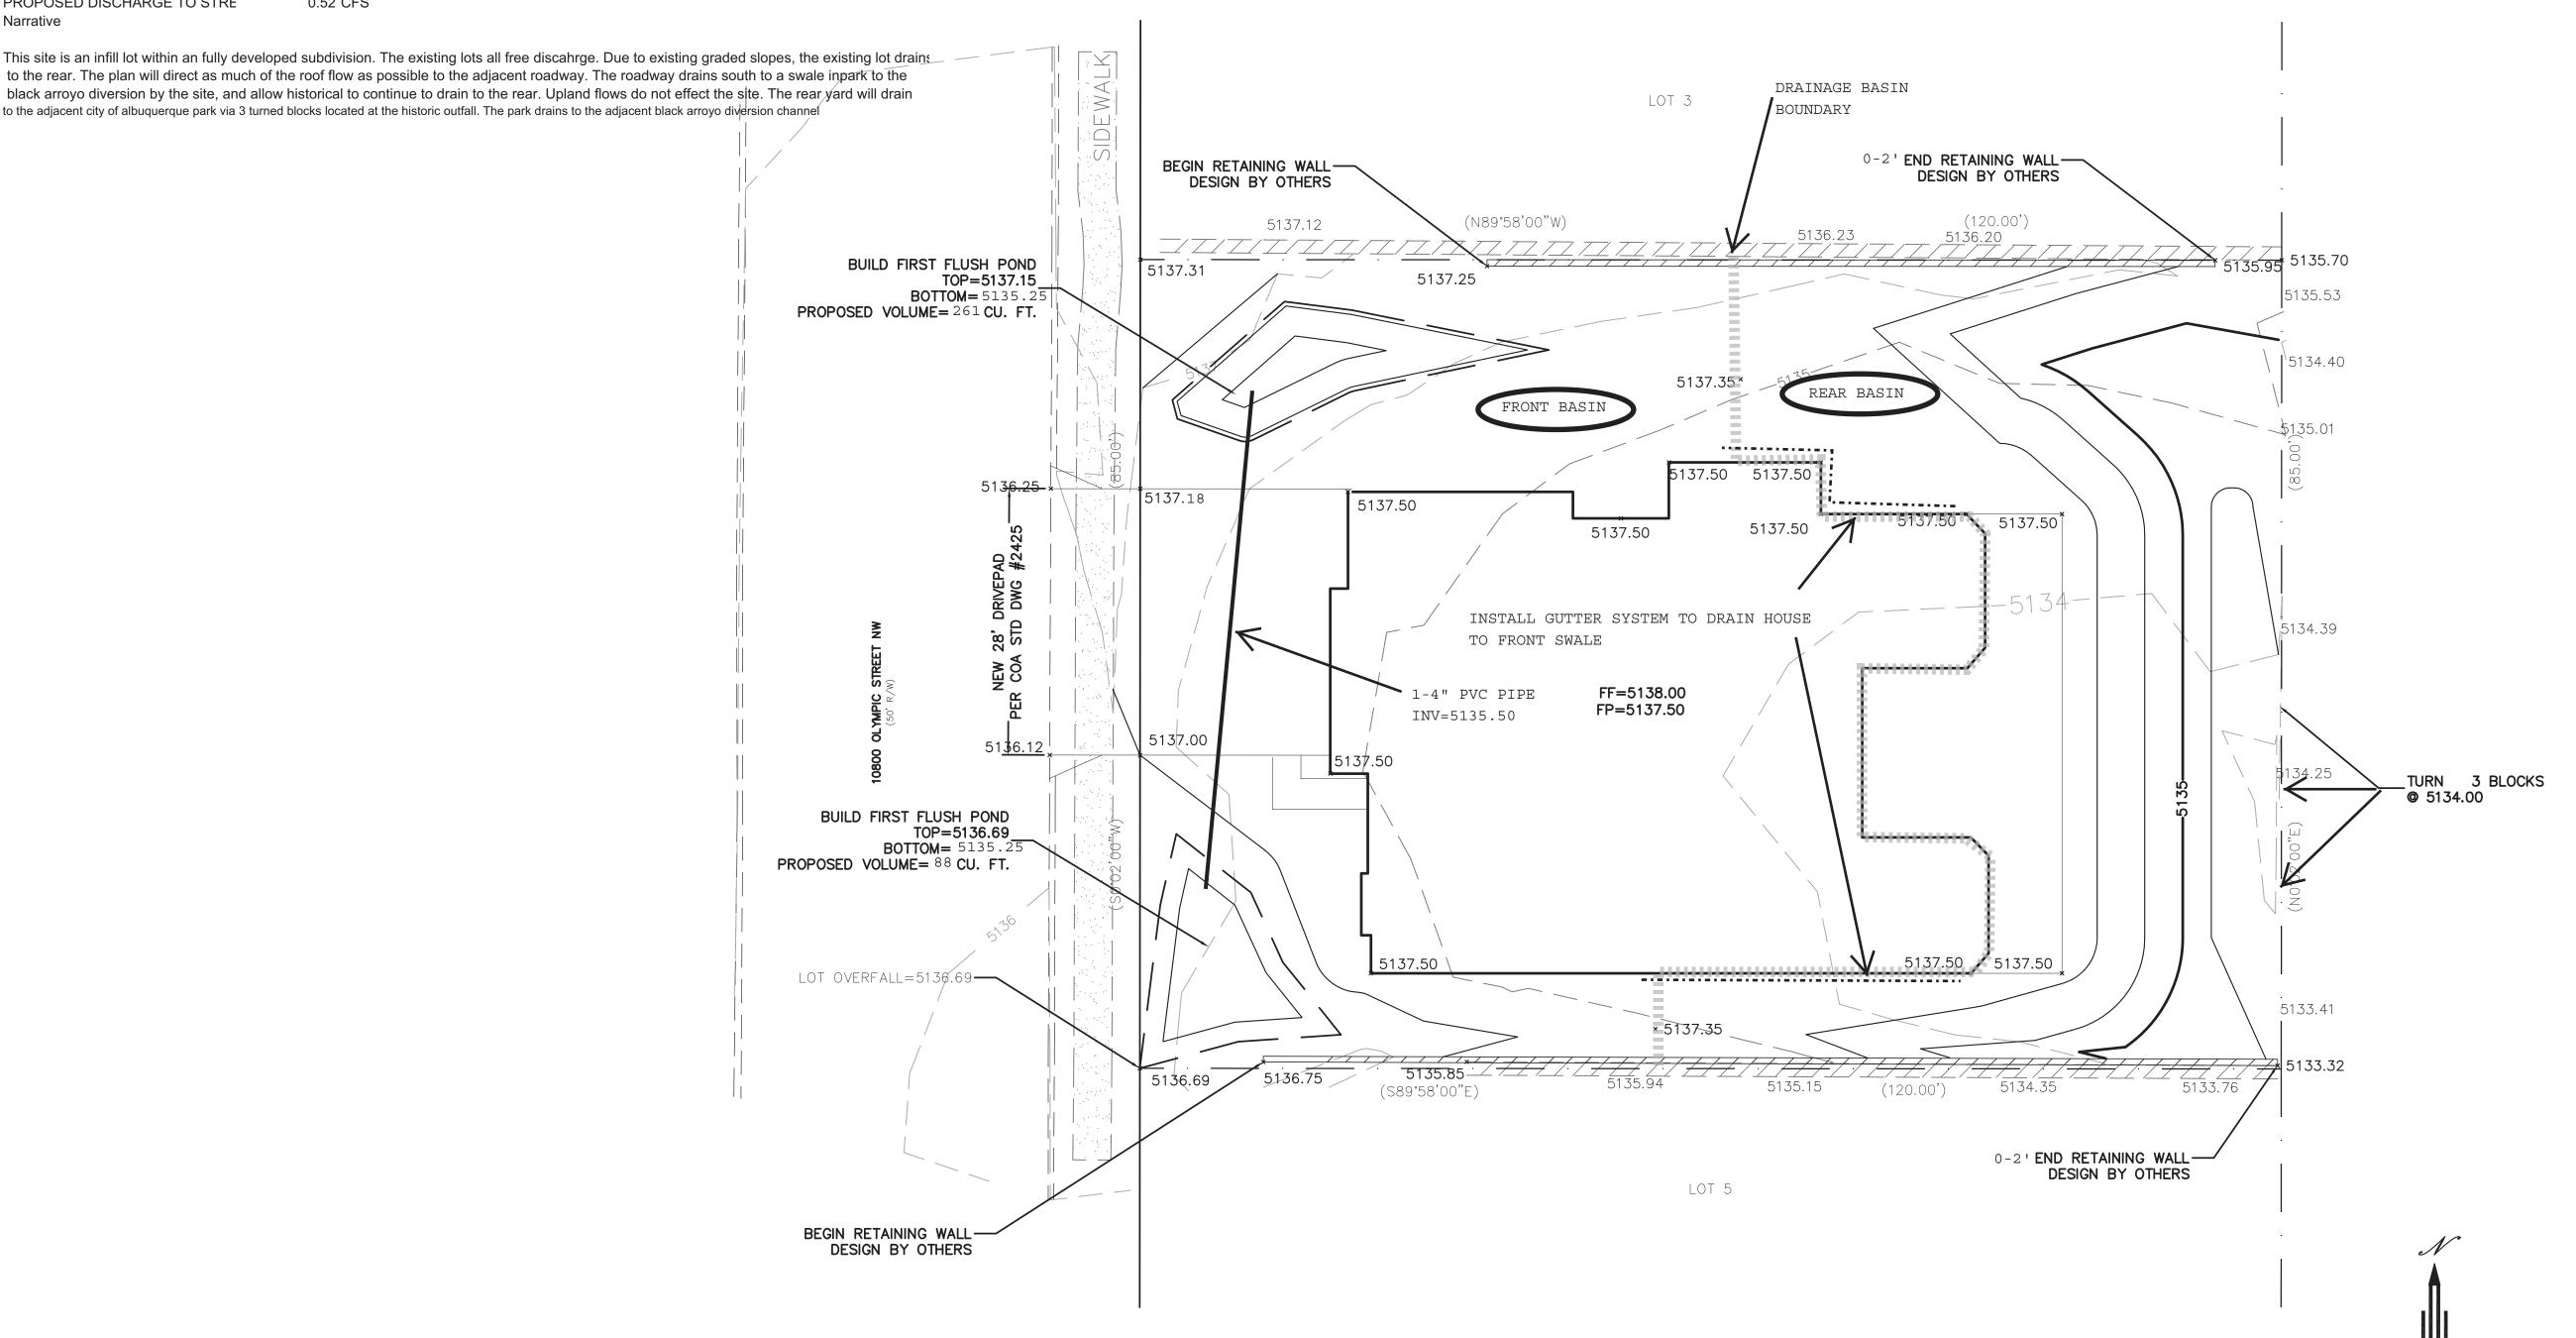


CAUTION: EXISTING UTILITIES ARE NOT SHOWN. IT SHALL BE THE SOLE RESPONSIBILITY OF THE CONTRACTOR TO CONDUCT ALL NECESSARY FIELD INVESTIGATIONS PRIOR TO ANY EXCAVATION TO DETERMINE THE ACTUAL LOCATION OF UTILITIES & OTHER IMPROVEMENTS.

## EROSION CONTROL NOTES:

INTO EXISTING RIGHT-OF-WAY.

- 1. CONTRACTOR IS RESPONSIBLE FOR OBTAINING A TOPSOIL DISTURBANCE PERMIT PRIOR TO BEGINNING WORK.
- 2. CONTRACTOR IS RESPONSIBLE FOR MAINTAINING RUN-OFF ON SITE DURING CONSTRUCTION.
- 3. CONTRACTOR IS RESPONSIBLE FOR CLEANING ALL SEDIMENT THAT GETS
- 4. REPAIR OF DAMAGED FACILITIES AND CLEANUP OF SEDIMENT
- ACCUMULATIONS ON ADJACENT PROPERTIES AND IN PUBLIC FACILITIES IS THE RESPONSIBILITY OF THE CONTRACTOR.
- 5. ALL EXPOSED EARTH SURFACES MUST BE PROTECTED FROM WIND AND WATER EROSION PRIOR TO FINAL ACCEPTANCE OF ANY PROJECT.

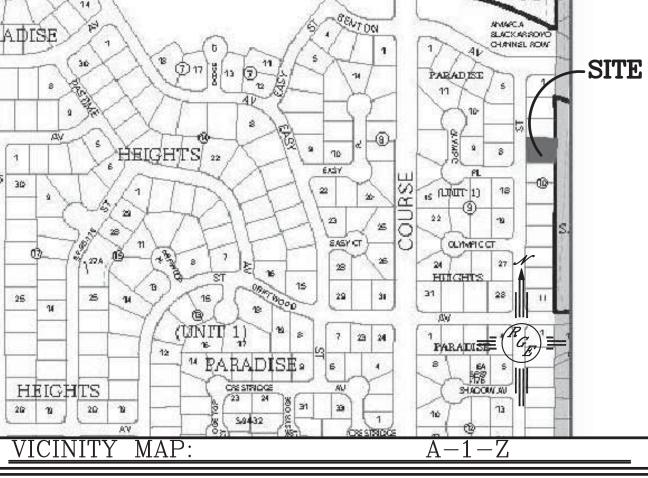


O. 21s Annual Charter Flesch Haubrig, Jero S of 11s entwell charter flesch wich everage depth less that are flesch wich (Califoge erros of less than and souther mile, John X

Digital Data Available

Unmepper

Ne Digi of Dero Avoilable

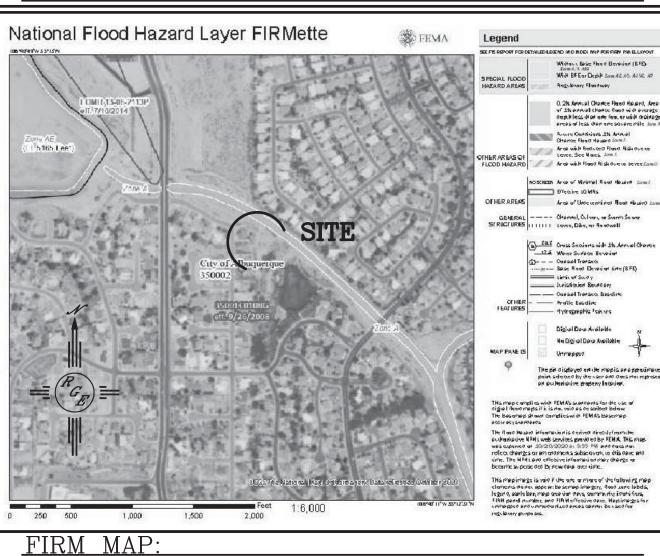

LEGAL DESCRIPTION: LOT 4, BLOCK 10 PARADISE HEIGHTS, UNIT ONE

1. ALL SPOT ELEVATIONS REPRESENT FLOWLINE ELEVATION UNLESS OTHERWISE


2. ALL SLOPES SHALL BE 3:1 MAX. AND GRAVEL OR NATIVE SEEDING PRIOR TO CO.

3. HOUSE SHALL HAVE ROOF GUTTER SYSTEM TO DRAIN TO WEST. REAR PORCH TO DRAIN TO REAR


## LEGEND

EXISTING CONTOUR \_\_\_\_ \_\_\_XXXX\_\_\_\_ \_\_\_\_ --- --- EXISTING INDEX CONTOUR — PROPOSED CONTOUR PROPOSED INDEX CONTOUR SLOPE TIE EXISTING SPOT ELEVATION × XXXX x XXXX PROPOSED SPOT ELEVATION BOUNDARY CENTERLINE — RIGHT—OF—WAY  $\equiv \equiv \equiv \equiv \equiv \equiv$  Existing curb and gutter

PROPOSED CMU SCREEN WALL

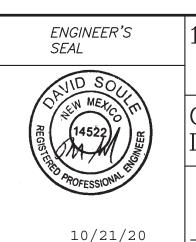

10800 OLYMPIC	DRAWN BY WCWJ
	DATE
GRADING AND	10-21-20
DRAINAGE PLAN	2102084-LAYOUT-10-21-20

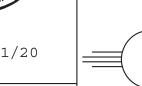



SHEET #

\_\_\_

JOB #

2102084

DAVID SOULE P.E. #14522

SCALE: 1"=10'