
GATEWAY


CITY OF RIO RANCHO, SANDOVAL COUNTY, NEW MEXICO IMPROVEMENTS FOR GRADING AND EROSION CONTROL PLAN

INDEX TO DRAWINGS

SHEET NO.	DESCRIPTION
1	COVER SHEET AND INDEX TO DRAWINGS
2-5	PLATS OF GEOMETRY
6	GRADING AND EROSION CONTROL PLAN GATEWAY SOUTH
7-8	GRADING AND EROSION CONTROL PLAN GATEWAY NORTH
9	POND OUTFALL CROSS SECTIONS

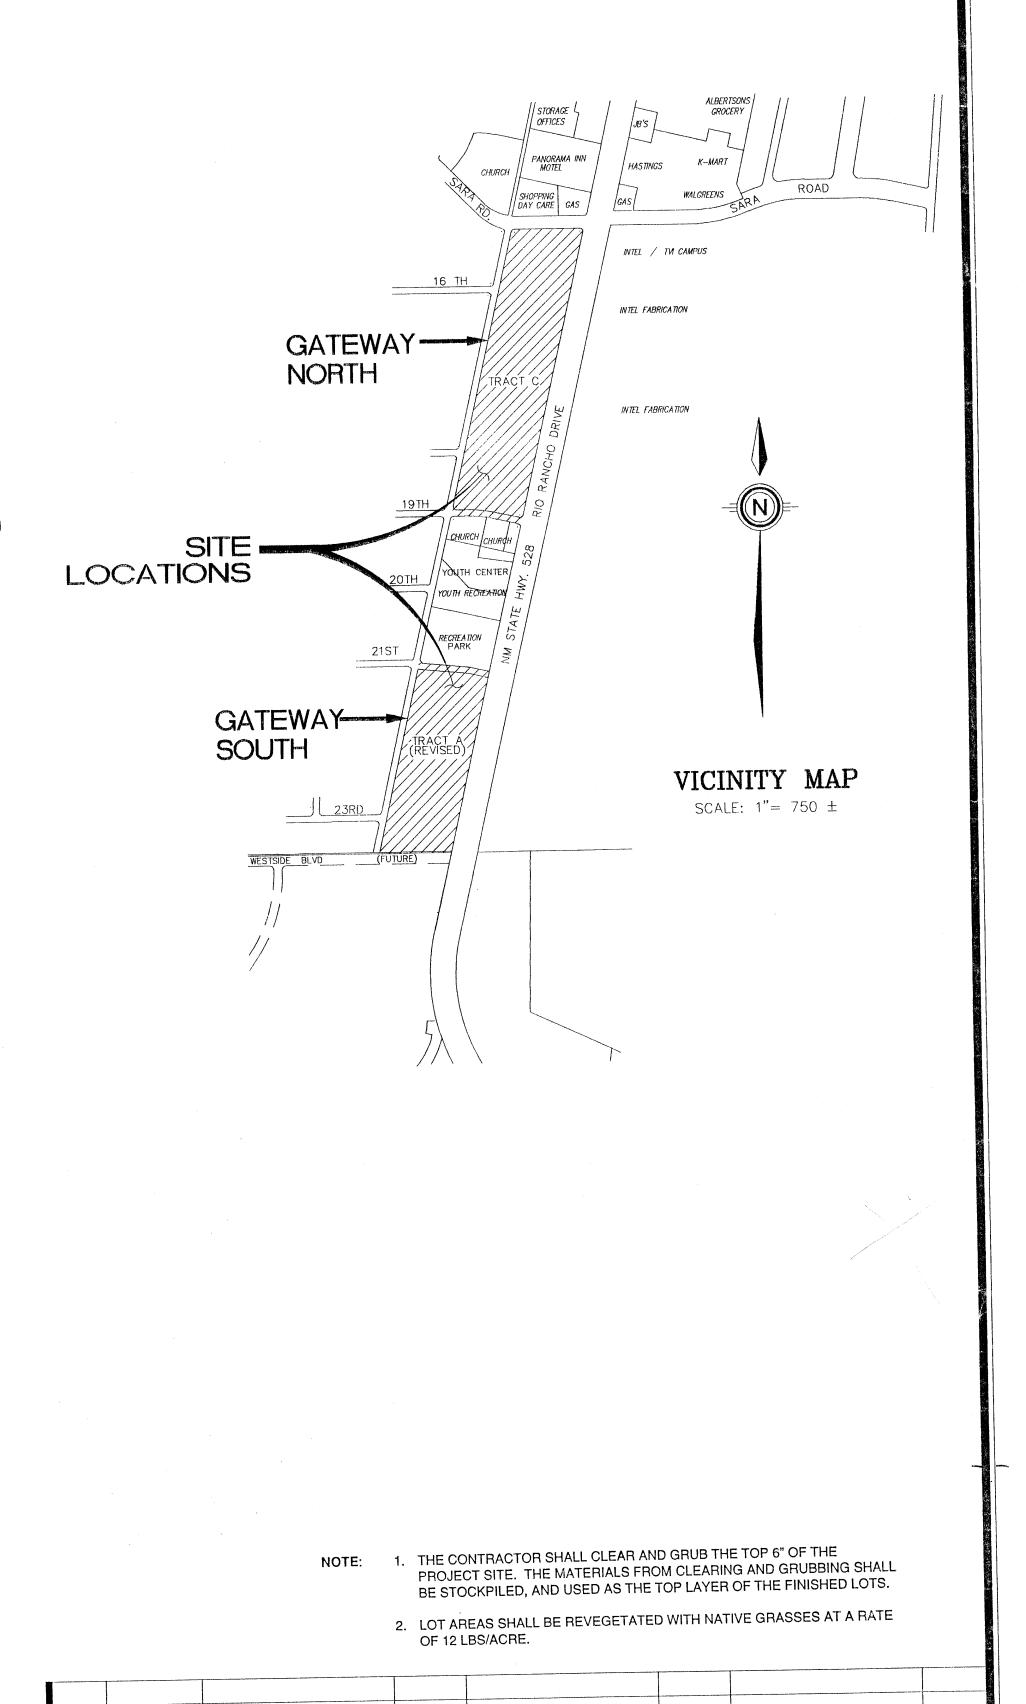

REV. SHEETS	CITY ENGINEER	DATE	USER DEF	PARTMENT	DATE	USER DEPA	RTMENT	DAT
ENGINEER'	JOALL	EB, 1994 : AS SHOWN NED: TTM, TLM		mmunit science	5	APPROVED FOR		
	JOB N	SPS 0.: 1-21-037	LAND PLANNING P.O. Box 1328	DOI atiOIA ENGINEERING Corrales,	SURVEYING N.M. 87048	CITY ENGINEER DATE		
·	PI N	ROJECT O.				SHEET	1 of	8

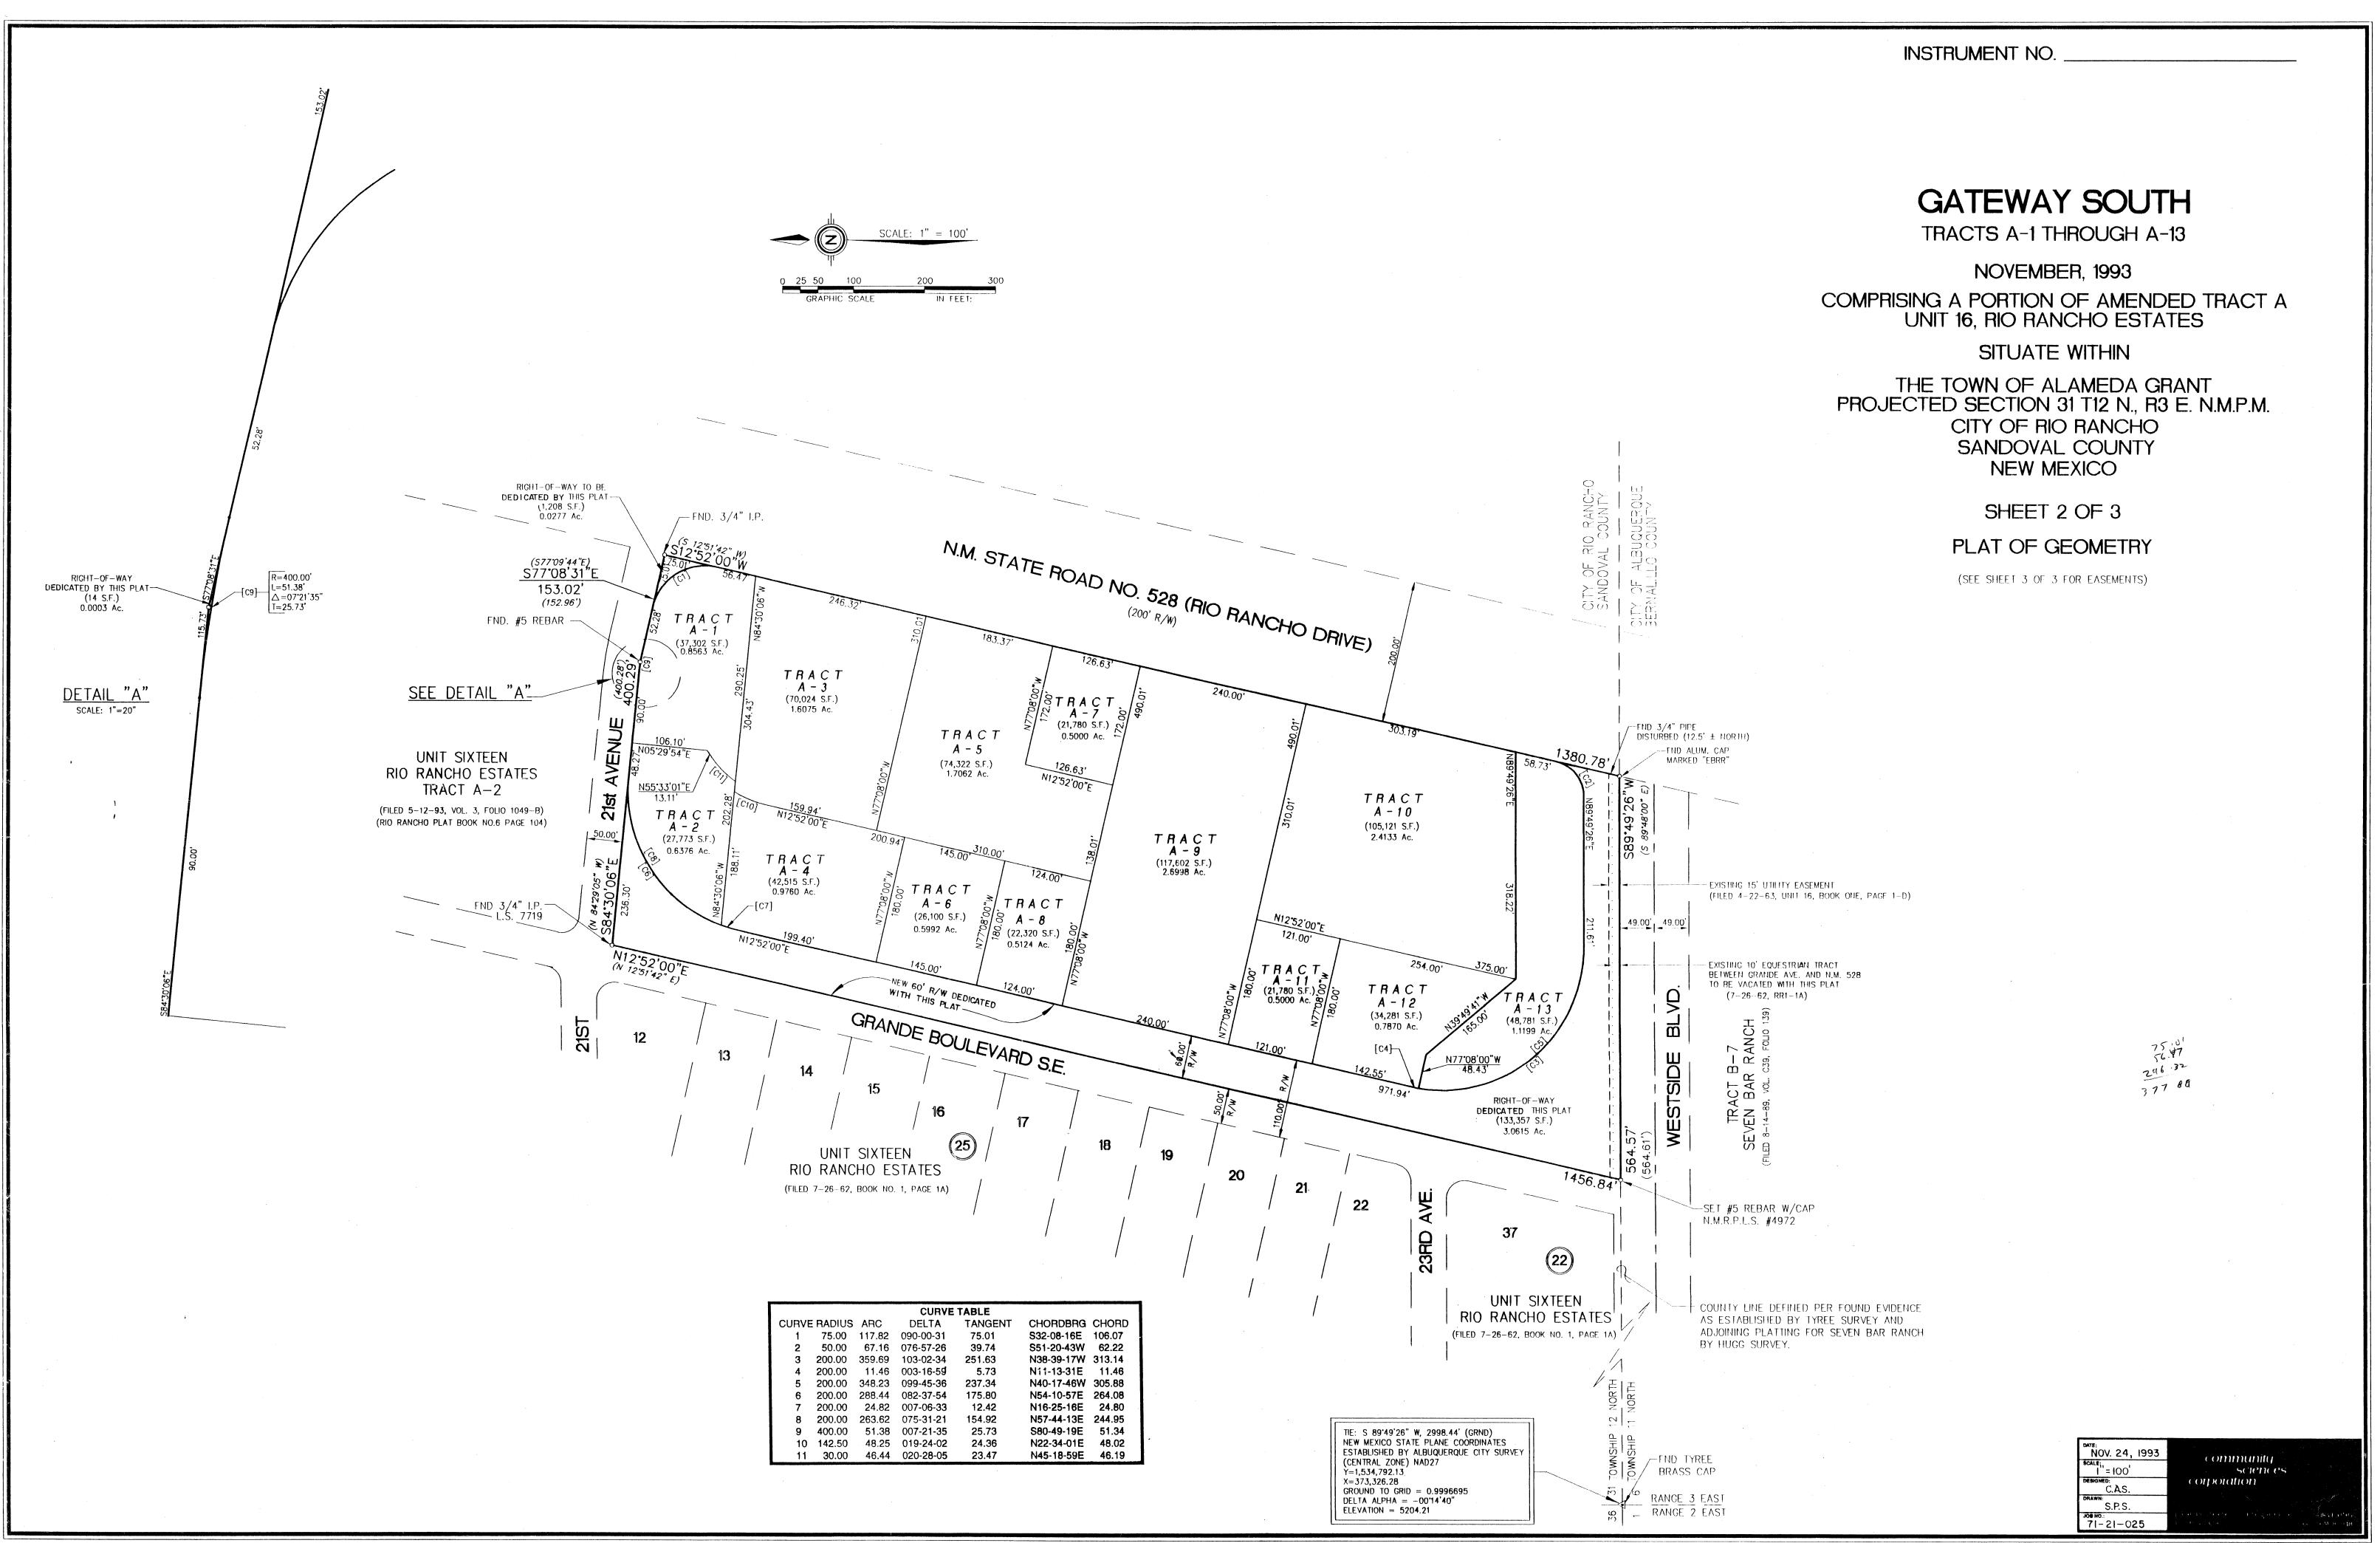


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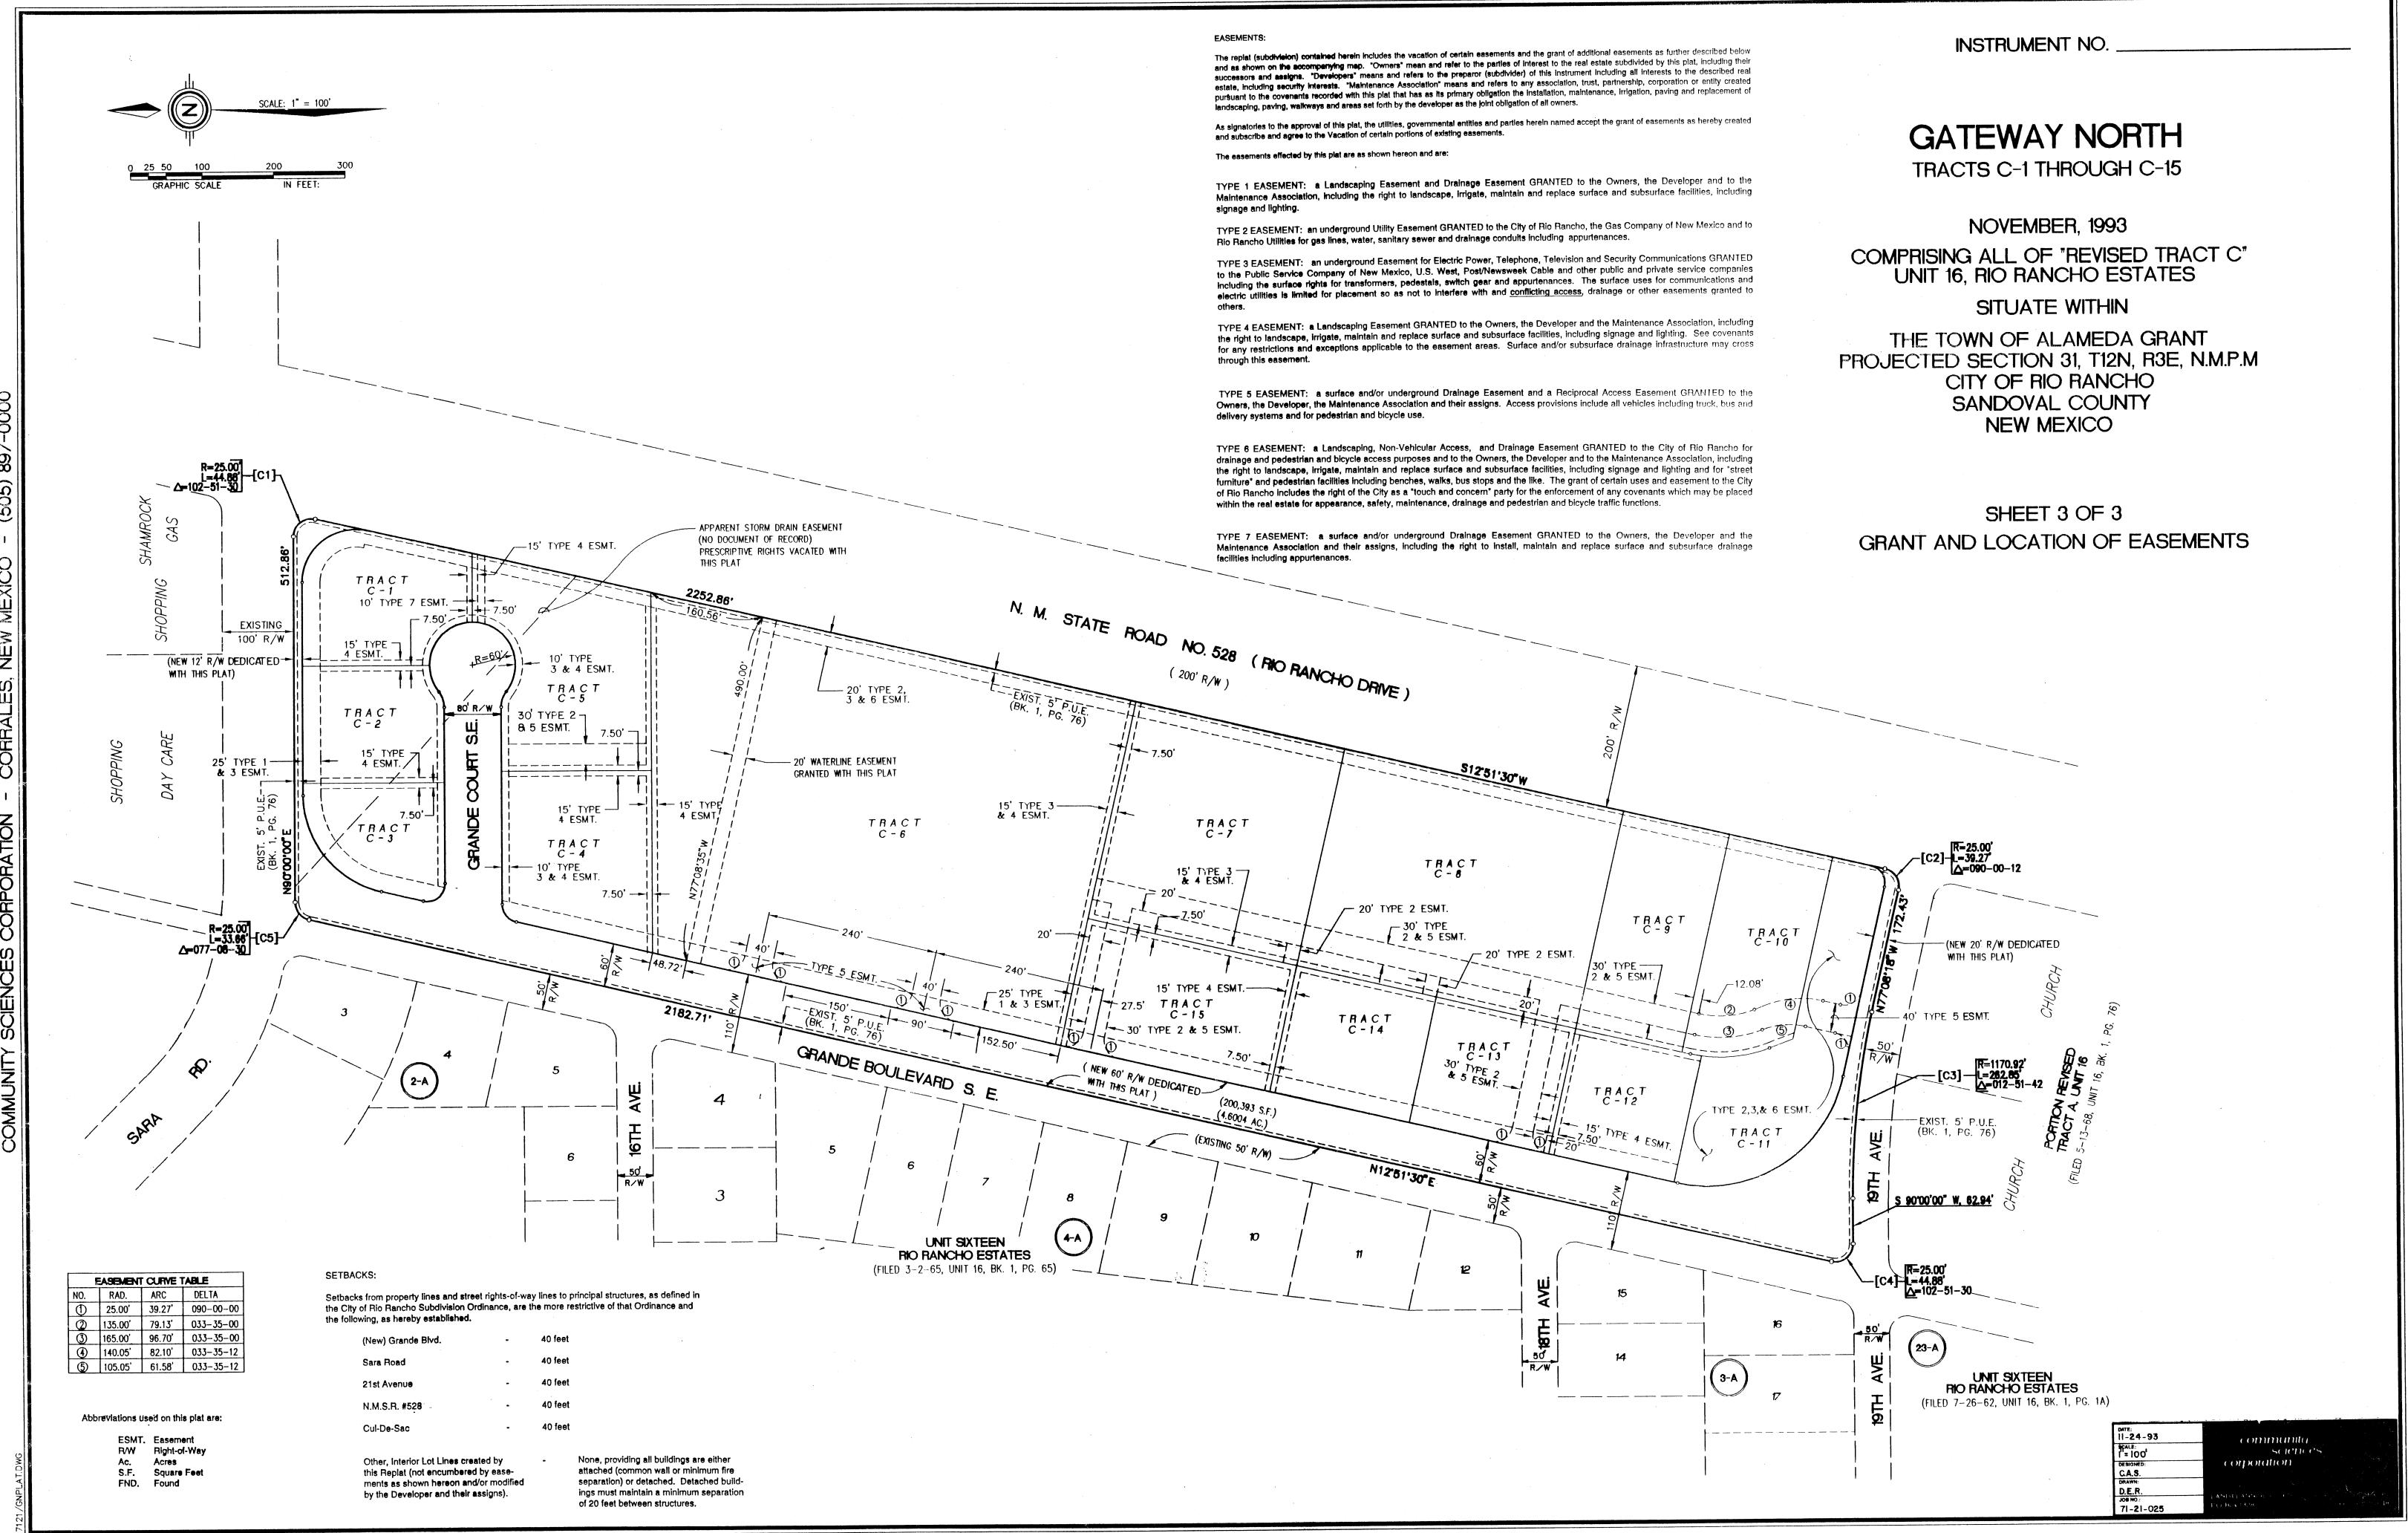
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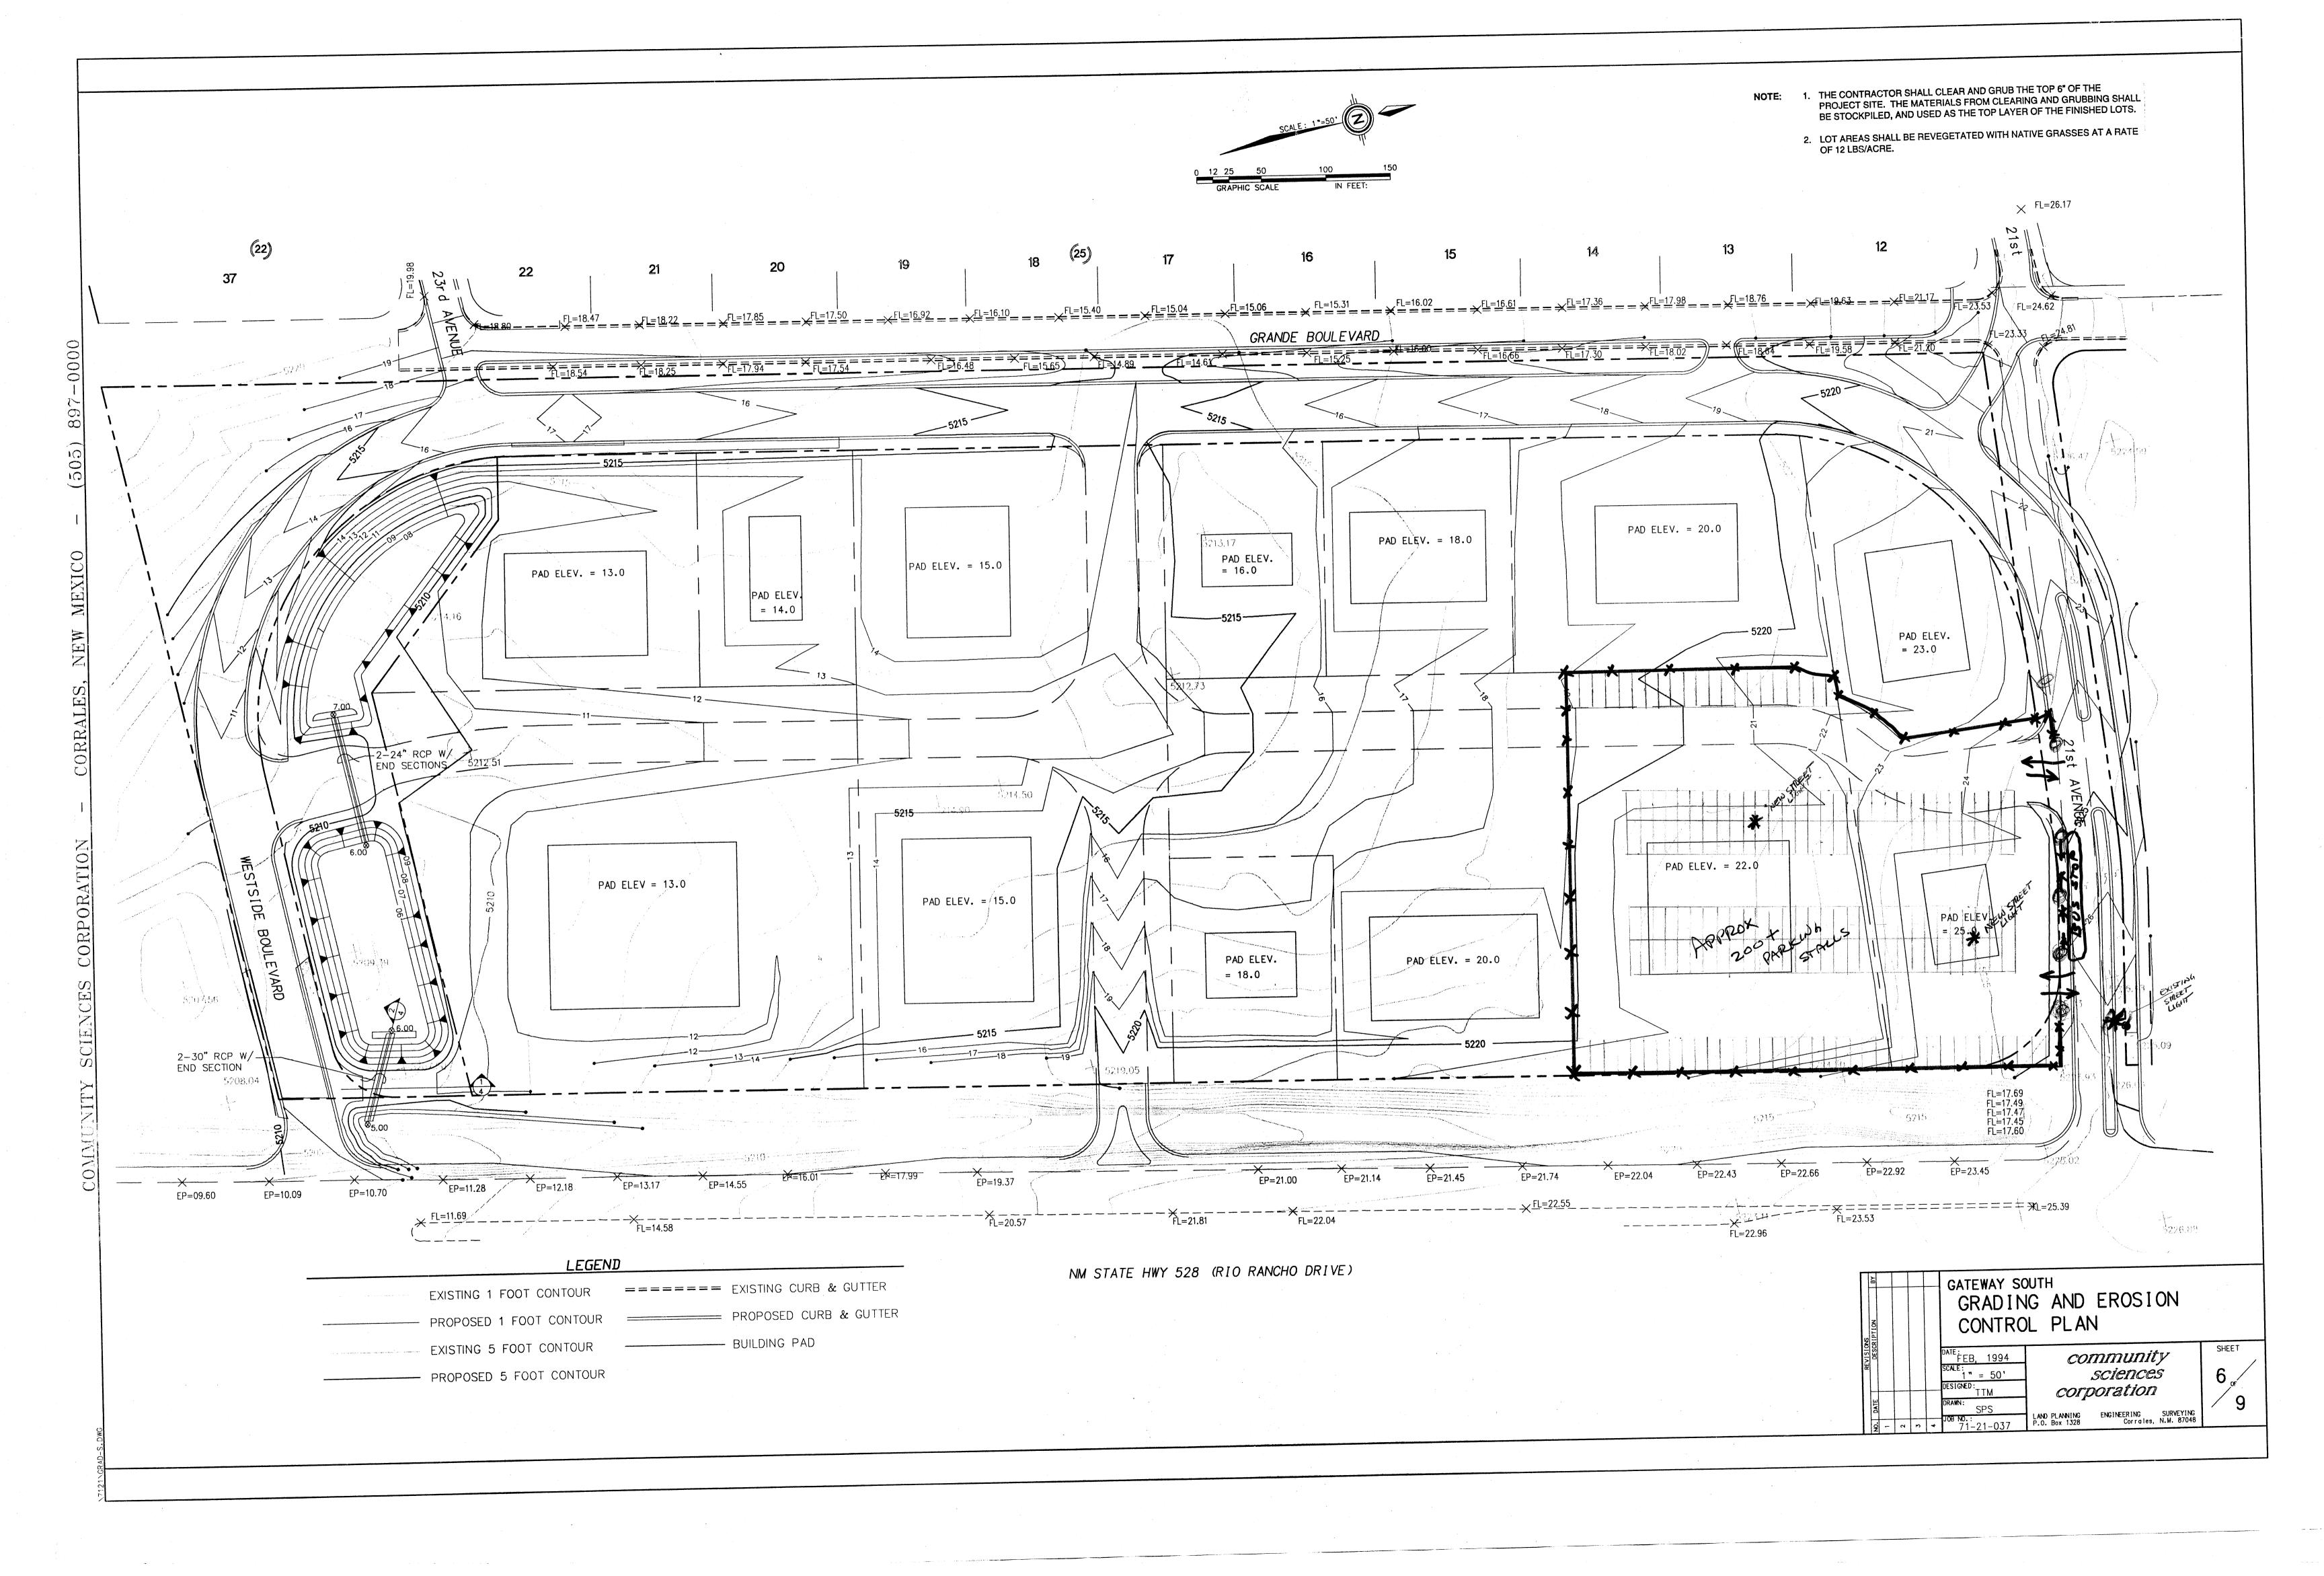
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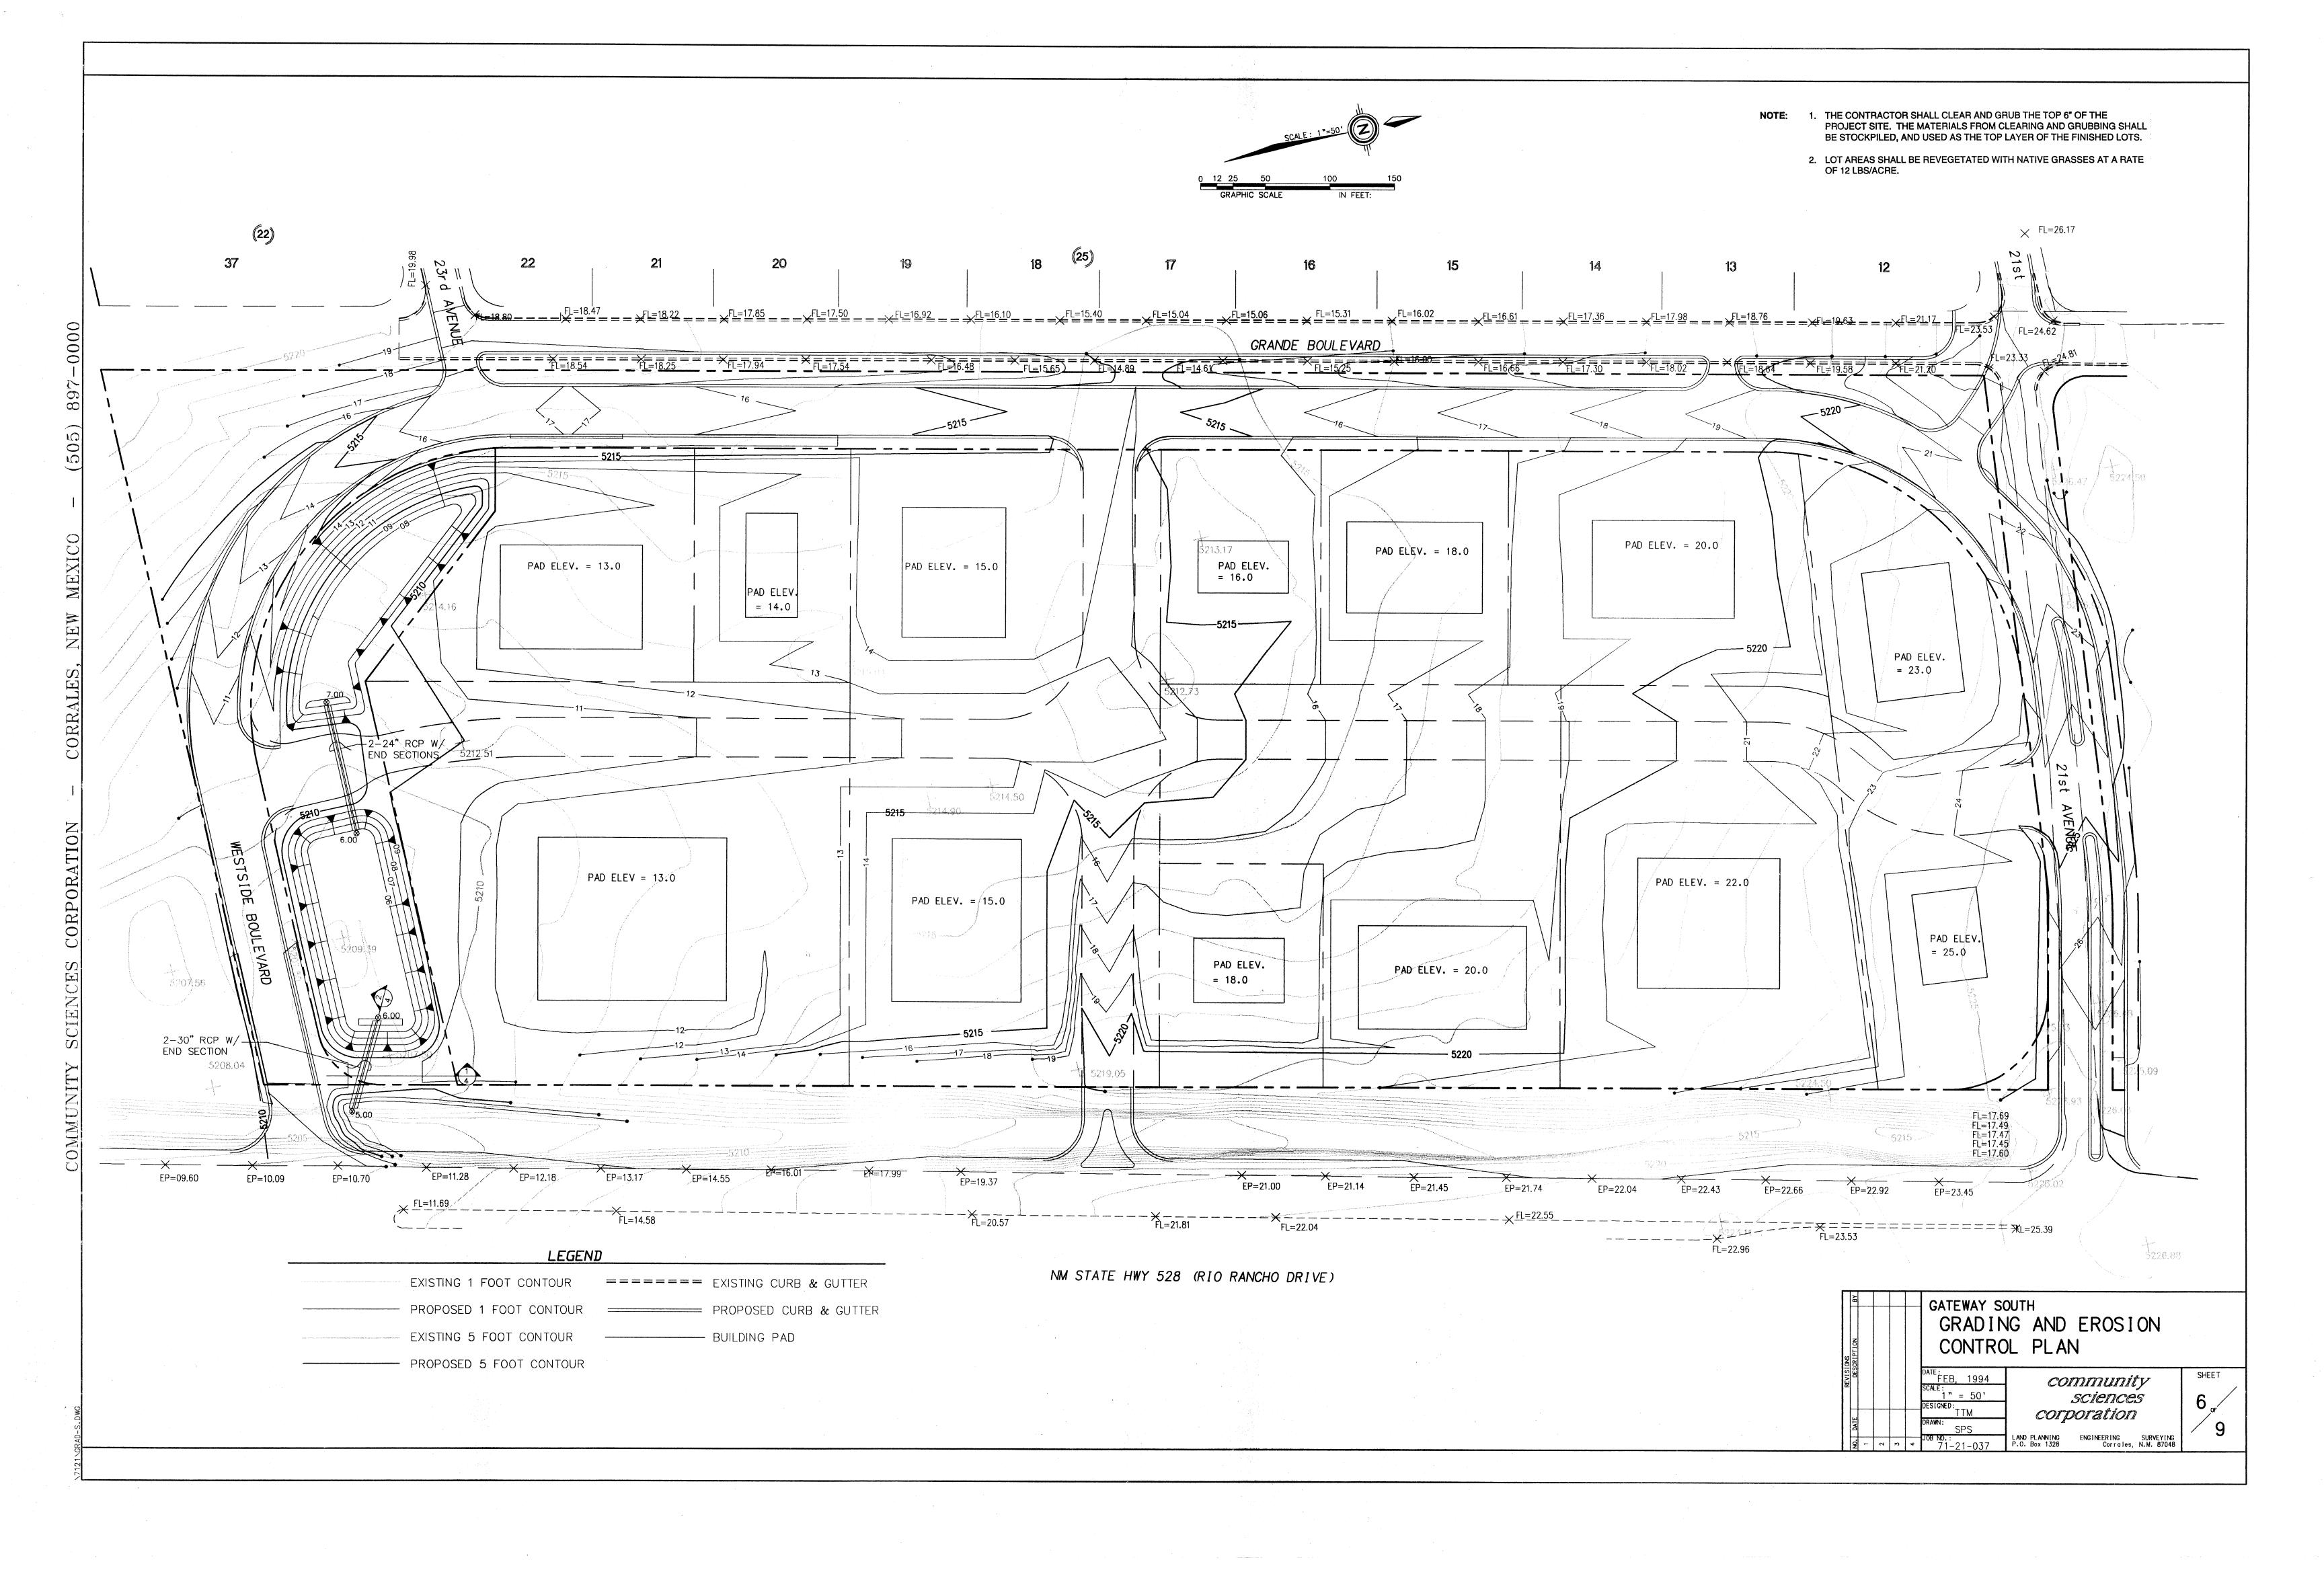
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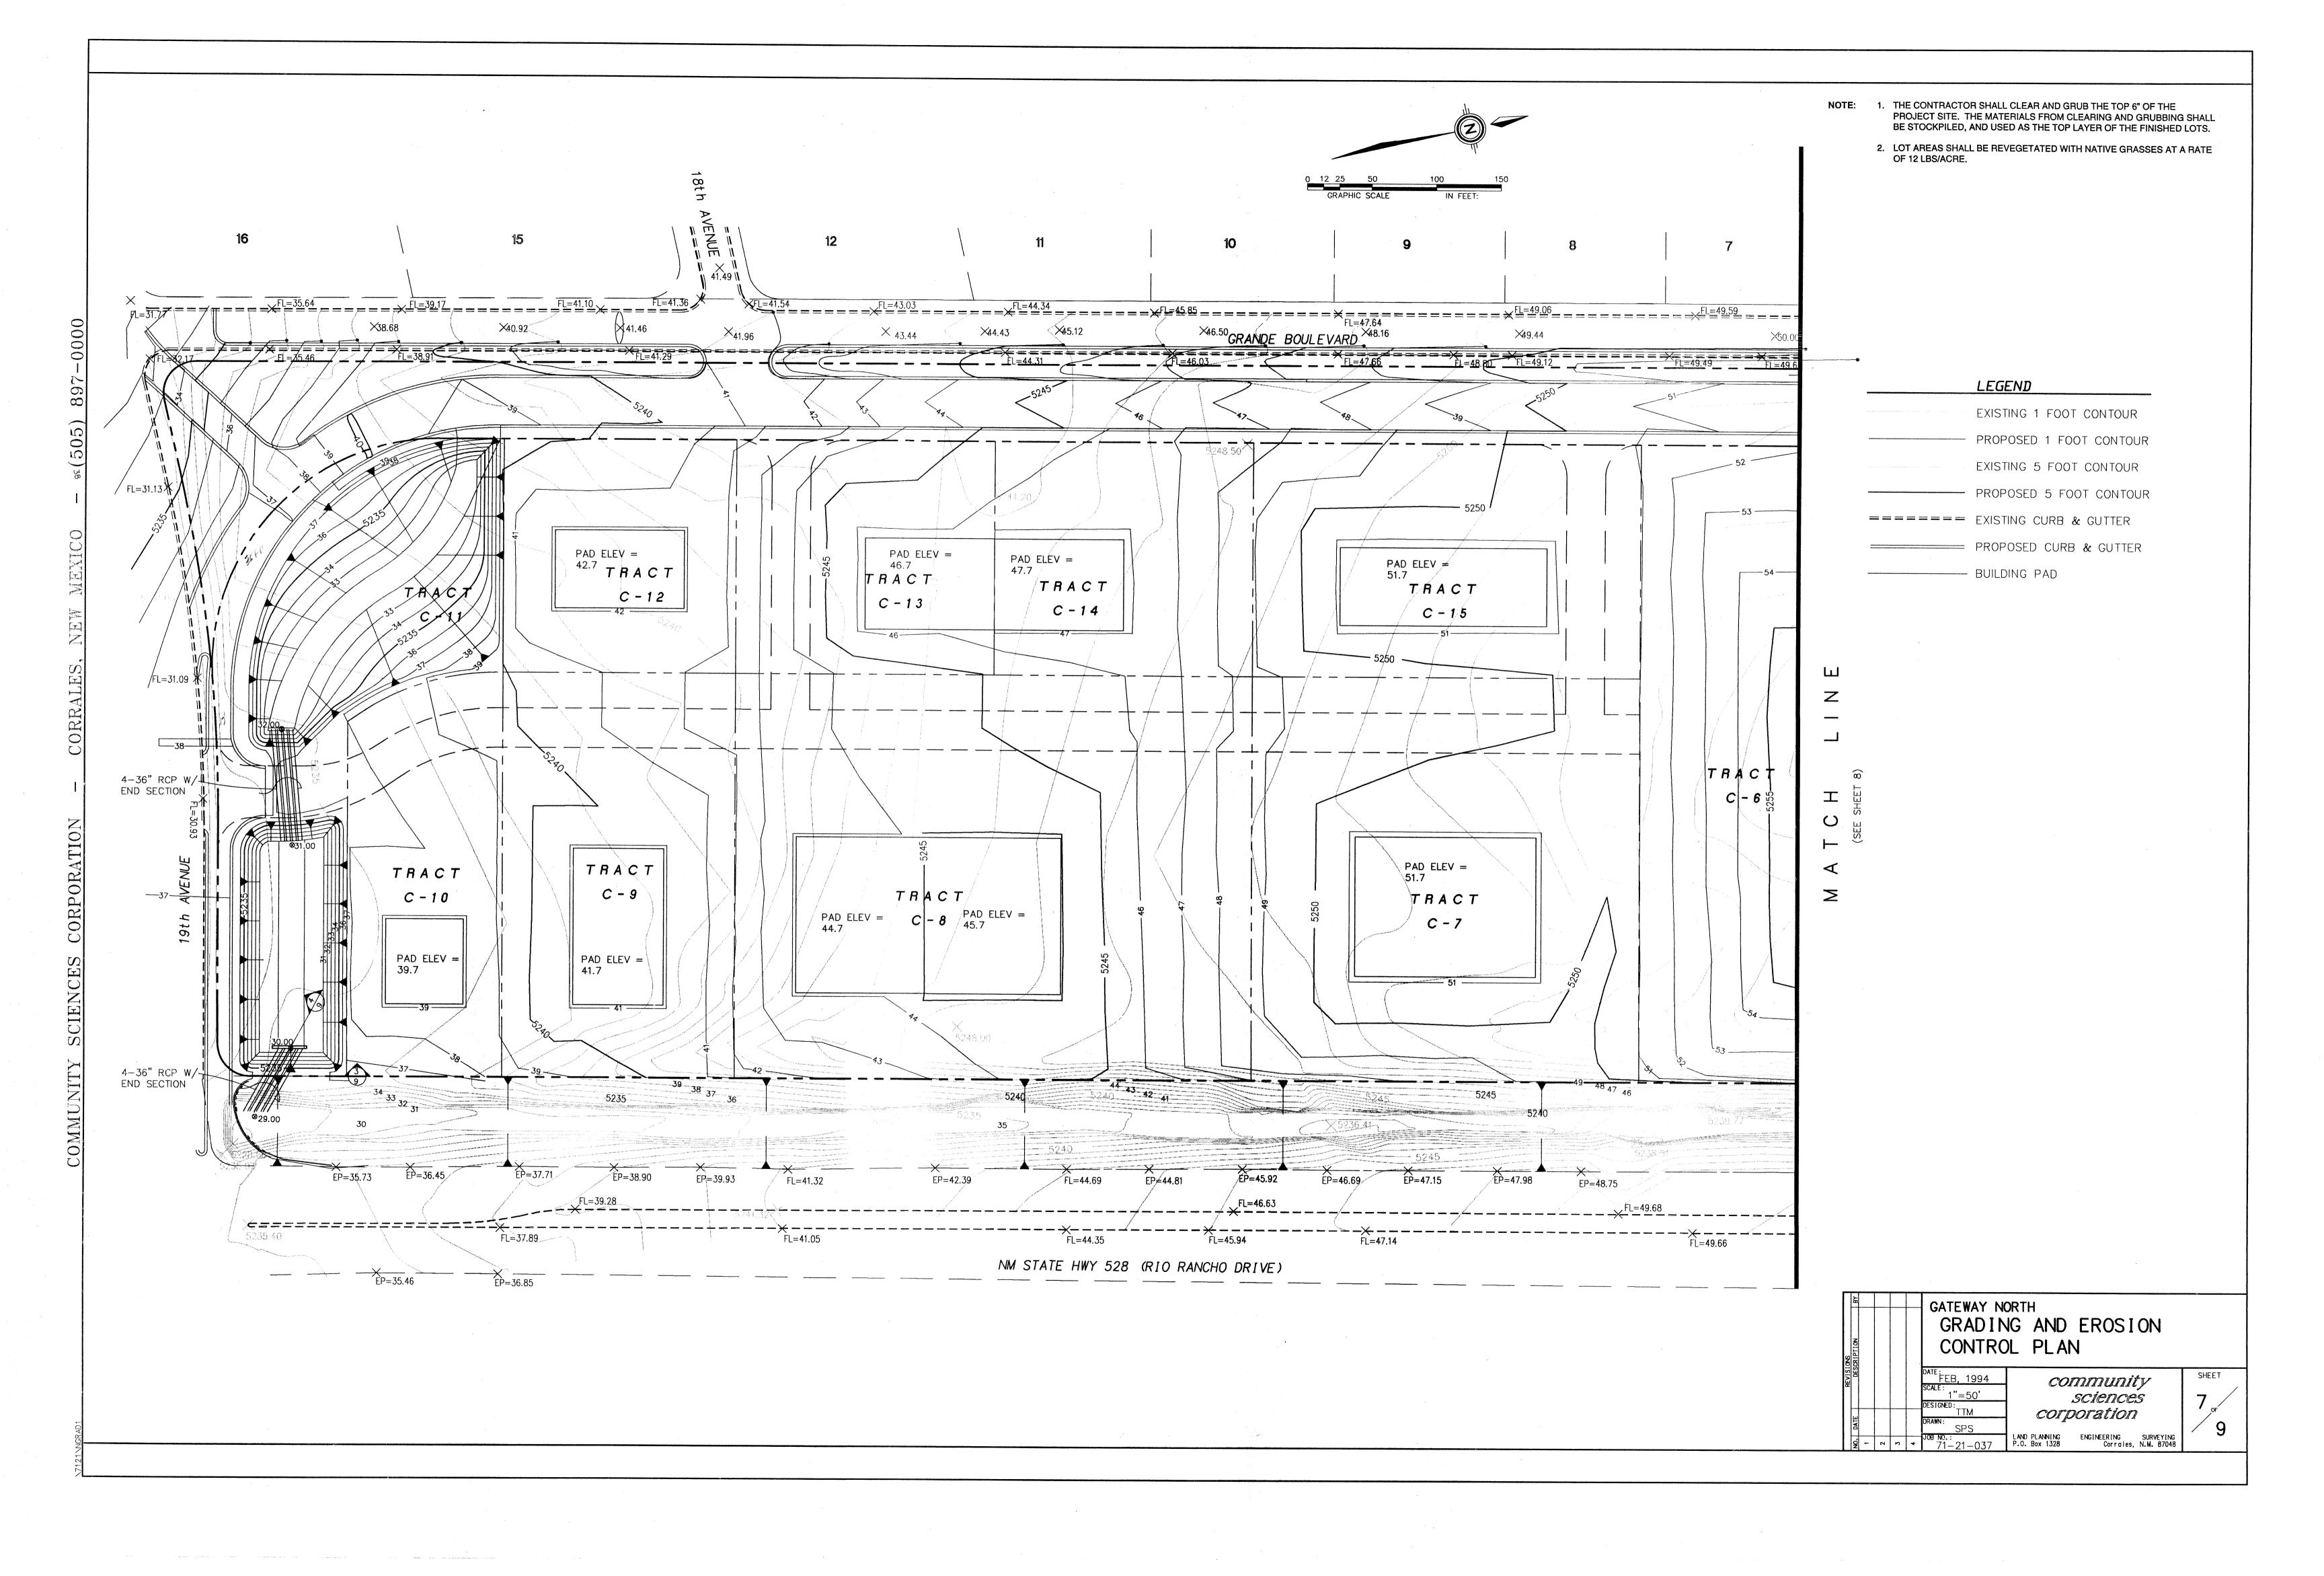
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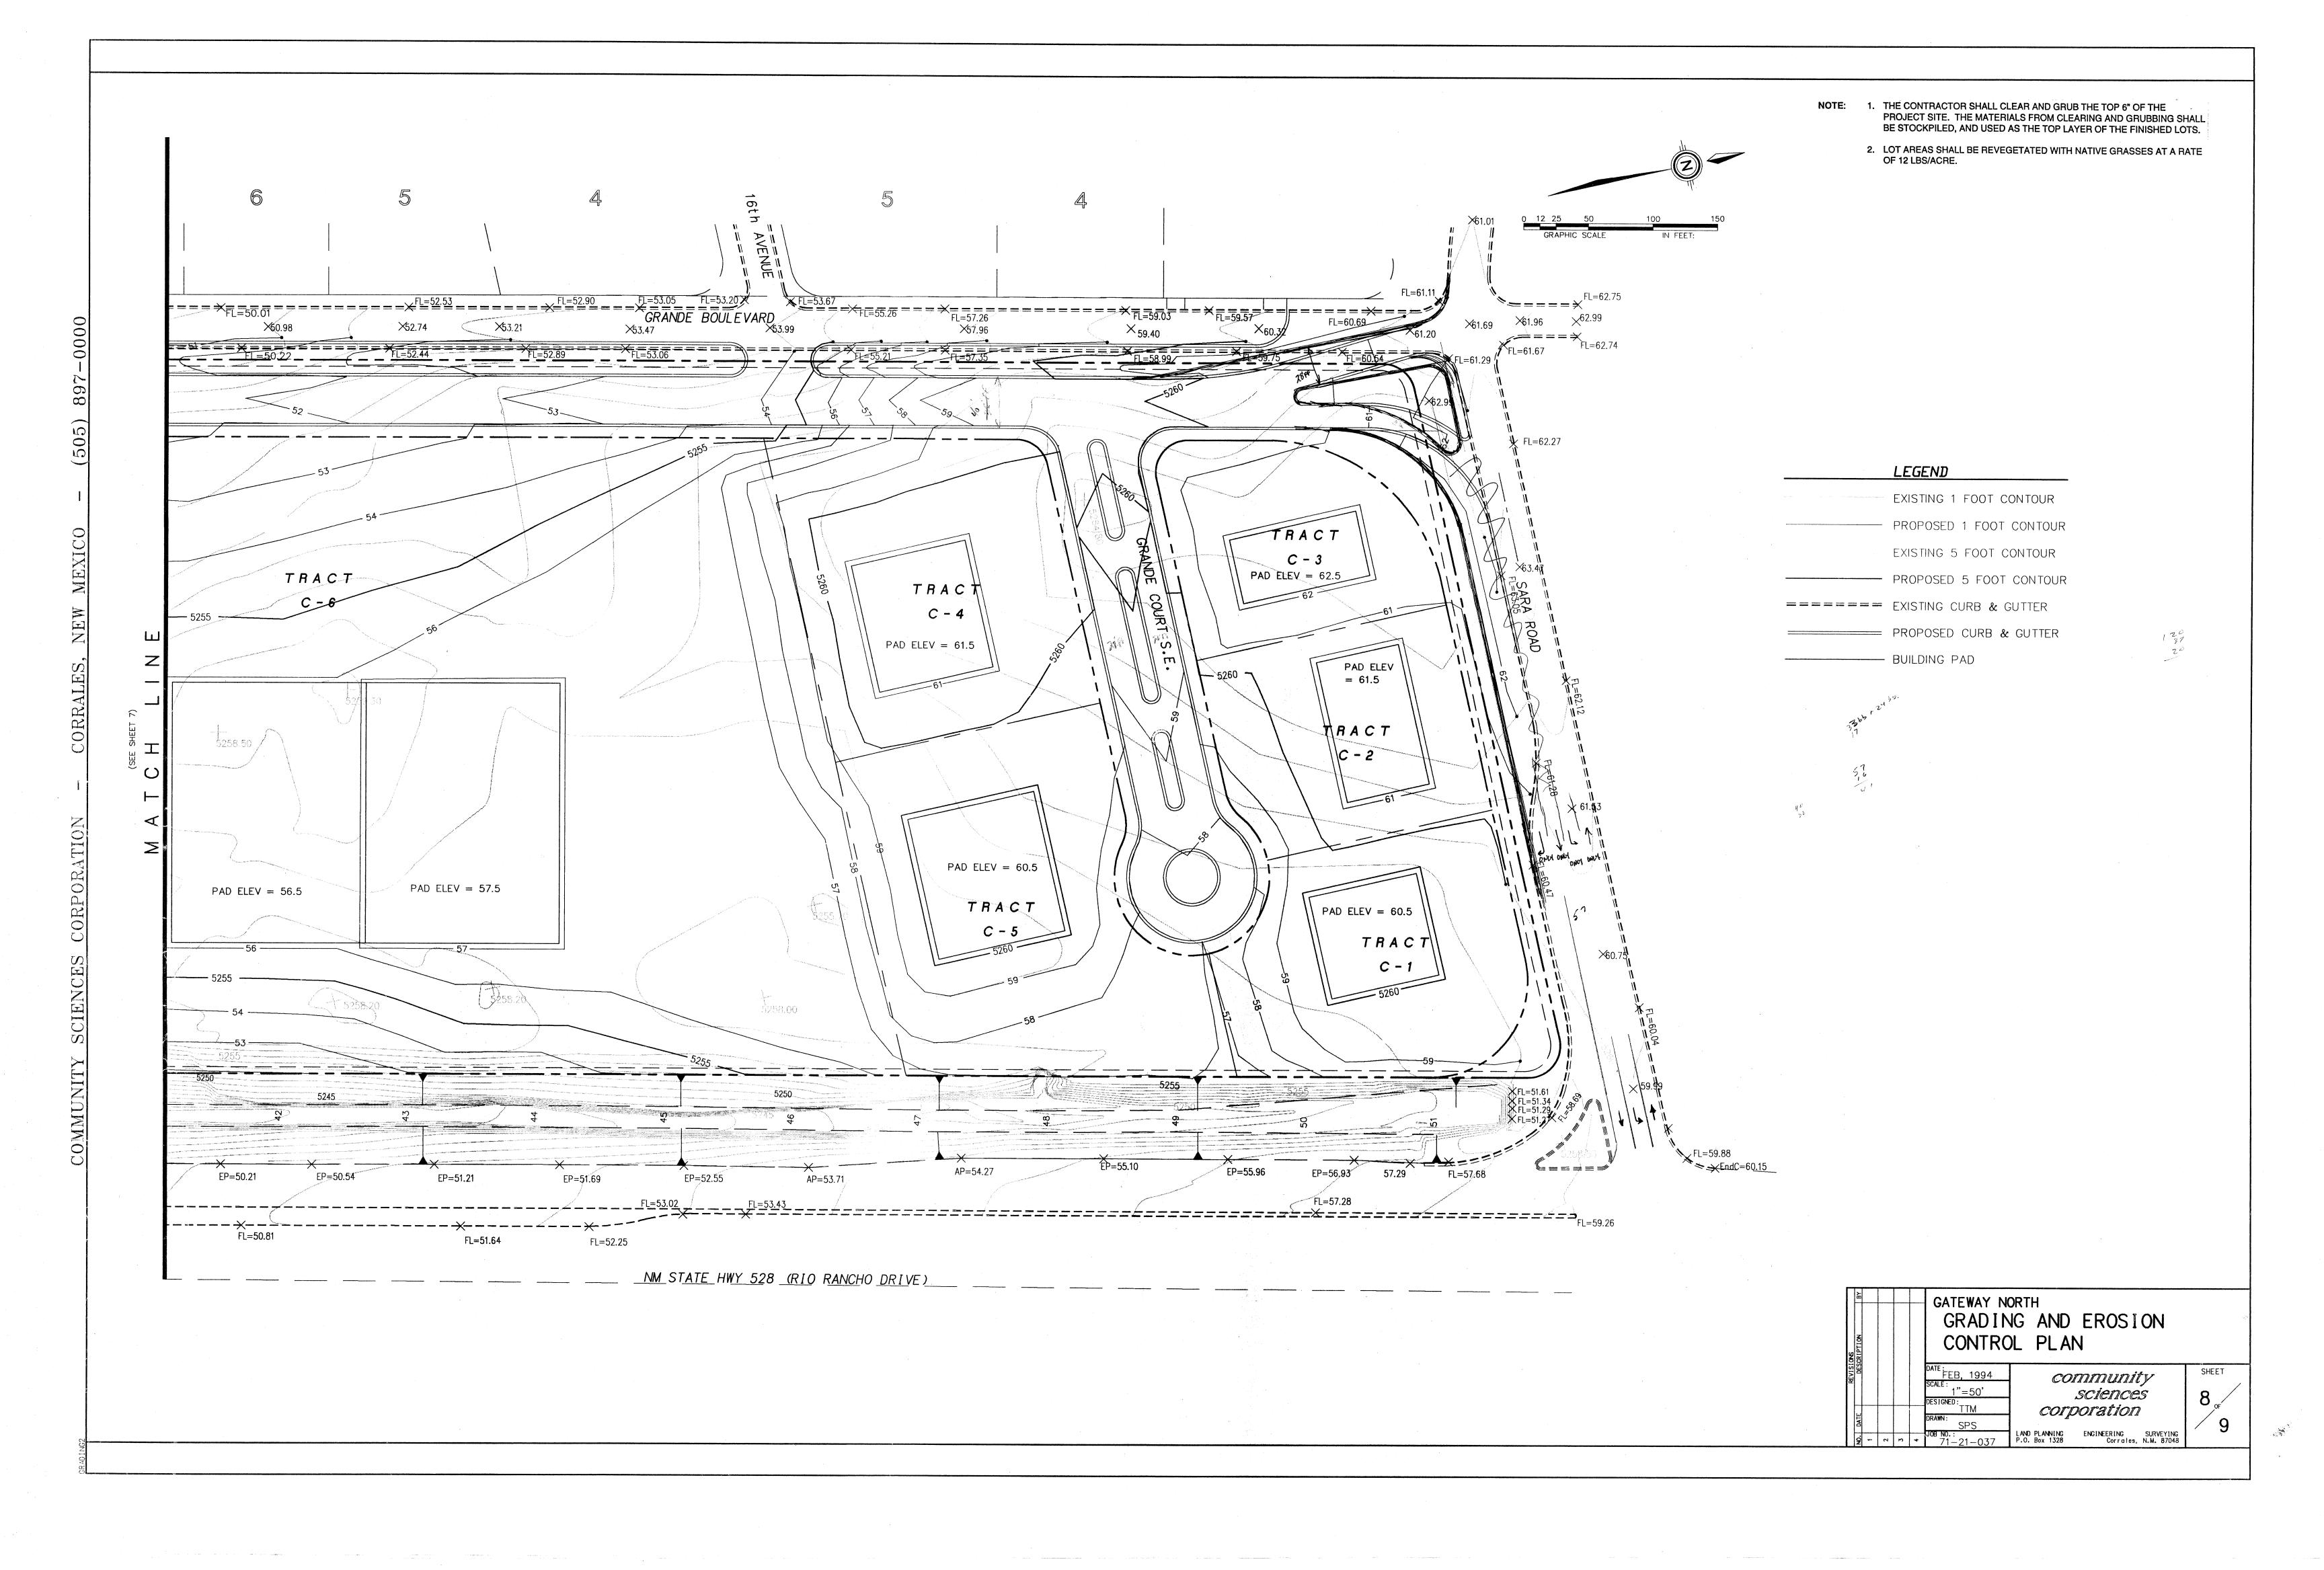













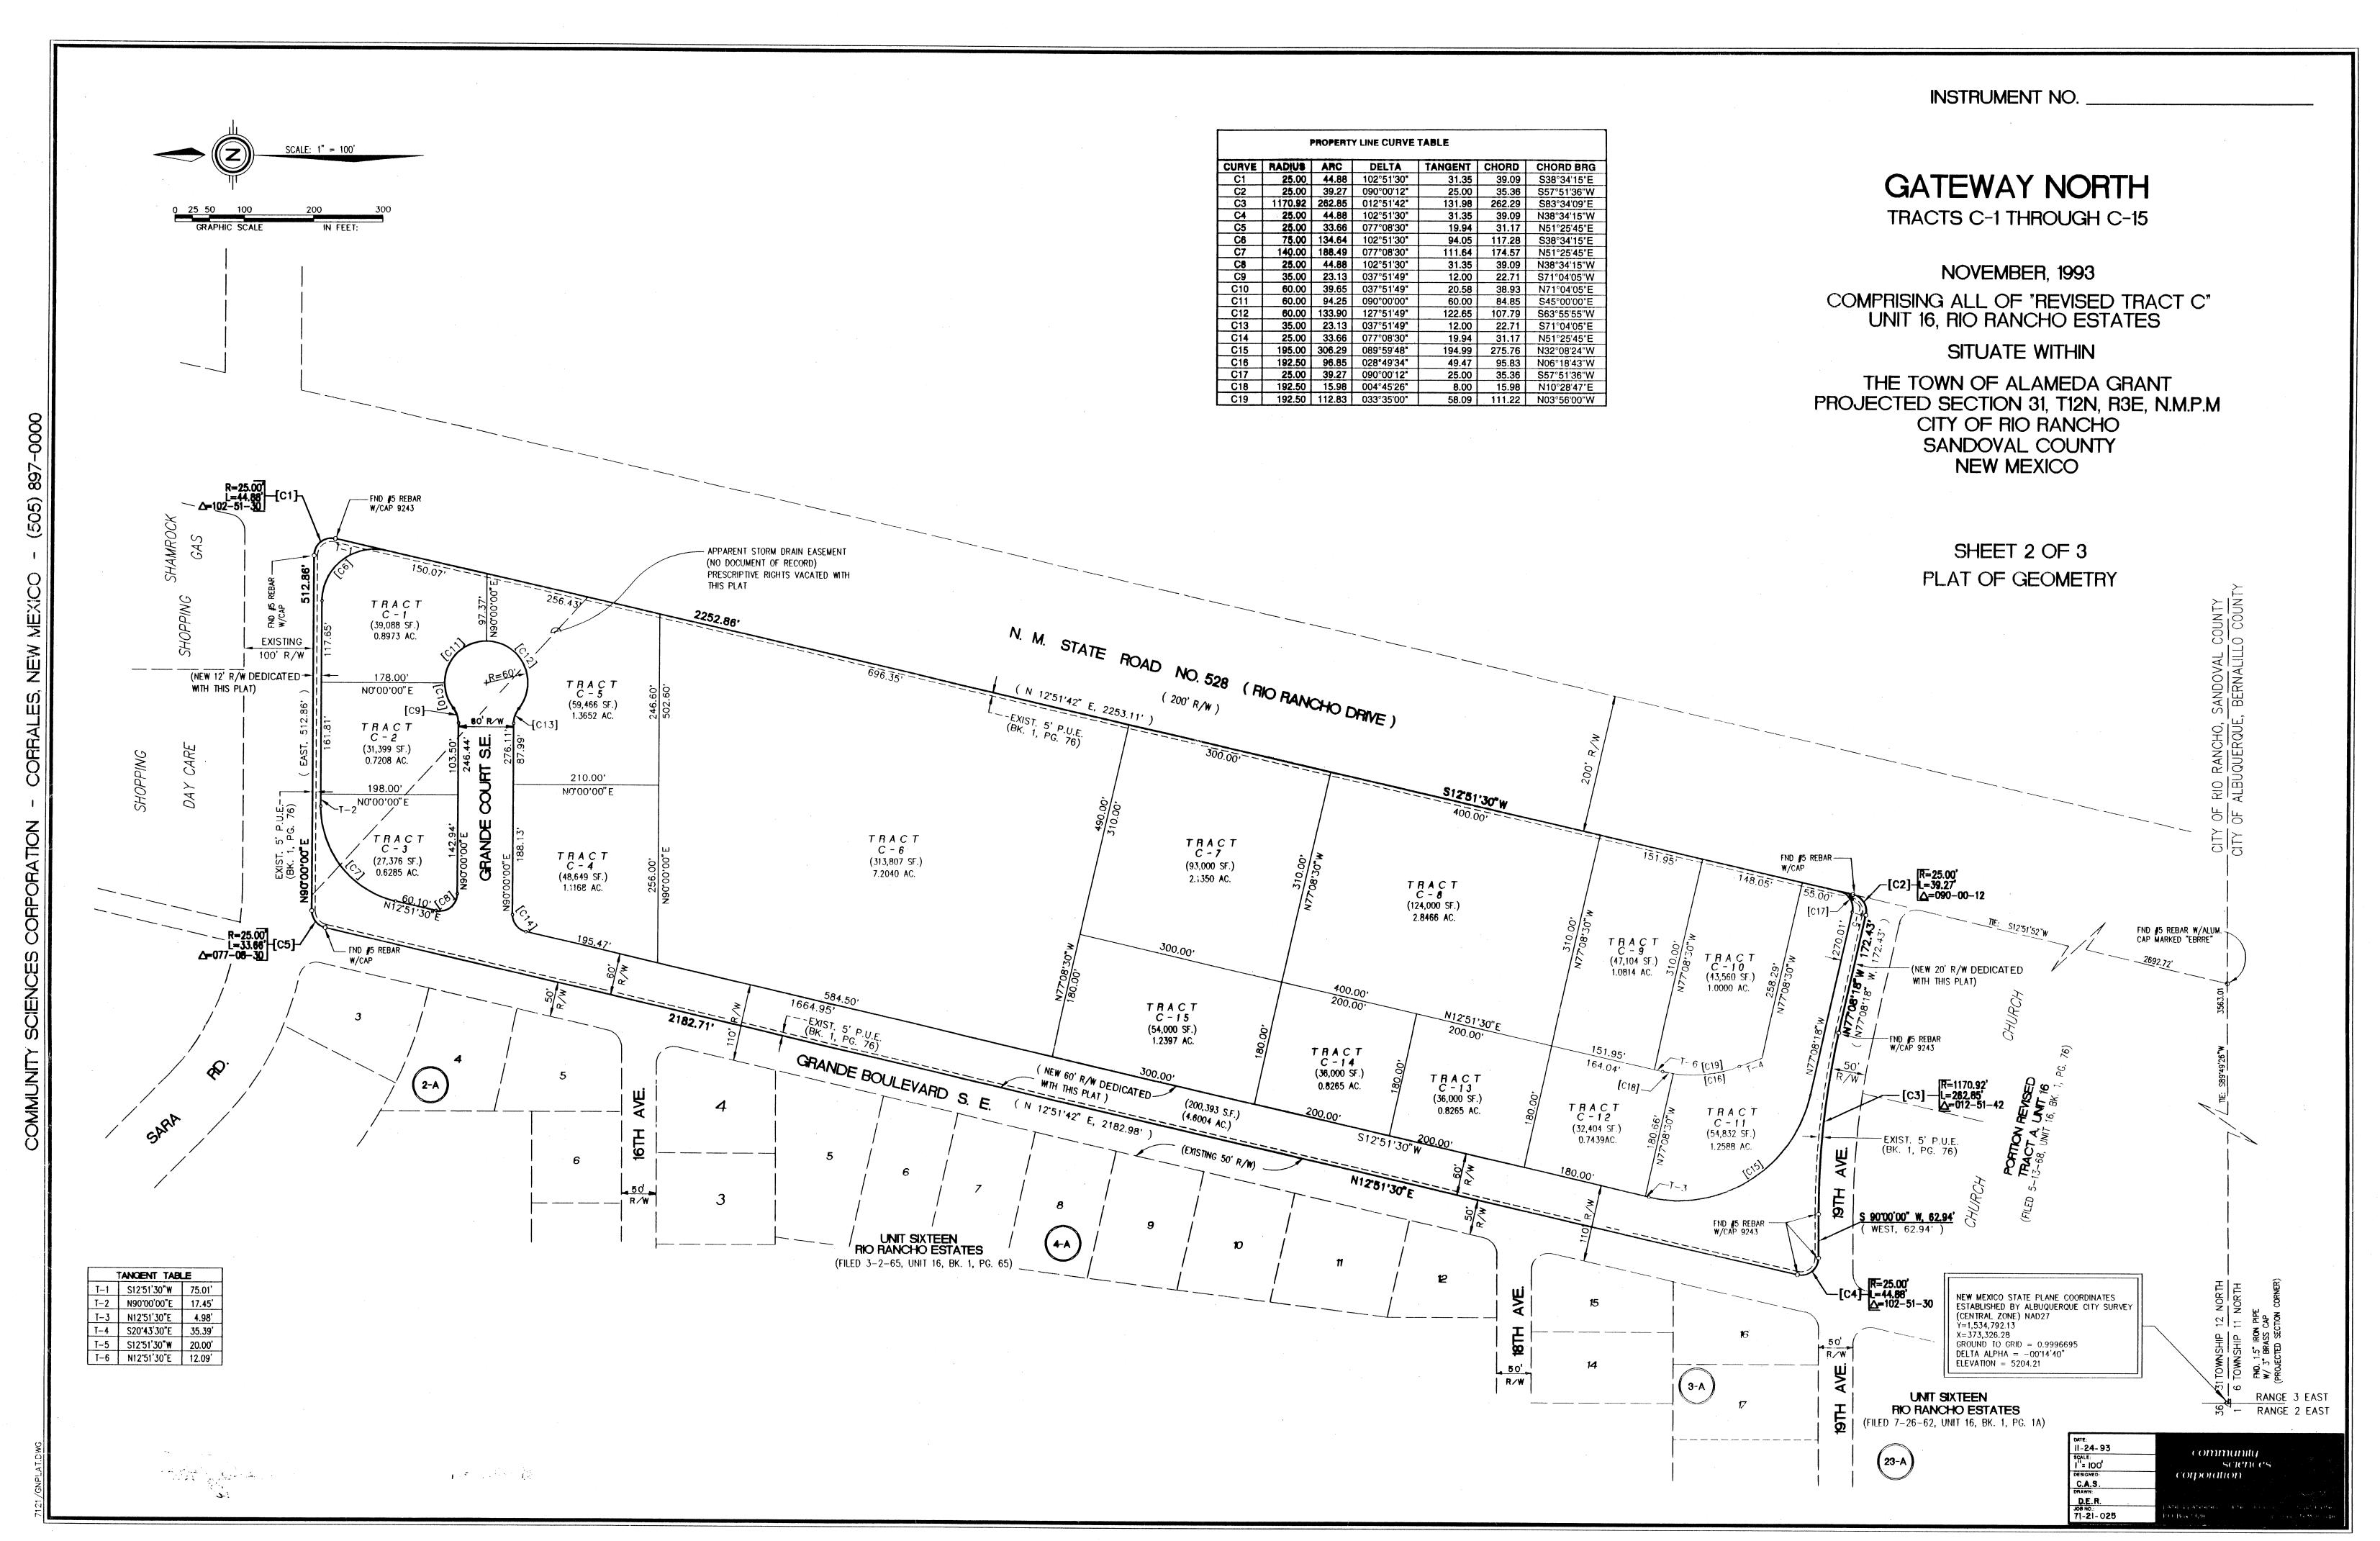

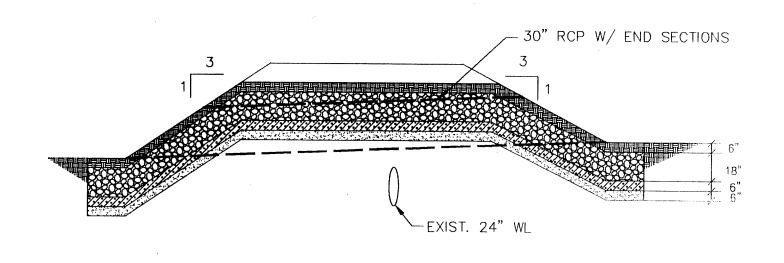

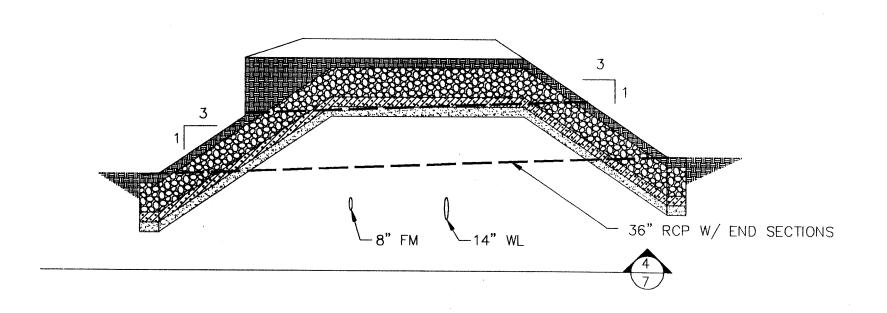

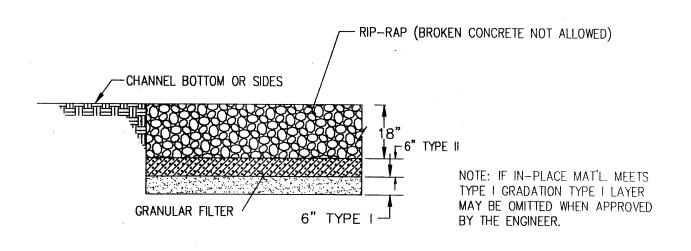

GRADATION FOR GRANULAR BEDDING

TYPICAL	RIP-RAP
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NOT TO SCALE

			U.S. STANDARD SIEVE SIZE	PERCENT BY W	Y WEIGHT PASSING		
	RIP-RAP GRADATION		OIL IL OILL	TYPE I	TYPE II		
% SMALLER THAN OR EQUAL TO SIZE BY WEIGHT	MINIMUM DIMENSION IN INCHES	KM (2) INCHES	3" 1.5"		90–100		
100 35–55	12 (1) 9	9	.75" .375" #4	- - 95–100	20-90 - 0-20		
10 1. AT LEAST 30% OF ALL	2 Stones by Weight Shall bi	– E THIS DIMENSION	#16 #50 #100	45-80 10-30 2-10	- -		
2. MEAN PARTICLE SIZE			# 200	0-2	0-3		

DESCRIPTION BY				GATEWAY POND OU	TFALL CROSS SECTION	ONS
ZEV1S DES				DATE: FEB., 1994 SCALE: AS SHOWN DESIGNED:	community sciences	SHEET 9
), DATE	2	3	4	TLM, TTM DRAWN:	COIPOI ALIOII LAND PLANNING ENGINEERING SURVEYING P.O. Box 1328 Corrales, N.M. 87048	9