



# OFFSITE WATER SYSTEM DISTRIBUTION - PHASE 2

12" WATER LINE  
PRESSURE REDUCING STATION  
AND METER VAULT

DRAWING NUMBER	SHEET TITLE
C40099CA	TITLE SHEET
C40099CB	VICINITY MAP
C40099CC	UTILITY GENERAL NOTES & DETAILS
C40099CD	SITE UTILITY PLAN AND PROFILE SOUTH
C40099CE	SITE UTILITY PLAN AND PROFILE NORTH
C40099CF	BACKFLOW PREVENTER PLAN
C40099CG	MISCELLANEOUS DETAILS

APPROVED BY:	
DEPARTMENT	DATE
FACILITIES PLANNING	
ARCHITECTURAL DESIGNER	
MECHANICAL DESIGNER	
ELECTRICAL DESIGNER	
MECHANICAL ENGINEER	
ELECTRICAL ENGINEER	
INDUSTRIAL ENGINEER	
PROJECT COORDINATOR	
EQUIPMENT ENGINEER	
PROCESS ENGINEER	
SAFETY ENGINEER	
AREA OWNER	

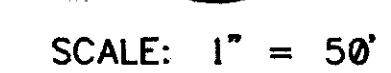
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NEW MEXICO CENTRAL PROJECTS

**intel** CORPORATION  
INTEL - New Mexico  
4188 San Road SE  
Rio Rancho, New Mexico 87124  
505 993-7000 Fax 505 993-7284

APPROVALS	DATE	FILE NO.	FILE CODE	DRAWING NO.
DESIGNED				
CHECKED				
PLANNING				
ENGINEER				
APPROVED				
BY CODE				

FILE NO.	FILE CODE	DRAWING NO.
C40099CA		C40099CA
1 = 1	NONE	1 7



FORM NO.	FILE NAME	DRAWING NO.	
	C40099CB	C40099CB	
OLD ENG. NO.	PLOT SCALE	DRAWING SCALE	SHEET OF
	1" = 50'	1" = 50'	1" X 1"



- A ALL WORK AND MATERIALS SHALL BE IN ACCORDANCE WITH THE PROJECT SPECIFICATIONS AND THE REFERENCED STANDARDS.
- B UTILITY CONTRACTOR SHALL COORDINATE ALL PIPELINE WORK WITH OTHER CONTRACTORS, SUBCONTRACTORS AND INTEL. ALL WORK SHALL BE ACCOMPLISHED IN THE MOST PROFESSIONAL AND WORKMANLIKE MANNER, AND SHALL BE PROVIDED IN ACCORDANCE WITH ALL SITE SAFETY REQUIREMENTS AS DESIGNATED BY INTEL.
- C WHEN COORDINATES ARE SHOWN HEREIN, THEY SHALL REFER TO THE INTEL SITE INTERNAL COORDINATE SYSTEM. ALL BEARINGS, IF SHOWN, ARE ALSO BASED ON INTEL SITE COORDINATES.
- D ALL 16" POTABLE WATER (CW) LINES SHALL BE CONSTRUCTED OF PRESSURE CLASS 250 DUCTILE IRON PIPE. ALL 12" POTABLE WATER (CW) LINES SHALL BE CONSTRUCTED OF PRESSURE CLASS 350 DUCTILE IRON PIPE.
- E ALL JOINTS FOR ALL WATER LINES SHALL BE RESTRAINED JOINTS. JOINTS SHALL BE "MEGALUG" OR SUR-GRIP BY JMC CORP.
- F ALL VALVES AND VALVE BOXES FOR LINE VALVES FOR THE COLD WATER LINES HAVE BEEN LOCATED ON THE PLANS. HOWEVER, LOCATIONS MAY BE RELOCATED OR ADJUSTED DURING CONSTRUCTION AT THE DIRECTION OF INTEL.
- G VERTICAL DEPTHS OF COVER FOR ALL PRESSURE PIPELINES SHALL BE FOLLOWED EXCEPT IN CASES OF CONFLICT. THE MINIMUM COVER DEPTHS BETWEEN GROUND AND TOP OF PIPE IS 4 FEET FOR COLD WATER LINES.
- H ALL SITE WORK WILL REQUIRE A CIPP (CONSTRUCTION INCIDENT PREVENTION PLAN) AND INTEL SITE EXCAVATION PERMIT PRIOR TO EXCAVATION. CIPP MUST BE TURNED IN 24 HOURS PRIOR TO STARTING WORK WITH REQUIRED SIGNATURES. CIPPS ARE GOOD FOR ONE WEEK AND THEN MUST BE RENEWED AND UPDATED.

SAN	=	SANITARY SEWER
SS	=	STORM SEWER
CW	=	COLD WATER
ICW	=	INDUSTRIAL COLD WATER
FL	=	FIRE LINES
IRR	=	IRRIGATION LINES
NG	=	NATURAL GAS
ELEC	=	ELECTRICAL
TELE	=	TELECOMMUNICATIONS
LSS	=	LIFE SAFETY
MH	=	MANHOLE
BFV	=	BUTTERFLY VALVE
PIV	=	POST INDICATOR VALVE
SAN FMS	=	SANITARY SEWER FORCE MAINS
EMD	=	ELECTRONIC MARKER DISK



**CONCRETE PIPE BOLLARD**



REV. NO.	REVISION DESCRIPTION	APPROVED	DATE	RECORDS (Y/N)



**BOHANNAN-HUSTON, INC.**  
ENGINEERS ARCHITECTS PHOTOGRAMMETRISTS SURVEYORS  
Courtyard I, 7500 Jefferson NE, Albuquerque, NM 87109

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NEW MEXICO CENTRAL PROJECTS

**intel** CORPORATION

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4100 Sara Road S.E.  
Rio Rancho, New Mexico 87124  
505 893-7000 Fax 505 893-7204

APPROVALS	DATE
 <small>John A. G. Jones</small>	 <small>[illegible]</small>

## OFFSITE WATER SYSTEM

## DISTRIBUTION - PHASE 2

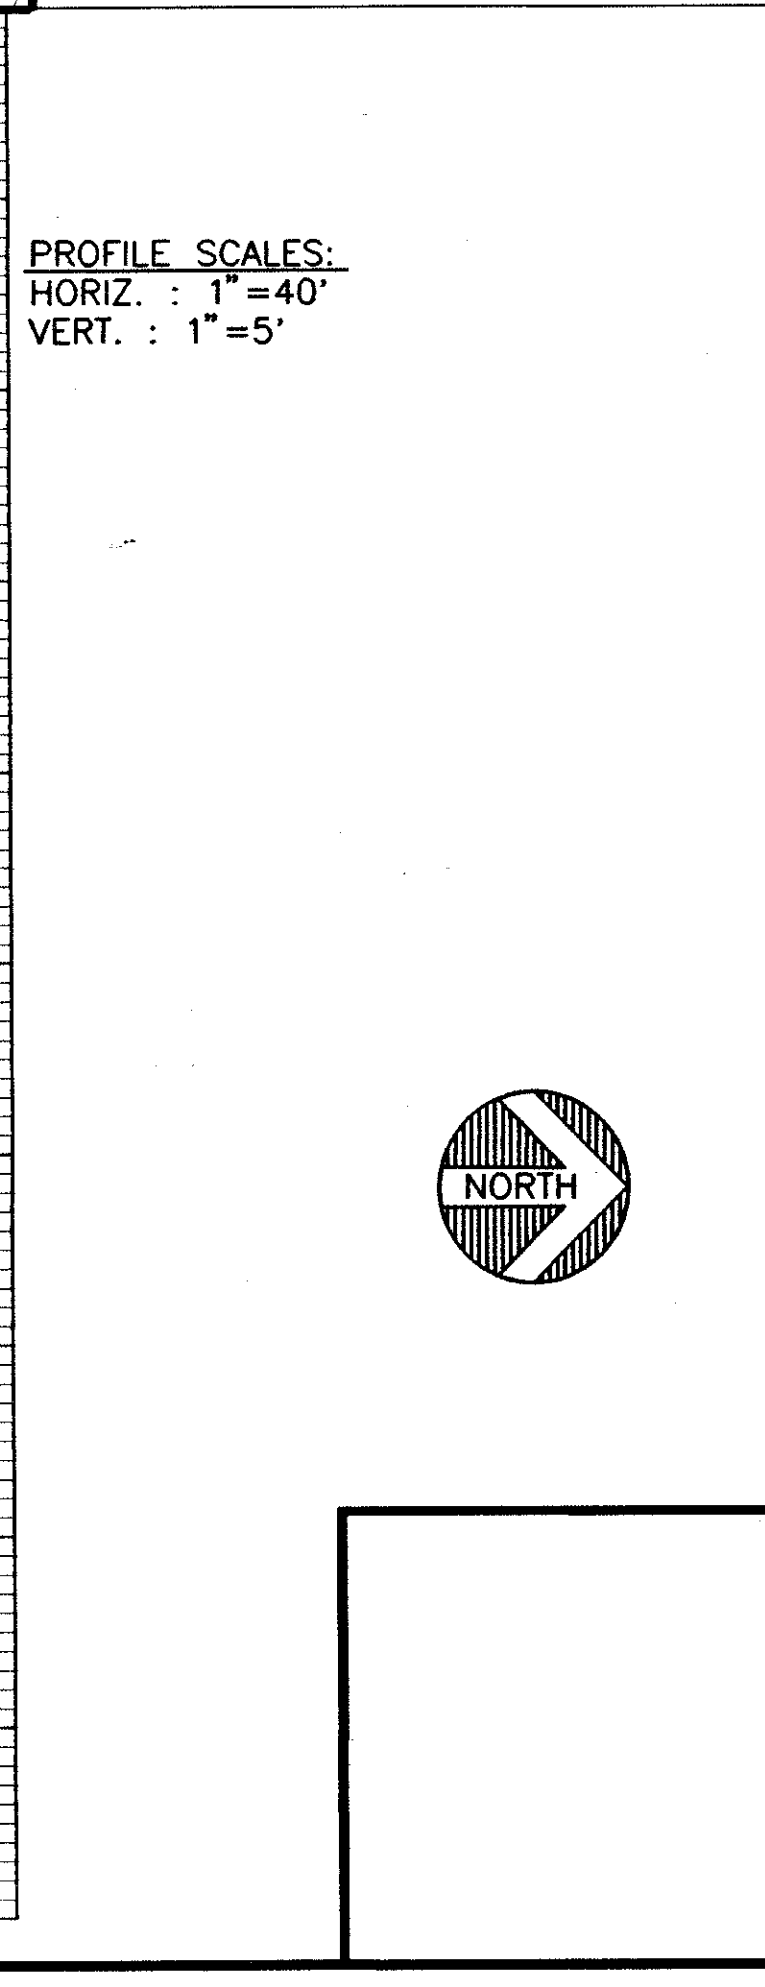
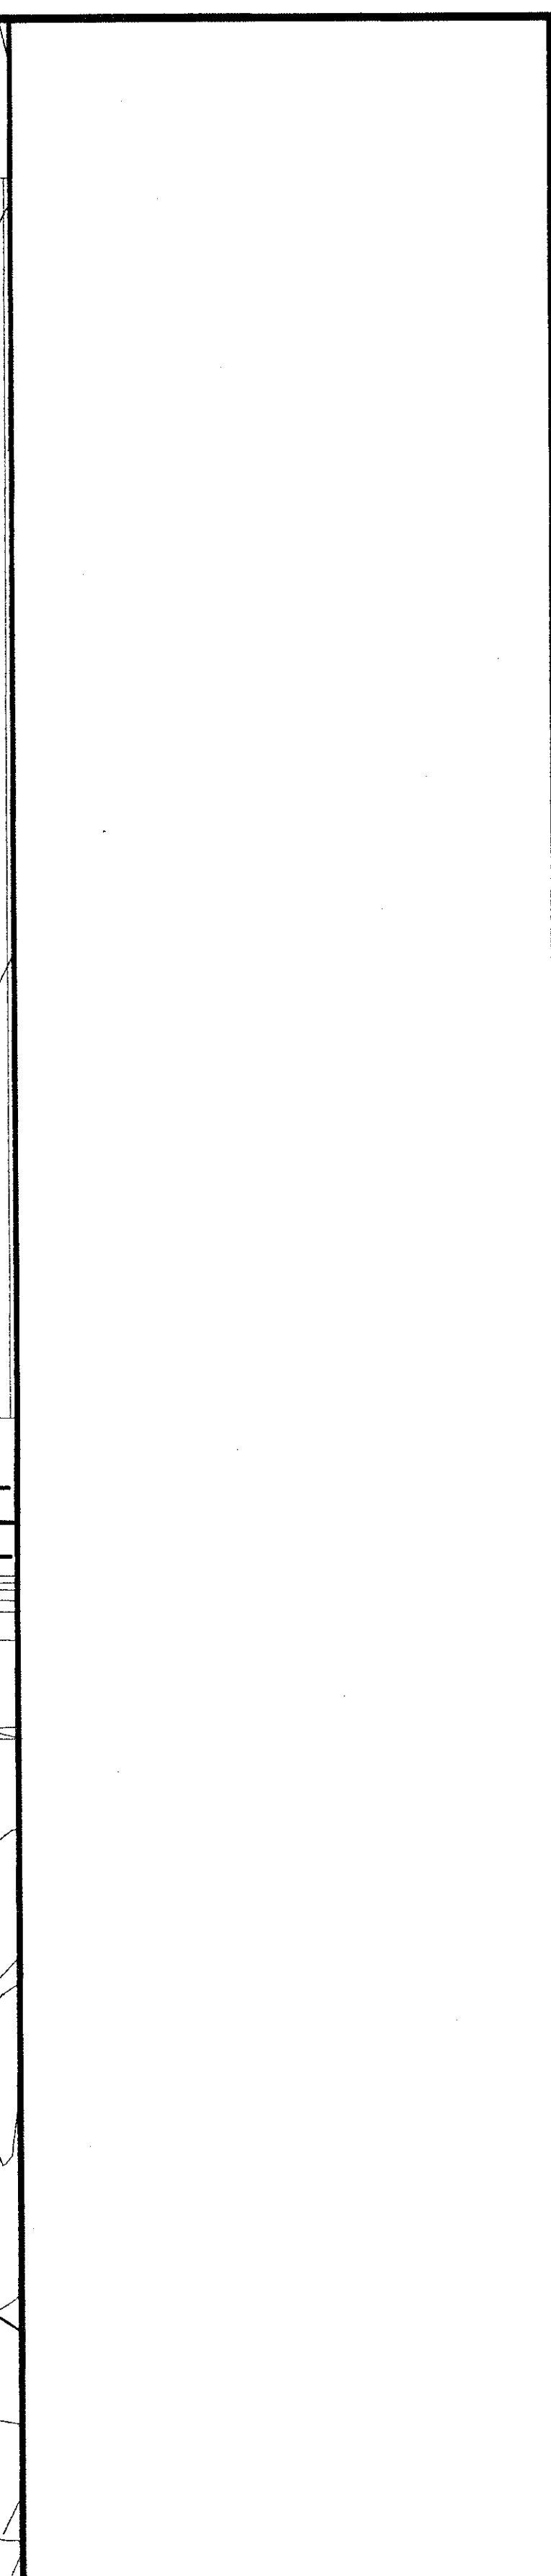
### UTILITY GENERAL



### UTILITY GENERAL NOTES & DETAILS

NOTES & DETAILS		
FWR NO.	FILE NAME	(DRAWING) NO.
		610000000

C40099CC		C40099CC	
OLD DWG NO.	PLOT SCALE	DRAWING SCALE	SHEET OF

	1 = 1	N T S	3 7
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		BOHANNAN-HUSTON, INC. ENGINEERS ARCHITECTS PHOTOGRAMMETRISTS SURVEYORS Courtyard I, 7540 Jefferson NE, Albuquerque, NM 87109		PROJECT NO. _____ DATE _____	
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APPROVALS      DATE		 INTEL NEW MEXICO 4100 San Road S.E. RIO Rancho, New Mexico 87124 505 993-7000 Fax 505 993-7204			
DESIGN CHECKED GRADINGS SAFETY PLANNING		OFFSITE WATER SYSTEM  DISTRIBUTION - PHASE 2 PLAN AND PROFILE CIVIL			
ENGINEER		FIRM NO.		FILE NAME	
APPROVED		C401199CD		DRAINING NO.	
NET CORN.		OLD DRAIN NO.		DRAINING SCALE	
1 = 40'		1" = 40'		1" = 40'	
4		7		4	









