



Richard J. Berry, Mayor

October 3, 2017

John Nourzad, P.E.
GreenbergFarrow
3 Executive Drive, Suite 150
Somerset, NJ 08873

**RE: Murphy Express – Cottonwood
Conceptual Grading and Drainage Plan
Stamp Date: 8/23/17
Hydrology File: A14D003A**

Dear Mr. Nourzad:

PO Box 1293

Based upon the information provided in your submittal received 9/29/17, the Conceptual Grading and Drainage Plan **is not** approved for Site Plan for Building Permit. The following comments need to be addressed for approval of the above referenced project:

Albuquerque

NM 87103

www.cabq.gov

1. Sheet C-3. Please provide the flood plain note with effective date.
2. Sheet C-3 & C-3.1. Please add the word "Conceptual" to the sheets title and add a note stating "Not for Construction".
3. Sheet C-3. Please use the procedure for 40 acre and smaller basins as outlined in Chapter 22, Part A of the Development Process Manual (DPM). Please provide both the existing conditions and proposed conditions for the 100 year-6 hour storm event.
4. Sheet C-3. Please add a note, "Prior to any work within Highway 528 Right-of-Way, a New Mexico Department of Transportation (NMDOT) permit will be required."
5. Sheet C-3. Please add a note, "Prior to any work within Cottonwood Right-of-Way, a City of Albuquerque permit will be required."
6. Sheet C-3.1. Please change the storm sewer manhole to an oil/water separator. Also provide a detail for the oil/water separator.
7. Sheet C-3. If the proposed pond is also to be a detention facility, then please use Chapter 22, Part A of the Development Process Manual (DPM). This section talks

CITY OF ALBUQUERQUE



Richard J. Berry, Mayor

how to use a hydrograph for small watersheds to calculate the volume needed for detention (100 year – 24 hour storm event). Please include the calculations. If a routing program is desired, then Chapter 22, Part C outlines a program called, “AHYMO”. Please do not use HydroCAD. This program does not exactly match the rain patterns here in Albuquerque.

8. Sheet C-3. Please show how the drainage is going from the proposed pond to the existing concrete channels.
9. Sheet C-3. Please provide wier calculations (Chapter 22 of the DPM) for the two existing concrete channels and state what the discharge rate of the site to the NMDOT’s drainage system.
10. Sheet C-3.1. Please reference City of Albuquerque standard detail No. 2236 – Sidewalk Culvert with Steel Plate Top at the two sidewalk culverts.

PO Box 1293

When you resubmit, please just send the two conceptual Grading and Drainage Sheets C-3 & C-3.1. If you have any questions, please contact me at 924-3995 or rbrissette@cabq.gov.

Sincerely,

Albuquerque

Reneé C. Brissette

NM 87103

Reneé C. Brissette, P.E. CFM
Senior Engineer, Hydrology
Planning Department

www.cabq.gov



City of Albuquerque

Planning Department

Development & Building Services Division

DRAINAGE AND TRANSPORTATION INFORMATION SHEET (REV 10/2015)

Project Title: Murphy Express (Cottonwood) **Building Permit #:** _____ **Hydrology File #:** _____

DRB#: _____ **EPC#:** 1011363 **Work Order#:** _____

Legal Description: Tract lettered "C-2" of Sever Bar Ranch, Albuquerque, NM, as the same is shown and designated on the plat thereof, filed in the office of the County Clerk of Bernalillo County, NM on July 26, 1984, in Plat Book C24, folio 136.

City Address: 3751 Hwy 528 NW

Applicant: Murphy Oil USA c/o Jillian Janovsky **Contact:** Jillian Janovsky

Address: 3 Executive Drive, Suite 150, Somerset, NJ 08873

Phone#: 732-537-0811 **Fax#:** _____ **E-mail:** jjanovsky@greenbergfarrow.com

Other Contact: _____ **Contact:** _____

Address: _____

Phone#: _____ **Fax#:** _____ **E-mail:** _____

Check all that Apply:

DEPARTMENT:

- ☒ HYDROLOGY/ DRAINAGE
☐ TRAFFIC/ TRANSPORTATION
☐ MS4/ EROSION & SEDIMENT CONTROL

TYPE OF SUBMITTAL:

- ☐ ENGINEER/ARCHITECT CERTIFICATION
- ☒ CONCEPTUAL G & D PLAN
☐ GRADING PLAN
☐ DRAINAGE MASTER PLAN
☐ DRAINAGE REPORT
☐ CLOMR/LOMR
- ☐ TRAFFIC CIRCULATION LAYOUT (TCL)
☐ TRAFFIC IMPACT STUDY (TIS)
☐ EROSION & SEDIMENT CONTROL PLAN (ESC)
- ☒ OTHER (SPECIFY) EPC

TYPE OF APPROVAL/ACCEPTANCE SOUGHT:

- ☐ BUILDING PERMIT APPROVAL
☐ CERTIFICATE OF OCCUPANCY
- ☐ PRELIMINARY PLAT APPROVAL
☐ SITE PLAN FOR SUB'D APPROVAL
☐ SITE PLAN FOR BLDG. PERMIT APPROVAL
☐ FINAL PLAT APPROVAL
- ☐ SIA/ RELEASE OF FINANCIAL GUARANTEE
☐ FOUNDATION PERMIT APPROVAL
☐ GRADING PERMIT APPROVAL
☐ SO-19 APPROVAL
☐ PAVING PERMIT APPROVAL
☐ GRADING/ PAD CERTIFICATION
☐ WORK ORDER APPROVAL
☐ CLOMR/LOMR

PRE-DESIGN MEETING?

☒ OTHER (SPECIFY) EPC

IS THIS A RESUBMITTAL?: ☐ Yes ☒ No

DATE SUBMITTED: 9/22/2017 **By:** Jillian Janovsky

COA STAFF: _____ ELECTRONIC SUBMITTAL RECEIVED: _____

SITE DEVELOPMENT PLANS FOR MURPHY EXPRESS ALBUQUERQUE, NEW MEXICO

3751 HIGHWAY 528 NW

GENERAL NOTES:

- A. CONTRACTOR SHALL BE RESPONSIBLE FOR RAZING AND REMOVAL OF THE EXISTING STRUCTURES, RELATED UTILITIES, PAVING, UNDERGROUND STORAGE TANKS AND ANY OTHER EXISTING IMPROVEMENTS AS NOTED.
- B. CONTRACTOR IS TO REMOVE AND DISPOSE OF ALL DEBRIS, RUBBISH AND OTHER MATERIALS RESULTING FROM PREVIOUS AND CURRENT DEMOLITION OPERATIONS. DISPOSAL WILL BE IN ACCORDANCE WITH ALL LOCAL, STATE AND/OR FEDERAL REGULATIONS GOVERNING SUCH OPERATIONS.
- C. THE GENERAL CONTRACTOR WILL BE HELD SOLELY RESPONSIBLE FOR AND SHALL TAKE ALL PRECAUTIONS NECESSARY TO AVOID PROPERTY DAMAGE TO ADJACENT PROPERTIES DURING THE CONSTRUCTION PHASES OF THIS PROJECT.
- D. WARRANTY/DISCLAIMER:
THE DESIGNS REPRESENTED IN THESE PLANS ARE IN ACCORDANCE WITH ESTABLISHED PRACTICES OF CIVIL ENGINEERING FOR THE DESIGN FUNCTIONS AND USES INTENDED BY THE OWNER AT THIS TIME. HOWEVER, NEITHER THE ENGINEER NOR ITS PERSONNEL CAN OR DO WARRANT THESE DESIGNS OR PLANS AS CONSTRUCTED EXCEPT IN THE SPECIFIC CASES WHERE THE ENGINEER INSPECTS AND CONTROLS THE PHYSICAL CONSTRUCTION ON A CONTEMPORARY BASIS AT THE SITE.
- E. SAFETY NOTICE TO CONTRACTOR:
IN ACCORDANCE WITH GENERALLY ACCEPTED CONSTRUCTION PRACTICES, THE CONTRACTOR SHALL BE SOLELY AND COMPLETELY RESPONSIBLE FOR CONDITIONS OF THE JOB SITE, INCLUDING SAFETY OF ALL PERSONS AND PROPERTY DURING PERFORMANCE OF THE WORK. THIS REQUIREMENT WILL APPLY CONTINUOUSLY AND NOT BE LIMITED TO NORMAL WORKING HOURS. ANY CONSTRUCTION OBSERVATION BY THE ENGINEER OF THE CONTRACTOR'S PERFORMANCE IS NOT INTENDED TO INCLUDE REVIEW OF THE ADEQUACY OF THE CONTRACTOR'S SAFETY MEASURES, IN, ON OR NEAR THE CONSTRUCTION SITE.
- F. ALL CONSTRUCTION WITHIN STATE HIGHWAY DEPARTMENT RIGHT-OF-WAY SHALL BE COORDINATED WITH THE HIGHWAY DEPARTMENT RESIDENT MAINTENANCE ENGINEER.
- G. ALL SITE WORK FOR THIS PROJECT SHALL MEET OR EXCEED THE SPECIFICATIONS OF THE RELEVANT UTILITY COMPANY OR REGULATORY AUTHORITY, AND THE SPECIFICATIONS FOR THE CONSTRUCTION OF THE EXISTING IMPROVEMENTS WHICH ARE BEING ALTERED OR REPLACED. CONTRACTOR SHALL CONTACT THE ENGINEER FOR SPECIFICATION SECTIONS FOR ITEMS SUCH AS LANDSCAPING AND IRRIGATION THAT ARE AFFECTED BY THE WORK BUT NOT COMPLETELY DETAILED OR SPECIFIED ON THESE PLANS.
- H. CONSTRUCTION AND INSTALLATION OF 1200 S.F. KIOSK/C-STORE, ALL UTILITY ENTRANCES, (1)25,000 GAL-REGULAR, (1)8,000 GAL-PREMIUM, (1)10,000 GAL-DIESEL, AND (1)8,000 GAL-E-O UNDERGROUND TANKS SHALL BE IN ACCORDANCE WITH ASSOCIATED PLANS.
- I. STAGE II VAPOR RECOVERY SYSTEM IS NOT REQUIRED.
- K. CONTRACTOR REQUIRED TO PROVIDE REDLINE AS-BUILTS AND PROVIDE THOSE TO MURPHY UPON COMPLETION.
- L. CONTRACTOR IS RESPONSIBLE FOR CONSTRUCTION SURVEYING, STAKING, AND LAYOUT

NOTES TO CONTRACTOR

- A. THE CONTRACTOR SHALL PROVIDE THE ENGINEER OF RECORD WITH THE DATE WHEN CONSTRUCTION IS TO BEGIN.
- B. THE CONTRACTOR IS RESPONSIBLE FOR CONSTRUCTION SURVEYING, STAKING, AND LAYOUT
- C. THE CONTRACTOR IS RESPONSIBLE FOR KEEPING THE ENGINEER OF RECORD INFORMED OF ANY DEVIATIONS DURING CONSTRUCTION AND SHALL REPORT THEM IMMEDIATELY
- D. CONTRACTOR IS REQUIRED TO KEEP REDLINE AS-BUILTS AND TO PROVIDE THOSE TO MURPHY UPON COMPLETION.
- E. CONTRACTOR IS RESPONSIBLE FOR UNDERSTANDING THE AS-BUILT AND CERTIFICATE OF OCCUPANCY (C.O.) REQUIREMENTS FROM THE ISSUING AUTHORITY.
- F. IF AN AS-BUILT SURVEY IS REQUIRED BY THE ISSUING AUTHORITY, THE CONTRACTOR SHALL BE RESPONSIBLE OBTAINING THE AS-BUILT SURVEY, PREPARED BY A LICENSED SURVEYOR, AND SUBMITTING THE AS-BUILT SURVEY TO ISSUING AUTHORITY AND THE ENGINEER OF RECORD

WETLANDS NOTE:

ANY DEVELOPMENT, EXCAVATION, CONSTRUCTION, OR FILLING IN A U.S. ARMY CORPS OF ENGINEERS DESIGNATED WETLAND IS SUBJECT TO LOCAL, STATE AND FEDERAL APPROVALS. THE CONTRACTOR SHALL COMPLY WITH ALL PERMIT REQUIREMENTS AND/OR RESTRICTIONS AND ANY VIOLATION WILL BE SUBJECT TO FEDERAL PENALTY. THE CONTRACTOR SHALL HOLD THE OWNER/DEVELOPER, THE ENGINEER AND THE LOCAL GOVERNING AGENCIES HARMLESS AGAINST SUCH VIOLATION.

FLOOD CERTIFICATION:

THIS PROPERTY IS NOT LOCATED WITHIN ANY PRESENTLY ESTABLISHED 100-YEAR FLOOD PLAIN, AS SHOWN BY THE FEDERAL EMERGENCY MANAGEMENT AGENCY, FLOOD INSURANCE RATE MAP 35001C0109H DATED AUGUST 16, 2012

NOTICE TO BIDDERS:

ALL QUESTIONS REGARDING THE PREPARATION OF THE GENERAL CONTRACTOR'S BID SHALL BE DIRECTED TO THE OWNER'S CONSTRUCTION DEPARTMENT AT (870) 866-7681 (JASON LAIRD). SUBCONTRACTORS MUST DIRECT THEIR QUESTIONS THROUGH THE GENERAL CONTRACTOR. THE CONSULTING ARCHITECT AND/OR THE CONSULTING ENGINEER SHALL NOT BE CONTACTED DIRECTLY WITHOUT PRIOR AUTHORIZATION FROM THE OWNER/DEVELOPER.

INFORMATION TO CONTRACTOR:


- MURPHY AND THE GENERAL GC ARE MADE AWARE THAT THIS PROJECT GOING OUT TO BID PRIOR TO PERMITS BEING OBTAINED. THIS INFORMATION IS BEING PROVIDED AS A BRIEF OVERVIEW OF THE PROJECT FOR INFORMATION ONLY AND IS NOT CONCLUSIVE. CONTRACT DOCUMENTS PROVIDED BY MURPHY INCLUDING PLANS AND SPECIFICATION SHALL GOVERN THE EXECUTION OF THE CONSTRUCTION CONTRACT.
- ENGINEER SHALL BE NOTIFIED IMMEDIATELY OF ANY DISCREPANCIES BETWEEN CONSTRUCTION DRAWINGS AND FIELD OBSERVATIONS REGARDING THE SITE-WORK SCOPE OF WORK.
- SWPPP - THE TOTAL DISTURBED ACREAGE FOR THE PROJECT IS APPROXIMATELY 1.20 ACRES. THE GC SHALL FOLLOW THE REQUIREMENTS OUTLINED IN THE STORMWATER POLLUTION PREVENTION PLAN (SWPPP) PREPARED BY THE CIVIL ENGINEER, THE EROSION AND SEDIMENT CONTROL PLANS, EPA CONSTRUCTION GENERAL PERMIT, AND SHALL PROTECT THE ADJACENT PROPERTY AND STORMWATER FACILITIES FROM SILT RUNOFF AND POSSIBLE CONTAMINANTS DURING CONSTRUCTION.
- THE GC IS TO NOTIFY THE ENGINEER OF RECORD THE DATE WHEN CONSTRUCTION IS TO COMMENCE. (INSERT SPECIFIC COUNTY, STATE, DISTRICT ADDITIONAL REQUIREMENTS IF NEEDED).
- NOI/NOT - NOT REQUIRED AT THIS TIME.
- THE BUILDING, CANOPY, SIGNS AND DUMPSTER COLORS AND TREATMENTS MUST BE COORDINATED WITH THE APPROVED SITE RENDERING PREPARED BY GREENBERGFARROW DATED JUNE 15, 2017.
- AS-BUILT OR RECORD DRAWINGS WILL BE REQUIRED TO OBTAIN THE CERTIFICATE OF OCCUPANCY - GC IS HEREBY ADVISED TO KEEP AS-BUILT RECORDS AND PROVIDE TO THE ENGINEER AND TO SCHEDULE THE AS-BUILT SURVEY WITH SUFFICIENT TIME TO PERFORM THE SURVEY AND HAVE IT REVIEWED/APPROVED BY THE CITY OF ALBUQUERQUE (TWO WEEKS MINIMUM TIME EXPECTED).
- PERMITS AND APPROVAL REQUIREMENTS:
 - BUILDING - PENDING
 - STATE FIRE MARSHALL - PENDING
 - EROSION CONTROL/SWPPP - A COPY OF THE SWPPP MUST BE LOCATED ON-SITE.
 - SIGN PERMIT - GC SHALL BE RESPONSIBLE FOR PULLING THE FINAL SIGN PERMIT AND PAYING ANY OUTSTANDING FEES ASSOCIATED WITH THE PERMIT.

ENGINEER (CIVIL)

C-0	COVER SHEET
C-1	SITE PLAN
C-2	SURVEY
C-3	GRADING PLAN
C-3.1	STORM SEWER PLAN
C-4	EROSION CONTROL PHASE 1
C-4.1	EROSION CONTROL PHASE 2
C-4.2	EROSION & SEDIMENT CONTROL DETAILS
C-5	DEMOLITION PLAN
C-6	UTILITY PLAN
C-6.1	UTILITY PROFILES
C-7	PAVING/JOINT LAYOUT PLAN
C-9	TRUCK ROUTE PLAN
C-10	LANDSCAPE PLAN
C-12	DETAIL SHEET
C-13	DETAIL SHEET
C-14	DETAIL SHEET
C-15	DETAIL SHEET
C-16	DETAIL SHEET
C-17	DETAIL SHEET
L1	PHOTOMETRIC PLAN

GALLOWAY (TANK/PIPING)

COVER	COVER SHEET
FS-1	SPECIFICATIONS
FS-2	SPECIFICATIONS
FS-3	SPECIFICATIONS
F-1	NOTES AND PARTS LIST
F-1.1	PARTS LIST
F-2	TANK INSTALLATION AND ANCHORING DETAILS
F-3	TANK SUMP AND VENTING DETAILS
F-4	TANK RISER, OBSERVATION WELL AND VENTING DETAILS
F-5	PRODUCT PIPING PLAN
F-6	DUALOY PIPING SOLUTION
F-7	STANDARD YARD AND DRIVE DETAILS
F-8	PARTIAL PAVING PLAN
FD-1	DISPENSER DETAILS
FE-1	CONDUIT PLAN, PUMPS AND DISPENSER WIRING DIAGRAM
FE-2	PUMPS AND DISPENSER CONTROL WIRING DIAGRAM
FE03	CANOPY WIRING LAYOUT, ELEVATIONS AND DETAILS
FE-4	SITE MONITORING DIAGRAM
FL-1	LABELING PLACEMENT STANDARDS
FL-2	STANDARD LABELING DETAILS

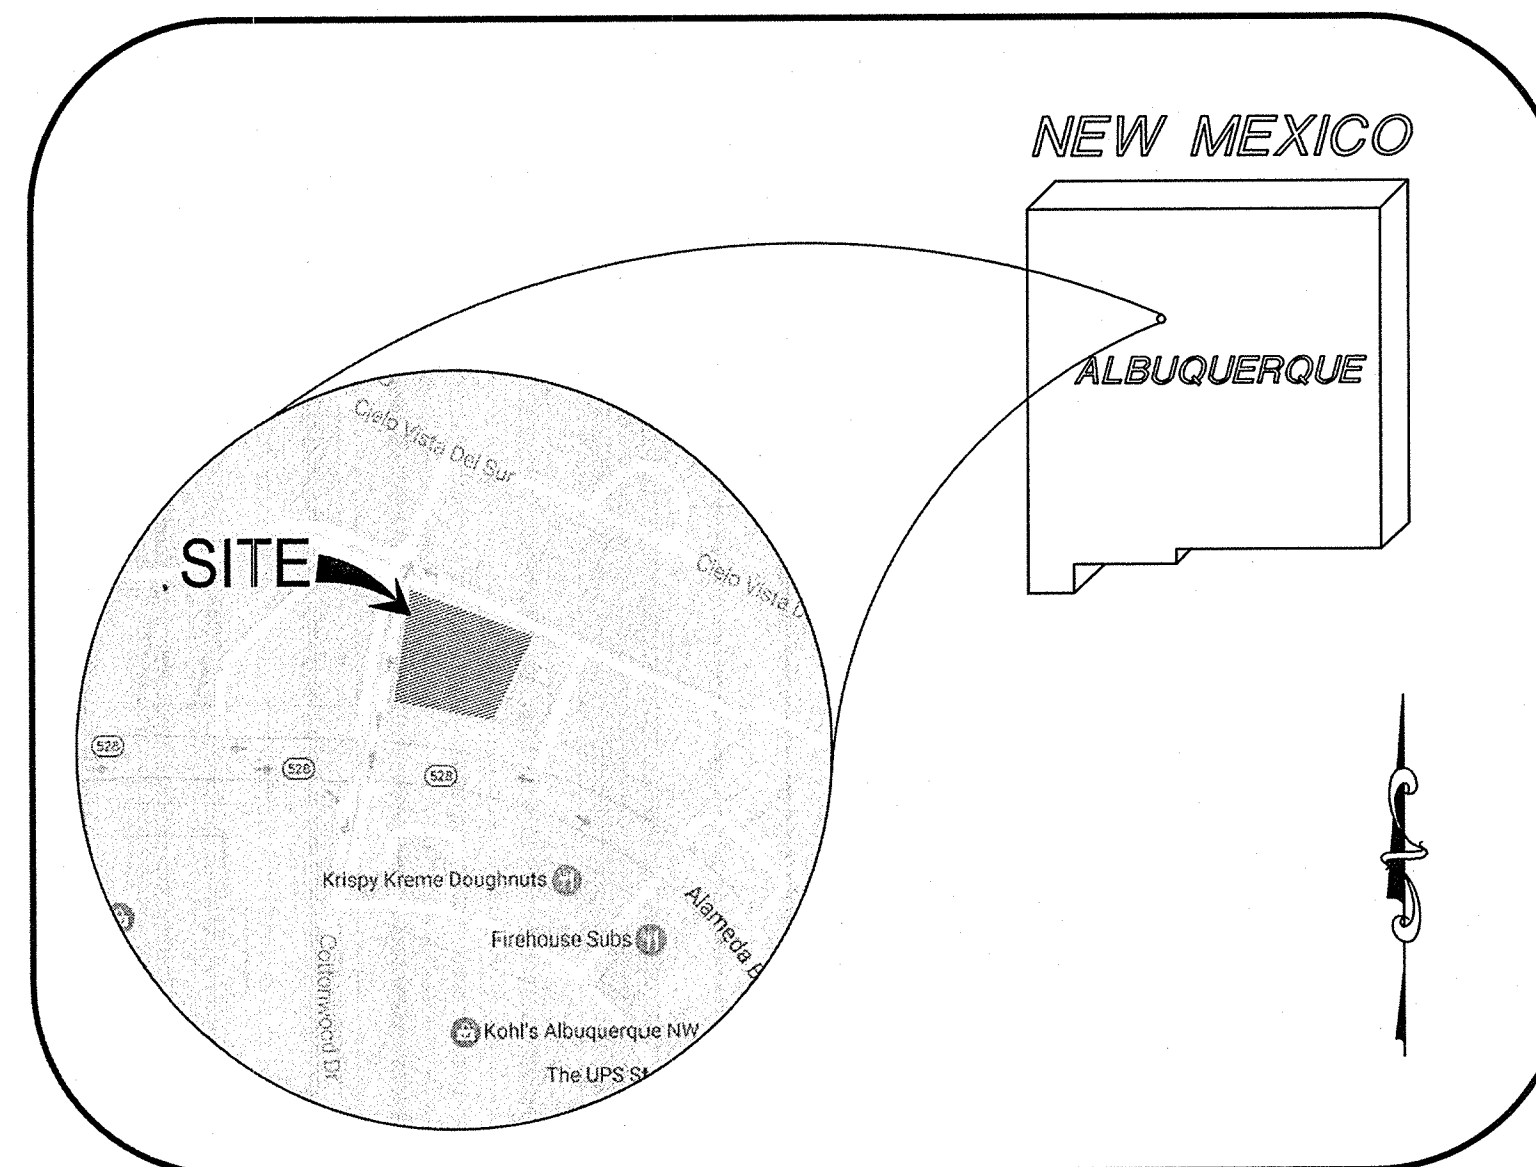

Vicinity Map

NOT TO SCALE

PLAN INDEX:

GREENBERGFARROW (BUILDING)

CS1	COVER SHEET
A1	ACCESSIBILITY STANDARDS NOTES & DETAILS
A2	EGRESS/ACCESSIBILITY FLOOR PLAN
S1	STRUCTURAL GENERAL NOTES
E1	EXTERIOR ELEVATIONS
E2	EXTERIOR ELEVATIONS
E3	FLOOR PLAN
E4	FLOOR FRAMING PLAN
E5	ROOF FRAMING PLAN
E6	SECTION
E7	SECTION
E8	INTERIOR ELEVATIONS
E9	INTERIOR ELEVATIONS
E10	FLOOR FINISH PLAN
EL1	ELECTRICAL PLAN
EL2	LIGHTING PLAN
EL3	ELECTRICAL DETAILS
EL4	ELECTRICAL PANEL SCHEDULE
P1	PLUMBING PLAN
P2	PLUMBING & WATER RISER
M1	MECHANICAL PLAN
M2	MECHANICAL ROOF PLAN
F1	FOUNDATION PLAN
F2	FOUNDATION DETAILS
GC1	GC SCOPE OF WORK FLOOR PLAN

GREENBERGFARROW (CANOPY)

CS1	COVER SHEET
S1	STRUCTURAL GENERAL NOTES
E1	FRAMING PLAN
E2	ELEVATIONS
E3	LIGHTING AND SOFFIT PLAN
E4	SECTION
E5	SECTION
E6	SECTION
F1	FOUNDATION PLAN

RESOURCE LIST:

PLANNING AND ZONING

KYM DICOME
CITY OF ALBUQUERQUE
URBAN DESIGN & DEVELOPMENT
600 2ND ST. NW
ALBUQUERQUE, NM 87102
PHONE: (505) 924-3814
KDICOME@CABQ.GOV

STORMWATER

JAMES HUGHES, PE
CITY OF ALBUQUERQUE
PLANNING DEPARTMENT
600 2ND ST. NW
ALBUQUERQUE, NM 87102
PHONE: (505) 924-3986
JHUGHES@CABQ.GOV

WATER AND SEWER

KRISTOPHER CADENA, P.E.
CITY OF ALBUQUERQUE
UTILITY DEVELOPMENT SECTION
600 2ND ST., NW, SUITE 201
ALBUQUERQUE, NM 87102
PHONE: (505) 289-3301

TELEPHONE

CONTACT: CHUCK AVENT
SUPERVISOR, PLANT FACILITIES
CENTURYLINK
PHONE: (505) 514-6473
CHUCK.AVENT@CENTURYLINK.COM

BUILDING

PATRICIA ORTIZ
PLANS EXAMINER
CITY OF ALBUQUERQUE
600 2ND ST. NW, SUITE 1-B
ALBUQUERQUE, NM 87102
PHONE: (505) 924-3910
PAORTIZ@CABQ.GOV

FIRE PREVENTION

LT. ERIC L. GONZALES
ALBUQUERQUE FIRE DEPT.
625 HOLCOMB BRIDGE ROAD
ALBUQUERQUE, NM 87102
PHONE: (505) 924-3611
ELGONZALES@CABQ.GOV

ELECTRIC

SUZANNE MARQUEZ
ENGINEERING TECHNICIAN
PNM PUBLIC SERVICE CO.
4201 EDITH BOULEVARD NE
ALBUQUERQUE, NM 87107
PHONE: (505) 241-3479
CELL: (505) 450-8641
SUZANNE.MARQUEZ@PNM.COM

ENGINEER

GREENBERG FARROW
CONTACT: TREVOR ANDREY
1530 WEST PEACHTREE ST., SUITE 200
ATLANTA, GA 30309
PHONE: (404) 601-4000

GEOTECH

UNITED CONSULTING
CONTACT: AARON C. EPSTEIN, P.E.
625 HOLCOMB BRIDGE ROAD
NORCROSS, GA 30071
PHONE: (770) 209-0029


MURPHY

CONTACT: GAVEN BALLINGER
200 PEACH ST.
EL DORADO, AR 71780
PHONE: (870) 881-6678

AGENCY	DATE
PLANNING & ZONING (CITY OF ALBUQUERQUE)	
STORMWATER (CITY OF ALBUQUERQUE)	
BUILDING (CITY OF ALBUQUERQUE)	
NPDES	
PNM PUBLIC SERVICE CO.	

BASED ON A SURVEY BY:
SURV-TEK
9384 VALLEY VIEW DRIVE N.W.
ALBUQUERQUE, NEW MEXICO 87114
PHONE: (505) 897-3366
FAX: (505) 897-3377
MAY 25, 2017

REVISION	DATE	DESCRIPTION
REV-0	08-23-17	REVIEW SET

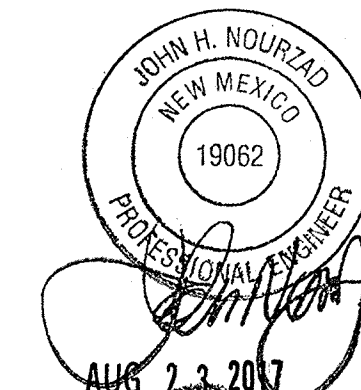


GreenbergFarrow

CONTACT: DAWN SCHAFFRAN
3 EXECUTIVE DRIVE, SUITE 150
SOMERSET, NJ 08873
(732) 537-0811

JOB NO.: 20160897.0

DATE: 08-23-17
REV-0
SHEET NO. C-0

ZONING:
SU-1 (SPECIAL USE ZONE)

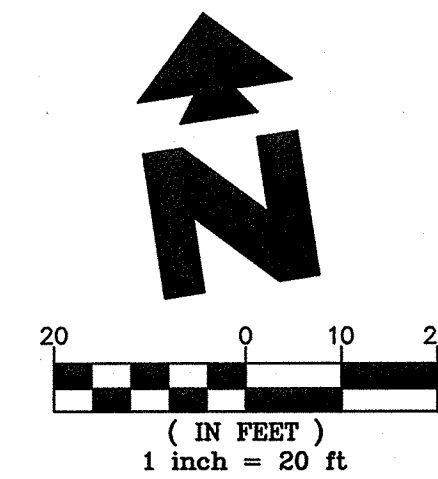

1200SF-8-2015v2

EXISTING

- | | |
|-------------------------------|---------------------------------|
| Sanitary Sewer Manhole | Hand Rolling |
| Power Pole w/underground feed | Light Pole |
| Power Pole | Bollard |
| High Voltage Tower | Concrete Symbol |
| Overhead Wires | Telephone Pedestal |
| Guy Wire | Underground Electric Line |
| Water Meter | Underground Communications Line |
| Water Valve | Underground Gas Line |
| Hydrant | Underground Water Line |
| Electric Meter | Sanitary Sewer Line |
| Traffic Box | Storm Drain Line |
| Overhead Traffic Light Pole | Control Point |
| Fence | Wall |

PROPOSED

- | |
|--|
| BOUNDARY LINE |
| CONCRETE CURB AND GUTTER |
| CF CONSTRUCTION FENCE (SEE DETAIL SHEETS) |
| CFP CONSTRUCTION FENCE ON PAVEMENT (SEE DETAIL SHEETS) |
| BUILDING/CANOPY CONTROL POINT |

GENERAL SITE NOTES

- A. ALL DIMENSIONS SHOWN ARE TO THE FACE OF CURB UNLESS OTHERWISE NOTED.
- B. ALL CURB RETURN RADII SHALL BE 5', AS SHOWN TYPICAL ON THIS PLAN, UNLESS OTHERWISE NOTED.
- C. UNLESS OTHERWISE SHOWN, CALLED OUT OR SPECIFIED HEREON:
- ALL CURB AND GUTTER ADJACENT TO CONCRETE PAVING SHALL BE INSTALLED PER DETAIL 1B.
 - PAVEMENT SHALL BE INSTALLED IN ACCORDANCE WITH THE PAVING PLAN OVER THE ENTIRE PARKING LOT AREA AND ALL APPROACH DRIVES.
 - SEE ASSOCIATED PLANS FOR CANOPY, COLUMN, PUMP ISLAND DETAILS AND LAYOUT.
- D. CONTRACTOR SHALL BEGIN CONSTRUCTION OF ANY LIGHT POLE BASES FOR RELOCATED LIGHT FIXTURES AND RELOCATION OF ELECTRICAL SYSTEM AS SOON AS DEMOLITION BEGINS. CONTRACTOR SHALL BE AWARE THAT INTERRUPTION OF POWER TO ANY LIGHT POLES OR SIGNS SHALL NOT EXCEED 24 HOURS.
- E. THE LOCATION OF THE CONSTRUCTION FENCE ON THE DRAWINGS IS FOR GRAPHICAL REPRESENTATION ONLY. THE CONTRACTOR IS TO ENSURE THAT THE CONSTRUCTION FENCE ENCOMPASSES THE ENTIRE WORK AREA.
- F. ALL SLOPES AND AREAS DISTURBED BY CONSTRUCTION SHALL BE GRADED SMOOTH AND FOUR INCHES OF TOPSOIL APPLIED. IF ADEQUATE TOPSOIL IS NOT AVAILABLE ON SITE, THE CONTRACTOR SHALL PROVIDE TOPSOIL, APPROVED BY THE OWNER, AS NEEDED. THE AREA SHALL THEN BE SEED, FERTILIZED, MULCHED, WATERED AND MAINTAINED UNTIL HARDY GRASS GROWTH IS ESTABLISHED IN ALL AREAS. ANY AREAS DISTURBED FOR ANY REASON PRIOR TO FINAL ACCEPTANCE OF THE PROJECT SHALL BE CORRECTED BY THE CONTRACTOR AT NO ADDITIONAL COST TO THE OWNER.
- G. CONTRACTOR SHALL PURCHASE AND INSTALL A MAILBOX, AND SHALL COORDINATE LOCATION OF MAILBOX WITH MURPHY CONSTRUCTION MANAGER AND/OR ON-SITE REPRESENTATIVE AND LOCAL POSTMASTER.
- H. ALL PROPOSED PAVEMENT STRIPING OR MARKINGS SHALL FOLLOW THE SPECIFICATIONS FOR PAINT INCLUDED IN DETAIL 10A.

SITE NOTES

- 2F DRILL (2) 3/4" x 5/8" DIA. HOLES (1) EACH FOR OPEN POSITION & CLOSED POSITION OF GATES. TO BE USED ON BOTH SIDES OF GATE. SEE DUMPSTER DETAIL.
- 8B OVERHEAD CANOPY - (TYP.-PER CANOPY PLANS)
- 12A 4" TRAFFIC YELLOW LANE STRIPE (SEE LENGTH INDICATED AT SYMBOL).
- 12D 4" WIDE PAINTED STRIPES. 2.0' O.C. @ 45° (SEE SIZE COLOR INDICATED AT SYMBOL).
- 12H 4" DOUBLE TRAFFIC YELLOW LANE STRIPE (SEE LENGTH INDICATED AT SYMBOL).
- 12M CONTRACTOR TO ENSURE THAT ANY LIGHT POLES OR HANDICAP PARKING SIGNS ARE AT LEAST 2' FROM BACK OF CURB TO PREVENT THE VEHICLES FROM STRIKING THESE ITEMS.
- 14J GC TO INSTALL (1) 4" PVC SLEEVE FOR IRRIGATION LINE. SEE UTILITY PLAN FOR INSTALLATION REQUIREMENTS.
- 14K GC TO INSTALL (2) 4" PVC SLEEVES FOR FUTURE USE. SEE UTILITY PLAN FOR INSTALLATION REQUIREMENTS.
- 16A MURPHY OIL FREESTANDING SIGN. PER APPROVED ELEVATION.
- 21A TAPER CURB TO MATCH EXISTING CURB
- 21D EDGE OF CONCRETE SLAB. PER TANK/PIPING PLANS.
- 21E UNDERGROUND STORAGE TANKS (1) 25,000 GAL-REGULAR, (1) 8,000 GAL-PREMIUM, (1) 10,000 GAL-DIESEL, (1) 8,000 GAL-E-O.
- 21G AIR VACUUM UNIT WITH 4" x 7" CONCRETE SLAB
- 21H MURPHY EXPRESS ID SIGN. PER APPROVED ELEVATION.
- 21I PRICE SIGN PER APPROVED ELEVATION
- 21P 7' x 10' CONCRETE PAD FOR PROPANE TANKS.
- 21T MAILBOX (CONTRACTOR TO COORDINATE LOCATION WITH MURPHY AND POSTMASTER PRIOR TO INSTALLATION)
- 21U 5' x 7' CONCRETE SLAB FOR ICE UNIT. SEE NUMBER INDICATED AT SYMBOL.
- 21V CONCRETE PAD FOR VENT RISERS. PER TANK & PIPING PLANS.
- 51B LIMITS OF SAWCUT AND PAVEMENT REMOVAL.

SITE DETAILS - SEE DETAIL SHEETS

- 1B TYPE "B" CONCRETE CURB & GUTTER.
- 2E DUMPSTER ENCLOSURE
- 2F CONSTRUCTION SAFETY FENCE
- 3D CONCRETE SIDEWALK
- 3M WHEELCHAIR RAMP IN SIDEWALK
- 5A GUARD POST (SINGLE)
- 5B TRAFFIC SIGN IN BOLLARD
- 6B SCREEN WALL
- 9S ACCESSIBLE / VAN ACCESSIBLE PARKING SIGN (TYP.)
- 9A ACCESSIBLE PARKING SYMBOL (SEE PAINT COLOR INDICATED AT SYMBOL)
- 10A TRAFFIC FLOW ARROW (TYP.)
- 10B STOP BAR (TYP.)
- 11D "RIGHT TURN ONLY" SIGN
- 11K "NO PARKING FIRE LANE" SIGN
- 12B BICYCLE BACK
- 12G "STOP" SIGN
- 12N MOTORCYCLE PARKING SIGN PER CITY OF ALBUQUERQUE STANDARDS
- 13A SITE LIGHT POLE. SEE PHOTOMETRIC PLANS FOR POLE BASE DETAIL, FIXTURE TYPE, AND MOUNTING DETAILS.

PARKING INFORMATION:
MURPHY

PARKING INFORMATION: MURPHY						
DESCRIPTION	BUILDING AREA (S.F.)	REQUIRED:				
		RATIO	SPACES			
MURPHY OIL	AREA	/1000 S.F.	REGULAR	ACCESSIBLE	VAN ACCESSIBLE	TOTAL
		5	6	1	1	6
STALL DIMENSIONS:		PROVIDED:				
9' X 20'		RATIO	SPACES			
		/1000 S.F.	REGULAR	ACCESSIBLE	VAN ACCESSIBLE	TOTAL
		7	6	1	1	7

CURVE TABLE						
CURVE	LENGTH	RADIUS	TANGENT	CHORD	CHORD BEARING	DELTA
C1	192.31'	1054.93'	96.42'	192.05'	N81°36'42"W	10°26'42"
C2	42.22'	25.00'	28.14'	37.38'	N38°27'13"W	96°45'40"
C3	110.99'	733.94'	55.60'	110.89'	N141°53'34"E	8°39'53"
C4	11.24'	15.00'	5.90'	10.98'	N82°29'13"E	42°55'21"



N.M. STATE HIGHWAY No. 528

SHEET NO. C-1

AUG 23 2017

SITE PLAN
MURPHY EXPRESS
3751 HIGHWAY 528 NW
ALBUQUERQUE NEW MEXICO

GreenbergFarrow
1430 W. PEACHTREE ST. NW SUITE 200
ATLANTA, GA 30309
PHONE: (404) 525-4000
FAX: (404) 525-4001
DWG NAME: ALBUQUERQUE, NM
JOB NO.: 20160897.0

MURPHY OIL USA, INC.
200 PEACH STREET
EL DORADO, AR 71730
MURPHY USA

AL.T.A. / N.S.P.S. LAND TITLE SURVEY OF
TRACT C-2
SEVEN - BAR RANCH
CITY OF ALBUQUERQUE
BERNALILLO COUNTY, NEW MEXICO
MAY, 2017

LEGEND

- Sanitary Sewer Manhole
- Power Pole w/underground feed
- Power Pole
- High Voltage Tower
- Guy Wire
- Overhead Wires
- Water Meter
- Water Valve
- Hydrant
- Electric Meter
- Traffic Box
- Overhead Traffic Light Pole
- Fence
- Hand Railing
- Light Pole
- Ballard
- Concrete Symbol
- Telephone Pedestal
- Underground Electric line
- Underground Communications Line
- Underground Gas Line
- Underground Water Line
- Sanitary Sewer Line
- Storm Drain Line
- Control Point
- Wall

CURVE TABLE						
CURVE	LENGTH	RADIUS	TANGENT	CHORD	CHORD BEARING	DELTA
C1	192.31'	1054.93'	96.42'	192.05'	N81°36'42"W	10°26'42"
C2	42.22'	25.00'	28.14'	37.38'	N38°27'13"W	96°45'40"
C3	110.99'	733.94'	55.60'	110.89'	N14°15'34"E	8°39'53"
C4	11.24'	15.00'	5.90'	10.98'	N82°29'13"E	42°55'21"

GRAPHIC SCALE



(IN FEET)
1 inch = 20 ft.



SHEET 2 OF 2

SURV+TEK, INC.
Consulting Surveyors

9384 Valley View Drive, N.W. Albuquerque, New Mexico 87114 Phone: 505-897-3366 Fax: 505-897-3377

170270_5-1-17.DWG

AMERICAN ROAD N.W.

TRACT C-1B-1
SEVEN-BAR RANCH
Filed December 30, 1997, Vol. 97C, Page 308

COTTONWOOD DRIVE N.W.

N.M. STATE HIGHWAY No. 528


BLOCK 1
SKYVIEW ACRES
Filed October 2, 1992, Vol. D3, Page 47

PK Nail with aluminum disk
stamped "SURV-TEK CONTROL"
North= 1532727.93'
East= 1519522.64'
Elevation= 5059.81'

TRACT C-2

TRACT C-3-A1-A1-A1
SEVEN-BAR RANCH
Filed March 28, 2008, Vol. 2008A, Page 68

Albuquerque Control Survey Monument "10-A14"
New Mexico State Plane Coordinates
Central Zone - NAD 83
North= 1,528,973.229 feet
East= 1,521,354.471 feet
Ground to Grid Factor= 0.999979709
Mapping Angles -001°34'11"
Elevation= 5058.821 feet

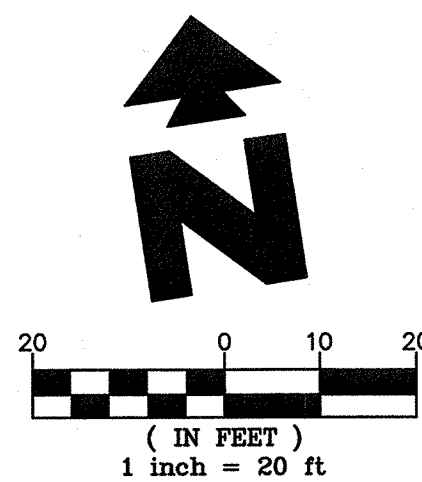

GRADING NARRATIVE

THE EXISTING TOPOGRAPHY ON THIS SITE SLOPES FROM NORTH TO SOUTH TOWARDS THE HIGHWAY. THERE ARE EXISTING STORMWATER FLUMES IN THE SOUTHEAST CORNER OF THE SITE. THE ADJACENT STREET TO THE NORTH SHEET FLOWS FROM WEST TO EAST, AND THE STREET TO THE WEST SHEET FLOWS FROM NORTH TO SOUTH. THERE IS AN EXISTING STORMWATER TRENCH TO THE SOUTH OF THE SITE. ACCORDING TO FLOOD MAP 35001C0109H (YEAR 2012) THE SITE IS IN FLOOD ZONE X AND IS NOT IN AN ESTABLISHED FLOOD PLAIN. PROPOSED GRADING IMPROVEMENTS INCLUDE A FINISHED FLOOR ELEVATION OF 5061.50' WITH SURROUNDING DRIVE ASLES AND PARKING TO MAINTAIN THE EXISTING DIRECTION OF STORMWATER FLOW AND THE CREATION OF A DEPRESSION ON THE EAST SIDE OF THE SITE FOR STORMWATER QUALITY WHERE PONDING WILL OCCUR. AREAS IN FRONT OF THE ICE MACHINE, PROPANE CAGE, AIRVAC, BIKIE RACK, AND ADA ACCESSIBLE PARKING SPACE ARE TO HAVE A MAXIMUM OF 2% CROSS SLOPE.

EXISTING

	Sanitary Sewer Manhole		Hand Railing
	Power Pole w/underground feed		Light Pole
	Power Pole		Ballard
	High Voltage Tower		Concrete Symbol
	Guy Wire		Telephone Pedestal
	Overhead Wires		Underground Electric Line
	Water Meter		Underground Communications Line
	Valve		Underground Gas Line
	Hydrant		Underground Water Line
	Electric Meter		Sanitary Sewer Line
	Traffic Box		Storm Drain Line
	Overhead Traffic Light Pole		Control Point
	Fence		Wall

PROPOSED

	PROPERTY LINE
	CONCRETE CURB AND GUTTER
	PROPOSED CONTOUR
	CONSTRUCTION FENCE
	CONSTRUCTION FENCE ON PAVEMENT (SEE DETAIL SHEETS)
	DRAINAGE SLOPE AND DIRECTION
	SPOT ELEVATIONS: XXXX TC XXXX C XXXX TOI XXXX EX XXXX TS
	PROPOSED STORM SEWER PIPE

GENERAL GRADING NOTES


- PRIOR TO INSTALLATION OF STORM OR SANITARY SEWER, WATER MAIN OR ANY OTHER UTILITIES, THE CONTRACTOR SHALL EXCAVATE, VERIFY, AND CALCULATE ALL POINTS OF CONNECTION AND ALL UTILITY CROSSINGS AND INFORM THE OWNER AND THE ENGINEER OF ANY CONFLICTS OR REQUIRED DEVIATIONS FROM THE PLAN PRIOR TO CONSTRUCTION. NOTIFICATION SHALL BE MADE A MINIMUM OF 72 HOURS PRIOR TO CONSTRUCTION. THE ENGINEER AND ITS CLIENTS SHALL BE HELD HARMLESS IN THE EVENT THAT THE CONTRACTOR FAILS TO MAKE SUCH NOTIFICATION.
- ALL SLOPES AND AREAS DISTURBED BY CONSTRUCTION SHALL BE GRADED SMOOTH AND FOUR INCHES OF TOPSOIL APPLIED. IF ADEQUATE TOPSOIL IS NOT AVAILABLE ON SITE, THE CONTRACTOR SHALL PROVIDE TOPSOIL, APPROVED BY THE OWNER, AS NEEDED. THE AREA SHALL THEN BE SEED, SOAKED, FERTILIZED, MULCHED, WATERED AND MAINTAINED UNTIL HARDY GRASS GROWTH IS ESTABLISHED IN ALL AREAS. ANY RELOCATED TREES SHALL BE MAINTAINED UNTIL SUCH POINT AS TREE IS RE-ESTABLISHED. ANY AREAS DISTURBED FOR ANY REASON PRIOR TO FINAL ACCEPTANCE OF THE PROJECT SHALL BE CORRECTED BY THE CONTRACTOR AT NO ADDITIONAL COST TO THE OWNER.
- THE CONTRACTOR IS SPECIFICALLY CAUTIONED THAT THE LOCATION AND/OR ELEVATION OF EXISTING UTILITIES AS SHOWN ON THESE PLANS IS BASED ON RECORDS OF THE VARIOUS UTILITY COMPANIES AND WHERE POSSIBLE, MEASUREMENTS TAKEN IN THE FIELD. THE INFORMATION IS NOT TO BE RELIED ON AS BEING EXACT OR COMPLETE. THE CONTRACTOR MUST CALL THE APPROPRIATE UTILITY COMPANY AT LEAST 72 HOURS BEFORE ANY EXCAVATION TO REQUEST EXACT FIELD LOCATION OF UTILITIES.
- REFER TO GEOTECHNICAL REPORT FOR SPECIFIC SITE SOIL CONDITIONS AND CONSIDERATIONS.
- CONTRACTOR SHALL COMPLY COMPLETELY WITH THE LATEST STANDARDS OF OSHA DIRECTIVES OR ANY OTHER AGENCY HAVING JURISDICTION FOR EXCAVATION AND TRENCHING PROCEDURES. THE CONTRACTOR SHALL USE SUPPORT SYSTEMS, SLOPING, BENCHING AND OTHER MEANS OF PROTECTION. THIS IS TO INCLUDE, BUT NOT LIMITED TO, ACCESS AND EGRESS FROM ALL EXCAVATION AND TRENCHING. CONTRACTOR IS RESPONSIBLE FOR COMPLYING WITH PERFORMANCE CRITERIA AS REQUIRED BY OSHA.
- ALL HDPE SHALL BE N-12 WT IB (OR EQUIVALENT) WITH SMOOTH INTERIOR AND ANNUAL EXTERIOR CORRUGATIONS. 4"-60" PIPE SHALL MEET ASTM F2848 (OR ASHTO M252 TYPE S) REQUIREMENTS, AND SHALL HAVE A MINIMUM MANNINGS "n" DESIGN VALUE OF 0.012. JOINTS SHALL BE WATER TIGHT ACCORDING TO ASTM D3212 (OR ASHTO M252, M294) REQUIREMENTS. GASKETS SHALL MEET THE REQUIREMENTS OF ASTM F477. JOINT PERFORMANCE, FITTINGS, MATERIAL PROPERTIES, AND INSTALLATION SHALL BE DONE PER THE COMPLETE ADS SPECIFICATION FOR ADS N-12 WT IB PIPE FOUND IN THE ADS, INC. DRAINAGE HANDBOOK, LATEST EDITION.
- IF USING HDPE PERFORATED PIPE FOR SUBSURFACE DRAINAGE AND DETENTION/RETENTION SYSTEMS, THE PERFORATIONS SHALL MEET THE ASHTO CLASS II STANDARD PERFORATION PATTERN REQUIREMENTS.
- ALL STORM SEWER LINES 18"-54" DIAMETER ARE TO BE REINFORCED CONCRETE PIPE ACCORDING TO ASTM C-76 TYPE III UNLESS OTHERWISE INDICATED.
- SPOT ELEVATIONS SHORTENED FOR CLARITY. ADD 5000 TO ELEVATIONS SHOWN.

GRADING NOTES

- 180 MATCH EXISTING PAVEMENT ELEVATIONS
- 51B LIMITS OF SAWCUT AND PAVEMENT REMOVAL
- 73A 2% MAXIMUM SLOPE

SHEET NO.

C-3

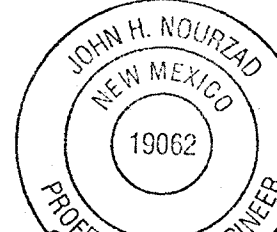

AUG 23 2017

GRADING PLAN
MURPHY EXPRESS
3751 HIGHWAY 528 NW
ALBUQUERQUE NEW MEXICO

GreenbergFarrow

1430 W. PEACHTREE ST. NW SUITE 200
ATLANTA, GA 30309
PHONE (404) 521-9000
FAX (404) 521-9070
DWG NAME: ALBUQUERQUE, NM
JOB NO.: 20160897.0

MURPHY OIL USA, INC.

MURPHY
USA

200 PEACH STREET
EL DORADO, AR 71730





WATER QUALITY REQUIREMENT

0.34 IN X IMPERVIOUS AREA:

0.34 IN X (1FT/12IN) X 29510 FT²
= 836 FT³

POST-DEV LAND USE

IMPERVIOUS AREA	0.68 AC
PERVIOUS AREA	0.57 AC
TOTAL AREA	1.25 AC

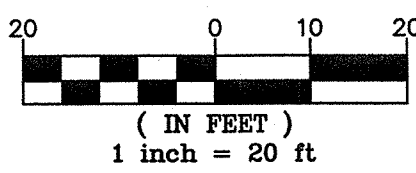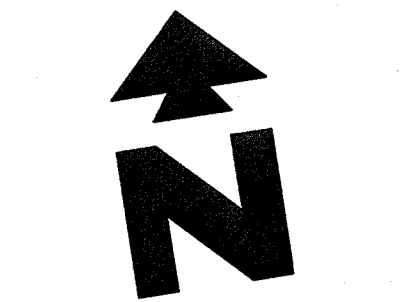

EXISTING

Sanitary Sewer Manhole	Hand Railing
Power Pole w/underground feed	Light Pole
Power Pole	Bollard
High Voltage Tower	Concrete Symbol
Guy Wire	Telephone Pedestal
Overhead Wires	Underground Electric Line
Water Meter	Underground Communications Line
Water Valve	Underground Gas Line
Hydrant	Underground Water Line
Electric Meter	Sanitary Sewer Line
Traffic Box	Storm Drain Line
Overhead Traffic Light Pole	Control Point
Fence	Wall

PROPOSED

PROPERTY LINE	CONCRETE CURB AND GUTTER
PROPOSED CONTOUR	CONSTRUCTION FENCE
CF	CONSTRUCTION FENCE ON PAVEMENT (SEE DETAIL SHEETS)
CFP	DRAINAGE SLOPE AND DIRECTION
STM	PROPOSED STORM SEWER PIPE

GENERAL GRADING NOTES

- PRIOR TO INSTALLATION OF STORM OR SANITARY SEWER, WATER MAIN OR ANY OTHER UTILITIES, THE CONTRACTOR SHALL EXCAVATE, VERIFY, AND CALCULATE ALL POINTS OF CONNECTION AND ALL UTILITY CROSSINGS AND INFORM THE OWNER AND THE ENGINEER OF ANY CONFLICTS OR REQUIRED DEVIATIONS FROM THE PLAN PRIOR TO CONSTRUCTION. NOTIFICATION SHALL BE MADE A MINIMUM OF 72 HOURS PRIOR TO CONSTRUCTION. THE ENGINEER AND ITS CLIENTS SHALL BE HELD HARMLESS IN THE EVENT THAT THE CONTRACTOR FAILS TO MAKE SUCH NOTIFICATION.
- ALL SLOPES AND AREAS DISTURBED BY CONSTRUCTION SHALL BE GRADED SMOOTH AND FOUR INCHES OF TOPSOIL APPLIED. IF ADEQUATE TOPSOIL IS NOT AVAILABLE ON SITE, THE CONTRACTOR SHALL PROVIDE TOPSOIL, APPROVED BY THE OWNER, AS NEEDED. THE AREA SHALL THEN BE SEEDDED/SOODED, FERTILIZED, MULCHED, WATERED AND MAINTAINED UNTIL HARDY GRASS GROWTH IS ESTABLISHED IN ALL AREAS. ANY RELOCATED TREES SHALL BE MAINTAINED UNTIL SUCH POINT AS TREE IS RE-ESTABLISHED. ANY AREAS DISTURBED FOR ANY REASON PRIOR TO FINAL ACCEPTANCE OF THE PROJECT SHALL BE CORRECTED BY THE CONTRACTOR AT NO ADDITIONAL COST TO THE OWNER.
- THE CONTRACTOR IS SPECIFICALLY CAUTIONED THAT THE LOCATION AND/OR ELEVATION OF EXISTING UTILITIES AS SHOWN ON THESE PLANS IS BASED ON RECORDS OF THE VARIOUS UTILITY COMPANIES, AND WHERE POSSIBLE, MEASUREMENTS TAKEN IN THE FIELD. THE INFORMATION IS NOT TO BE RELIED ON AS BEING EXACT OR COMPLETE. THE CONTRACTOR MUST CALL THE APPROPRIATE UTILITY COMPANY AT LEAST 72 HOURS BEFORE ANY EXCAVATION TO REQUEST EXACT FIELD LOCATION OF UTILITIES.
- REFER TO GEOTECHNICAL REPORT FOR SPECIFIC SITE SOIL CONDITIONS AND CONSIDERATIONS.
- CONTRACTOR SHALL COMPLY COMPLETELY WITH THE LATEST STANDARDS OF OSHA DIRECTIVES OR ANY OTHER AGENCY HAVING JURISDICTION FOR EXCAVATION AND TRENCHING PROCEDURES. THE CONTRACTOR SHALL USE SUPPORT SYSTEMS, SLOPING, BENCHING AND OTHER MEANS OF PROTECTION. THIS IS TO INCLUDE, BUT NOT LIMITED TO ACCESS AND EGRESS FROM ALL EXCAVATION AND TRENCHING. CONTRACTOR IS RESPONSIBLE FOR COMPLYING WITH PERFORMANCE CRITERIA AS REQUIRED BY OSHA.
- ALL HDPE SHALL BE N-12 WT IB (OR EQUIVALENT) WITH SMOOTH INTERIOR AND ANNUAL EXTERIOR CORRUGATIONS. 4'-60" PIPE SHALL MEET ASTM F2848 (OR ASHTO M252 TYPE S) REQUIREMENTS, AND SHALL HAVE A MINIMUM MANNINGS "n" DESIGN VALUE OF 0.012. JOINTS SHALL BE WATERTIGHT ACCORDING TO ASTM D3212 (OR ASHTO M252, M294) REQUIREMENTS. GASKETS SHALL MEET THE REQUIREMENTS OF ASTM F477, JOINT PERFORMANCE, FITTINGS, MATERIAL PROPERTIES, AND INSTALLATION SHALL BE DONE PER THE COMPLETE ADS SPECIFICATION FOR ADS N-12 WT IB PIPE FOUND IN THE ADS, INC. DRAINAGE HANDBOOK, LATEST EDITION.
- IF USING HDPE PERFORATED PIPE FOR SUBSURFACE DRAINAGE AND DETENTION/RETENTION SYSTEMS, THE PERFORATIONS SHALL MEET THE ASHTO CLASS II STANDARD PERFORATION PATTERN REQUIREMENTS.
- ALL STORM SEWER LINES 18"-54" DIAMETER ARE TO BE REINFORCED CONCRETE PIPE ACCORDING TO ASTM C-76 TYPE III UNLESS OTHERWISE INDICATED.


STORM DETAILS - SEE DETAIL SHEETS

- 17S EXISTING FLUME WITH STEEL PLATE/SIDEWALK
- 19A CONCRETE HEADWALL
- 23D STORM DRAIN MANHOLE
- 23E COMBINATION INLET
- 23G TEE CONNECTION (INSERTA TEE OR EQUIVALENT WATER TIGHT CONNECTION)
- 27E STORM DRAIN CLEAN-OUT
- 27H ROOF DRAIN DOWNSPOUT CONNECTION
- 27J CATCHY DRAIN DOWNSPOUT CONNECTION
- 28A STORM SEWER TRENCH AND BEDDING
- 73F WATERSTOP STRUCTURE CONNECTION FOR HDPE PIPE



SHEET NO.

C-3.1

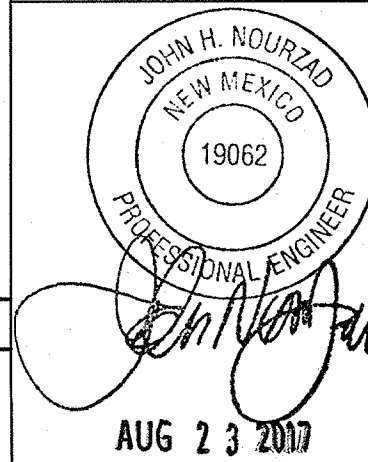

STORM SEWER PLAN

MURPHY EXPRESS

3751 HIGHWAY 528 NW

ALBUQUERQUE NEW MEXICO

GreenbergFarrow


1430 W. PEACHTREE ST., NW SUITE 200
ATLANTA, GA 30309
TEL: (404) 525-8800
FAX: (404) 525-8801
DWG NAME: ALBUQUERQUE, NM
JOB NO.: 2016097.0

MURPHY OIL USA, INC.

MURPHY
USA

200 PEACH STREET
EL DORADO, AR 71730

N.M. STATE HIGHWAY No. 528

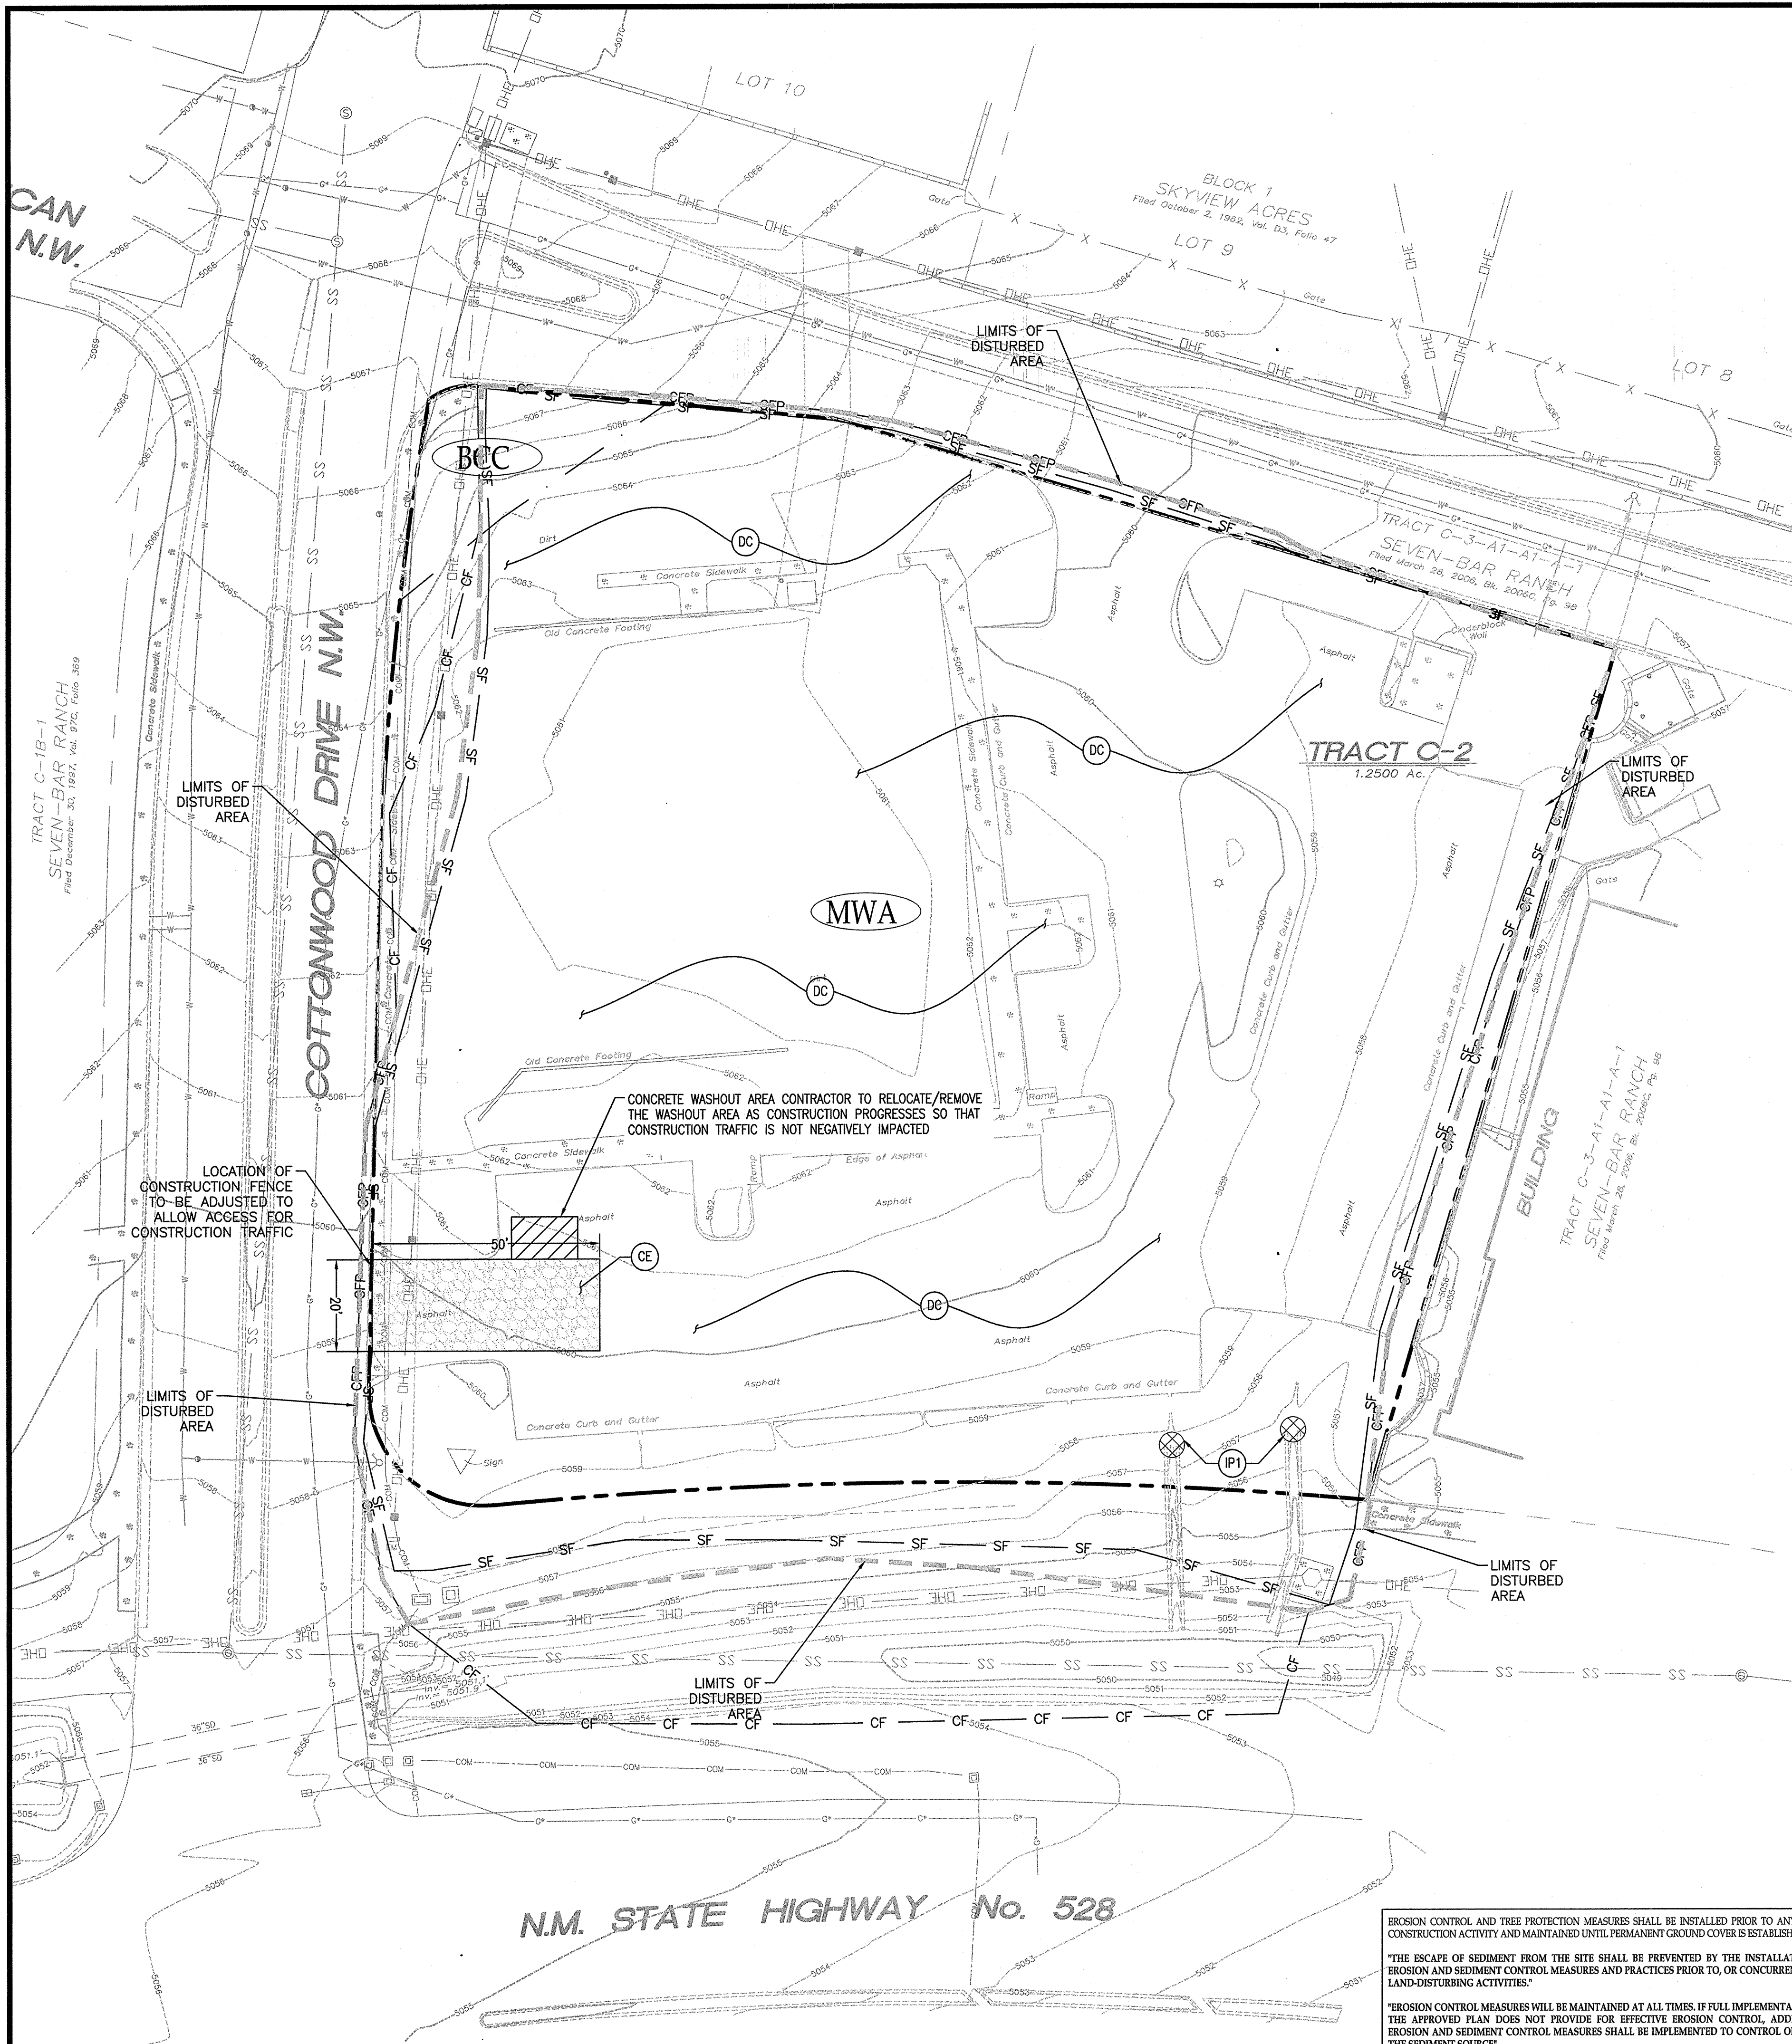

GENERAL EROSION NOTES

- CONTRACTOR SHALL IMPLEMENT BEST MANAGEMENT PRACTICES AS REQUIRED BY THIS STORM WATER POLLUTION PREVENTION PLAN. ADDITIONAL BEST MANAGEMENT PRACTICES SHALL BE IMPLEMENTED AS DICTATED BY CONDITIONS AT NO ADDITIONAL COST OF OWNER THROUGHOUT ALL PHASES OF CONSTRUCTION.
- BEST MANAGEMENT PRACTICES (BMP'S) AND CONTROLS SHALL CONFORM TO FEDERAL, STATE, OR LOCAL REQUIREMENTS OR MANUAL OF PRACTICE, AS APPLICABLE. CONTRACTOR SHALL IMPLEMENT ADDITIONAL CONTROLS AS DIRECTED BY PERMITTING AGENCY OR OWNER.
- SITE MAP MUST CLEARLY DELINEATE ALL STATE WATERS. PERMITS FOR ANY CONSTRUCTION ACTIVITY IMPACTING STATE WATERS OR REGULATED WETLANDS MUST BE MAINTAINED ON SITE AT ALL TIMES.
- CONTRACTOR TO LIMIT DISTURBANCE OF SITE IN STRICT ACCORDANCE WITH EROSION CONTROL SEQUENCING SHOWN ON THIS PLAN, OR AS REQUIRED BY THE APPLICABLE GENERAL PERMIT. NO UNNECESSARY OR IMPROPERLY SEQUENCED CLEARING AND/OR GRADING SHALL BE PERMITTED.
- GENERAL CONTRACTOR SHALL DENOTE ON PLAN THE TEMPORARY PARKING AND STORAGE AREA WHICH SHALL ALSO BE USED AS THE EQUIPMENT MAINTENANCE AND CLEANING AREA, EMPLOYEE PARKING AREA, AND AREA FOR LOCATING PORTABLE FACILITIES, OFFICE TRAILERS, AND TOILET FACILITIES. CONTRACTOR SHALL CONSTRUCT TEMPORARY BERM ON DOWNSTREAM SIDES AS NEEDED.
- ALL WASH WATER (CONCRETE TRUCKS, VEHICLE CLEANING, EQUIPMENT CLEANING, ETC.) SHALL BE DETAINED AND PROPERLY TREATED OR DISPOSED.
- SUFFICIENT OIL AND GREASE ABSORBING MATERIALS AND FLotation BOOMS SHALL BE MAINTAINED ON SITE OR READILY AVAILABLE TO CONTAIN AND CLEAN-UP FUEL OR CHEMICAL SPILLS AND LEAKS.
- DUST ON THE SITE SHALL BE MINIMIZED. THE USE OF MOTOR OILS AND OTHER PETROLEUM BASED OR TOXIC LIQUIDS FOR DUST SUPPRESSION OPERATIONS IS PROHIBITED.
- RUBBISH, TRASH, GARBAGE, LITTER, OR OTHER SUCH MATERIALS SHALL BE DEPOSITED INTO SEALED CONTAINERS. MATERIALS SHALL BE PREVENTED FROM LEAVING THE PREMISES THROUGH THE ACTION OF WIND OR STORMWATER DISCHARGE INTO DRAINAGE DITCHES OR WATERS OF THE STATE.
- ALL DENUDE/BARE AREAS THAT WILL BE INACTIVE FOR 14 DAYS OR MORE, MUST BE STABILIZED IMMEDIATELY UPON COMPLETION OF MOST RECENT GRADING ACTIVITY, WITH THE USE OF FAST-GERMINATING ANNUAL GRASS/GRAIN VARIETIES, STRAW/HAY MULCH, WOOD CELLULOSE FIBERS, TACKIFIERS, NETTING OR BLANKETS.
- DISTURBED PORTIONS OF THE SITE WHERE CONSTRUCTION ACTIVITY HAS PERMANENTLY STOPPED SHALL BE PERMANENTLY STABILIZED AS SHOWN ON THE PLANS. THESE AREAS SHALL BE SEEDED, SOILED, AND/OR VEGETATED IMMEDIATELY, OR STABILIZED AS SHOWN ON PLANS. NO LATER THAN 14 DAYS AFTER THE LAST CONSTRUCTION ACTIVITY OCCURRING IN THESE AREAS, REFER TO THE GRADING PLAN AND/OR LANDSCAPE PLAN.
- IF THE ACTION OF VEHICLES TRAVELING OVER THE GRAVEL CONSTRUCTION ENTRANCES IS NOT SUFFICIENT TO PREVENT TRACKING OF DIRT, DUST OR MUD, THEN THE TIRES MUST BE WASHED BEFORE THE VEHICLES ENTER A PUBLIC ROAD. PROVISIONS MUST BE MADE TO INTERCEPT THE WASH WATER AND TRAP THE SEDIMENT BEFORE IT IS CARRIED OFF THE SITE. ONLY USE INGRESS/EGRESS LOCATIONS AS PROVIDED.
- ALL MATERIALS SPILLED, DROPPED, WASHED, OR TRACKED FROM VEHICLES ONTO ROADWAYS OR INTO STORM DRAINS MUST BE REMOVED IMMEDIATELY.
- CONTRACTORS OR SUBCONTRACTORS WILL BE RESPONSIBLE FOR REMOVING SEDIMENT IN THE DETENTION POND MADE UP OF AN EXISTING COMMERCIAL LOT. STORM RUN-OFF FROM THE SITE WILL PIPE INTO THE PROPOSED DETENTION POND CONSTRUCTED TO ACCOMMODATE STORM RUN-OFF FOR THE GAS STATION.
- ON-SITE AND OFF-SITE SOIL STOCKPILE AND BORROW AREAS SHALL BE PROTECTED FROM EROSION AND SEDIMENTATION THROUGH IMPLEMENTATION OF BEST MANAGEMENT PRACTICES. STOCKPILE AND BORROW AREA LOCATIONS SHALL BE NOTED ON THE SITE MAP AND PERMITTED IN ACCORDANCE WITH GENERAL PERMIT REQUIREMENTS.
- SLOPES SHALL BE LEFT IN A ROUGHENED CONDITION DURING THE GRADING PHASE TO REDUCE RUNOFF VELOCITIES AND EROSION.
- DUE TO THE GRADE CHANGES DURING THE DEVELOPMENT OF THE PROJECT, THE CONTRACTOR SHALL BE RESPONSIBLE FOR ADJUSTING THE EROSION AND SEDIMENT CONTROL MEASURES (SILT FENCES, ETC.) TO PREVENT EROSION AND POLLUTANT DISCHARGE.
- GENERAL CONTRACTOR IS TO DESIGNATE/IDENTIFY AREAS ON THE SITE MAPS, INSIDE OF THE LIMITS OF DISTURBANCE, FOR WASTE DISPOSAL AND DELIVERY AND MATERIAL STORAGE.

SEQUENCE OF CONSTRUCTION

- PHASE I**
- INSTALL STABILIZED CONSTRUCTION ENTRANCES.
 - PREPARE TEMPORARY PARKING AND STORAGE AREA.
 - CONSTRUCT THE SILT FENCES ON THE SITE.
 - INSTALL ALL PERIMETER SEDIMENT MEASURES.
 - INSTALL ALL TEMPORARY EROSION & SEDIMENT CONTROLS AS NEEDED.
 - INSTALL FLUME PROTECTION DEVICES.
 - CLEAR AND GRUB THE SITE.
 - BEGIN GRADING THE SITE.
- PHASE II**
- START CONSTRUCTION OF BUILDING PAD, STRUCTURES, AND OFF-SITE IMPROVEMENTS.
 - TEMPORARILY SEED DENUDE AREAS.
 - INSTALL UTILITIES, UNDERDRAINS, STORM SEWERS, CURBS AND GUTTERS.
 - INSTALL INLET PROTECTION DEVICES.
 - INSTALL RIP RAP AROUND OUTLET STRUCTURES.
 - PREPARE SITE FOR PAVING.
 - PAVE SITE.
 - COMPLETE GRADING AND INSTALL PERMANENT SEEDING AND PLANTING.
 - REMOVE EROSION AND TEMPORARY SEDIMENT CONTROL DEVICES AFTER FINAL STABILIZATION IS ACHIEVED.

BMP MAINTENANCE NOTES


- ALL MEASURES STATED ON THIS SITE MAP, AND IN THE STORM WATER POLLUTION PREVENTION PLAN, SHALL BE MAINTAINED IN FULLY FUNCTIONAL CONDITION UNTIL NO LONGER REQUIRED FOR A COMPLETED PHASE OF WORK OR FINAL STABILIZATION OF THE SITE. ALL EROSION AND SEDIMENTATION CONTROL MEASURES SHALL BE CHECKED BY A QUALIFIED PERSON IN ACCORDANCE WITH THE CONTRACT DOCUMENTS OR THE APPLICABLE PERMIT, WHICHEVER IS MORE STRINGENT, AND REPAIRED IN ACCORDANCE WITH THE FOLLOWING:
- INLET PROTECTION DEVICES AND BARRIERS SHALL BE REPAIRED OR REPLACED IF THEY SHOW SIGNS OF UNDERMINING OR DETERIORATION.
 - ALL SEEDED AREAS SHALL BE CHECKED REGULARLY TO SEE THAT GOOD STAND IS MAINTAINED. AREAS SHOULD BE FERTILIZED, WATERED, AND RESEED AS NEEDED.
 - SILT FENCES SHALL BE REPAIRED TO THEIR ORIGINAL CONDITIONS IF DAMAGED. SEDIMENT SHALL BE REMOVED FROM THE SILT FENCES WHEN IT REACHES ONE-HALF OF THE SILT FENCE.
 - THE CONSTRUCTION EXITS SHALL BE MAINTAINED IN A CONDITION WHICH WILL PREVENT TRACKING OR FLOW OF MUD ONTO PUBLIC RIGHTS-OF-WAY. THIS MAY REQUIRE PERIODIC TOP DRESSING OF THE CONSTRUCTION EXITS AS CONDITIONS DEMAND.
 - THE TEMPORARY PARKING AND STORAGE AREA SHALL BE KEPT IN GOOD CONDITION (SUITABLE FOR PARKING AND STORAGE). THIS MAY REQUIRE PERIODIC TOP DRESSING OF THE TEMPORARY PARKING AREA AS CONDITIONS DEMAND.
 - FILTER TUBES SHALL BE REPAIRED TO THEIR ORIGINAL CONDITIONS IF DAMAGED. SEDIMENT SHALL BE REMOVED FROM TUBES WHEN IT REACHES 1/2 OF ITS EXPOSED HEIGHT. SEE DETAILS.
 - PRIOR TO LEAVING THE SITE, ALL VEHICLES SHALL BE CLEANED OF DEBRIS. ANY DEBRIS AND/OR SEDIMENT REACHING THE PUBLIC STREET SHALL BE CLEANED IMMEDIATELY BY A METHOD OTHER THAN FLUSHING.

EROSION CONTROL AND TREE PROTECTION MEASURES SHALL BE INSTALLED PRIOR TO ANY OTHER CONSTRUCTION ACTIVITY AND MAINTAINED UNTIL PERMANENT GROUND COVER IS ESTABLISHED.

"THE ESCAPE OF SEDIMENT FROM THE SITE SHALL BE PREVENTED BY THE INSTALLATION OF EROSION AND SEDIMENT CONTROL MEASURES AND PRACTICES PRIOR TO, OR CONCURRENT WITH LAND-DISTURBING ACTIVITIES."

"EROSION CONTROL MEASURES WILL BE MAINTAINED AT ALL TIMES. IF FULL IMPLEMENTATION OF THE APPROVED PLAN DOES NOT PROVIDE FOR EFFECTIVE EROSION CONTROL, ADDITIONAL EROSION AND SEDIMENT CONTROL MEASURES SHALL BE IMPLEMENTED TO CONTROL OR TREAT THE SEDIMENT SOURCE."

24 HR EMERGENCY CONTACT:
JASON LAIRD 870-866-7681

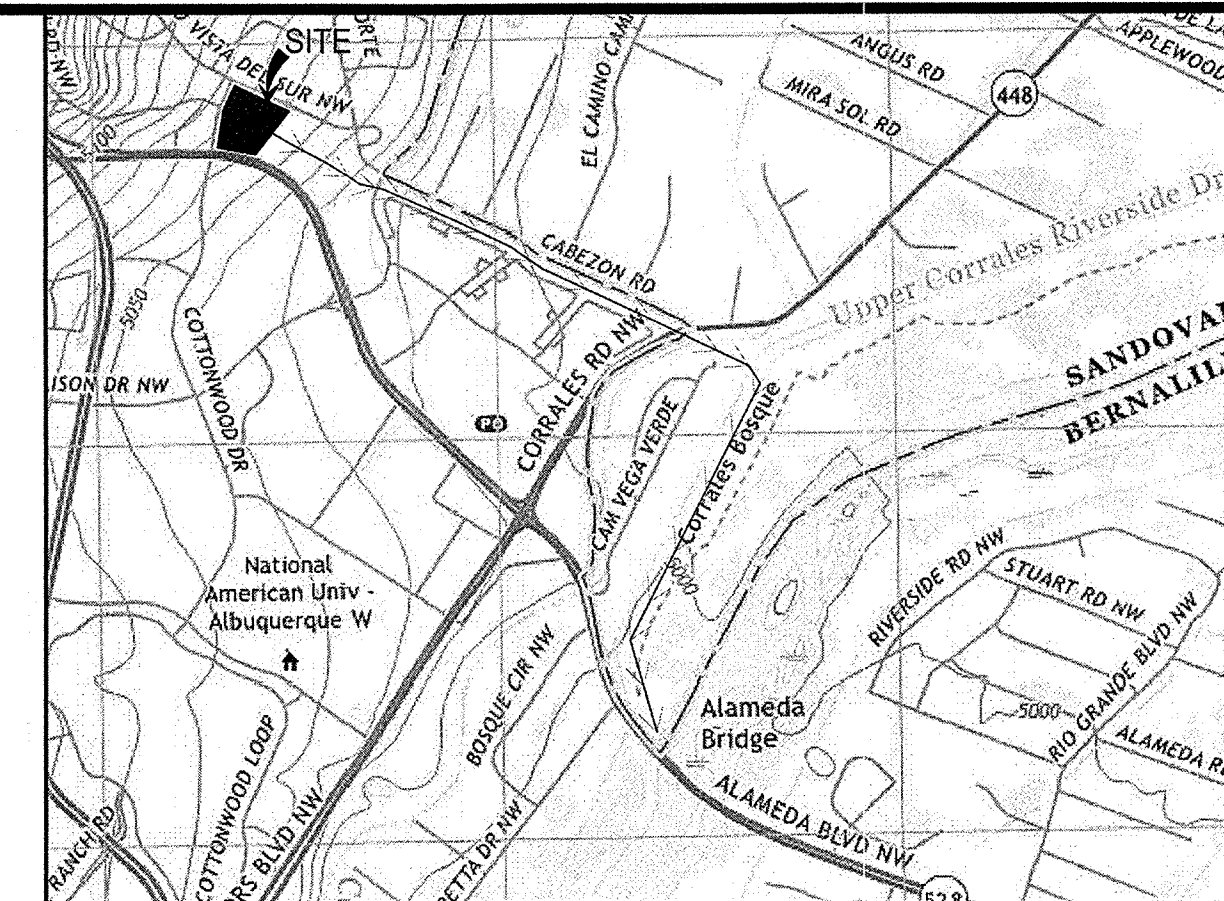

EXISTING

Sanitary Sewer Manhole	Hand Rolling
Power Pole	Light Pole
W/underground feed	Bollard
Power Pole	Concrete Symbol
High Voltage Tower	Telephone Pedestal
Guy Wire	Underground Electric Line
Overhead Wires	Underground Communications Line
Water Meter	Underground Gas Line
Water Valve	Underground Water Line
Hydrant	Sanitary Sewer Line
Electric Meter	Storm Drain Line
Traffic Box	Control Point
Overhead Traffic Light Pole	Wall
Fence	

PROPOSED

BOUNDARY LINE
CONSTRUCTION FENCE
LIMITS OF DISTURBED AREA
CONSTRUCTION FENCE ON PAVEMENT (SEE DETAIL SHEETS)
SOIL TYPE DESIGNATION
SOIL TYPE BOUNDARY LINE

PROJECT INFORMATION

RECEIVING WATER IS UN-NAMED LOCAL DEPRESSION. DEPRESSION EVENTUALLY CONNECTS TO THE RIO GRANDE ± 1 MILE FROM THE PROJECT SITE.

PROPOSED PROJECT SITE MADE UP OF AN EXISTING COMMERCIAL LOT. STORM RUN-OFF FROM THE SITE WILL PIPE INTO THE PROPOSED DETENTION POND CONSTRUCTED TO ACCOMMODATE STORM RUN-OFF FOR THE GAS STATION.

PROPOSED PROJECT IS CONSTRUCTING A GAS STATION CONSISTING OF 1200 S.F. CONVENIENT STORE WITH (8) PUMP ISLANDS AND ASSOCIATED PARKING AREA.

ACREAGE OF SITE IS 1.25 ACRES.

DISTURBED ACREAGE OF SITE (INCLUDING OFF-SITE WORK) IS 1.25 ACRES.

ANTICIPATED CONSTRUCTION START DATE IS APRIL 2018 AND COMPLETION DATE IS JULY 2018.

CONTRACTOR TO TAKE APPROPRIATE MEASURES TO KEEP SEDIMENT FROM ESCAPING SITE AND ALL ACCUMULATED SEDIMENT SHALL BE CLEANED OUT AND REMOVED FROM SITE.


DOWNSTREAM CONDITION WILL NOT BE NEGATIVELY AFFECTED BY PROPOSED DEVELOPMENT.

EROSION DETAILS -- SEE DETAIL SHEET C-4.2

CE	STABILIZED CONSTRUCTION ACCESS
SF	SEDIMENTATION/SILT FENCE WITH WIRE SUPPORT
DC	DUST CONTROL (USING: PHASING OF THE PROJECT, MULCH, SPRINKLING WATER, SPRAY-ON-ADHESIVE, CALCIUM CHLORIDE, BARRIERS, ETC.)
IP1	TEMP. BLOCK AND AGGREGATE FLUME SEDIMENT FILTER

SITE SOILS

MWA	MADUREZ-WINK ASSOCIATION
BCC	BLUEPOINT LOAMY FINE SAND

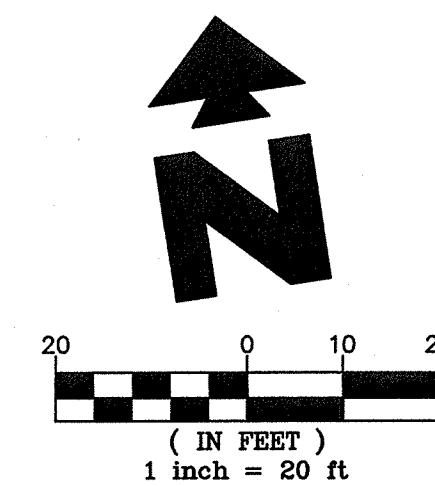

GreenbergFarrow

1430 W. PEACHTREE ST. NW SUITE 200
ATLANTA, GA 30309
TEL: (404) 601-3000
FAX: (404) 601-3001
DWG NAME: ALBUQUERQUE, NM
JOB NO.: 20160897.0

MURPHY OIL USA, INC.

MURPHY USA

200 PEACH STREET
EL DORADO, AR 71730

EROSION CONTROL PHASE 1

MURPHY EXPRESS

3751 HIGHWAY 528 NW

ALBUQUERQUE NEW MEXICO


SHEET NO. C-4

AUG 23 2017

JOHN H. NOURAD

PROFESSIONAL ENGINEER

13062

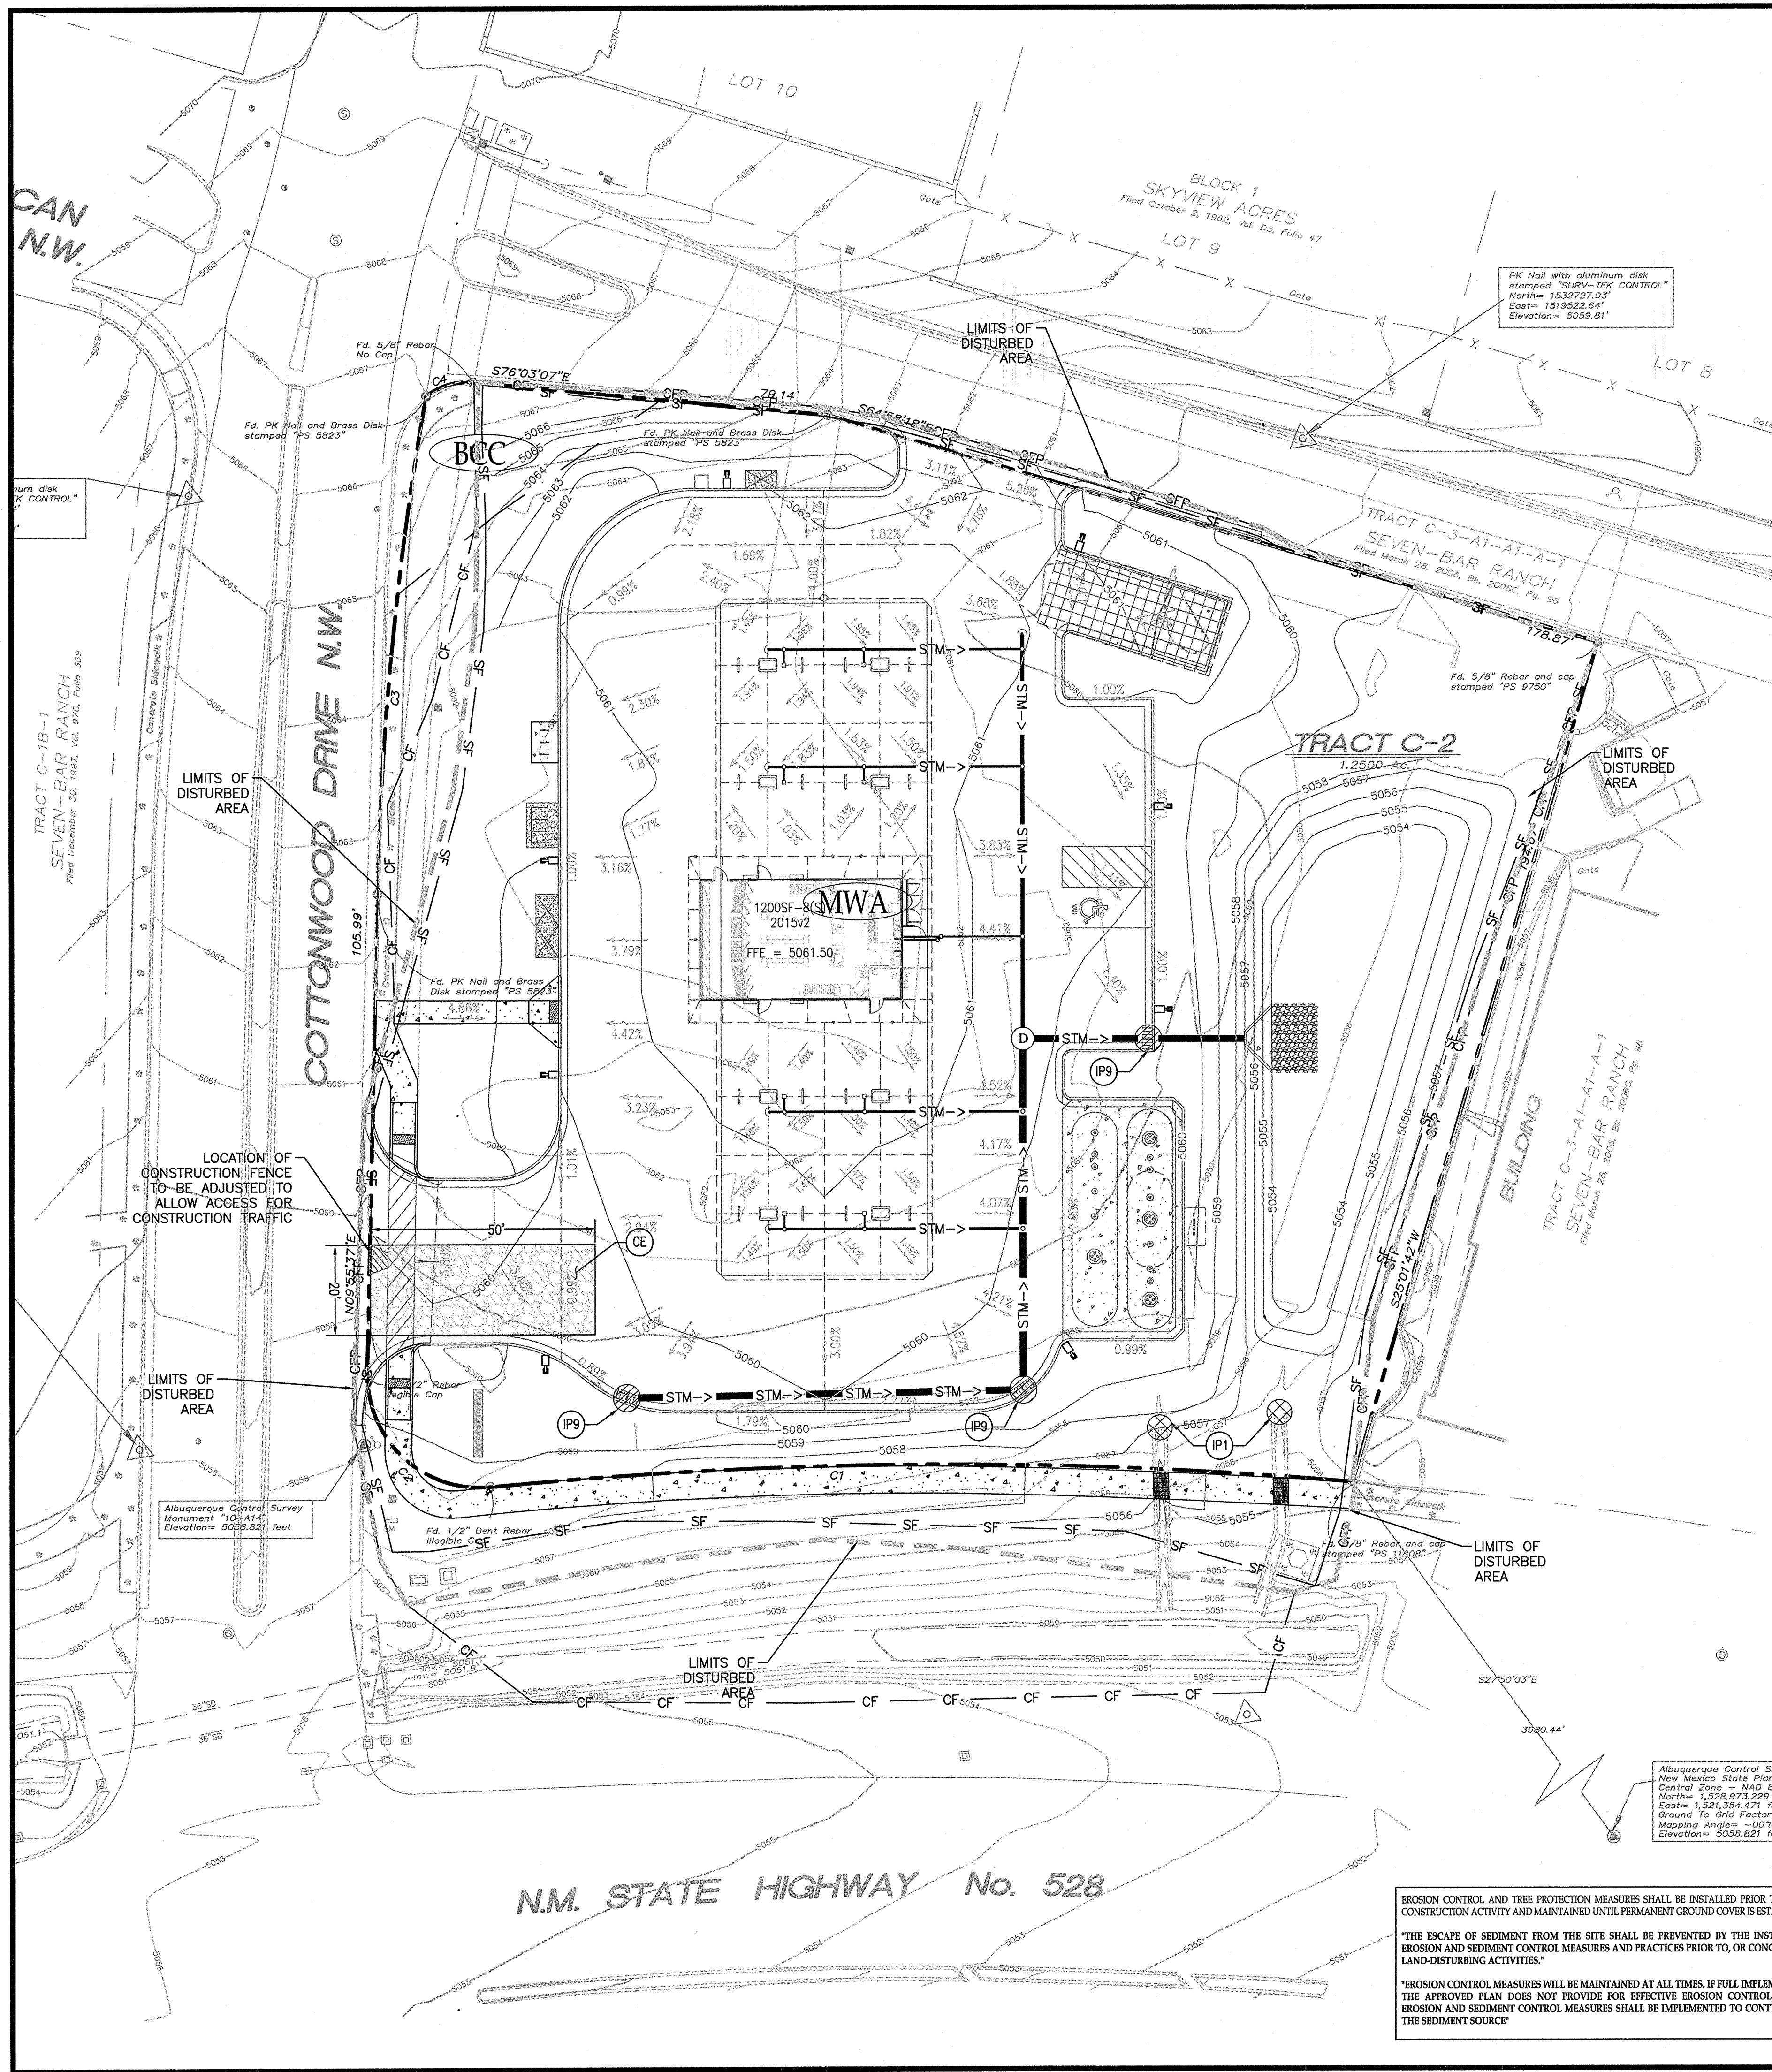

GENERAL EROSION NOTES

- CONTRACTOR SHALL IMPLEMENT BEST MANAGEMENT PRACTICES AS REQUIRED BY THIS STORM WATER POLLUTION PREVENTION PLAN. ADDITIONAL BEST MANAGEMENT PRACTICES SHALL BE IMPLEMENTED AS DICTATED BY CONDITIONS AT NO ADDITIONAL COST OF OWNER THROUGHOUT ALL PHASES OF CONSTRUCTION.
- BEST MANAGEMENT PRACTICES (BMP'S) AND CONTROLS SHALL CONFORM TO FEDERAL, STATE, OR LOCAL REQUIREMENTS OR MANUAL OF PRACTICE, AS APPLICABLE. CONTRACTOR SHALL IMPLEMENT ADDITIONAL CONTROLS AS DIRECTED BY PERMITTING AGENCY OR OWNER.
- SITE MAP MUST CLEARLY DELINEATE ALL STATE WATERS. PERMITS FOR ANY CONSTRUCTION ACTIVITY IMPACTING STATE WATERS OR REGULATED WETLANDS MUST BE MAINTAINED ON SITE AT ALL TIMES.
- CONTRACTOR TO LIMIT DISTURBANCE OF SITE IN STRICT ACCORDANCE WITH EROSION CONTROL SEQUENCING SHOWN ON THIS PLAN, OR AS REQUIRED BY THE APPLICABLE GENERAL PERMIT. NO UNNECESSARY OR IMPROPERLY SEQUENCED CLEARING AND/OR GRADING SHALL BE PERMITTED.
- GENERAL CONTRACTOR SHALL DENOTE ON PLAN THE TEMPORARY PARKING AND STORAGE AREA WHICH SHALL ALSO BE USED AS THE EQUIPMENT MAINTENANCE AND CLEANING AREA, EMPLOYEE PARKING AREA, AND AREA FOR LOCATING PORTABLE FACILITIES, OFFICE TRAILERS, AND TOILET FACILITIES. CONTRACTOR SHALL CONSTRUCT TEMPORARY BERM ON DOWNSTREAM SIDES AS NEEDED.
- ALL WASH WATER (CONCRETE TRUCKS, VEHICLE CLEANING, EQUIPMENT CLEANING, ETC.) SHALL BE DETAINED AND PROPERLY TREATED OR DISPOSED.
- SUFFICIENT OIL AND GREASE ABSORBING MATERIALS AND FLotation BOOMS SHALL BE MAINTAINED ON SITE OR READILY AVAILABLE TO CONTAIN AND CLEAN-UP FUEL OR CHEMICAL SPILLS AND LEAKS.
- DUST ON THE SITE SHALL BE MINIMIZED. THE USE OF MOTOR OILS AND OTHER PETROLEUM BASED OR TOXIC LIQUIDS FOR DUST SUPPRESSION OPERATIONS IS PROHIBITED.
- RUBBISH, TRASH, GARBAGE, LITTER, OR OTHER SUCH MATERIALS SHALL BE DEPOSITED INTO SEALED CONTAINERS. MATERIALS SHALL BE PREVENTED FROM LEAVING THE PREMISES THROUGH THE ACTION OF WIND OR STORMWATER DISCHARGE INTO DRAINAGE DITCHES OR WATERS OF THE STATE.
- ALL DENuded/BARE AREAS THAT WILL BE INACTIVE FOR 14 DAYS OR MORE, MUST BE STABILIZED IMMEDIATELY UPON COMPLETION OF MOST RECENT GRADING ACTIVITY, WITH THE USE OF FAST-GERMINATING ANNUAL GRASS/GRAN VARIETIES, STRAW/HAY MULCH, WOOD CELLULOSE FIBERS, TACKIFIERS, NETTING OR BLANKETS.
- DISTURBED PORTIONS OF THE SITE WHERE CONSTRUCTION ACTIVITY HAS PERMANENTLY STOPPED SHALL BE PERMANENTLY STABILIZED AS SHOWN ON THE PLANS. THESE AREAS SHALL BE SEEDED, SODDED, AND/OR VEGETATED IMMEDIATELY, OR STABILIZED AS SHOWN ON PLANS, NO LATER THAN 14 DAYS AFTER THE LAST CONSTRUCTION ACTIVITY OCCURRING IN THESE AREAS. REFER TO THE GRADING PLAN AND/OR LANDSCAPE PLAN.
- IF THE ACTION OF VEHICLES TRAVELING OVER THE GRAVEL CONSTRUCTION ENTRANCES IS NOT SUFFICIENT TO PREVENT TRACKING OF DIRT, DUST OR MUD, THEN THE TIRES MUST BE WASHED BEFORE THE VEHICLES ENTER A PUBLIC ROAD. PROVISIONS MUST BE MADE TO INTERCEPT THE WASH WATER AND TRAP THE SEDIMENT BEFORE IT IS CARRIED OFF THE SITE. ONLY USE INGRESS/EGRESS LOCATIONS AS PROVIDED.
- ALL MATERIALS SPILLED, DROPPED, WASHED, OR TRACKED FROM VEHICLES ONTO ROADWAYS OR INTO STORM DRAINS MUST BE REMOVED IMMEDIATELY.
- CONTRACTORS OR SUBCONTRACTORS WILL BE RESPONSIBLE FOR REMOVING SEDIMENT IN THE DETENTION POND THAT MAY HAVE COLLECTED IN THE STORM SEWER DRAINAGE SYSTEMS IN CONJUNCTION WITH THE STABILIZATION OF THE SITE.
- ON-SITE AND OFFSITE SOIL STOCKPILE AND BORROW AREAS SHALL BE PROTECTED FROM EROSION AND SEDIMENTATION THROUGH IMPLEMENTATION OF BEST MANAGEMENT PRACTICES. STOCKPILE AND BORROW AREA LOCATIONS SHALL BE NOTED ON THE SITE MAP AND PERMITTED IN ACCORDANCE WITH GENERAL PERMIT REQUIREMENTS.
- SLOPES SHALL BE LEFT IN A ROUGHENED CONDITION DURING THE GRADING PHASE TO REDUCE RUNOFF VELOCITIES AND EROSION.
- DUE TO THE GRADE CHANGES DURING THE DEVELOPMENT OF THE PROJECT, THE CONTRACTOR SHALL BE RESPONSIBLE FOR ADJUSTING THE EROSION AND SEDIMENT CONTROL MEASURES (SILT FENCES, ETC.) TO PREVENT EROSION AND POLLUTANT DISCHARGE.
- GENERAL CONTRACTOR IS TO DESIGNATE/IDENTIFY AREAS ON THE SITE MAPS, INSIDE OF THE LIMITS OF DISTURBANCE, FOR WASTE DISPOSAL AND DELIVERY AND MATERIAL STORAGE.


SEQUENCE OF CONSTRUCTION

- PHASE I**
- INSTALL STABILIZED CONSTRUCTION ENTRANCES.
 - PREPARE TEMPORARY PARKING AND STORAGE AREA.
 - CONSTRUCT THE SILT FENCES ON THE SITE.
 - INSTALL ALL PERIMETER SEDIMENT MEASURES.
 - INSTALL ALL TEMPORARY EROSION & SEDIMENT CONTROLS AS NEEDED.
 - INSTALL FLUME PROTECTION DEVICES.
 - CLEAR AND GRUB THE SITE.
 - BEGIN GRADING THE SITE.
- PHASE II**
- START CONSTRUCTION OF BUILDING PAD, STRUCTURES, AND OFF-SITE IMPROVEMENTS.
 - TEMPORARILY SEED DENuded AREAS.
 - INSTALL UTILITIES, UNDERDRAINS, STORM SEWERS, CURBS AND GUTTERS.
 - INSTALL INLET PROTECTION DEVICES.
 - INSTALL RIP RAP AROUND OUTLET STRUCTURES.
 - PREPARE SITE FOR PAVING.
 - PAVE SITE.
 - COMPLETE GRADING AND INSTALL PERMANENT SEEDING AND PLANTING.
 - REMOVE EROSION AND TEMPORARY SEDIMENT CONTROL DEVICES AFTER FINAL STABILIZATION IS ACHIEVED.

BMP MAINTENANCE NOTES

ALL MEASURES STATED ON THIS SITE MAP, AND IN THE STORM WATER POLLUTION PREVENTION PLAN, SHALL BE MAINTAINED IN FULLY FUNCTIONAL CONDITION UNTIL NO LONGER REQUIRED FOR A COMPLETED PHASE OF WORK OR FINAL STABILIZATION OF THE SITE. ALL EROSION AND SEDIMENTATION CONTROL MEASURE SHALL BE CHECKED BY A QUALIFIED PERSON IN ACCORDANCE WITH THE CONTRACT DOCUMENTS OR THE APPLICABLE PERMIT, WHICHEVER IS MORE STRINGENT, AND REPAIRED IN ACCORDANCE WITH THE FOLLOWING:

- INLET PROTECTION DEVICES AND BARRIERS SHALL BE REPAIRED OR REPLACED IF THEY SHOW SIGNS OF UNDERMINING OR DETERIORATION.
- ALL SEEDED AREAS SHALL BE CHECKED REGULARLY TO SEE THAT GOOD STAND IS MAINTAINED. AREAS SHOULD BE FERTILIZED, WATERED, AND RESEED AS NEEDED.
- SILT FENCES SHALL BE REPAIRED TO THEIR ORIGINAL CONDITIONS IF DAMAGED. SEDIMENT SHALL BE REMOVED FROM THE SILT FENCES WHEN IT REACHES ONE-HALF OF THE SILT FENCE.
- THE CONSTRUCTION EXITS SHALL BE MAINTAINED IN A CONDITION WHICH WILL PREVENT TRACKING OR FLOW OF MUD ONTO PUBLIC RIGHTS-OF-WAY. THIS MAY REQUIRE PERIODIC TOP DRESSING OF THE CONSTRUCTION EXITS AS CONDITIONS DEMAND.
- THE TEMPORARY PARKING AND STORAGE AREA SHALL BE KEPT IN GOOD CONDITION (SUITABLE FOR PARKING AND STORAGE). THIS MAY REQUIRE PERIODIC TOP DRESSING OF THE TEMPORARY PARKING AREA AS CONDITIONS DEMAND.
- FILTER TUBES SHALL BE REPAIRED TO THEIR ORIGINAL CONDITIONS IF DAMAGED. SEDIMENT SHALL BE REMOVED FROM TUBES WHEN IT REACHES 1 OF ITS EXPOSED HEIGHT. SEE DETAILS.
- PRIOR TO LEAVING THE SITE, ALL VEHICLES SHALL BE CLEARED OF DEBRIS. ANY DEBRIS AND/OR SEDIMENT REACHING THE PUBLIC STREET SHALL BE CLEARED IMMEDIATELY BY A METHOD OTHER THAN FLUSHING.

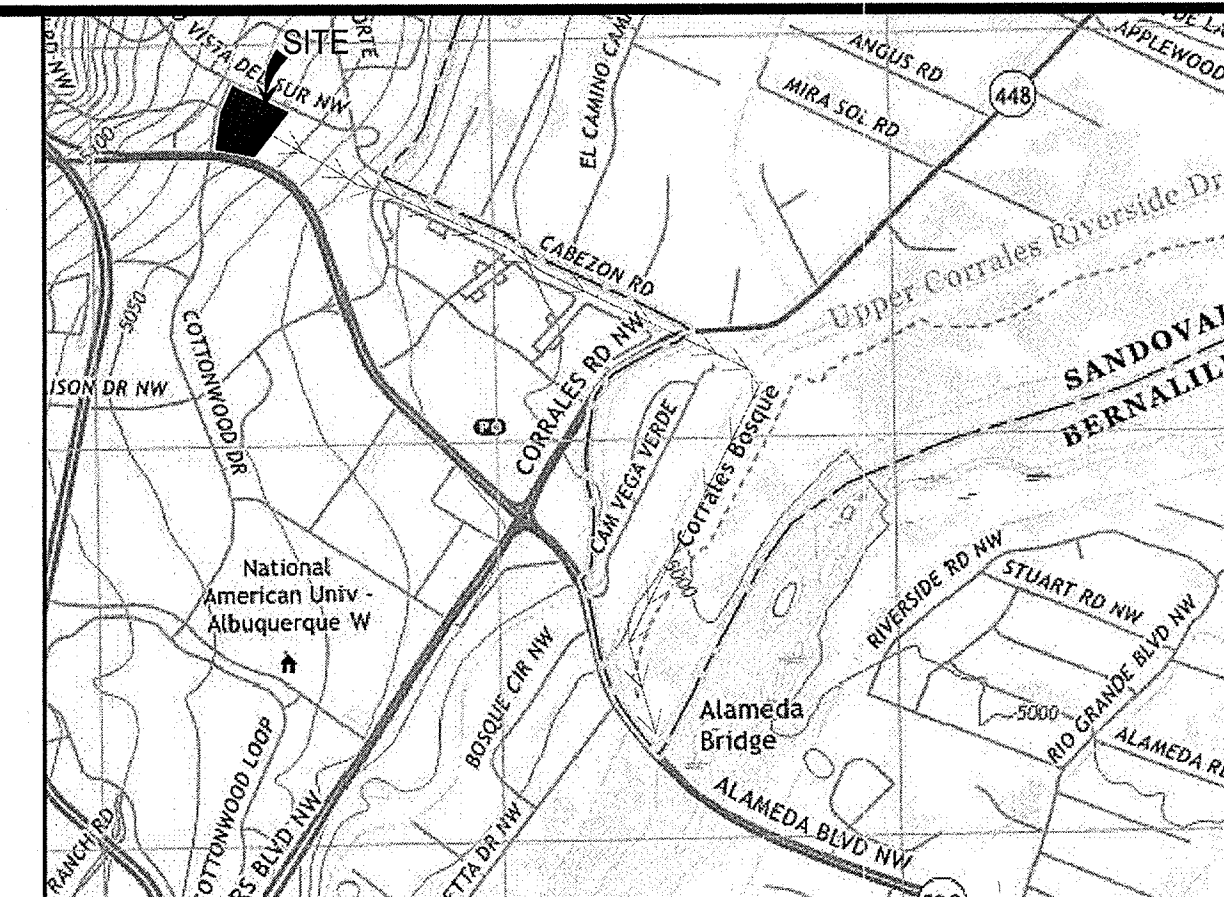

USGS QUADRANGLE MAP
N.T.S.

EXISTING

	Sanitary Sewer Manhole		Hand Railing
	Power Pole w/underground feed		Light Pole
	Power Pole		Bollard
	High Voltage Tower		Concrete Symbol
	Guy Wire		Telephone Pedestal
	Overhead Wires		Underground Electric Line
	Water Meter		Underground Communications Line
	Water Valve		Underground Gas Line
	Hydrant		Underground Water Line
	Electric Meter		Sanitary Sewer Line
	Traffic Box		Storm Drain Line
	Overhead Traffic Light Pole		Control Point
	Fence		Wall

PROPOSED

	BOUNDARY LINE
	CONSTRUCTION FENCE
	LIMITS OF DISTURBED AREA
	CONSTRUCTION FENCE ON PAVEMENT (SEE DETAIL SHEETS)
	SOIL TYPE DESIGNATION

PROJECT INFORMATION

RECEIVING WATER IS UN-NAMED LOCAL DEPRESSION. DEPRESSION EVENTUALLY CONNECTS TO THE RIO GRANDE ± 1 MILE FROM THE PROJECT SITE.

PROPOSED PROJECT SITE MADE UP OF AN EXISTING COMMERCIAL LOT. STORM RUN-OFF FROM SITE WILL PIPE INTO THE PROPOSED DETENTION POND CONSTRUCTED TO ACCOMMODATE STORM RUN-OFF FOR THE GAS STATION.

PROPOSED PROJECT IS CONSTRUCTING A GAS STATION CONSISTING OF 1200 S.F. CONVENIENT STORE WITH (8) PUMP ISLANDS AND ASSOCIATED PARKING AREA.

ACREAGE OF SITE IS 1.25 ACRES.

DISTURBED ACREAGE OF SITE (INCLUDING OFF-SITE WORK) IS 1.25 ACRES.

ANTICIPATED CONSTRUCTION START DATE IS APRIL 2018 AND COMPLETION DATE IS JULY 2018.

CONTRACTOR TO TAKE APPROPRIATE MEASURES TO KEEP SEDIMENT FROM ESCAPING SITE AND ALL ACCUMULATED SEDIMENT SHALL BE CLEARED OUT AND REMOVED FROM SITE.


DOWNSTREAM CONDITION WILL NOT BE NEGATIVELY AFFECTED BY PROPOSED DEVELOPMENT.

EROSION DETAILS - SEE DETAIL SHEET C-4.2

	CE STABILIZED CONSTRUCTION ACCESS
	PS PERMANENT STABILIZATION. SEE LANDSCAPE PLANS
	SF SEDIMENTATION/SILT FENCE WITH WIRE SUPPORT
	IP1 TEMP. BLOCK AND AGGREGATE FLUME SEDIMENT FILTER
	IP9 INLET SEDIMENT FILTER SECK

SITE SOILS

MWA	MAJUREZ-WINK ASSOCIATION
BCC	BLUEPOINT LOAMY FINE SAND

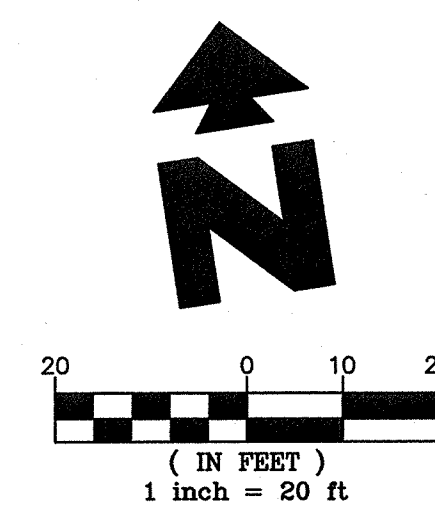

24 HR EMERGENCY CONTACT:
JASON LAIRD 870-866-7681

SHEET NO. C-4.1

NEW MEXICO
19052
PROFESSIONAL ENGINEER
AUG 2 3 2017

EROSION CONTROL PHASE 2
MURPHY EXPRESS
3751 HIGHWAY 528 NW
ALBUQUERQUE NEW MEXICO


GreenbergFarrow
1430 W. PEACHTREE ST. NW SUITE 200
ATLANTA, GA 30309
FAX: (404) 601-3900
DWG NAME: ALBUQUERQUE, NM
JOB NO.: 20160897.0

MURPHY OIL USA, INC.
MURPHY USA
200 PEACH STREET
EL DORADO, AR 71730


EROSION CONTROL AND TREE PROTECTION MEASURES SHALL BE INSTALLED PRIOR TO ANY OTHER CONSTRUCTION ACTIVITY AND MAINTAINED UNTIL PERMANENT GROUND COVER IS ESTABLISHED.

THE ESCAPE OF SEDIMENT FROM THE SITE SHALL BE PREVENTED BY THE INSTALLATION OF EROSION AND SEDIMENT CONTROL MEASURES AND PRACTICES PRIOR TO, OR CONCURRENT WITH LAND-DISTURBING ACTIVITIES.


EROSION CONTROL MEASURES WILL BE MAINTAINED AT ALL TIMES. IF FULL IMPLEMENTATION OF THE APPROVED PLAN DOES NOT PROVIDE FOR EFFECTIVE EROSION CONTROL, ADDITIONAL EROSION AND SEDIMENT CONTROL MEASURES SHALL BE IMPLEMENTED TO CONTROL OR TREAT THE SEDIMENT SOURCE.

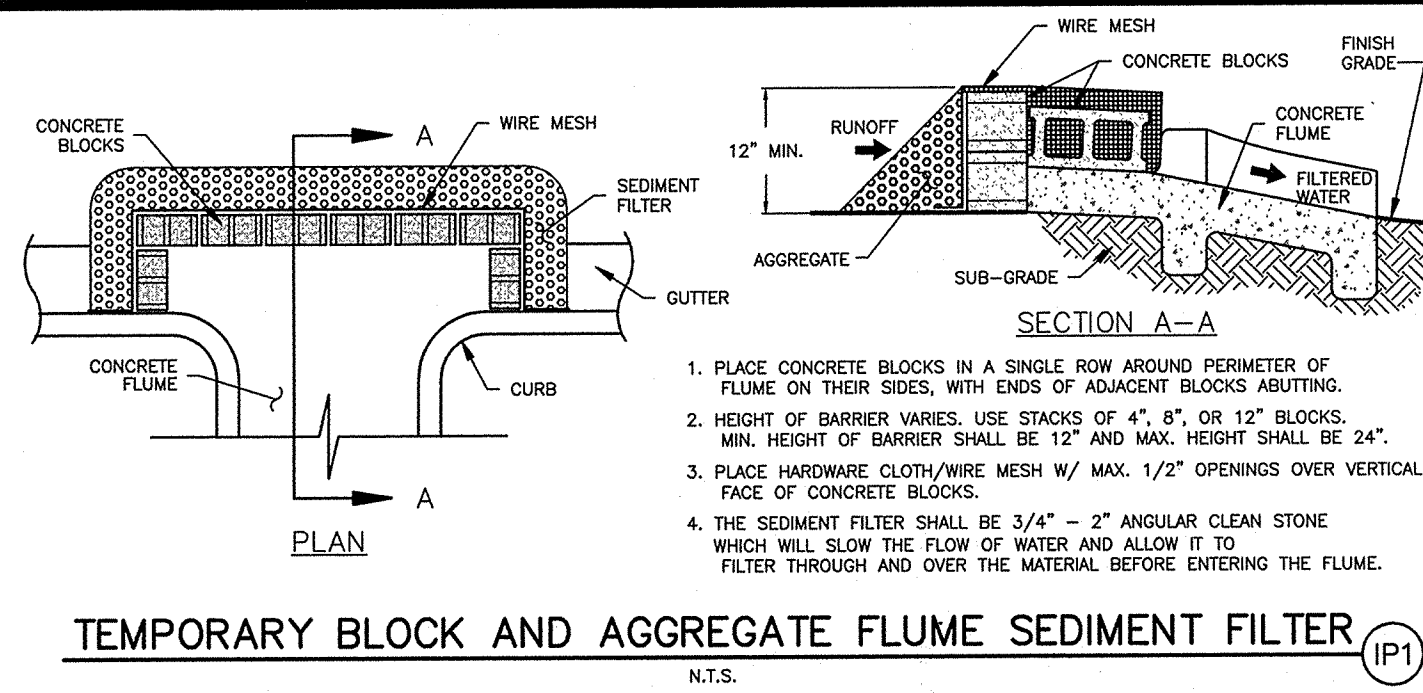

TEMPORARY BLOCK AND AGGREGATE FLUME SEDIMENT FILTER (IP1)

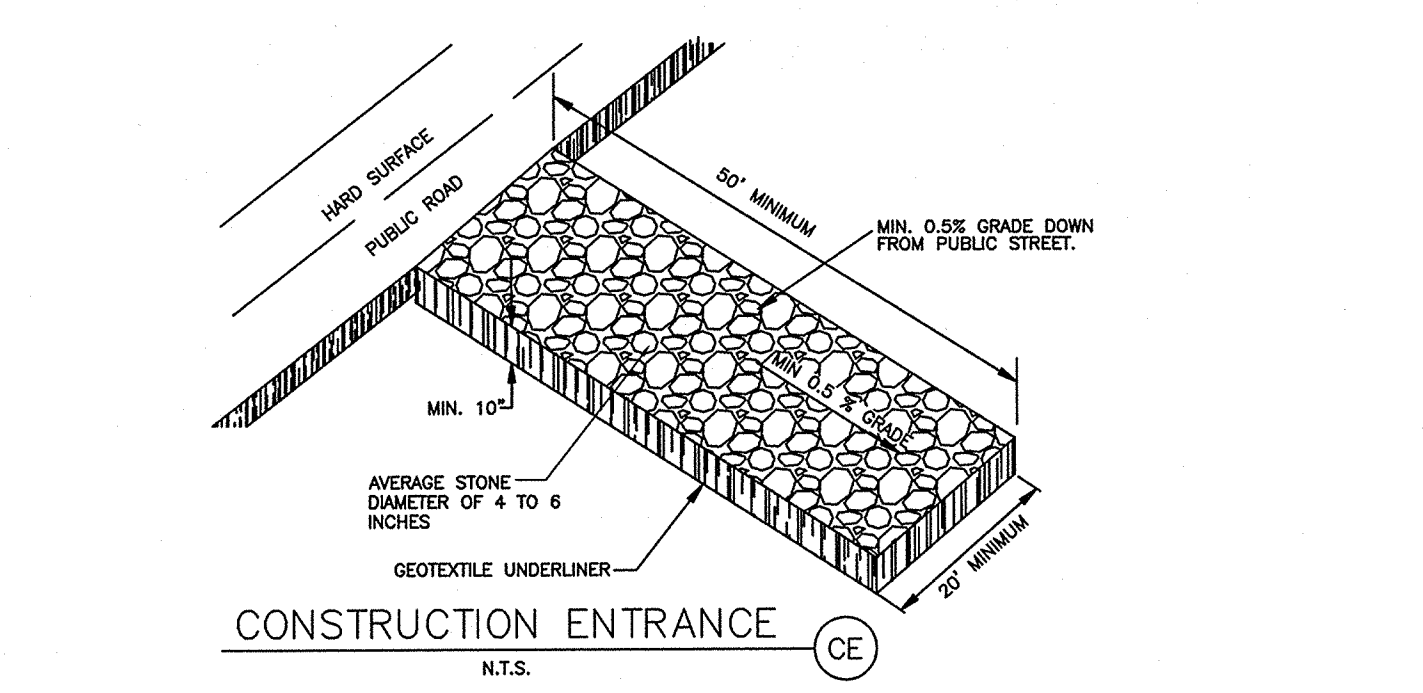

CONSTRUCTION ENTRANCE (CE)

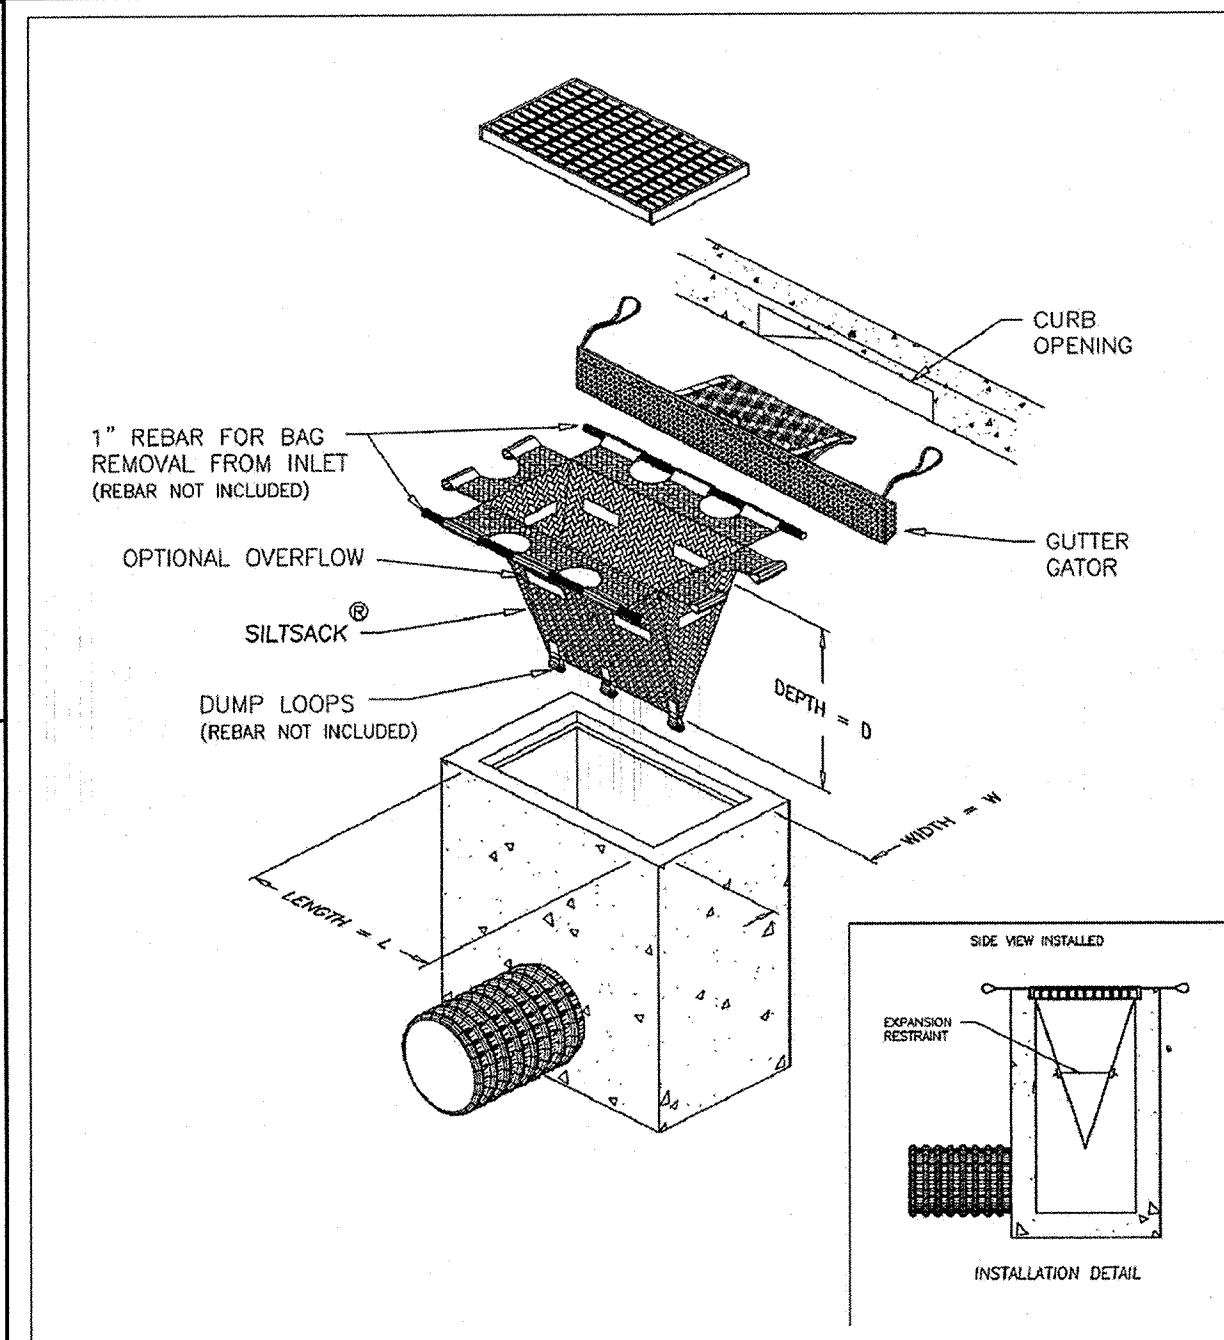


DETAIL OF INLET SEDIMENT CONTROL DEVICE WITH GUTTER GATOR

ACF Environmental
Your Complete Source for
Geosynthetic Solutions

ACF Environmental, Inc.
2831 Carwell Rd.
Richmond, Virginia 23234
(800) 448-3836

SILTSACK® GUTTER GATOR COMBINATION SPECIFICATIONS			
NOTE: THE SILTSACK® WILL BE MANUFACTURED FROM A WOVEN POLYPROPYLENE FABRIC THAT MEETS OR EXCEEDS THE FOLLOWING SPECIFICATIONS.			
REGULAR FLOW SILTSACK® (FOR AREAS OF LOW TO MODERATE PRECIPITATION AND RUN-OFF)			
PROPERTIES	TEST METHOD	UNITS	
GRAB TENSILE STRENGTH	ASTM D-4632	300 LBS	
GRAB TENSILE ELONGATION	ASTM D-4632	20 %	
PUNCTURE	ASTM D-4632	120 LBS	
MULLER BURST	ASTM D-2706	800 PSI	
TRAPEZOID TEAR	ASTM D-4253	120 LBS	
UV RESISTANCE	ASTM D-4253	50 %	
APPARENT OPENING SIZE	ASTM D-4751	40 US SIEVE	
FLOW RATE	ASTM D-4491	40 GAL/MIN/20 FT	
PERMITTIVITY	ASTM D-4491	0.95 SEC -1	
HI-FLOW SILTSACK® (FOR AREAS OF MODERATE TO HEAVY PRECIPITATION AND RUN-OFF)			
PROPERTIES	TEST METHOD	UNITS	
GRAB TENSILE STRENGTH	ASTM D-4632	355 LBS	
GRAB TENSILE ELONGATION	ASTM D-4632	20 %	
PUNCTURE	ASTM D-4632	125 LBS	
MULLER BURST	ASTM D-2706	850 PSI	
TRAPEZOID TEAR	ASTM D-4253	130 LBS	
UV RESISTANCE	ASTM D-4253	50 %	
APPARENT OPENING SIZE	ASTM D-4751	20 US SIEVE	
FLOW RATE	ASTM D-4491	200 GAL/MIN/20 FT	
PERMITTIVITY	ASTM D-4491	1.5 SEC -1	
OIL-ABSORBANT SILTSACK® (FOR AREAS WHERE THERE IS A CONCERN FOR OIL RUN-OFF OR SPILLS)			
DEFENDING ON YOUR PARTICULAR APPLICATION, THE SILTSACK CAN BE MADE FROM EITHER ONE OF THE ABOVE FABRICS WITH AN OIL-ABSORBANT FILLW INSERT OR, MADE COMPLETELY FROM AN OIL-ABSORBANT SILTSACK WITH A WOVEN FILLW INSERT.			
INLET SEDIMENT FILTER SACK (IP9)			
N.T.S.			

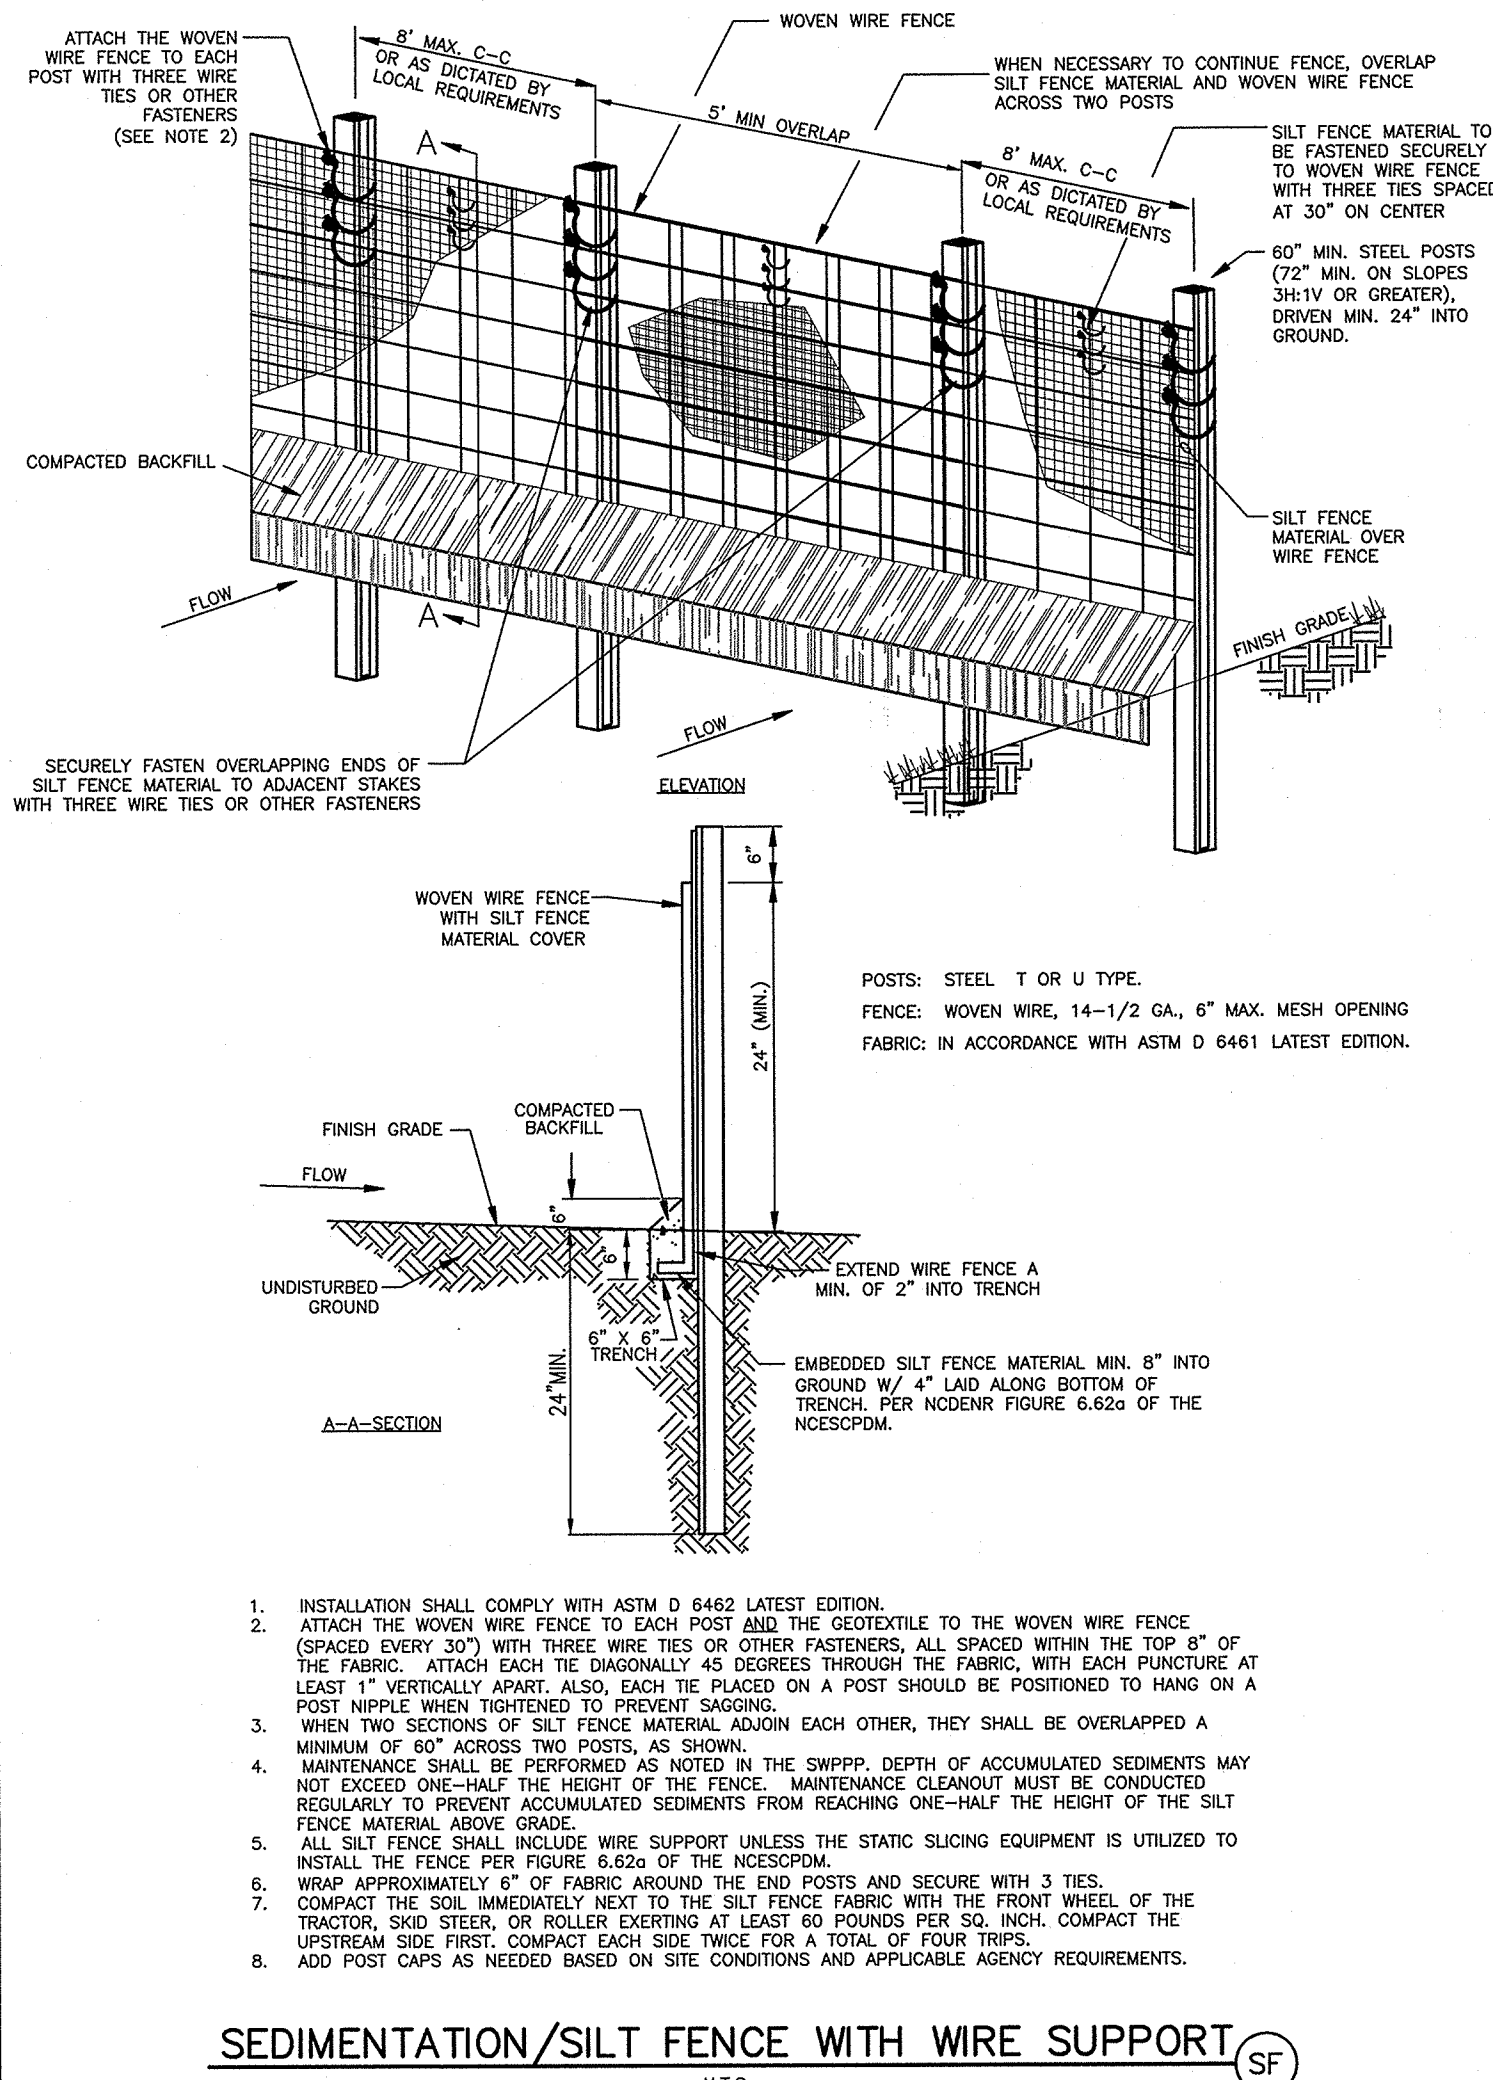

SEDIMENTATION/SILT FENCE WITH WIRE SUPPORT (SF)



SHEET NO.
C-4.2

JOHN H. HOUZARD
NEW MEXICO
19062
PROFESSIONAL ENGINEER
AUG 23 2017

DS
DS
DS
JN
08-23-17
REV-0
DATE
PRN
DES
PM
E&S CONTROL DETAILS
MURPHY EXPRESS
3761 HIGHWAY 528 NW
ALBUQUERQUE NEW MEXICO

GreenbergFarrow
1430 W. PEACHTREE ST. NW SUITE 200
ATLANTA, GA 30309
PHONE: (404) 601-3970
FAX: (404) 601-3970
DWC NAME: ALBUQUERQUE, NM
JOB NO. 20160897.0

MURPHY OIL USA, INC.
200 PEACH STREET
EL DORADO, AR 71730
MURPHY
USA

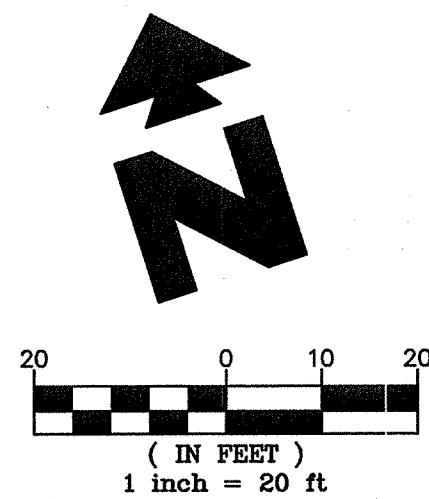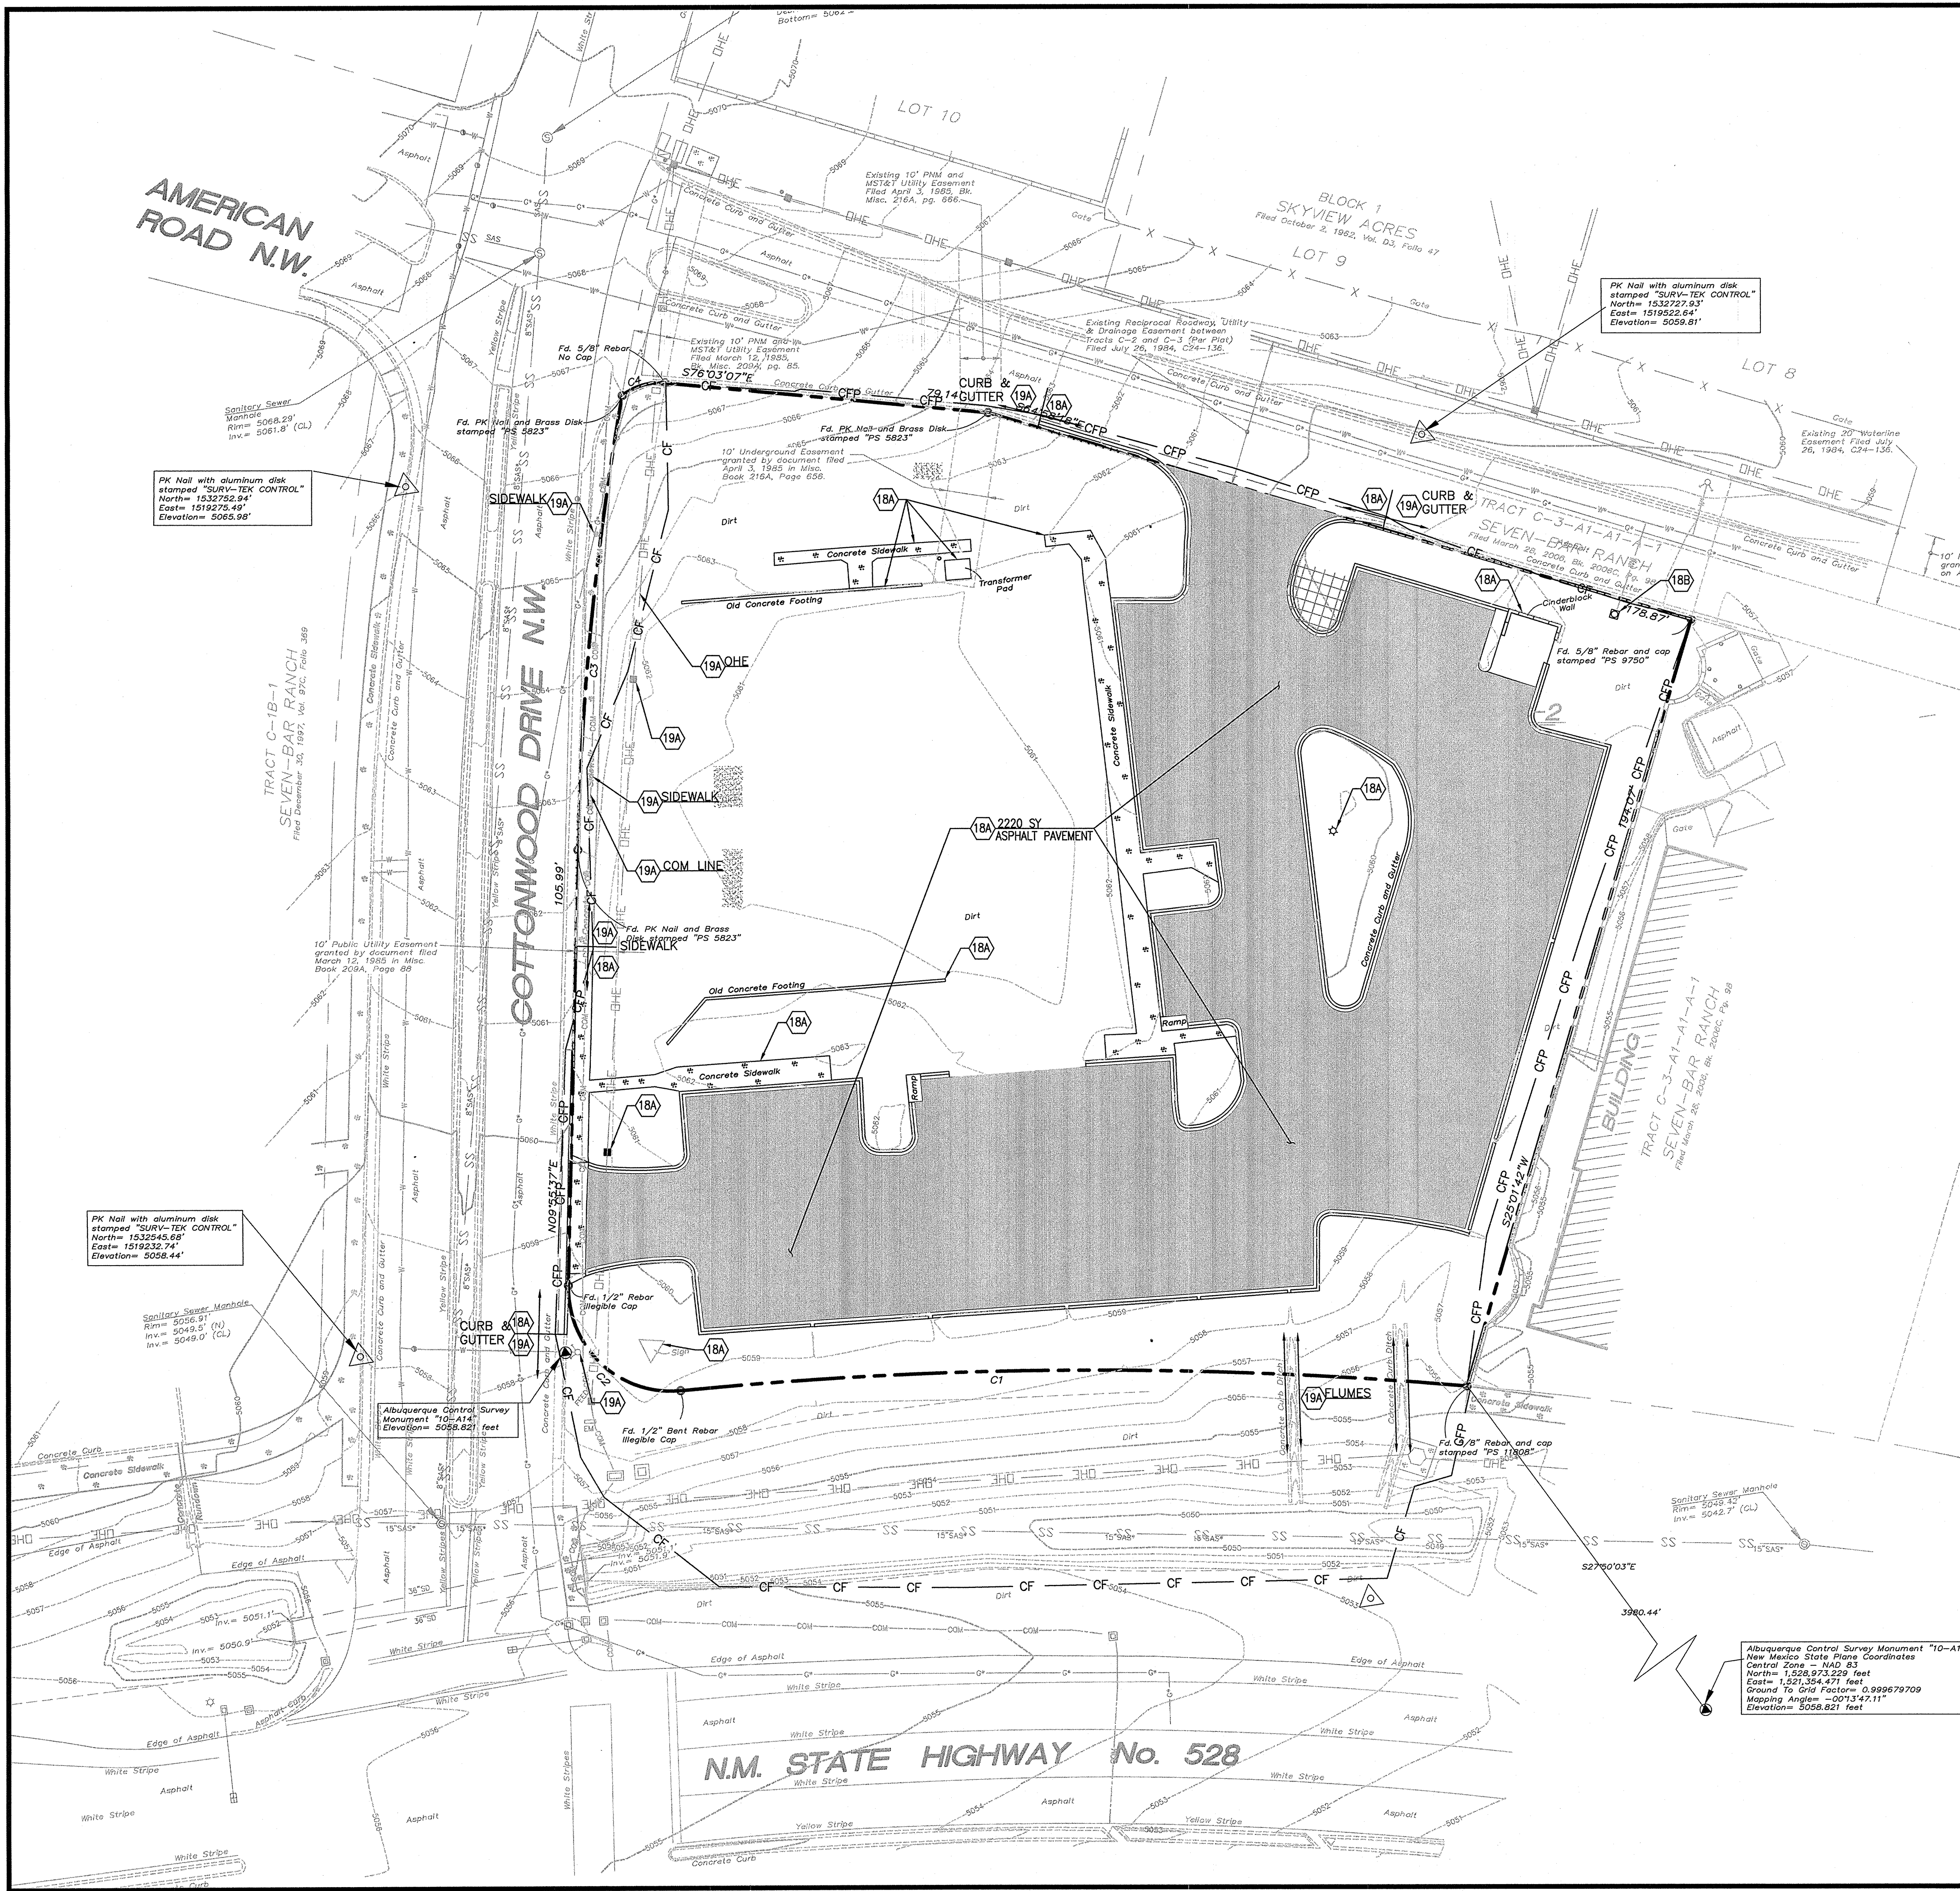

EXISTING	
	Sanitary Sewer Manhole
	Power Pole w/underground feed
	Power Pole
	High Voltage Tower
	Guy Wire
	Overhead Wires
	Water Meter
	Water Valve
	Hydrant
	Electric Meter
	Traffic Box
	Overhead Traffic Light Pole
	Fence
	Hand Railing
	Light Pole
	Bollard
	Concrete Symbol
	Telephone Pedestal
	Underground Electric Line
	Underground Communications Line
	Underground Gas Line
	Underground Water Line
	Sanitary Sewer Line
	Storm Drain Line
	Control Point
	Wall

PROPOSED	
	BOUNDARY LINE
	CONSTRUCTION FENCE (SEE DETAIL SHEETS)
	CONSTRUCTION FENCE ON PAVEMENT (SEE DETAIL SHEETS)

- GENERAL DEMOLITION NOTES**
- A. CONTRACTOR SHALL BE RESPONSIBLE FOR REMOVAL OF THE EXISTING STRUCTURES, RELATED UTILITIES, PAVING, UNDERGROUND STORAGE TANKS AND ANY OTHER EXISTING IMPROVEMENTS AS NOTED.
- B. CONTRACTOR IS TO REMOVE AND DISPOSE OF ALL DEBRIS, RUBBISH AND OTHER MATERIALS RESULTING FROM PREVIOUS AND CURRENT DEMOLITION OPERATIONS. DISPOSAL WILL BE IN ACCORDANCE WITH ALL LOCAL, STATE AND/OR FEDERAL REGULATIONS GOVERNING SUCH OPERATIONS.
- C. THE GENERAL CONTRACTOR SHALL TAKE ALL PRECAUTIONS NECESSARY TO AVOID PROPERTY DAMAGE TO ADJACENT PROPERTIES DURING THE CONSTRUCTION PHASES OF THIS PROJECT. THE CONTRACTOR WILL BE HELD SOLELY RESPONSIBLE FOR ANY DAMAGES TO THE ADJACENT PROPERTIES OCCURRING DURING THE CONSTRUCTION PHASES OF THIS PROJECT.
- D. THE CONTRACTOR IS SPECIFICALLY CAUTIONED THAT THE LOCATION AND/OR ELEVATION OF EXISTING UTILITIES AS SHOWN ON THESE PLANS IS BASED ON RECORDS OF THE VARIOUS UTILITY COMPANIES, AND WHERE POSSIBLE, MEASUREMENTS TAKEN IN THE FIELD. THE INFORMATION IS NOT TO BE RELIED ON AS BEING EXACT OR COMPLETE. THE CONTRACTOR MUST CALL THE APPROPRIATE UTILITY COMPANY AT LEAST 72 HOURS BEFORE ANY EXCAVATION TO REQUEST EXACT FIELD LOCATION OF UTILITIES.

- DEMOLITION NOTES**
- 18A EXISTING TO BE REMOVED
- 19A EXISTING TO REMAIN
- 51B LIMITS OF SAWCUT AND PAVEMENT REMOVAL

SHEET NO.
C-5

REV-0

DATE

08-23-17

JN

PRN

DS

DES

PM

DS

DES

DRW

REV-0

DATE

08-23-17

JN

PRN

DS

DES

PM

DS

DES

DRW

DEMOLITION PLAN

MURPHY EXPRESS

3751 HIGHWAY 528 NW

ALBUQUERQUE NEW MEXICO

MURPHY OIL USA, INC.

1430 W. PEACHTREE ST. NW SUITE 200

ATLANTA, GA 30309

TEL: (404) 601 3070

FAX: (404) 601 3070

DWG NAME: ALBUQUERQUE, NM

JOB NO.: 20160897.0

MURPHY OIL USA, INC.



200 PEACH STREET

EL DORADO, AR 71730

MURPHY OIL USA, INC.

200 PEACH STREET

EL DORADO, AR 71730

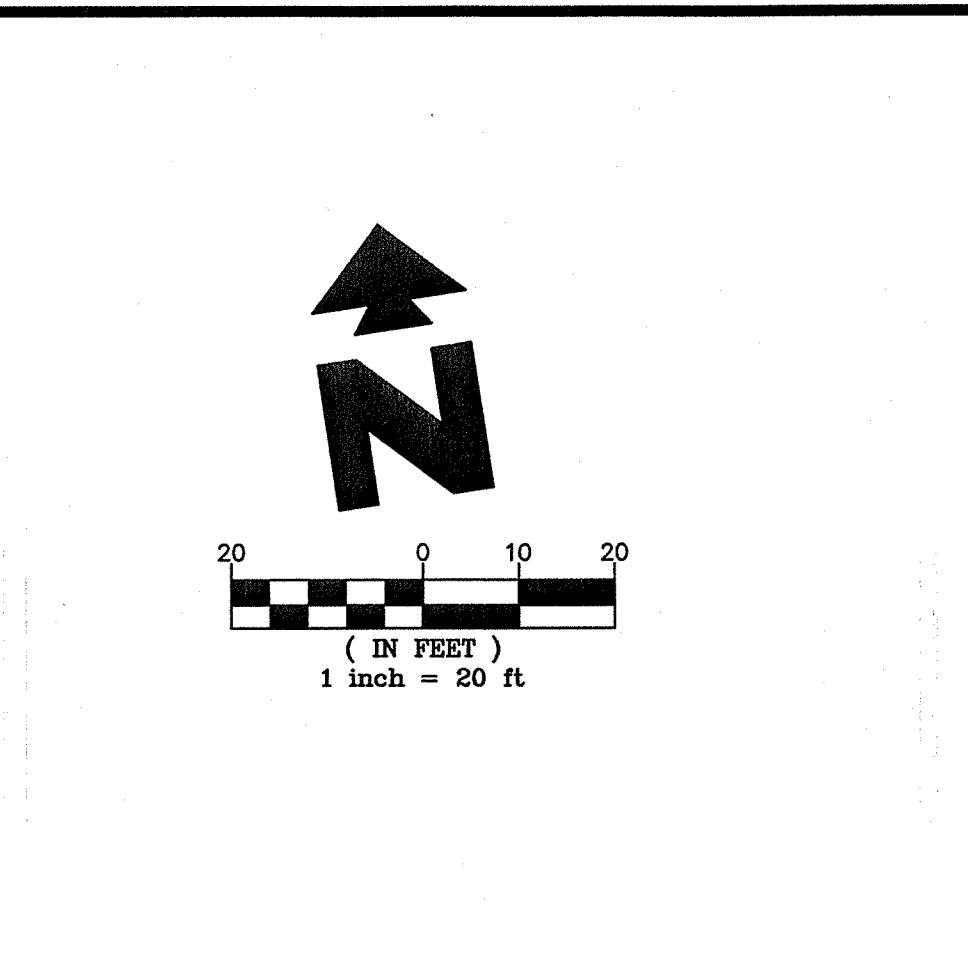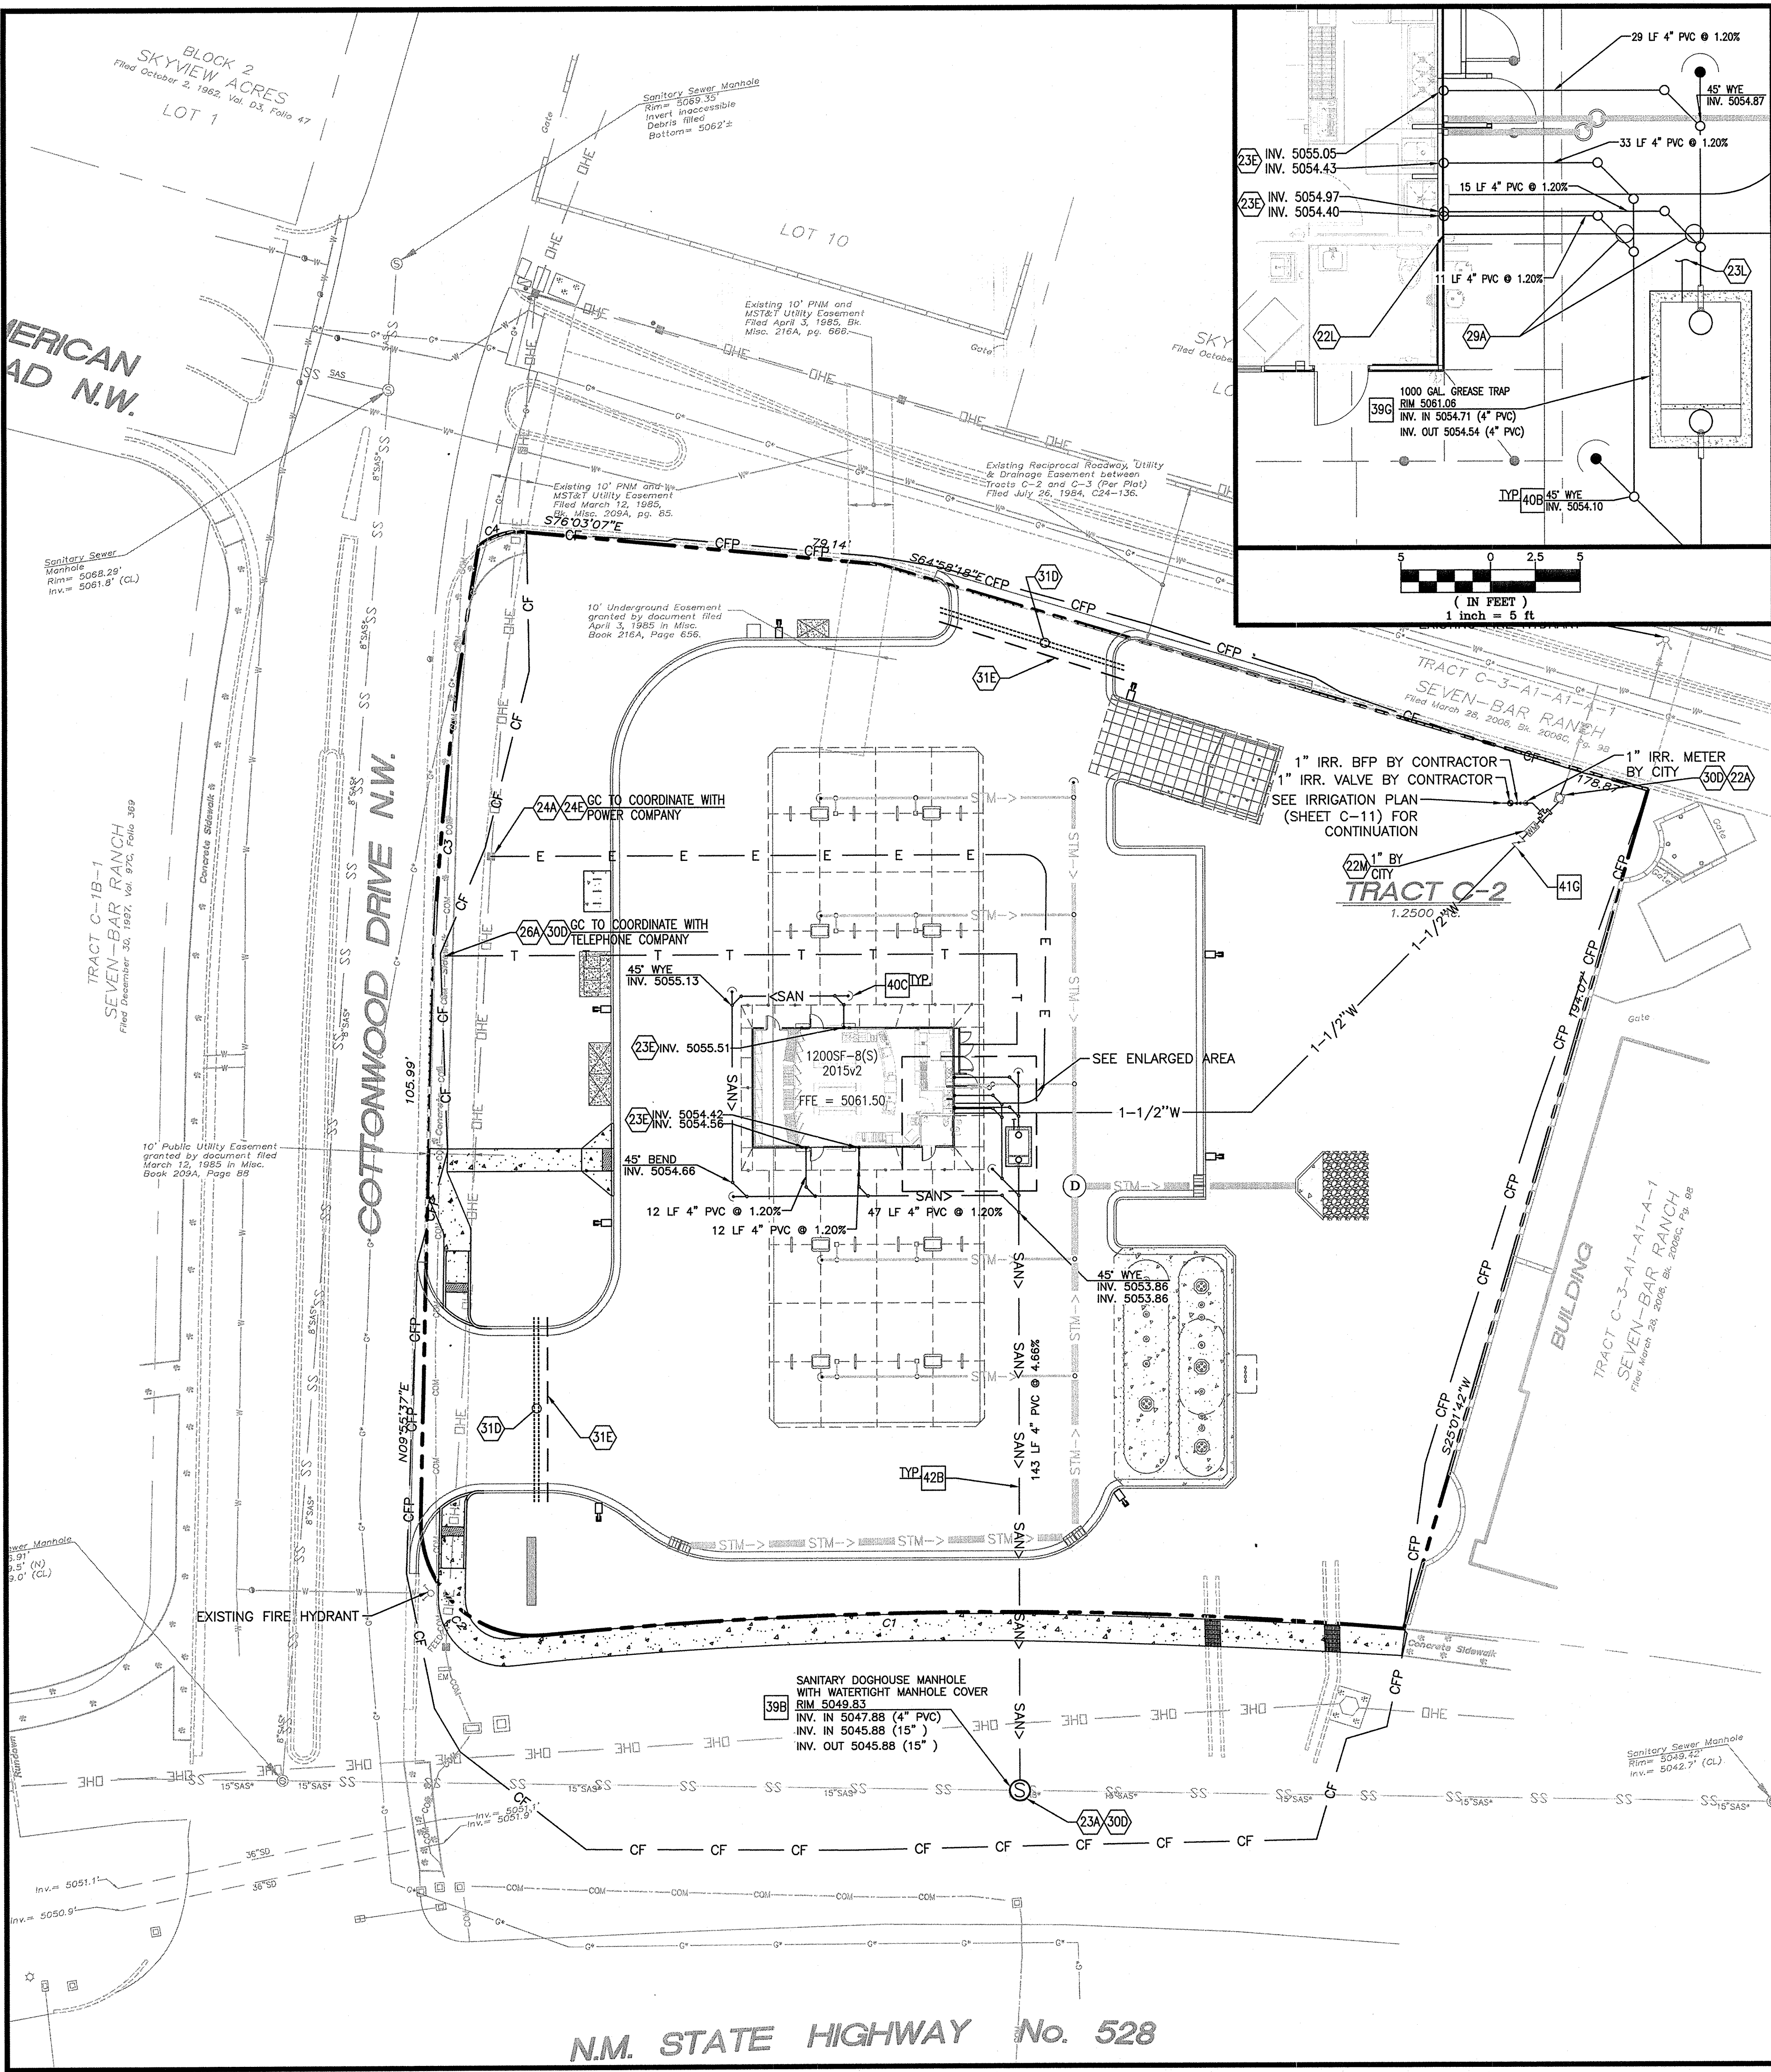

UTILITY CONTACT INFORMATION

ELECTRIC
SUZANNE MARQUEZ
ENGINEERING TECHNICIAN
PNM PUBLIC SERVICE CO.
4201 EDITH BOULEVARD NE
ALBUQUERQUE, NM 87107
PHONE: (505) 241-3479
CELL: (505) 450-8641
SUZANNE.MARQUEZ@PNM.COM

WATER AND SEWER
KRISTOPHER CADENA, P.E.
CITY OF ALBUQUERQUE
UTILITY DEVELOPMENT SECTION
600 2ND ST., NW, SUITE 201
ALBUQUERQUE, NM 87102
PHONE: (505) 289-3301

TELEPHONE
CONTACT: CHUCK AVENT
SUPERVISOR, PLANT FACILITIES
CENTURYLINK
PHONE: (505) 514-6473
CHUCK.AVENT@CENTURYLINK.COM

UTILITY INSTALLATION RESPONSIBILITIES

ELECTRIC RESPONSIBILITY			
	GENERAL CONTRACTOR	UTILITY PROVIDER	N/A
CONDUIT / TRENCH	X		
TRANSFORMER PAD			X
CT CABINET	X		
EASEMENTS (TRANSFORMER)			X
EASEMENTS (SECONDARY LINE)			X

TELEPHONE RESPONSIBILITY			
	GENERAL CONTRACTOR	UTILITY PROVIDER	N/A
CONDUIT / TRENCH	X		
PULL STRINGS			X

WATER RESPONSIBILITY			
	GENERAL CONTRACTOR	UTILITY PROVIDER	N/A
TAP	X		
DOMESTIC METER		X	
DOMESTIC BFP	X		
IRRIGATION METER		X	
IRRIGATION BFP	X		
HYDRANT			X
EASEMENTS			X

SEWER RESPONSIBILITY			
	GENERAL CONTRACTOR	UTILITY PROVIDER	N/A
TAP	X		
EASEMENTS			X

UTILITY FEE SCHEDULE

WATER & SANITARY SEWER FEES TO BE PAID BY MURPHY:

WATER:
\$5,076.00 IMPACT FEE
\$3,344.00 DOMESTIC METER, TAP & RPZ
\$5,360.00 TOTAL

SANITARY SEWER:
\$3,808.00 IMPACT FEE
\$3,808.00 TOTAL

METER SIZES

DOMESTIC: 1"
IRRIGATION: 1"

- EXISTING**
- Sanitary Sewer Manhole
 - Power Pole w/underground feed
 - High Voltage Tower
 - Guy Wire
 - Overhead Wires
 - Water Meter
 - Water Valve
 - Hydrant
 - Electric Meter
 - Traffic Box
 - Overhead Traffic Light Pole
 - Fence
- PROPOSED**
- Hand Rolling
 - Light Pole
 - Bollard
 - Concrete Symbol
 - Telephone Pedestal
 - Underground Electric Line
 - Underground Communications Line
 - Underground Gas Line
 - Underground Water Line
 - Sanitary Sewer Line
 - Storm Drain Line
 - Control Point
 - Wall

- PROPOSED LEGEND**
- BOUNDARY LINE
 - SAN> SANITARY SEWER SERVICE
 - E UNDERGROUND ELECTRIC SERVICE
 - T UNDERGROUND TELEPHONE SERVICE
 - 1-1/4"W WATER SERVICE
 - CF CONSTRUCTION FENCE (SEE CIVIL DETAILS)
 - CFP CONSTRUCTION FENCE ON PAVEMENT (SEE DETAIL SHEETS)
- GENERAL UTILITY NOTES**
- A. ALL BUILDING WATER LINES FROM METER TOWARDS BUILDING SHALL BE SCHEDULE 40 PVC, MEETING ASTM D1785 & D2685 SPECIFICATIONS, AND SHALL BE RATED FOR USE WITH POTABLE WATER PER NSF STD. 61 & STD.14, WITH 36" MIN. COVER.
- B. ALL SANITARY SEWER LINES SHALL BE SCHEDULE 40 PVC UNLESS OTHERWISE SPECIFIED BY THE UTILITY COMPANY, PROVIDE 36" MINIMUM COVER.
- C. CONTRACTOR SHALL COORDINATE ANY DISRUPTIONS TO EXISTING UTILITY SERVICES WITH ADJACENT PROPERTY OWNERS.
- D. ALL ELECTRIC AND TELEPHONE EXTENSIONS INCLUDING SERVICE LINES SHALL BE CONSTRUCTED TO THE APPROPRIATE UTILITY COMPANY SPECIFICATIONS. ALL UTILITY DISCONNECTIONS SHALL BE COORDINATED WITH THE DESIGNATED UTILITY COMPANIES.
- E. CONSTRUCTION SHALL NOT START ON ANY PUBLIC UTILITY SYSTEM UNTIL WRITTEN APPROVAL HAS BEEN RECEIVED BY THE ENGINEER FROM THE APPROPRIATE GOVERNING AUTHORITY AND CONTRACTOR HAS BEEN NOTIFIED BY THE ENGINEER.
- F. PRIOR TO THE CONSTRUCTION OF OR CONNECTION TO ANY STORM DRAIN, SANITARY SEWER, WATER MAIN OR ANY OTHER UTILITIES, THE CONTRACTOR SHALL EXCAVATE, VERIFY AND CALCULATE ALL POINTS OF CONNECTION AND ALL UTILITY CROSSINGS AND INFORM GREENBERGFARROW ENGINEERS AND THE OWNER/DEVELOPER OF ANY CONFLICT OR REQUIRED DEVIATIONS FROM THE PLAN. NOTIFICATION SHALL BE MADE A MINIMUM OF (72) HOURS PRIOR TO CONSTRUCTION. GREENBERGFARROW AND ITS CLIENTS SHALL BE HELD HARMLESS IN THE EVENT THAT THE CONTRACTOR FAILS TO MAKE SUCH NOTIFICATION.
- G. CONTRACTOR SHALL COMPLY COMPLETELY WITH THE LATEST STANDARDS OF OSHA DIRECTIVES OR ANY OTHER AGENCY HAVING JURISDICTION FOR EXCAVATION AND TRENCHING PROCEDURES. THE CONTRACTOR SHALL USE SUPPORT SYSTEMS, SLOPING, BENCHING AND OTHER MEANS OF PROTECTION. THIS IS TO INCLUDE, BUT NOT LIMITED TO ACCESS AND EGRESS FROM ALL EXCAVATION AND TRENCHING. CONTRACTOR IS RESPONSIBLE FOR COMPLYING WITH PERFORMANCE CRITERIA AS REQUIRED BY OSHA.

- UTILITY NOTES**
- 22A POINT OF CONNECTION - WATER SERVICE.
- 22L METERED DOMESTIC WATER SERVICE ENTRY PER BLDG PLUMBING PLAN (SEE SIZES THIS SHEET).
- 23A PROPOSED WATER METER (SEE SIZE THIS SHEET).
- 23B POINT OF CONNECTION - SANITARY SEWER SERVICE.
- 23C SANITARY SEWER SERVICE ENTRY (PER BUILDING MECHANICAL PLANS).
- 23L CONNECT GREASE TRAP VENT TO BUILDING VENT SYSTEM. GREASE TRAP VENT INVERT MUST BE HIGHER THAN INLET INVERT.
- 24A POINT OF CONNECTION FOR UNDERGROUND ELECTRIC SERVICE.
- 24E PROPOSED POLE MOUNTED TRANSFORMER.
- 25A POINT OF CONNECTION FOR UNDERGROUND TELEPHONE.
- 25B MAINTAIN MIN. 18" VERTICAL SEPARATION.
- 30D VERIFY LOCATION AND DEPTH OF EXISTING UTILITY BEFORE CONSTRUCTING PROPOSED UTILITY.
- 31D INSTALL (2) 4" PVC SLEEVES 30" BELOW FINAL GRADE UNDER DRIVEWAY. EXTEND SLEEVES 2 FEET BEYOND BACK OF PROPOSED CURB OR EDGE OF PAVEMENT. STAKE BOTH ENDS OF EACH SLEEVE WITH CAPPED VERTICAL PVC PIPE, 12" ABOVE GRADE. DO NOT ALLOW SOIL OR WATER TO ENTER SLEEVES DURING OR AFTER CONSTRUCTION.
- 31E INSTALL (1) 4" PVC SLEEVE 30" BELOW FINAL GRADE UNDER DRIVEWAY FOR IRRIGATION LINE. EXTEND SLEEVE 2 FEET BEYOND BACK OF PROPOSED CURB OR EDGE OF PAVEMENT. STAKE BOTH ENDS OF SLEEVE WITH CAPPED VERTICAL PVC PIPE, 12" ABOVE GRADE. DO NOT ALLOW SOIL OR WATER TO ENTER SLEEVE DURING OR AFTER CONSTRUCTION.
- ☐ UTILITY DETAILS - SEE DETAIL SHEETS
- 39B SANITARY SEWER "DOGHOUSE" MANHOLE
- 39C SANITARY SEWER GREASE TRAP
- 40B SANITARY SEWER WYE CONNECTION
- 40C SANITARY SEWER CLEAN-OUT
- 41G REDUCED PRESSURE ZONE BACKFLOW PREVENTER. CONTRACTOR TO VERIFY TYPE (ABOVE/UNDERGROUND) PRIOR TO COMMENCING CONSTRUCTION.
- 42B SANITARY SEWER TRENCHING AND BEDDING.

SHEET NO.
C-6


AUG 23 2017


GreenbergFarrow
1430 W. PEACHTREE ST., NW SUITE 200
ATLANTA, GA 30309
PHONE: (404) 524-8000
FAX: (404) 603-9970
DWGNAME: ALBUQUERQUE, NM
JOB NO.: 20160892.0

MURPHY OIL USA, INC.
MURPHY USA
200 PEACH STREET
EL DORADO, AR 71730


UTILITY PLAN
MURPHY EXPRESS
3751 HIGHWAY 528 NW
ALBUQUERQUE NEW MEXICO

REV-0
DATE
08-23-17
PRN
DES
DS
DRW

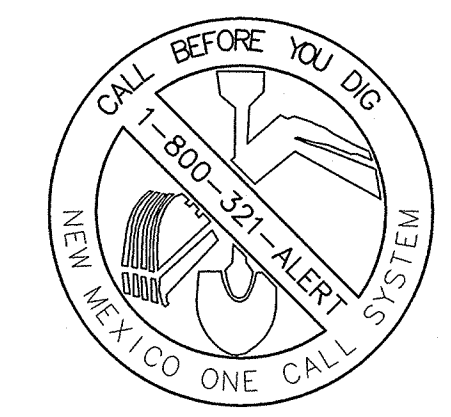

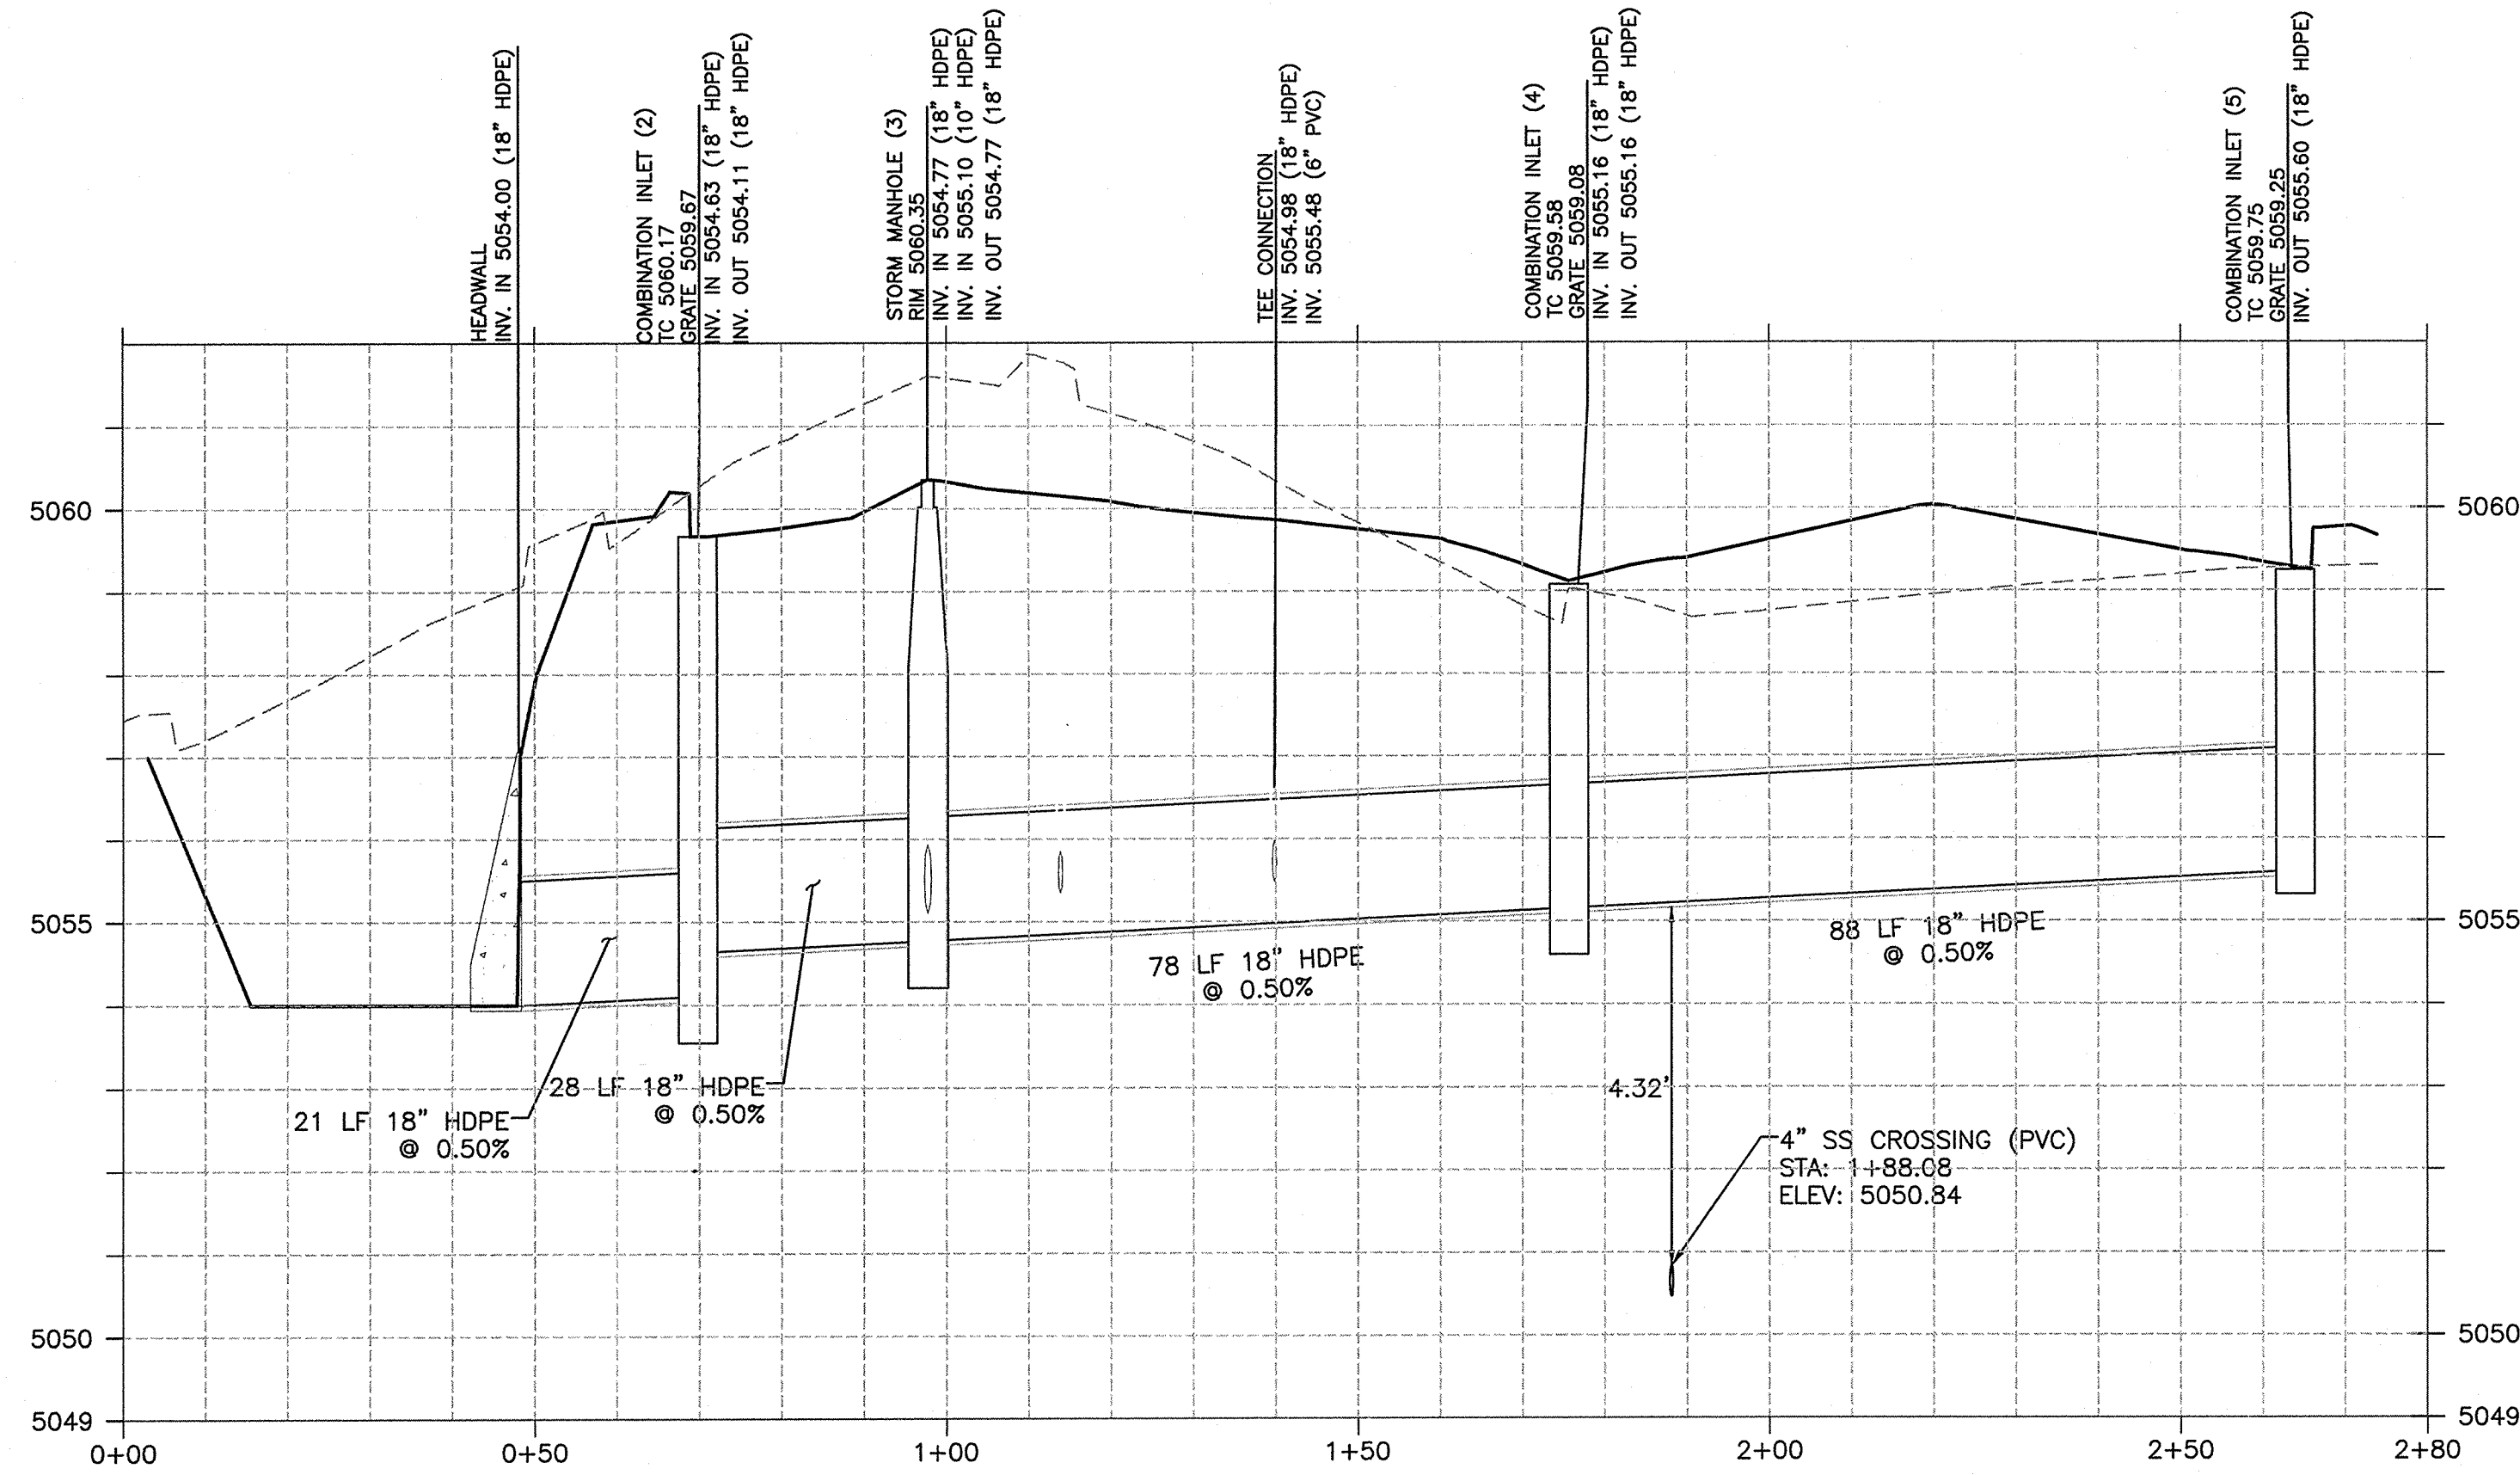

STORM
VERTICAL SCALE: 1"=2'
HORIZONTAL SCALE: 1"=20'

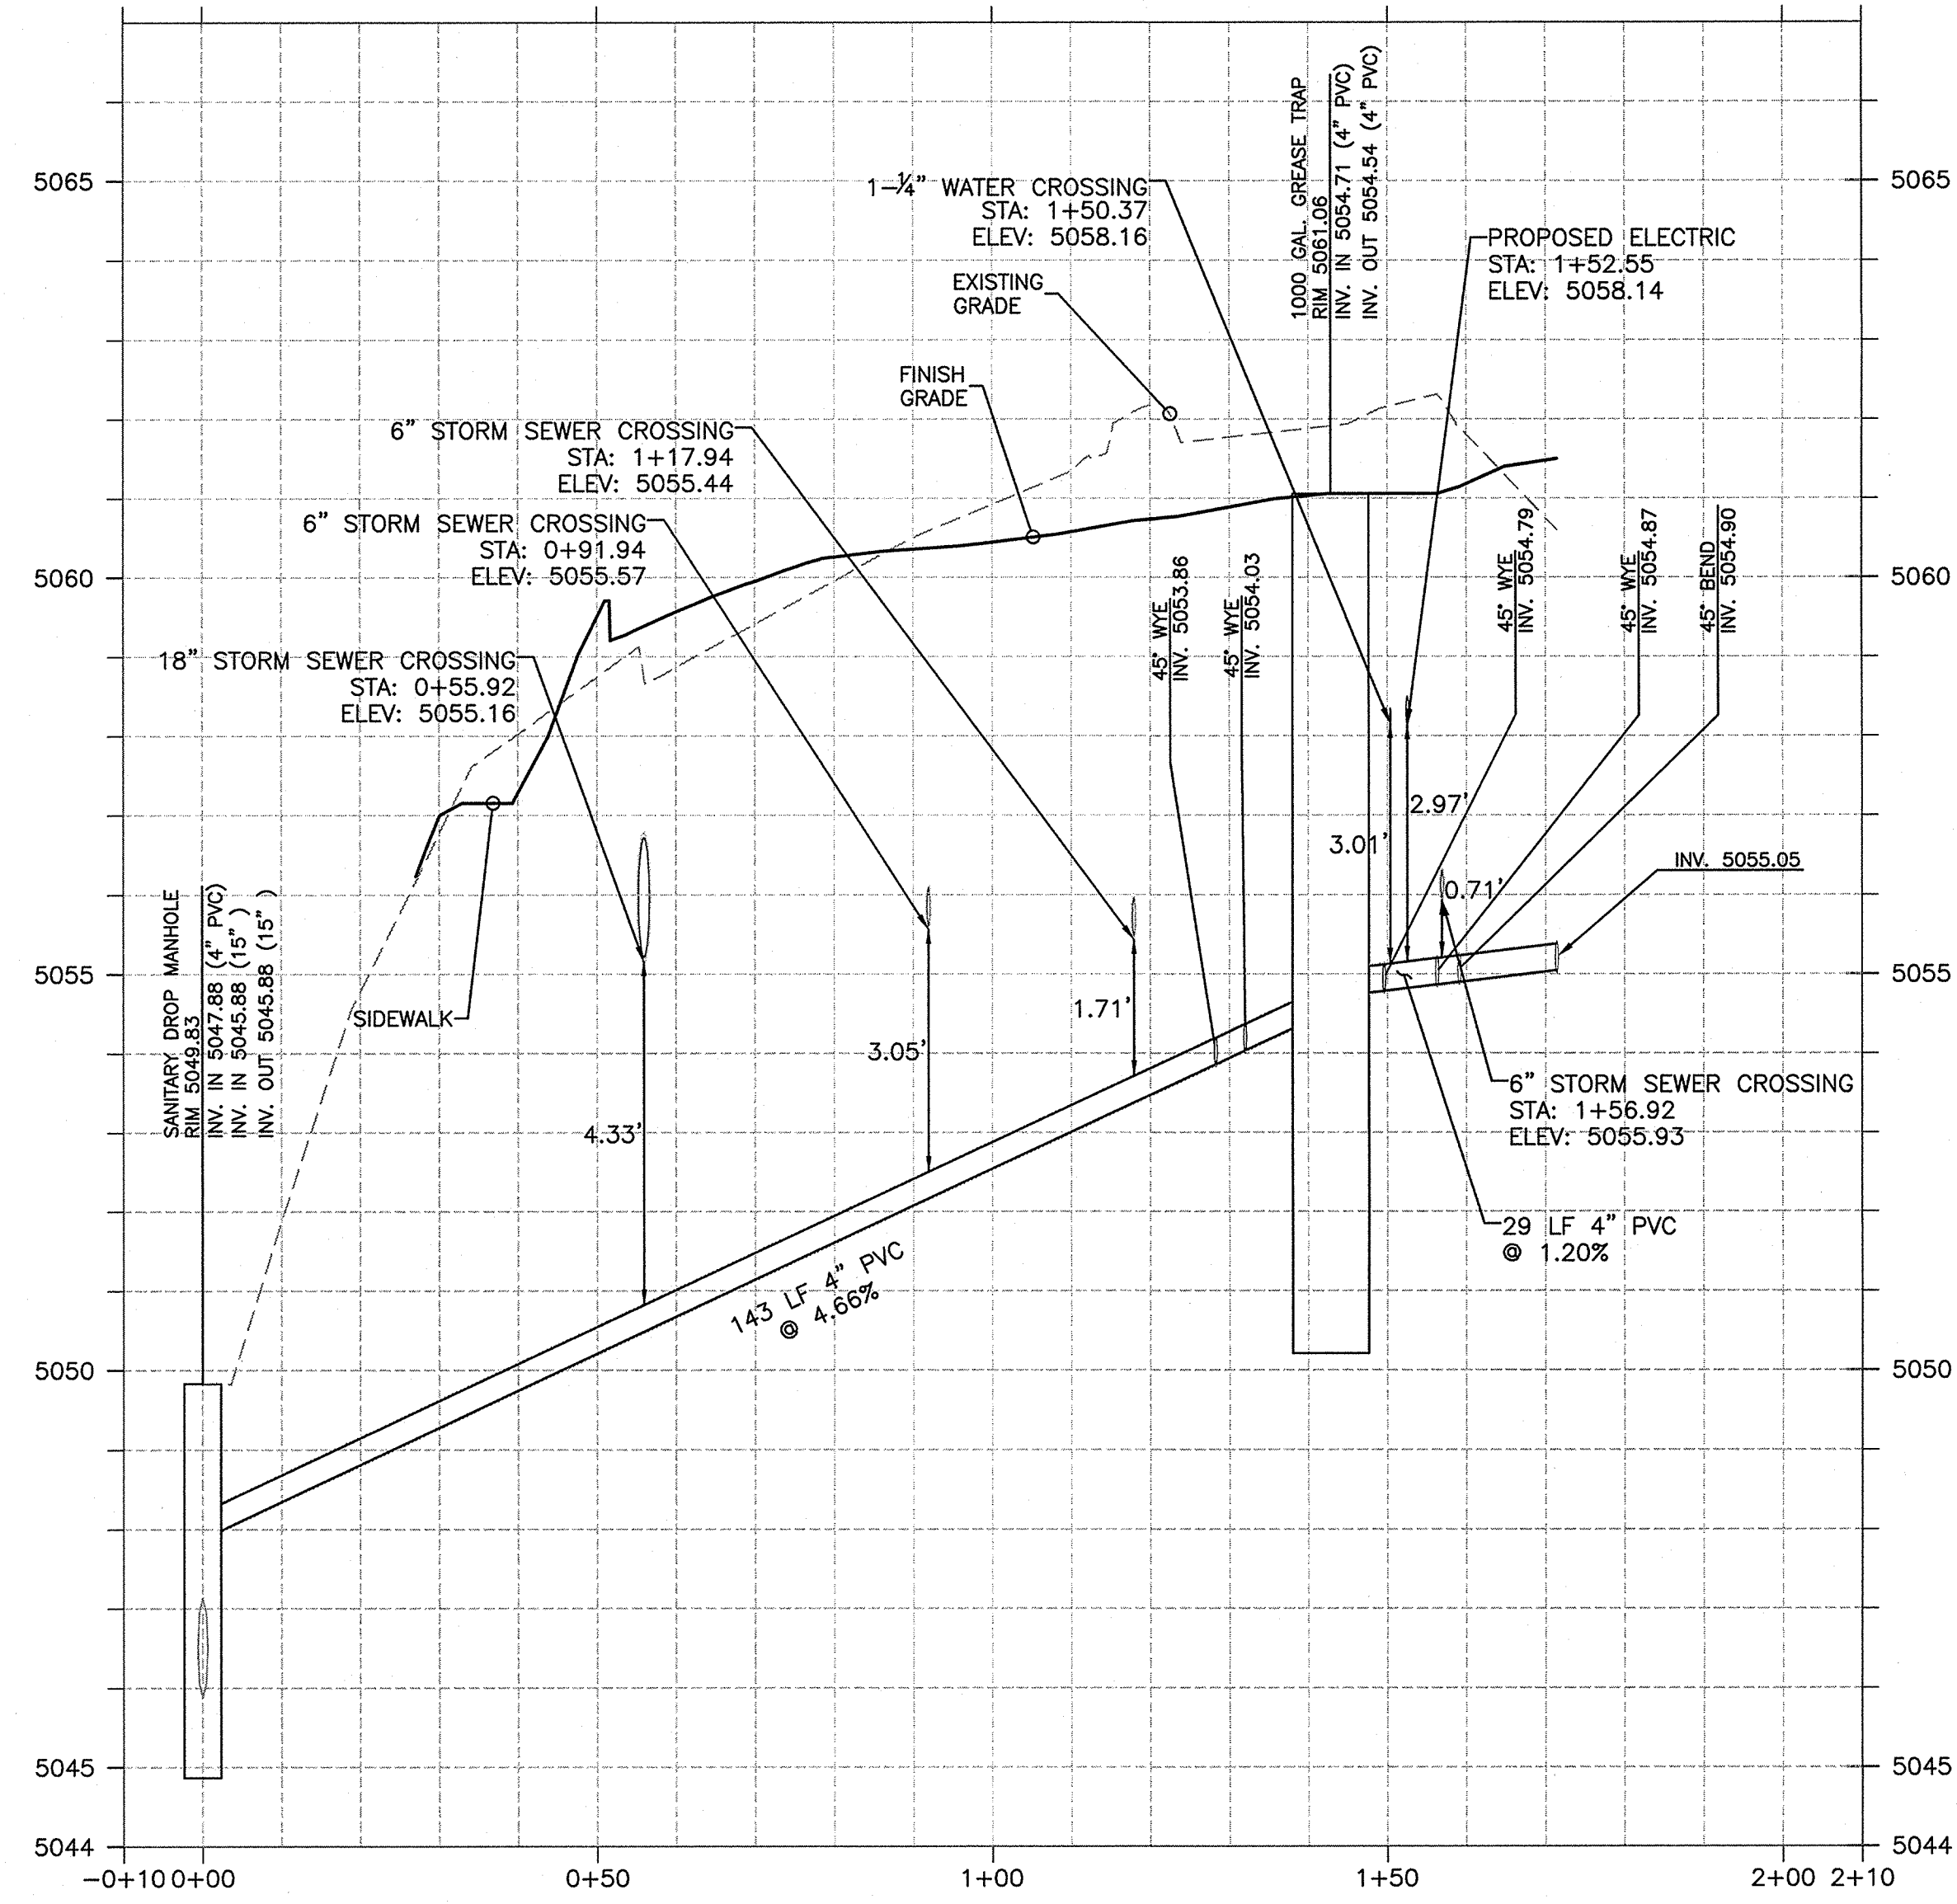

SANITARY SEWER
VERTICAL SCALE: 1"=2'
HORIZONTAL SCALE: 1"=20'

MURPHY OIL USA, INC.

MURPHY
USA

200 PEACH STREET
EL DORADO, AR 71730

GreenbergFarrow

1430 W. PEACHTREE ST. NW SUITE 200
ATLANTA, GA 30309
TEL: (404) 601 3700
FAX: (404) 601 3701
DWG NAME: ALBUQUERQUE, NM
JOB NO.: 20160897.0





UTILITY PROFILES
MURPHY EXPRESS
3751 HIGHWAY 628 NW
ALBUQUERQUE NEW MEXICO


REV-0
DATE
08-23-17
JN
PRN
DS
PM
DS
DES
DRW

SHEET NO.




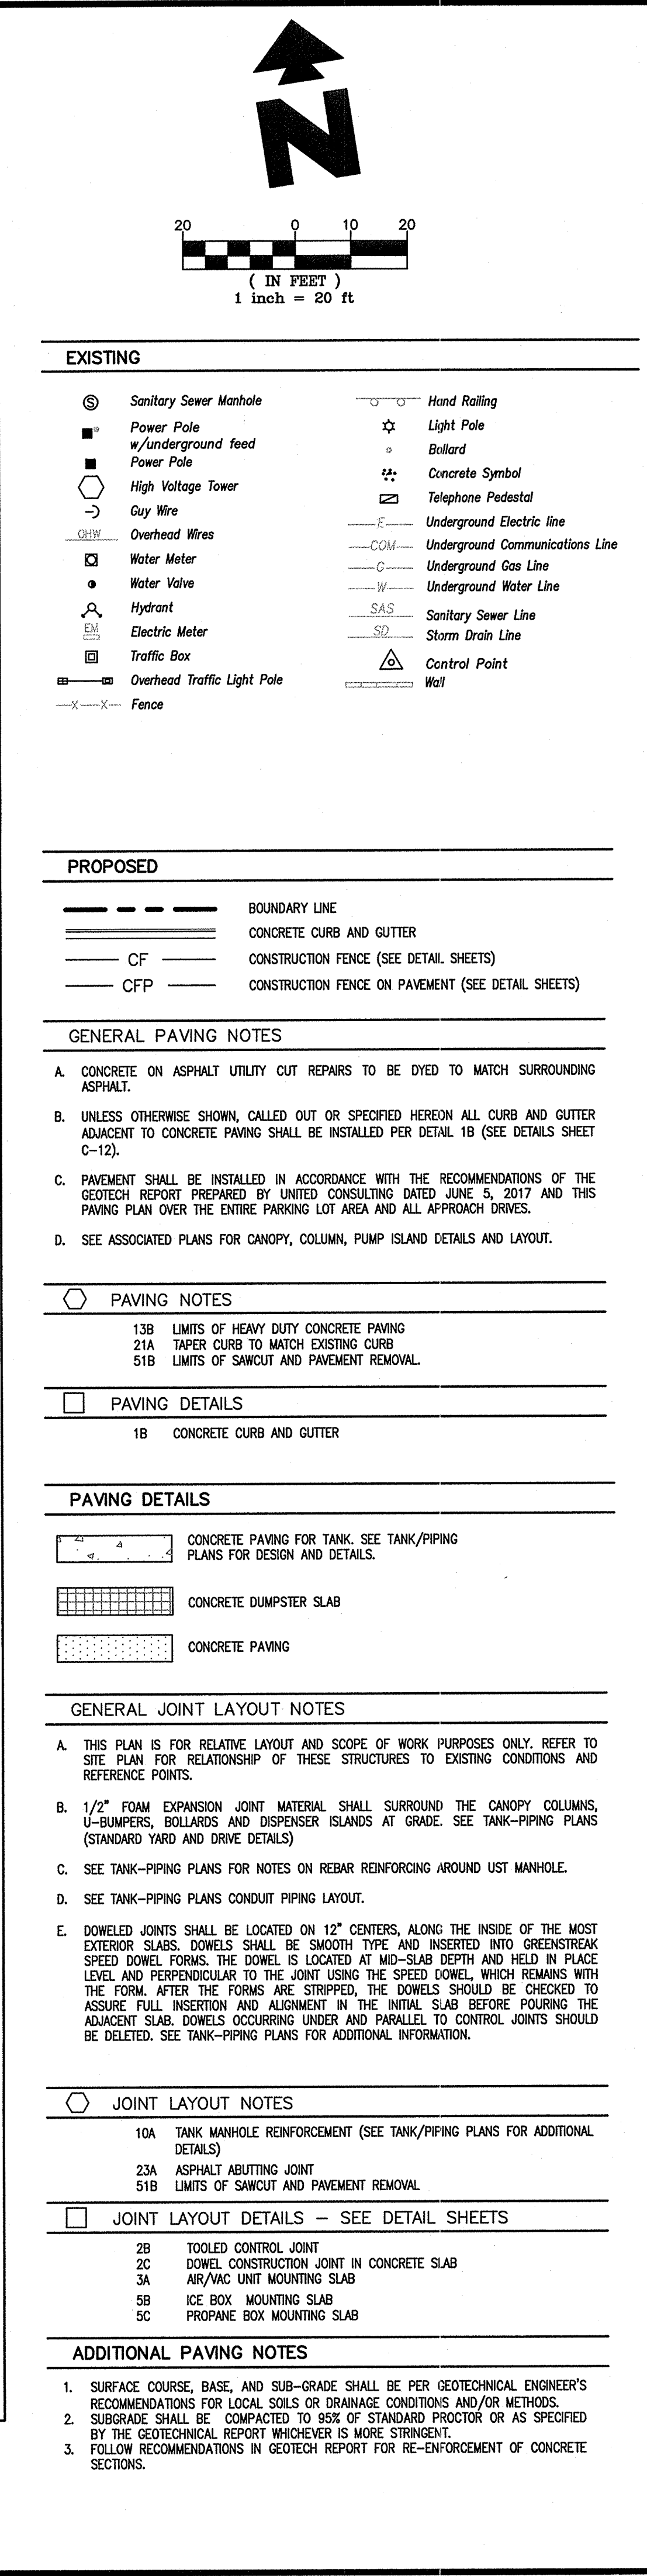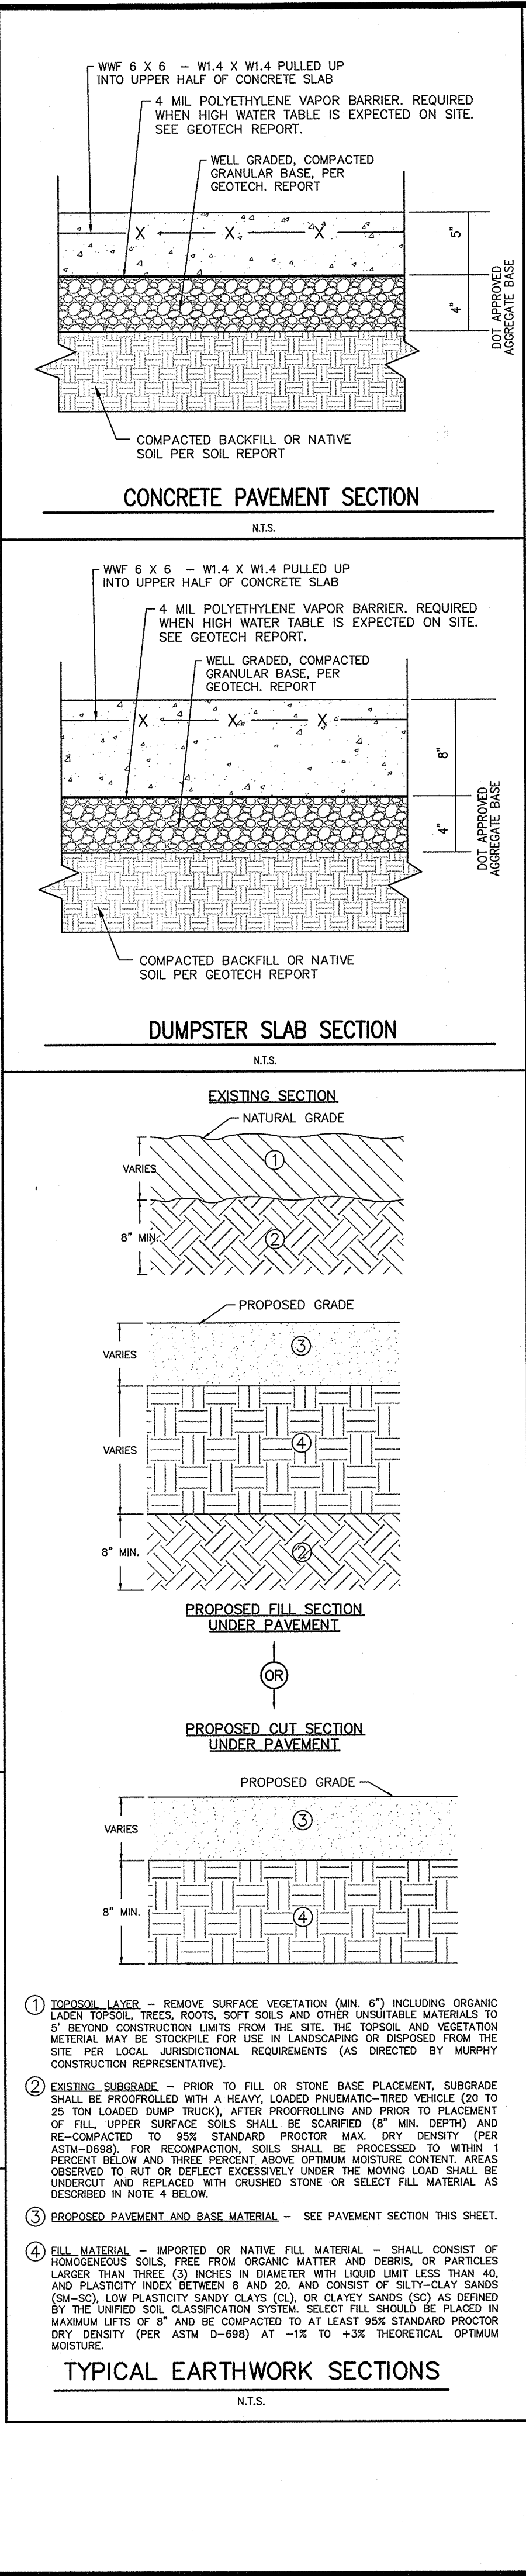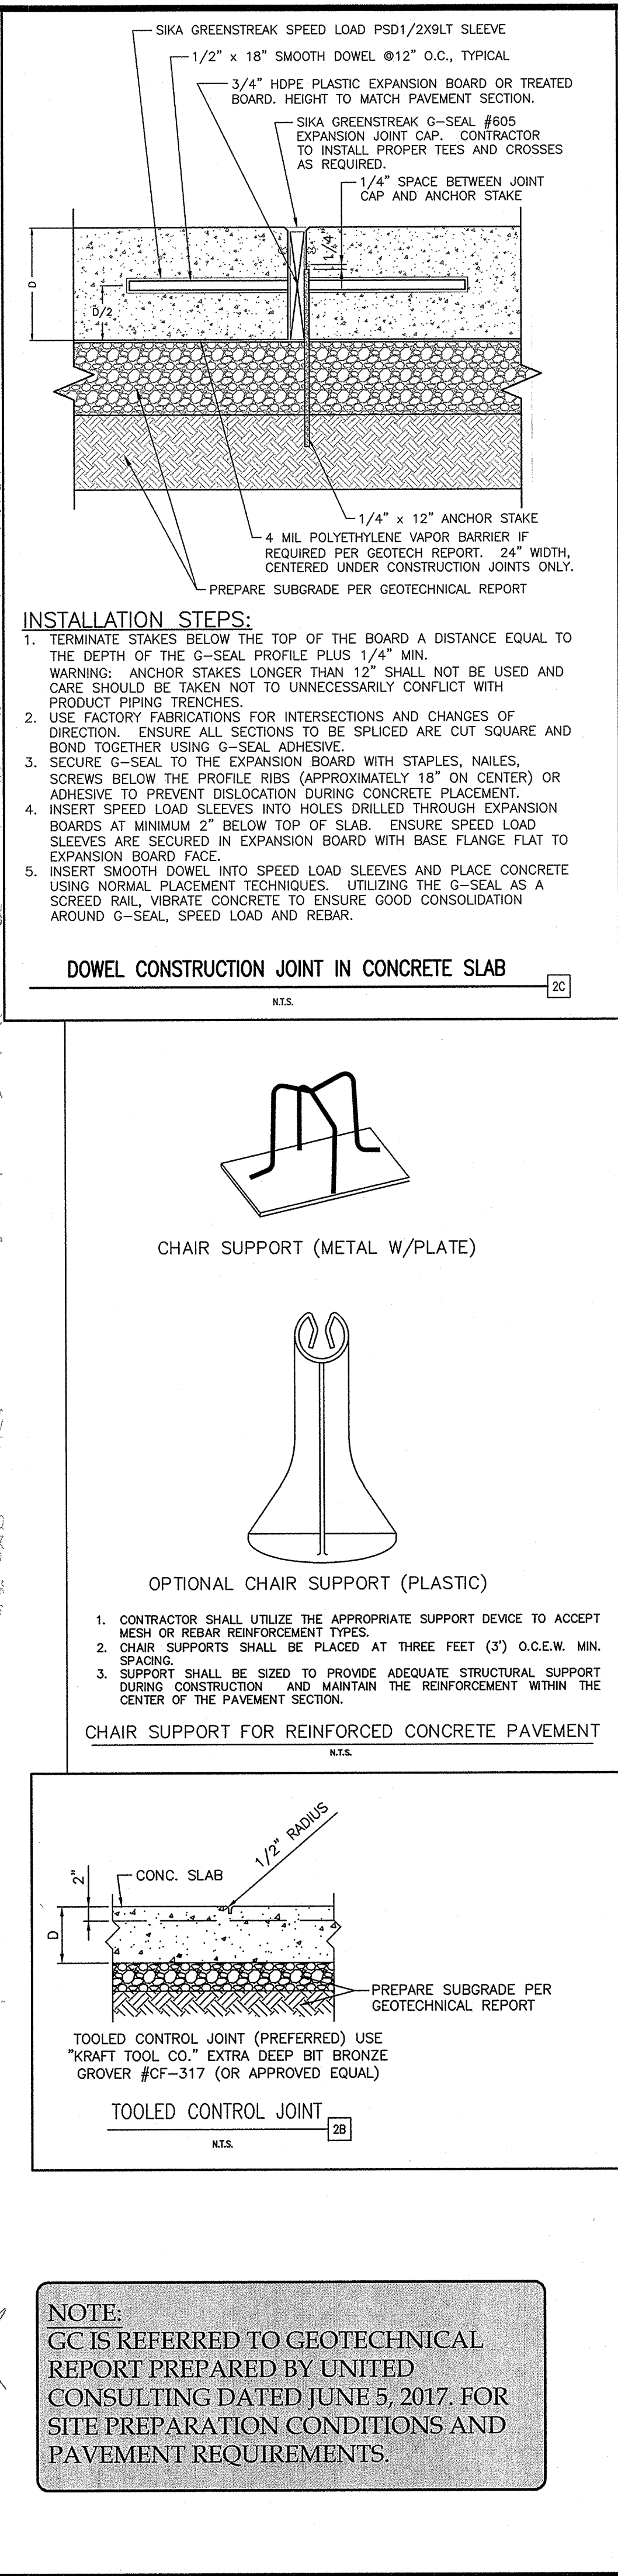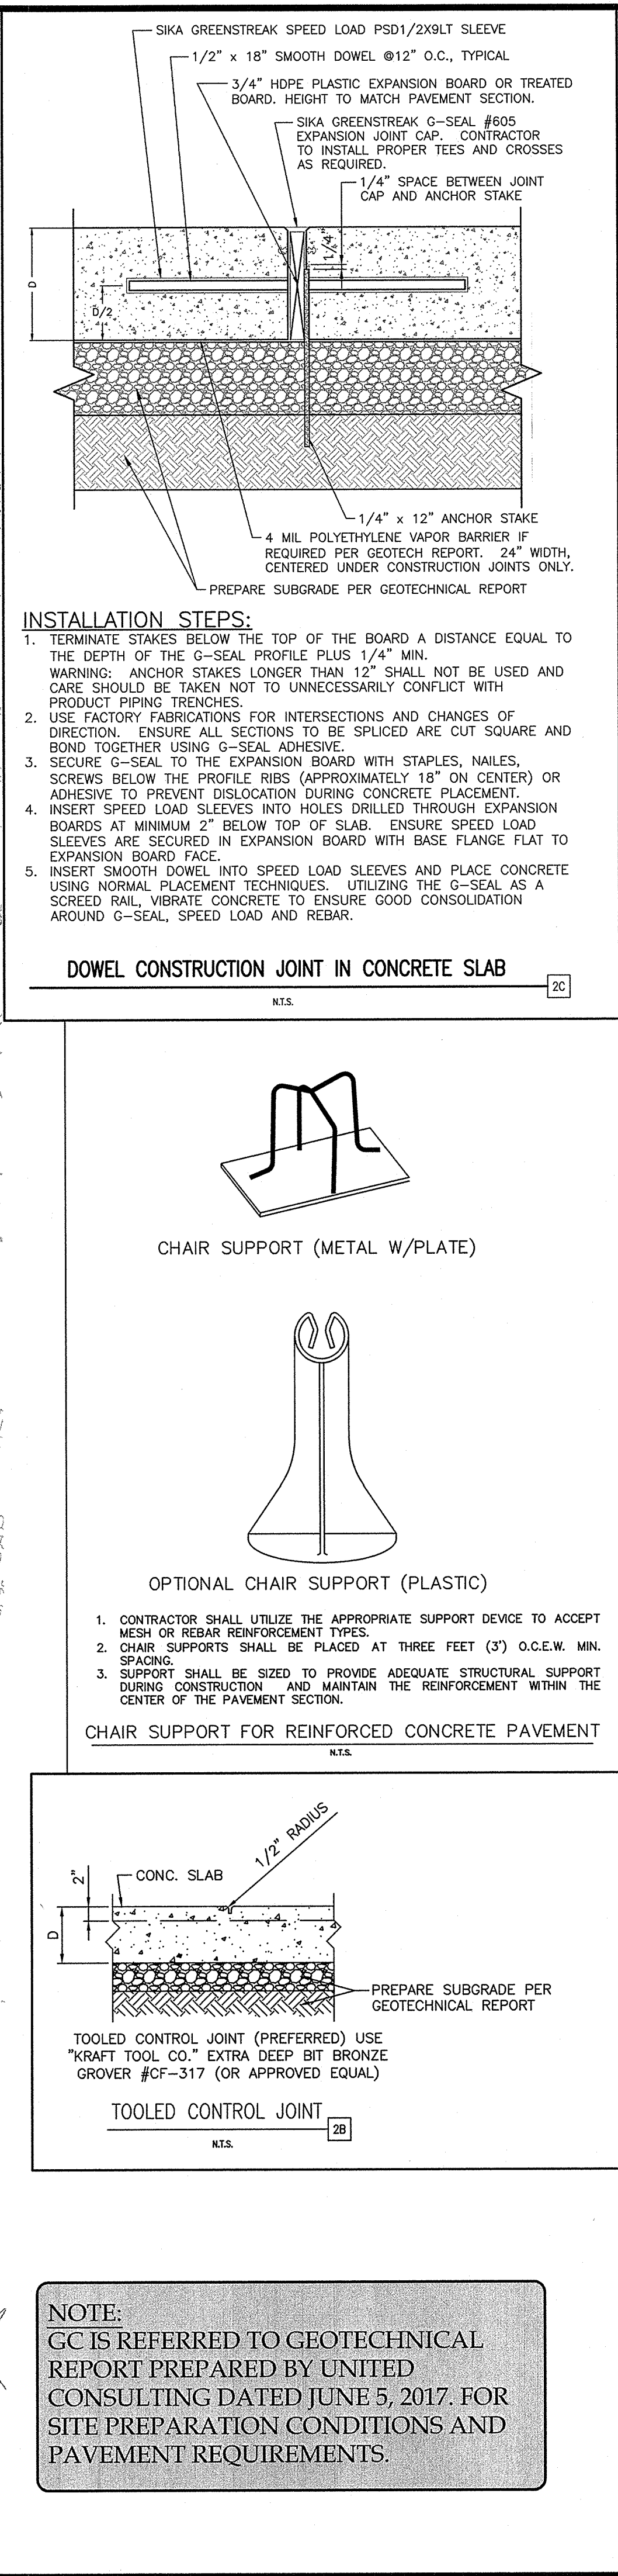


JOHN H. NOURZAD
NEW MEXICO
19062
PROFESSIONAL ENGINEER
AUG 23 2017

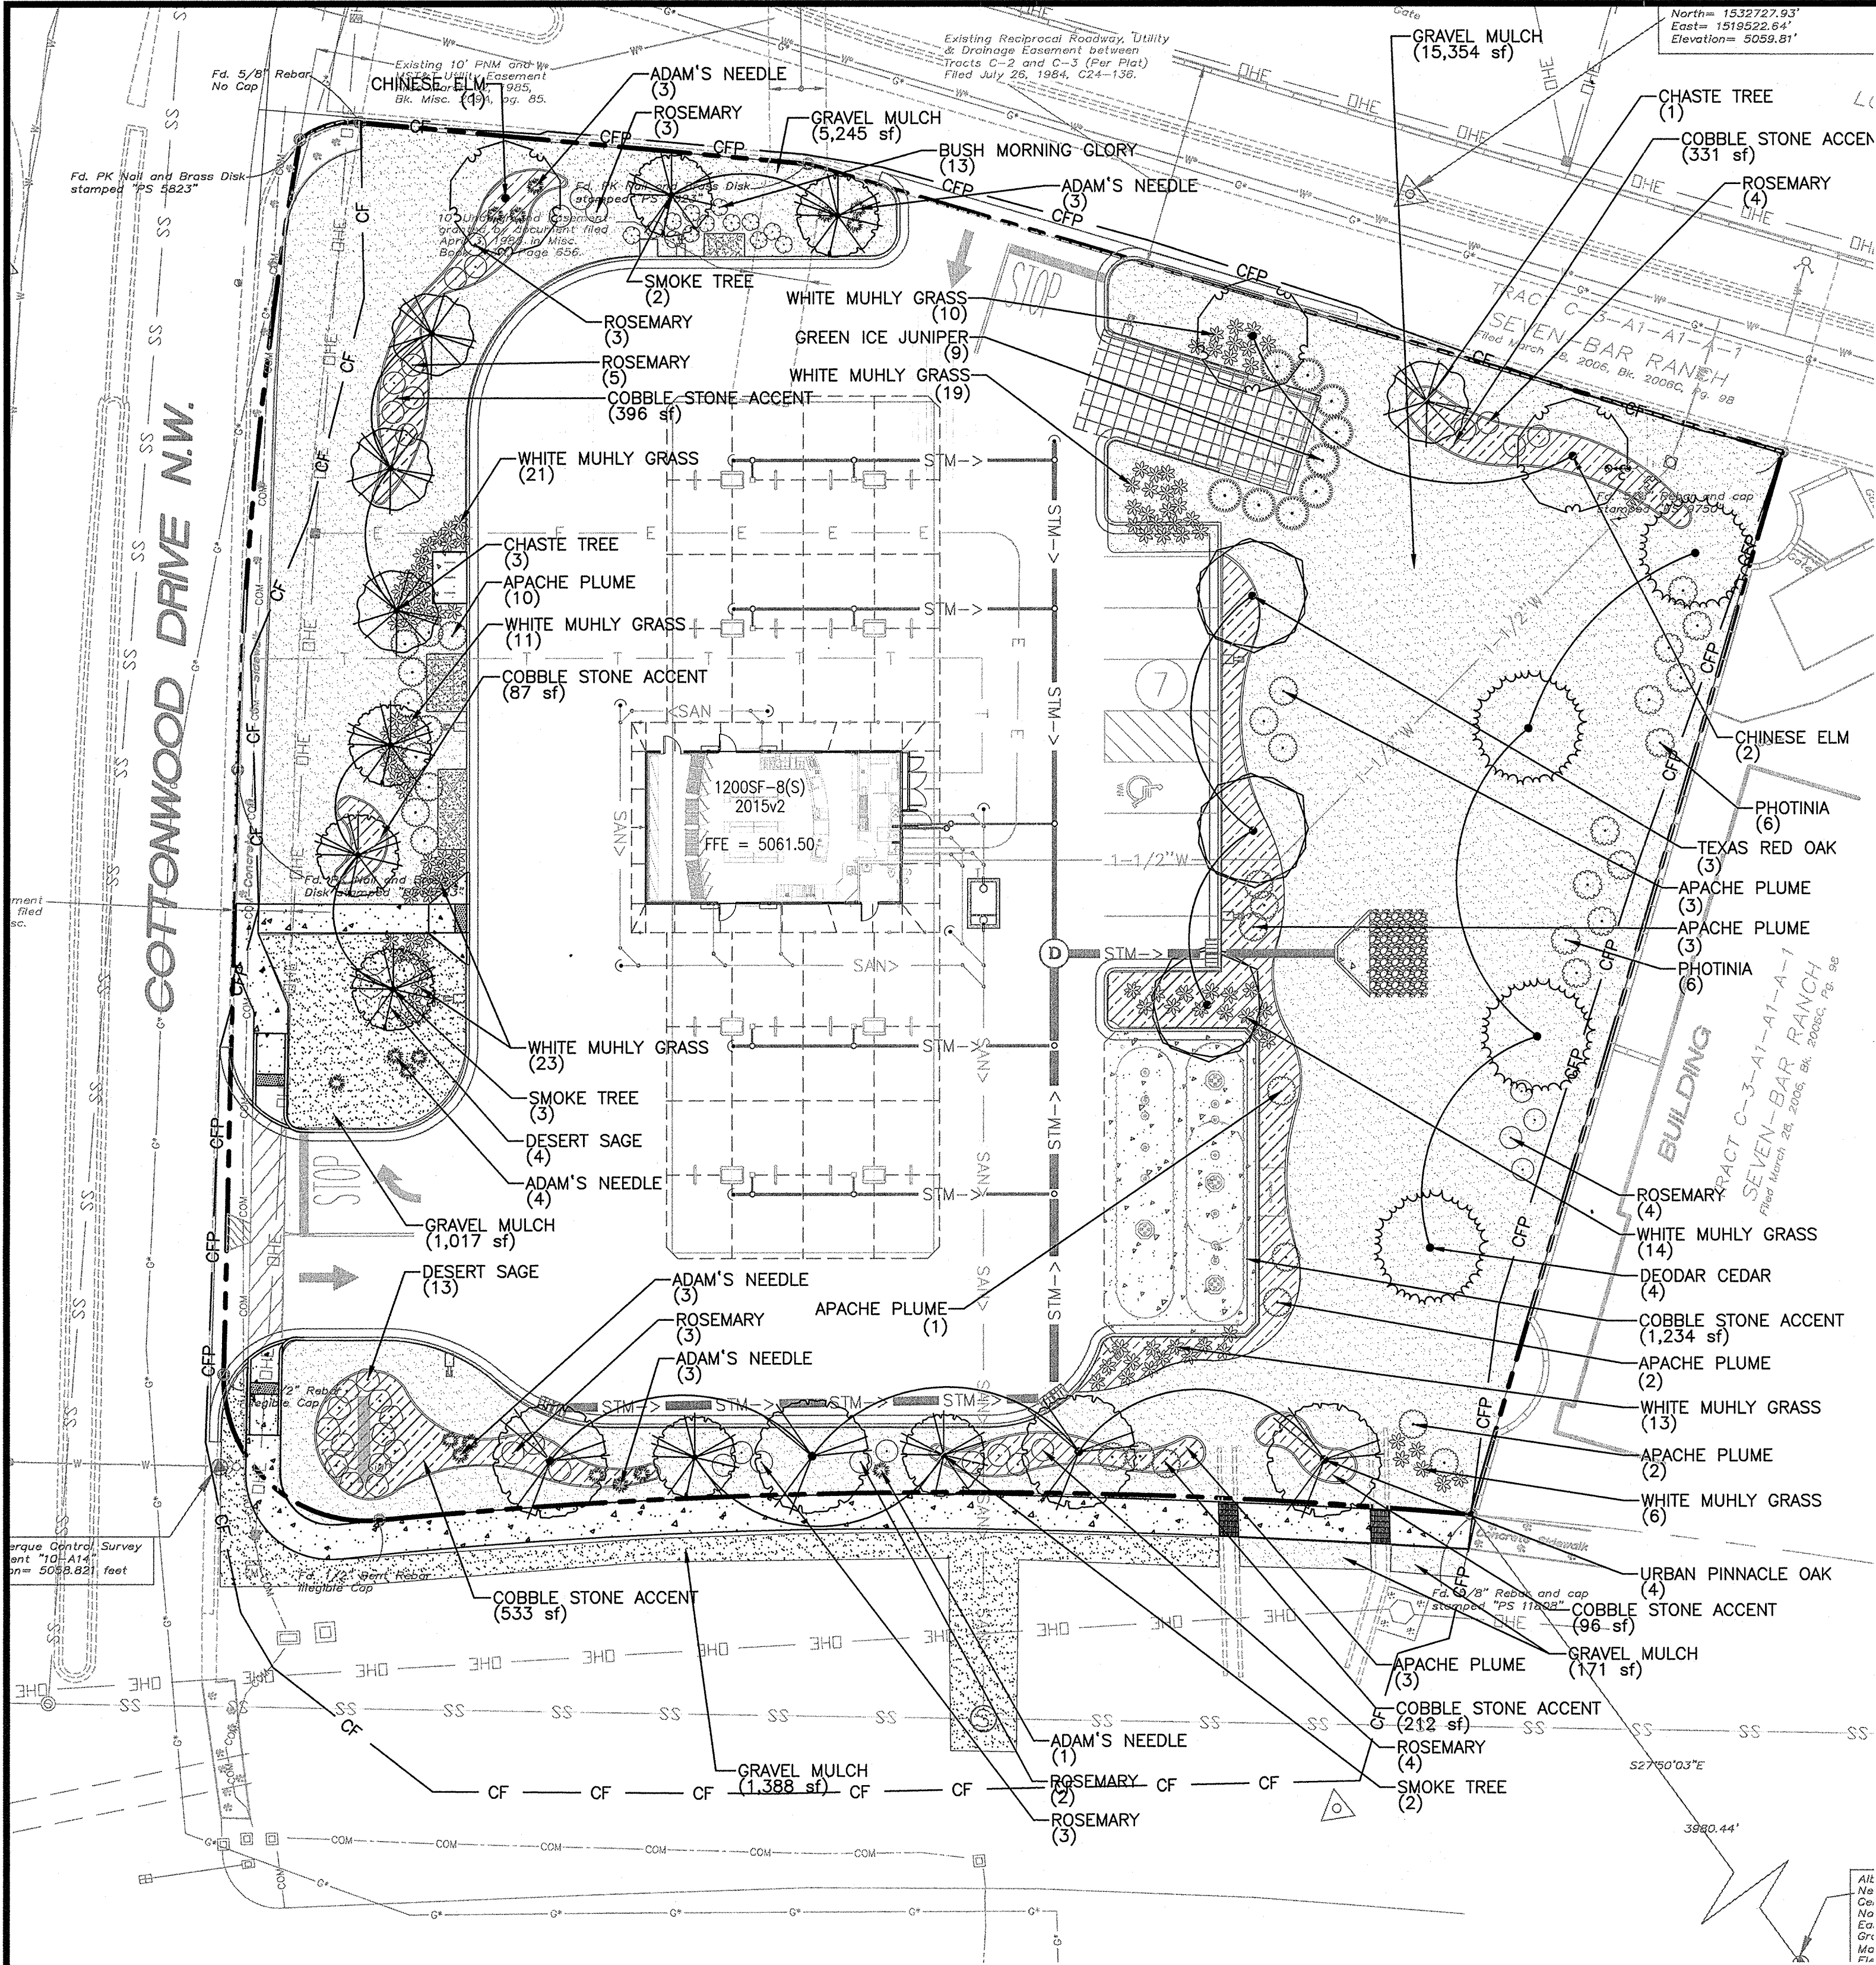C-6.1



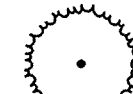

PLANT SCHEDULE LANDSCAPE


TREES	QTY	BOTANICAL NAME / COMMON NAME	CONT	CAL	SIZE	REMARKS
	4	Cedrus deodara / Deodar Cedar	B & B	3"Cal	12'-15' H	
	7	Cotinus coggygia 'Golden Spirit' / Smoke Tree	B & B	2.5"Cal	8'-10' HT	Straight trunk; full form
	4	Quercus macrocarpa 'Urban Pinnacle' / Urban Pinnacle Oak	B & B	3"Cal	10'-12' HT	Full Well Rooted, Straight Trunk
	3	Quercus texana / Texas Red Oak	B & B	3"Cal	12'-15' H	Straight trunk; full form
	3	Ulmus parvifolia / Chinese Elm	B & B	3"Cal	12'-15' H	Straight trunk; clear 8' above ground
	4	Vitex agnus-castus / Chaste Tree	B & B	2"Cal		

SHRUBS	QTY	BOTANICAL NAME / COMMON NAME	SIZE	HEIGHT	WIDTH	REMARKS
	13	Convolvulus cneorum / Bush Morning Glory	3 gal	12" MIN.		Round, full form
	24	Fallugia paradoxa / Apache Plume	7 gal	36" MIN.		Round, full form
	9	Juniperus scopulorum 'Green Ice' TM / Green Ice Juniper	B & B		8' MIN	Full to ground; dense
	117	Muhlenbergia capillaris 'White Cloud' / White Muhly Grass	3 gal			SP. 30" O.C.
	12	Photinia x fraseri / Photinia	7 gal	48" HT MIN.		Dense to ground
	31	Rosmarinus officinalis / Rosemary	7 gal	30" MIN.		Full form
	17	Salvia dorrii / Desert Sage	3 gal	18" MIN,		Dense, full form
	17	Yucca filamentosa 'Color Guard' / Adam's Needle	5 gal			Full, Well Rooted




NOTE: STRAPS, WIDE, SOFT, BIODEGRADABLE MATERIAL MANUFACTURED FOR THE PURPOSE OF TREE ANCHORING. DO NOT USE HOSE AND WIRE.

DECIDUOUS TREE PLANTING

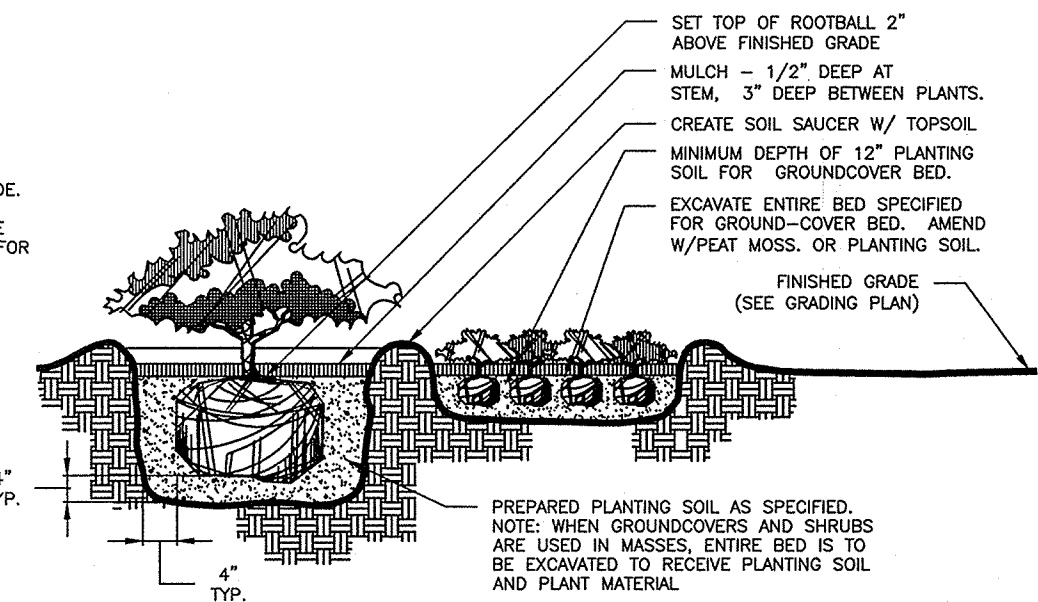


SHRUB PLANTING

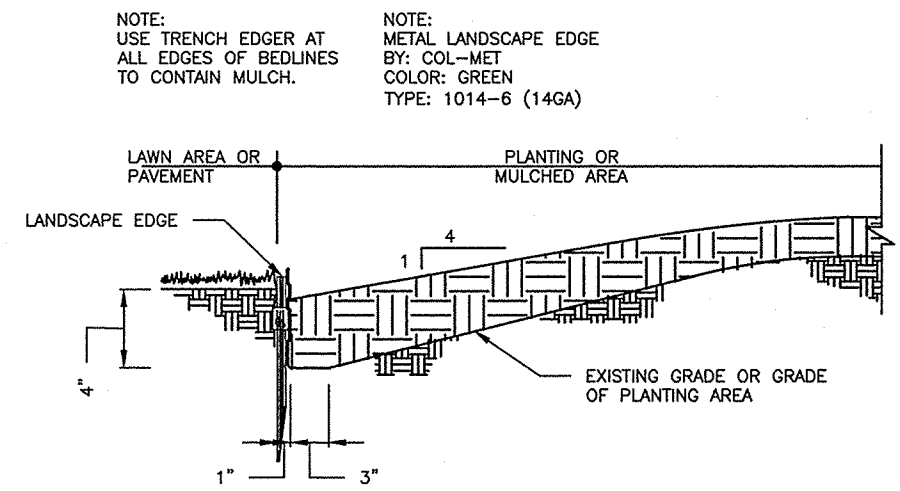

TRENCH EDGER DETAIL

LANDSCAPE CALCULATIONS		
	REQUIRED	PROVIDED
LANDSCAPE AREA		
SITE = 1.25 AC (54,540 SF)	8,181 SF (15%)	24,355 SF (44%)
OFF STREET PARKING AREA LANDSCAPE		
1 TREE PER 10 SPACES	1	3
PROPOSED PARKING SPACES ARE LOCATED IN 100' FROM A TREE TRUNK		
STREET TREES (AMERICAN RD.) - 1 TREE PER 35LF		
(269 LF - 36LF DRIVE) / 35LF	6.6(7)	7
COTTONWOOD DR. - 1 TREE PER 35LF		
(259 LF - 36LF DRIVE) / 35LF	6.2(7)	7
HWY 528 - 1 TREE PER 35LF		
192 LF / 35LF =	5.4(6)	6

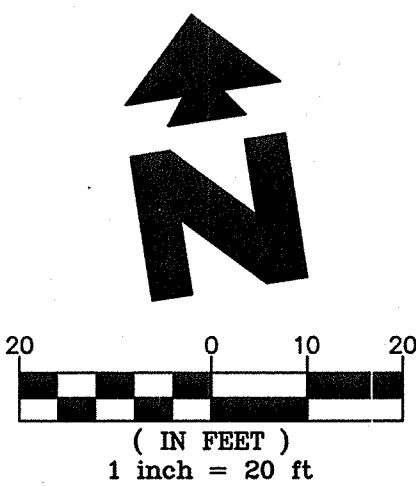

EXISTING

- Sanitary Sewer Manhole
- Power Pole w/underground feed
- Power Pole
- High Voltage Tower
- Guy Wire
- Overhead Wires
- Water Meter
- Water Valve
- Hydrant
- Electric Meter
- Traffic Box
- Overhead Traffic Light Pole
- Fence
- Hand Railing
- Light Pole
- Ballard
- Concrete Symbol
- Telephone Pedestal
- Underground Electric Line
- Underground Communications Line
- Underground Gas Line
- Underground Water Line
- Sanitary Sewer Line
- Storm Drain Line
- Control Point
- Wall

PROPOSED

- BOUNDARY LINE
- TYPICAL PLANTING WITH QUANTITY AND KEY (SEE PLANT LIST)
- CONSTRUCTION FENCE (SEE CIVIL DETAILS)

GENERAL LANDSCAPE NOTES

A. LOCATE ALL UTILITIES AND SITE LIGHTING CONDUITS BEFORE LANDSCAPE CONSTRUCTION BEGINS.

B. NOTIFY LANDSCAPE ARCHITECT OR DESIGNATED REPRESENTATIVE OF ANY LAYOUT DISCREPANCIES PRIOR TO ANY PLANTING.

C. ALL LANDSCAPE MATERIALS SHALL BE IN COMPLIANCE WITH THE AMERICAN STANDARD FOR NURSERY STOCK. (ANSI-Z60.1-1986)

D. ALL SLOPES AND AREAS DISTURBED BY CONSTRUCTION SHALL BE GRADED SMOOTH AND FOUR INCHES OF TOPSOIL APPLIED. IF ADEQUATE TOPSOIL IS NOT AVAILABLE ON SITE, THE CONTRACTOR SHALL PROVIDE TOPSOIL APPROVED BY THE OWNER, AS NEEDED. THE AREA SHALL THEN BE SEED/ED, FERTILIZED, MULCHED, WATERED AND MAINTAINED UNTIL HARDY GRASS GROWTH IS ESTABLISHED IN ALL AREAS. ANY RELOCATED TREES SHALL BE MAINTAINED UNTIL SUCH POINT AS TREE IS RE-ESTABLISHED. ANY AREAS DISTURBED SHALL BE RE-SEED/ED PRIOR TO FINAL ACCEPTANCE OF THE PROJECT SHALL BE CORRECTED BY THE CONTRACTOR AT NO ADDITIONAL COST TO THE OWNER.

E. THE MURPHY STATION WILL NOT DROPT MASTER DEVELOPMENT'S GREEN SPACE BELOW CITY'S REQUIREMENTS.

F. CONTRACTOR IS TO VERIFY LOCATION OF MASTER DEVELOPMENT IRRIGATION SYSTEM, VALVE BOXES, CONTROL BOXES, BACKFLOW PREVENTION DEVICES AND OTHER ITEMS WHICH ARE PART OF THE SYSTEM. IF DAMAGED THEY MUST BE REPAIRED AT CONTRACTOR'S COST.

G. CONTRACTOR IS TO PROTECT EXISTING LANDSCAPING/IRRIGATION MATERIALS.

H. ACCEPTANCE OF GRADING AND SEEDING SHALL BE BY LANDSCAPE ARCHITECT AND/OR OWNER. THE CONTRACTOR SHALL ASSUME MAINTENANCE RESPONSIBILITIES FOR A MINIMUM OF ONE (1) YEAR OR UNTIL SECOND CUTTING, WHICHEVER IS LONGER. MAINTENANCE SHALL INCLUDE WATERING, WEEDING, RESEEDING, AND OTHER OPERATIONS NECESSARY TO KEEP ALL LAWN AREAS IN A THRIVING CONDITIONS. UPON FINAL ACCEPTANCE, OWNER SHALL ASSUME ALL MAINTENANCE RESPONSIBILITIES. AFTER LAWN AREA HAVE GERMINATED, AREAS WHICH FAIL TO SHOW A UNIFORM STAND OF GRASS FOR ANY REASON WHATSOEVER SHALL BE RE-SEED/ED REPEATEDLY UNTIL ALL AREAS ARE COVERED WITH A SATISFACTORY STAND OF GRASS. MINIMUM ACCEPTANCE OF SEED/ED LAWN AREAS MAY INCLUDE SCATTERED BARE SPOTS, NONE OF WHICH ARE LARGER THAN 1 SQUARE FOOT, AND WHEN COMBINED DO NOT EXCEED 2% OF TOTAL SEED/ED LAWN AREA.

J. THE LANDSCAPE CONTRACTOR SHALL VERIFY ALL QUANTITIES SHOWN ON THESE PLANS, BEFORE PRICING THE WORK.

K. QUANTITIES ON THE PLANT SCHEDULE ARE PROVIDED FOR CONVENIENCE. THE CONTRACTOR SHALL BE RESPONSIBLE FOR HIS/HER OWN QUANTITY CALCULATIONS. IN THE EVENT OF A DISCREPANCY BETWEEN THE LANDSCAPE PLANS AND THE PLANT SCHEDULE, THE LANDSCAPE PLAN WILL TAKE PRECEDENCE. THE CONTRACTOR SHALL INFORM THE LANDSCAPE ARCHITECT IMMEDIATELY UPON DISCOVERING ANY QUANTITY DISCREPANCIES.

L. METAL LANDSCAPE EDGING IS TO BE INSTALLED BETWEEN SOD AND LANDSCAPE PLANTING BEDS.
































SHEET NO. **C-10**




JOHN H. NOURZAD
NEW MEXICO
19062
AUG 23 2017

LANDSCAPE PLAN
MURPHY EXPRESS
3751 HIGHWAY 528 NW
ALBUQUERQUE NEW MEXICO

GreenbergFarrow
1430 W. PEACHTREE ST. NW SUITE 200
ATLANTA, GA 30309
TEL: (404) 524-1000
FAX: (404) 524-1000
DWG NAME: ALBUQUERQUE, NM
JOB NO.: 20160897.0





MURPHY OIL USA, INC.
200 PEACH STREET
EL DORADO, AR 71730

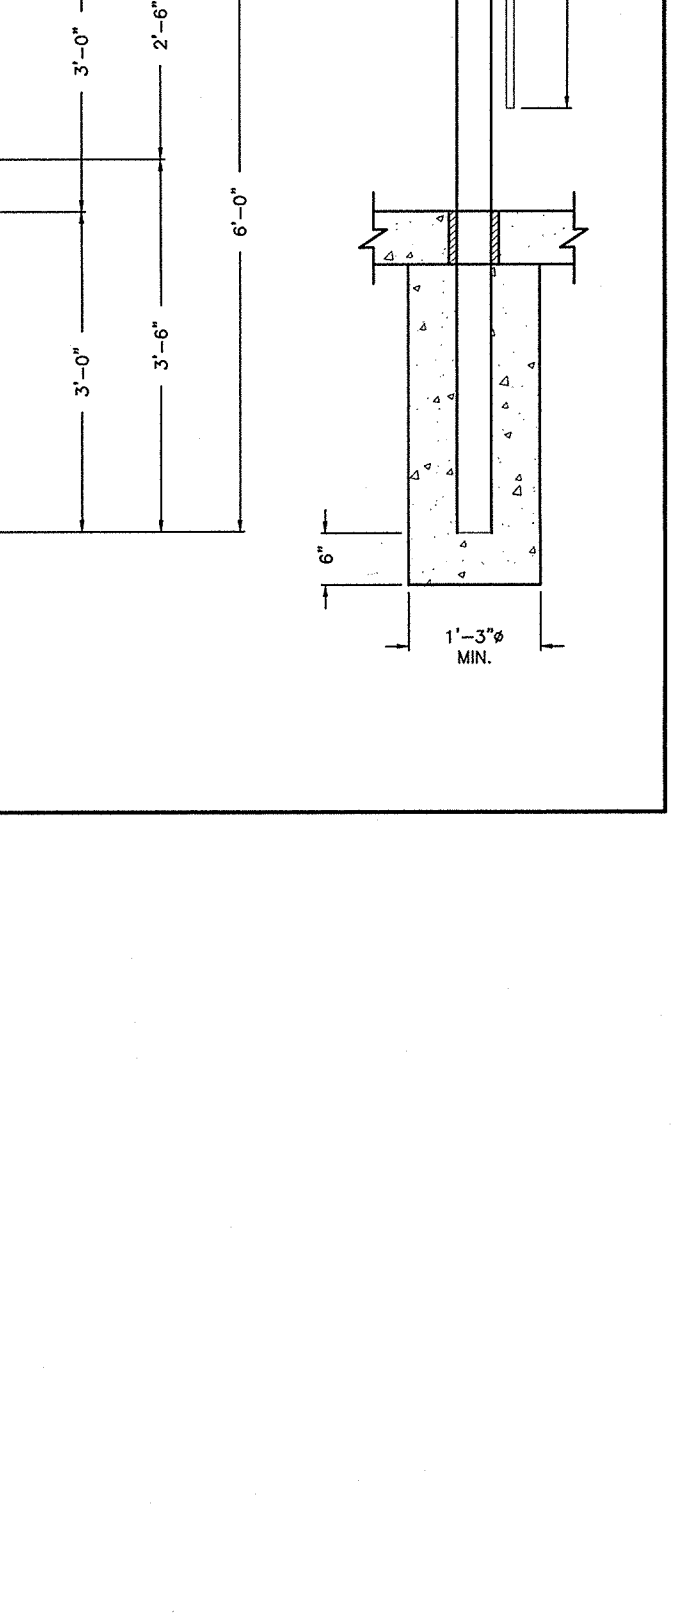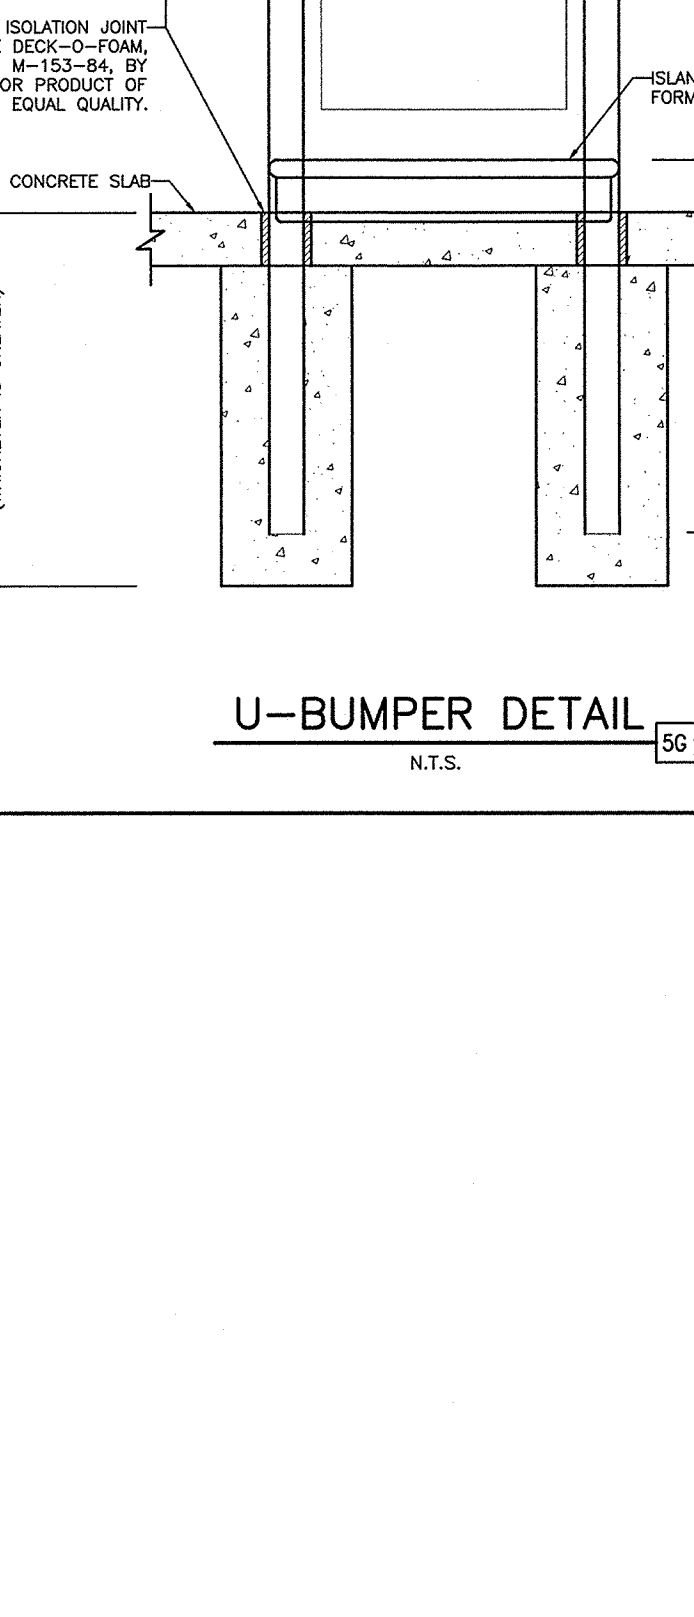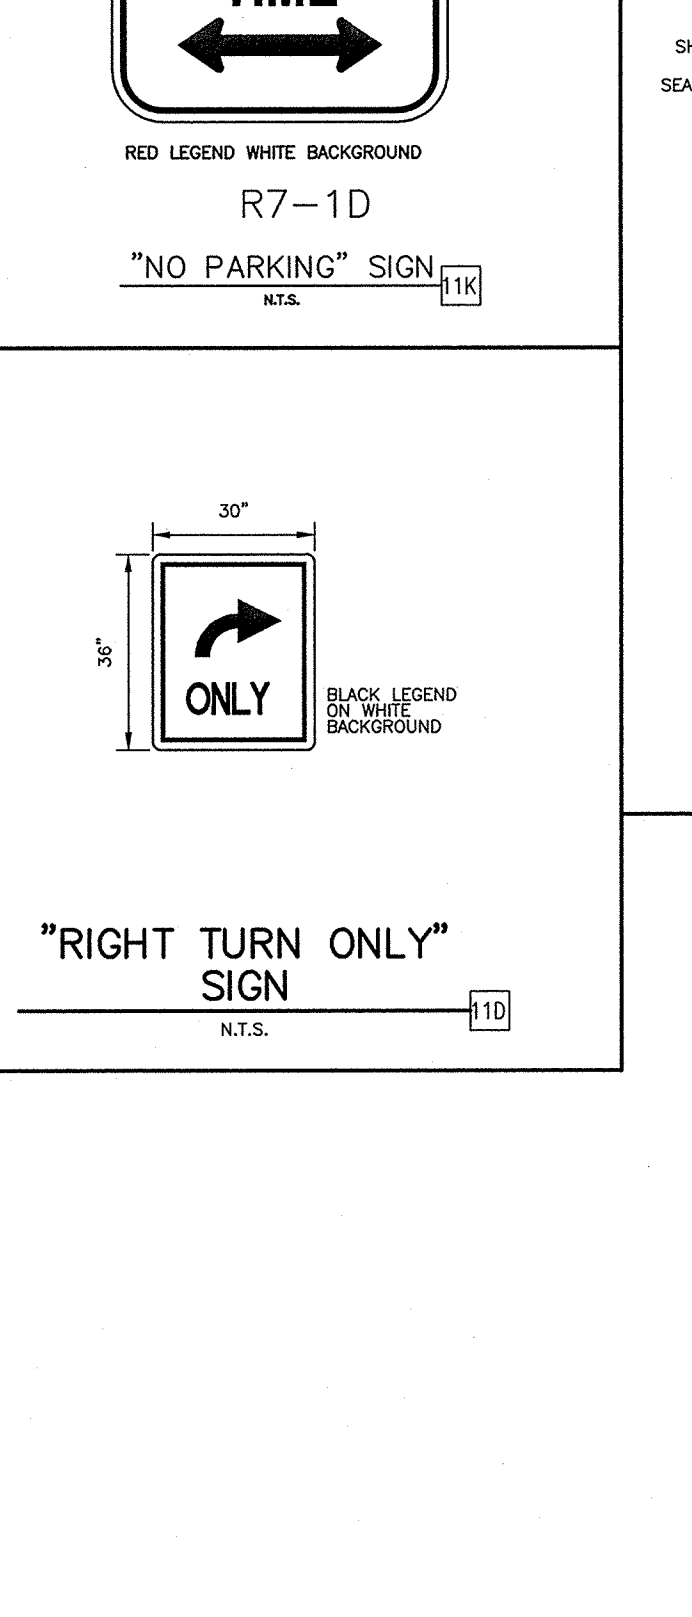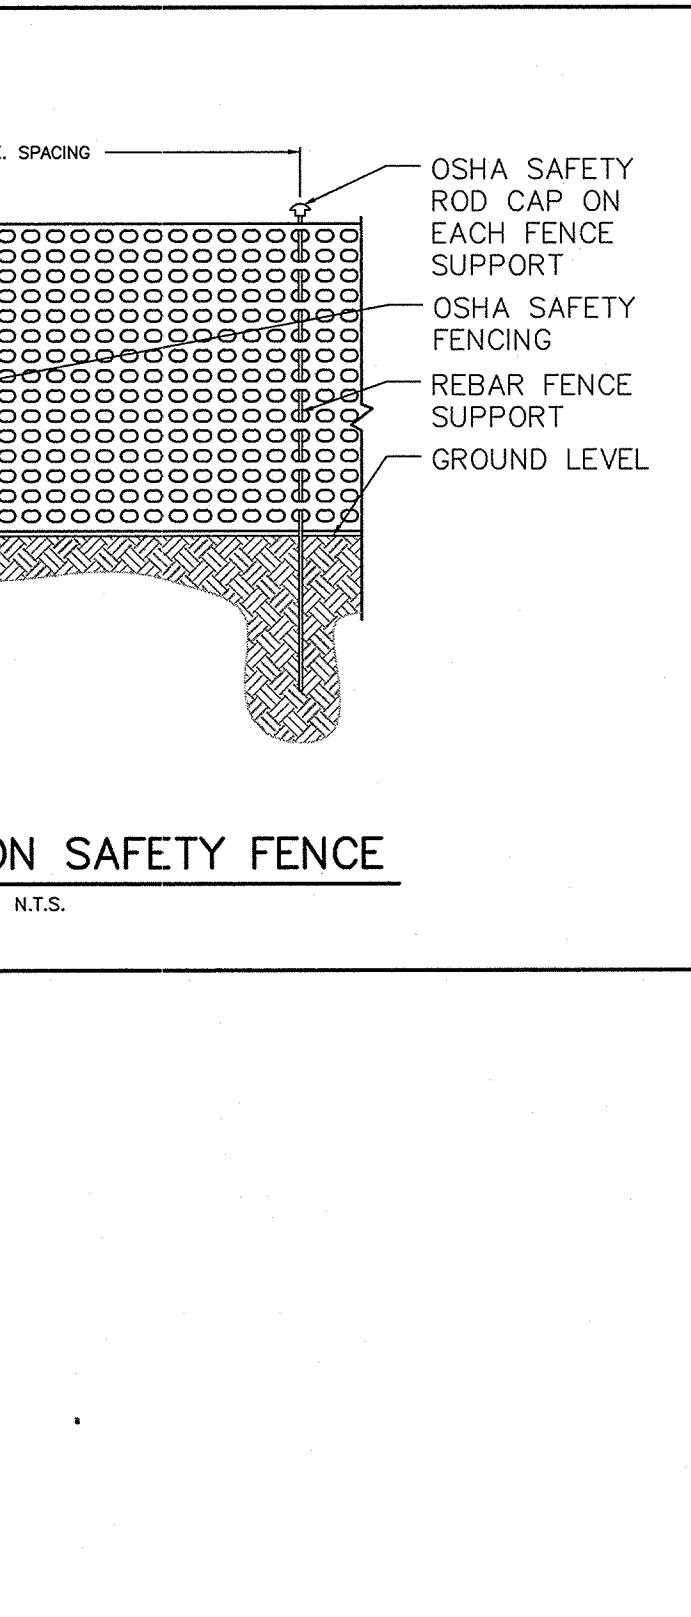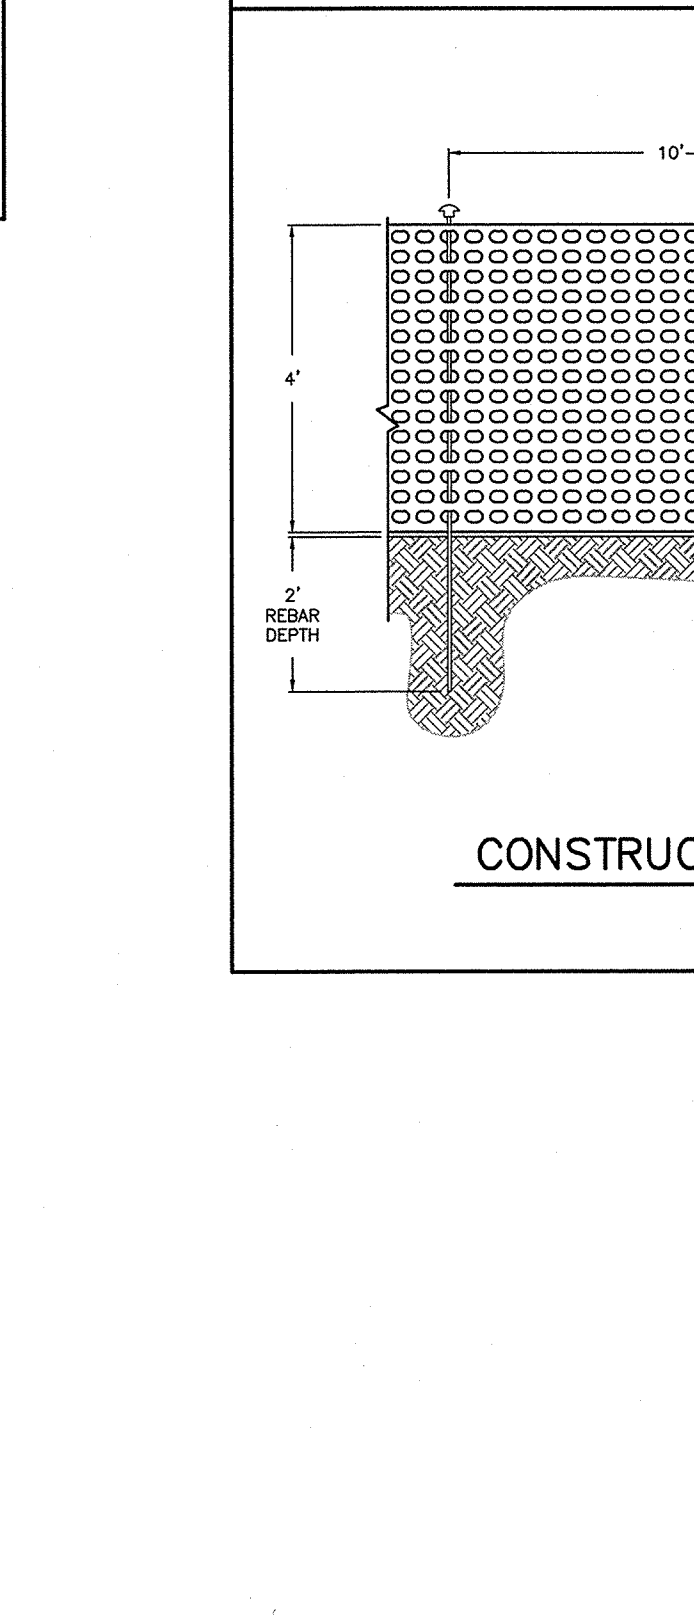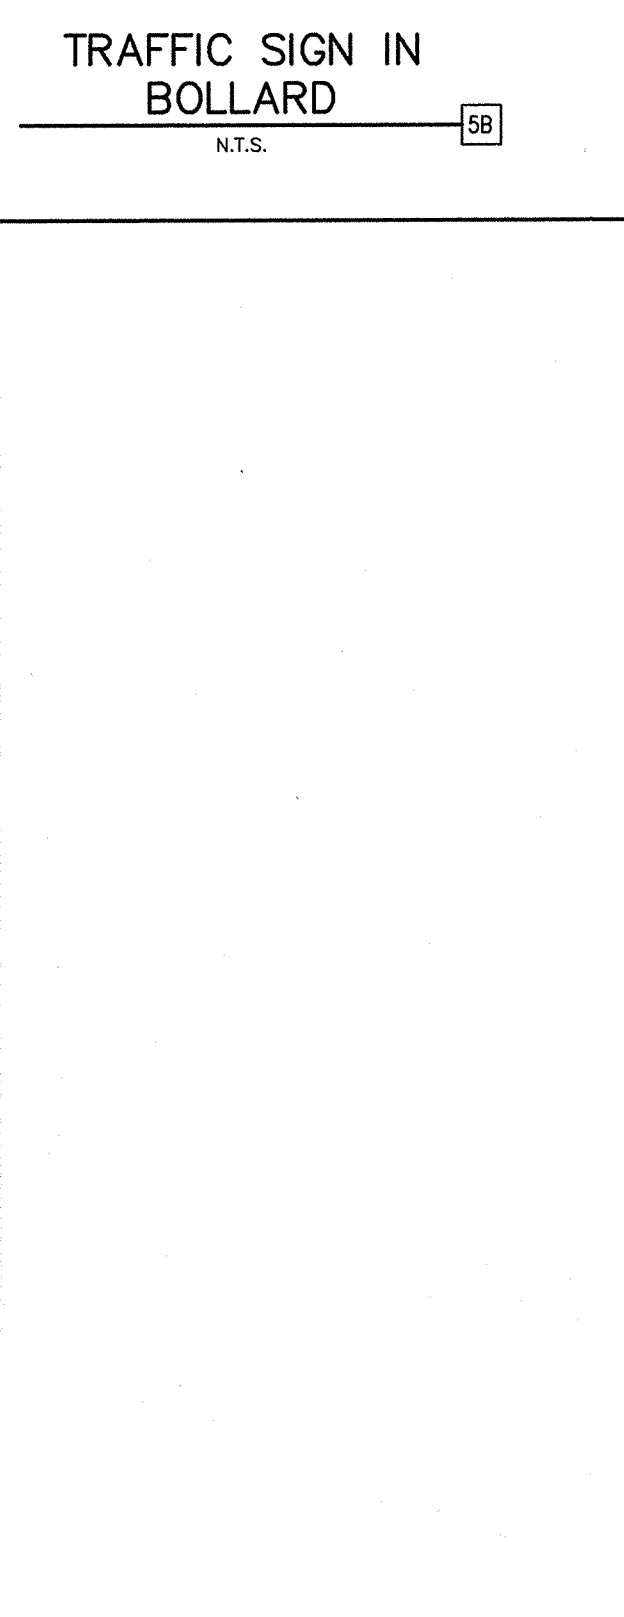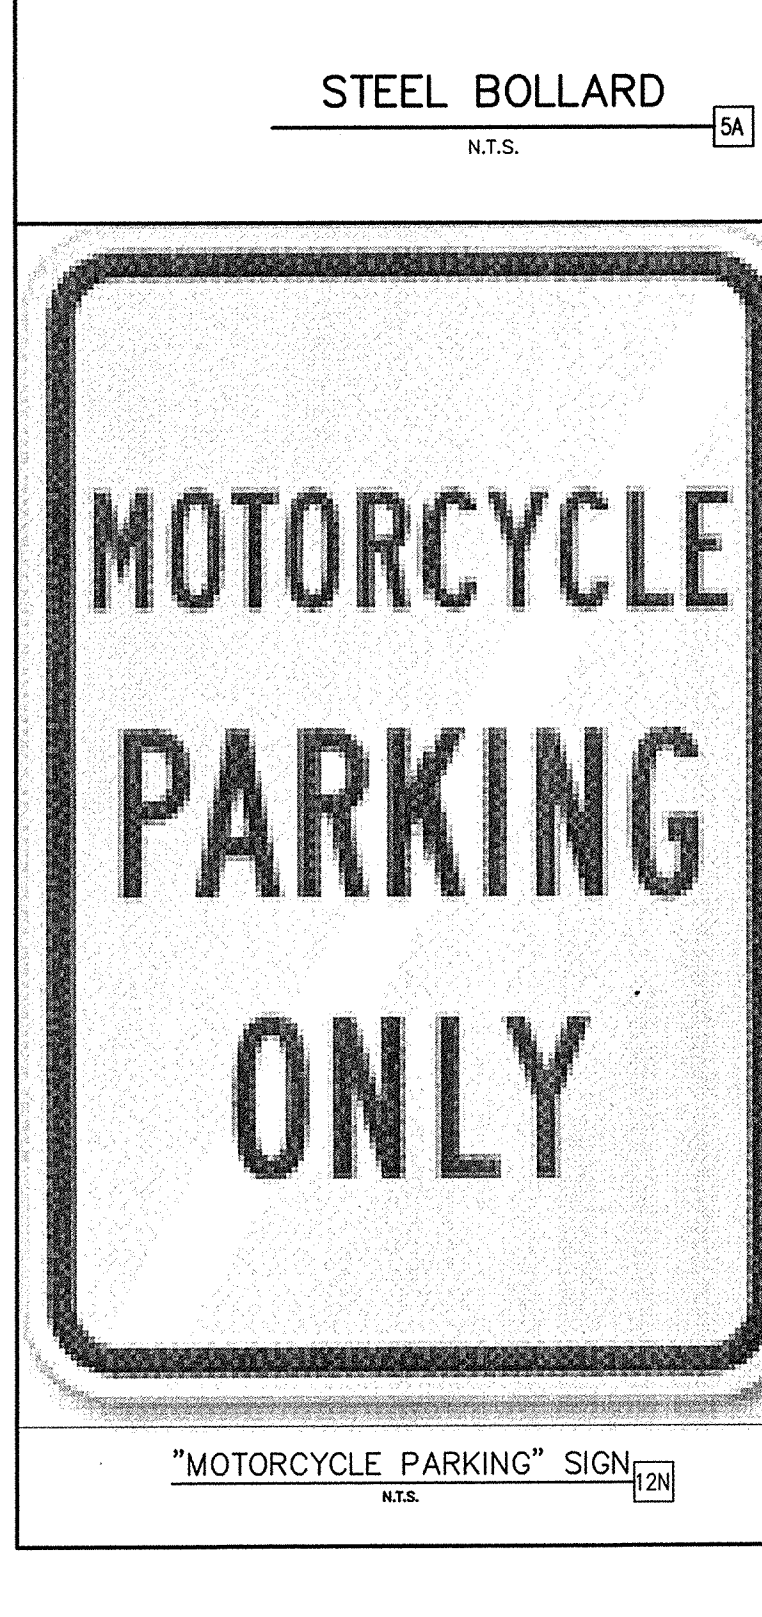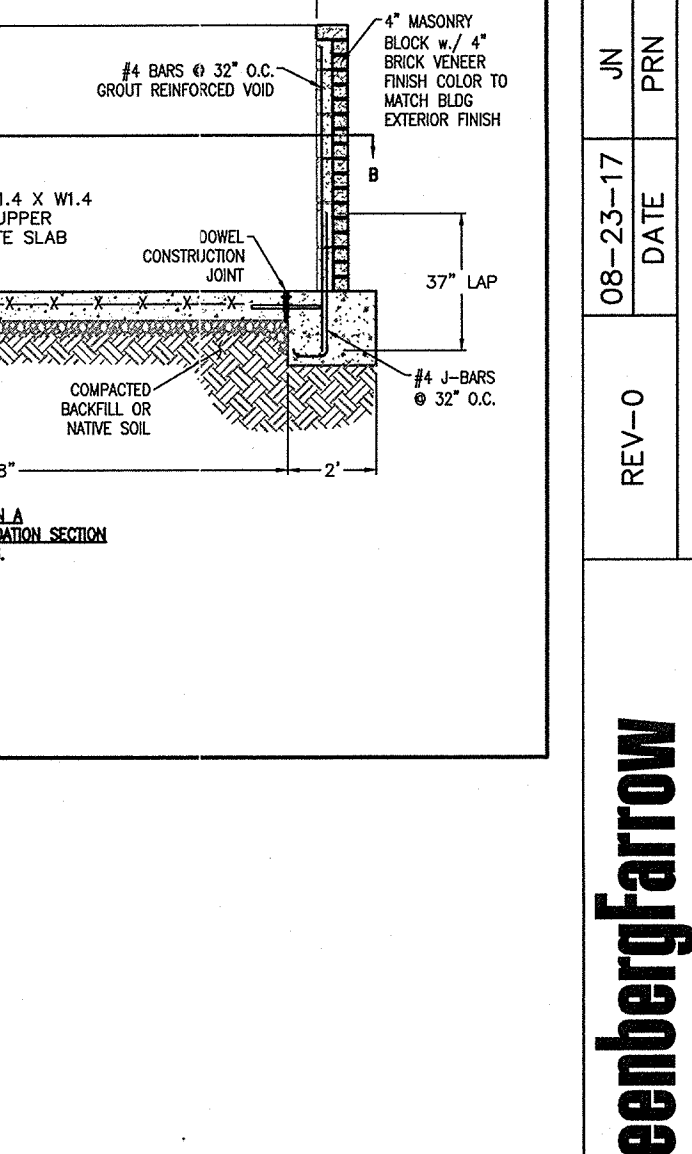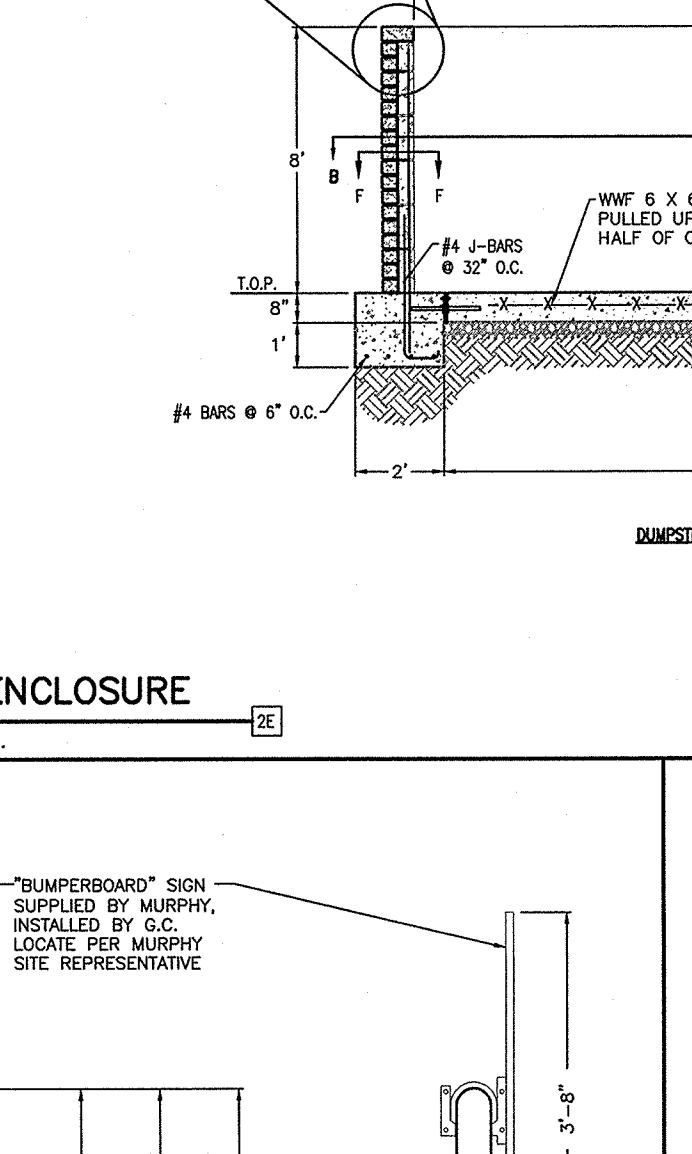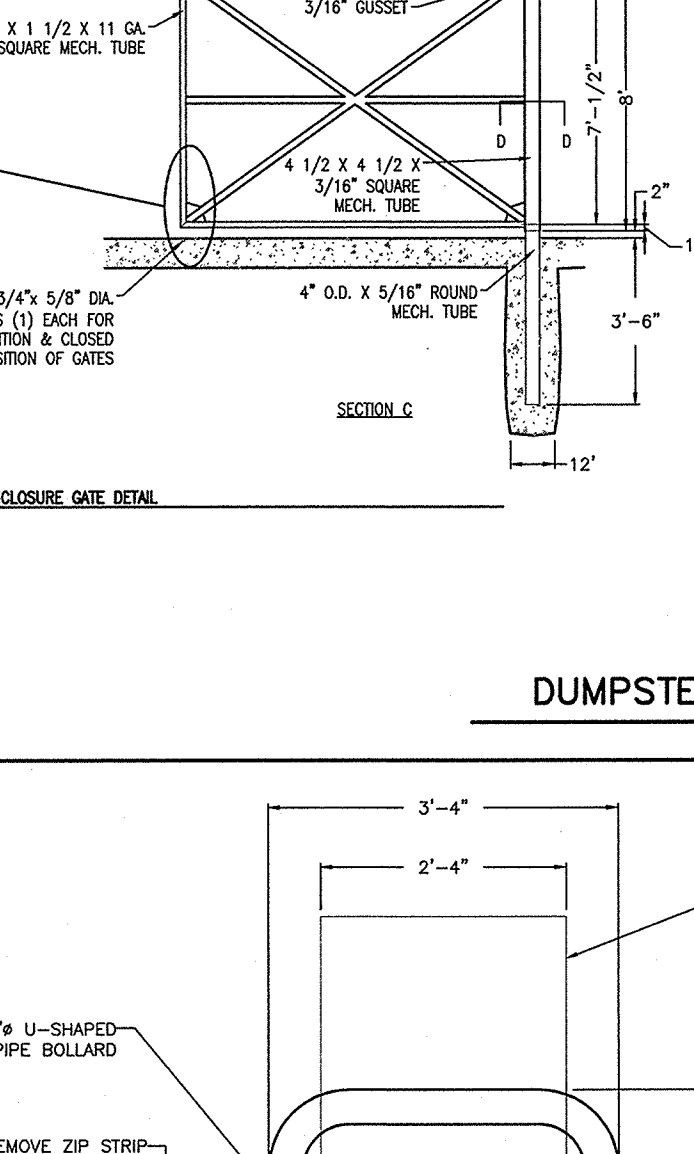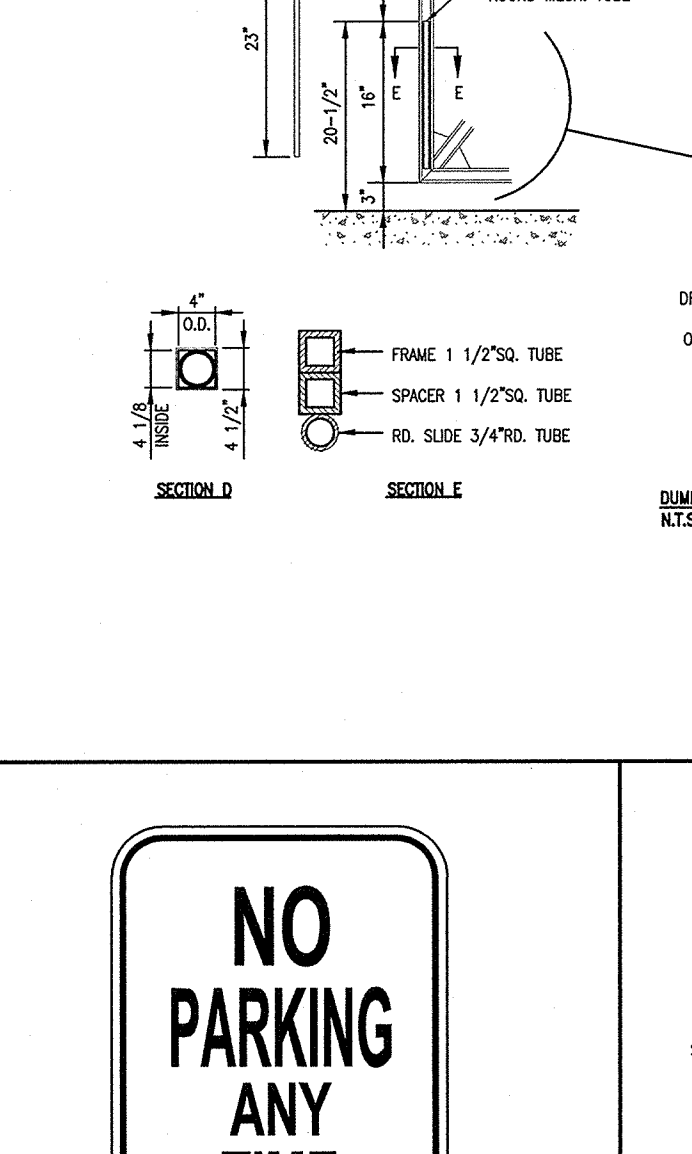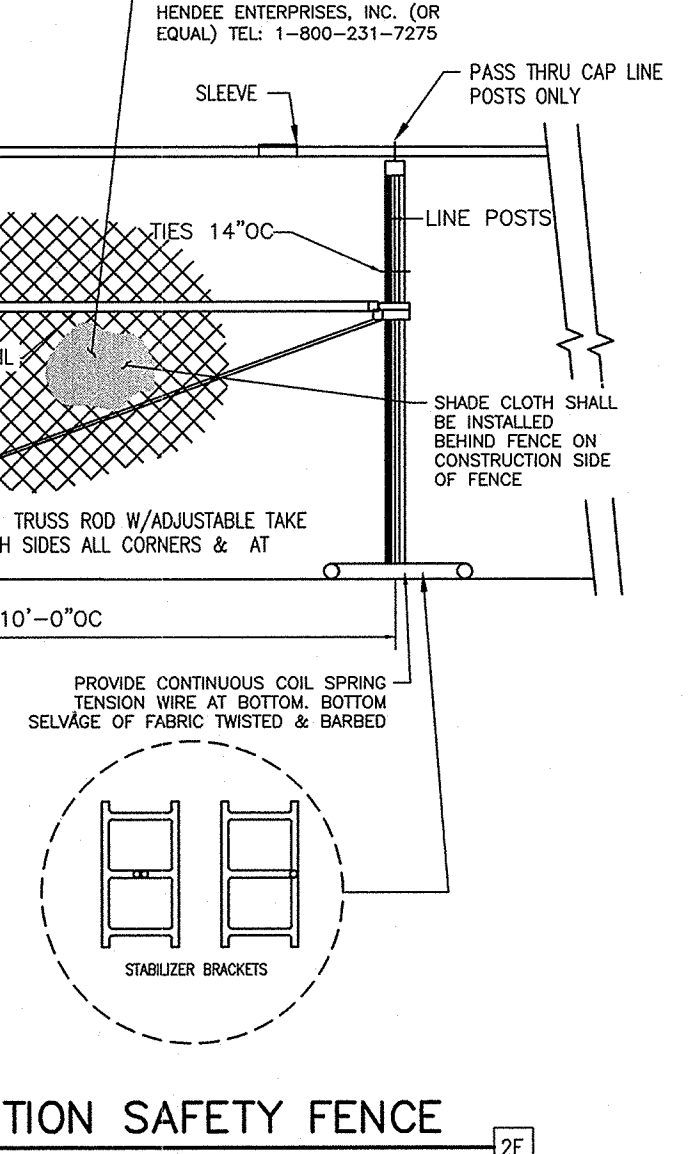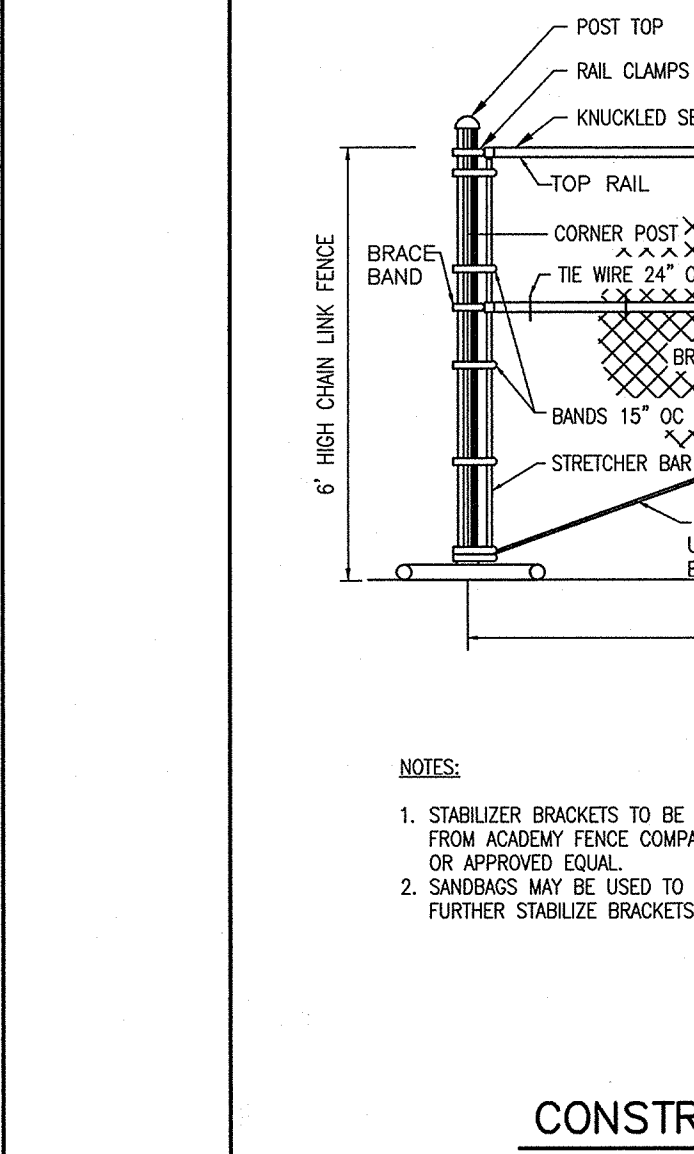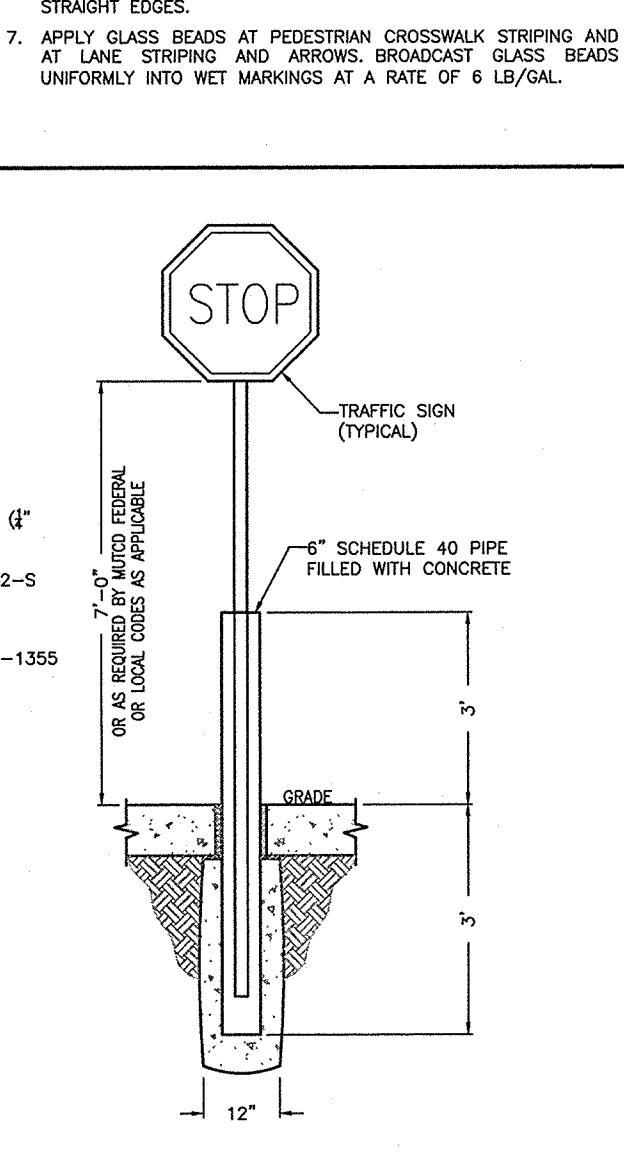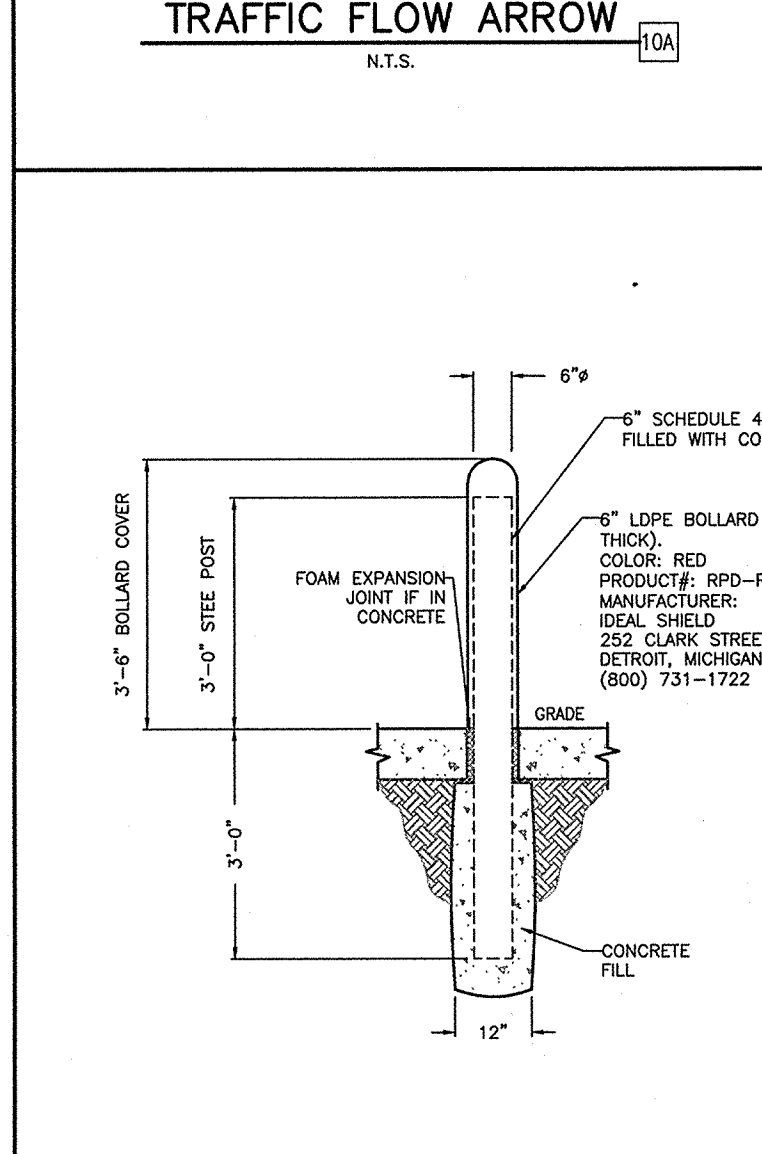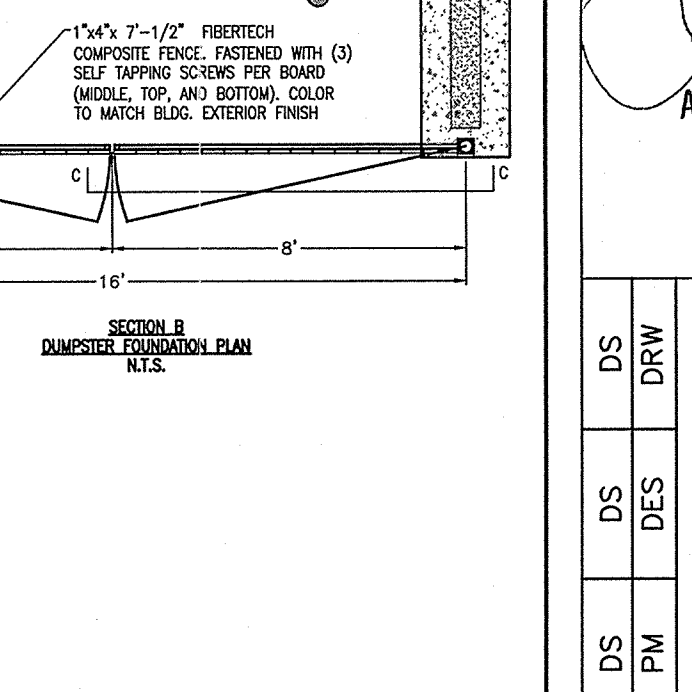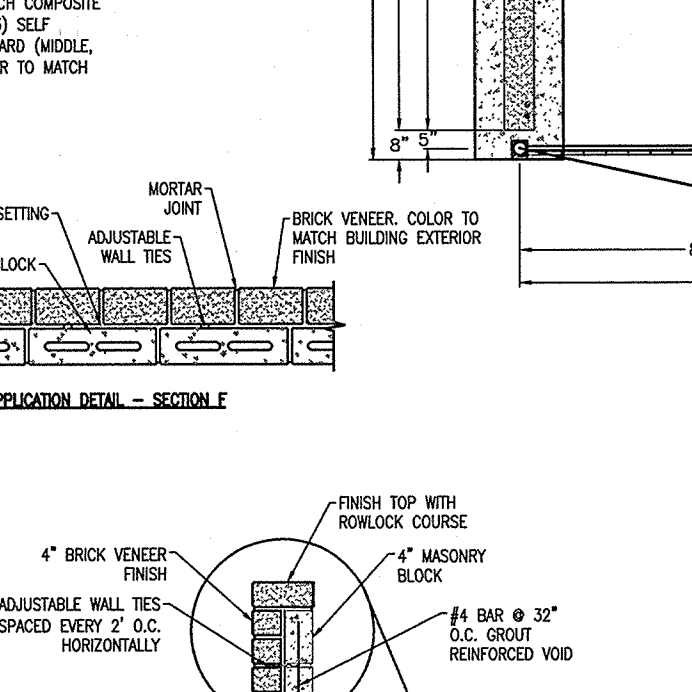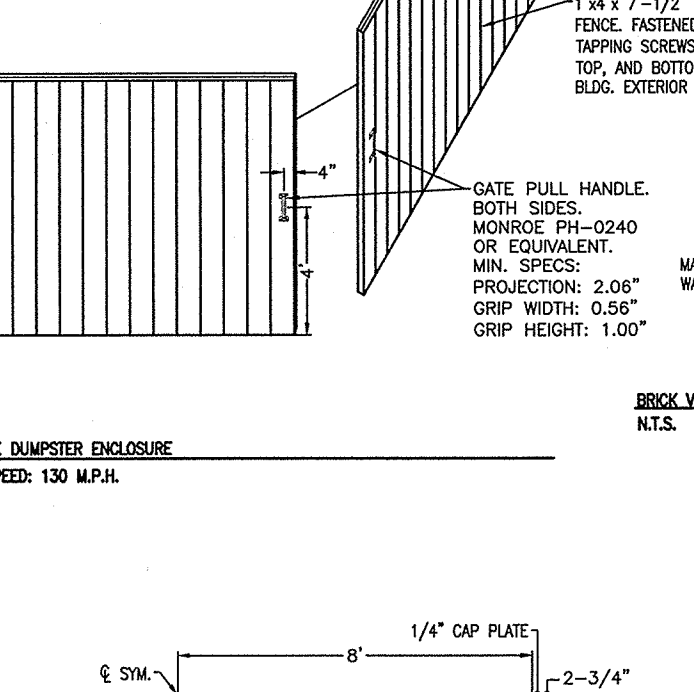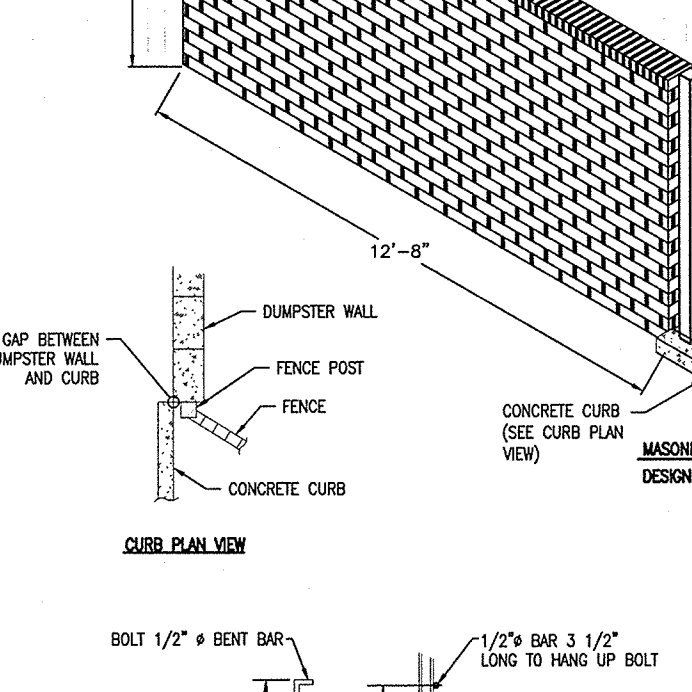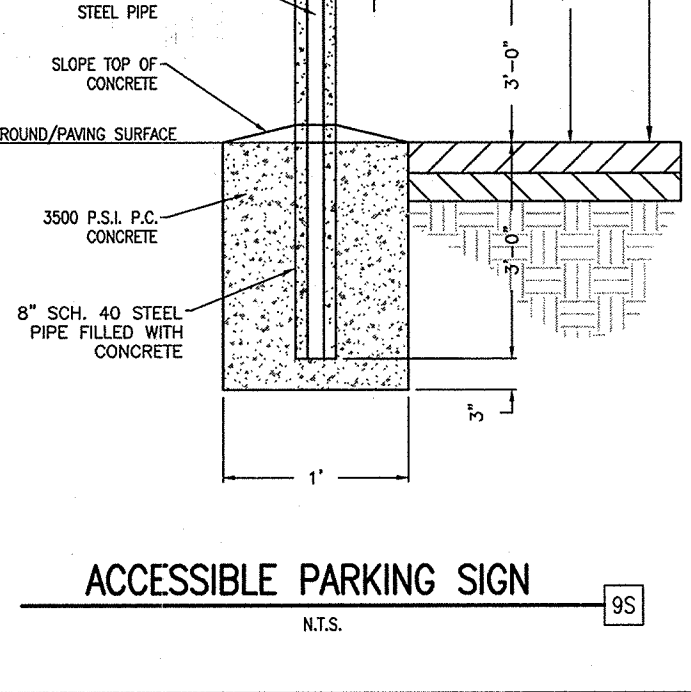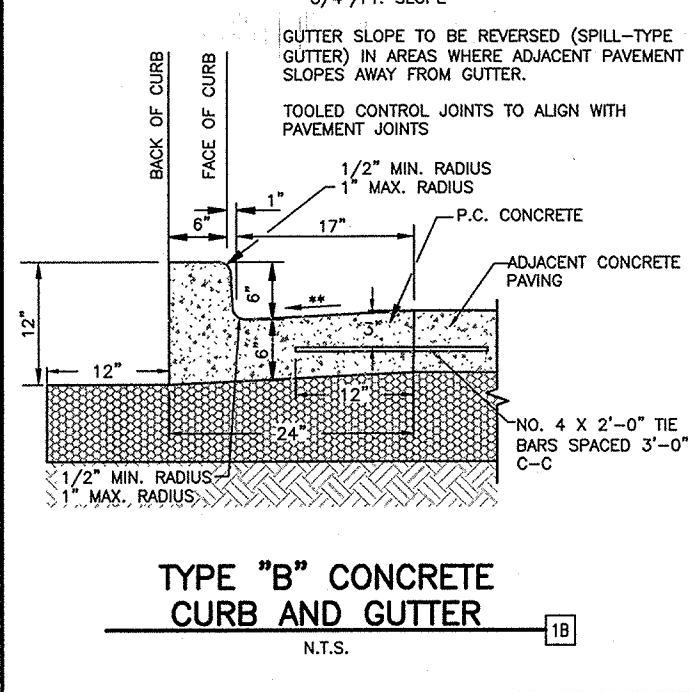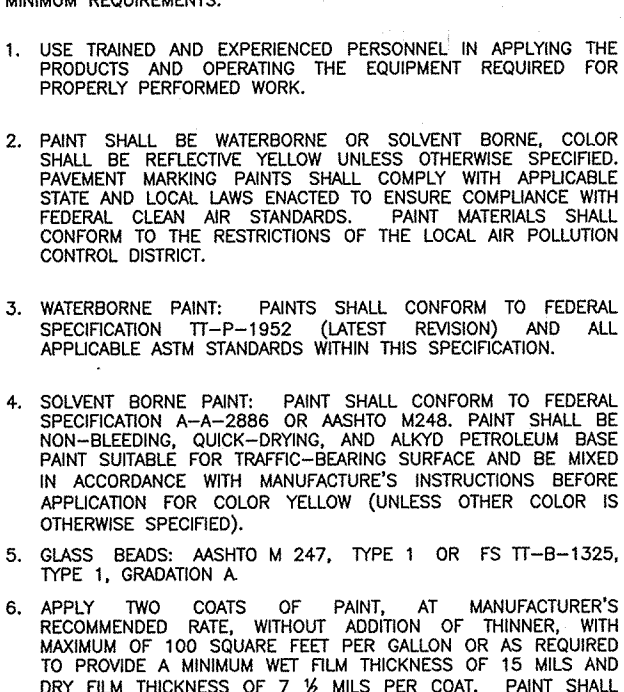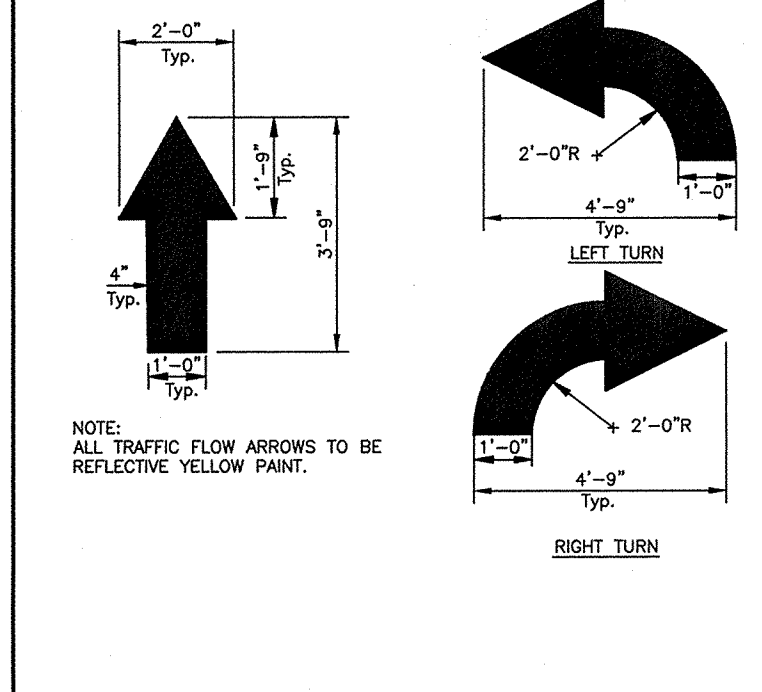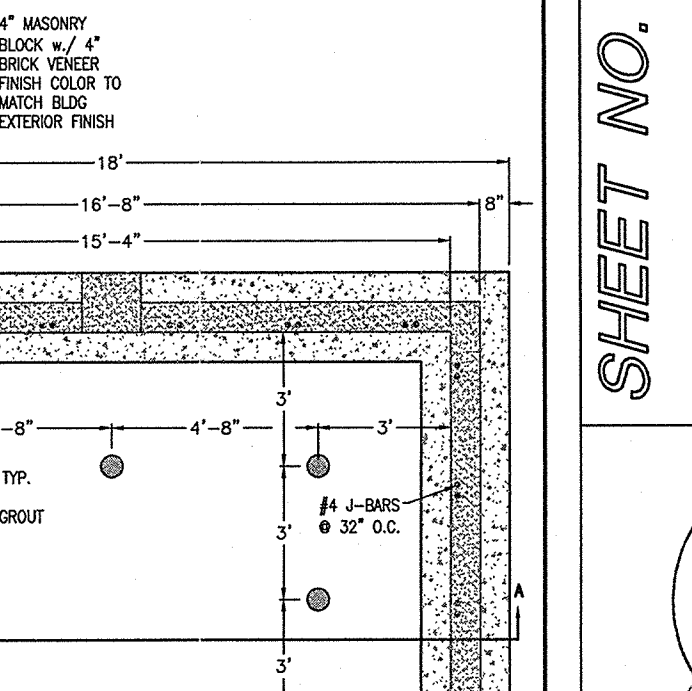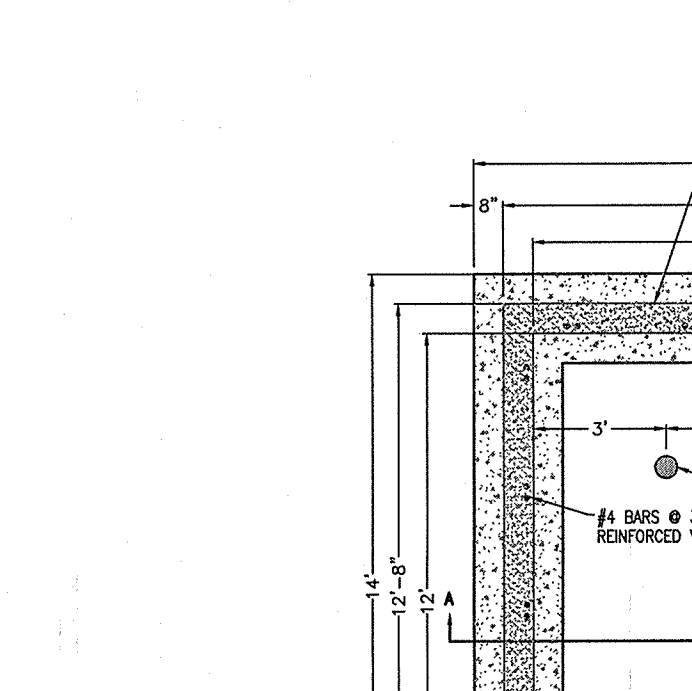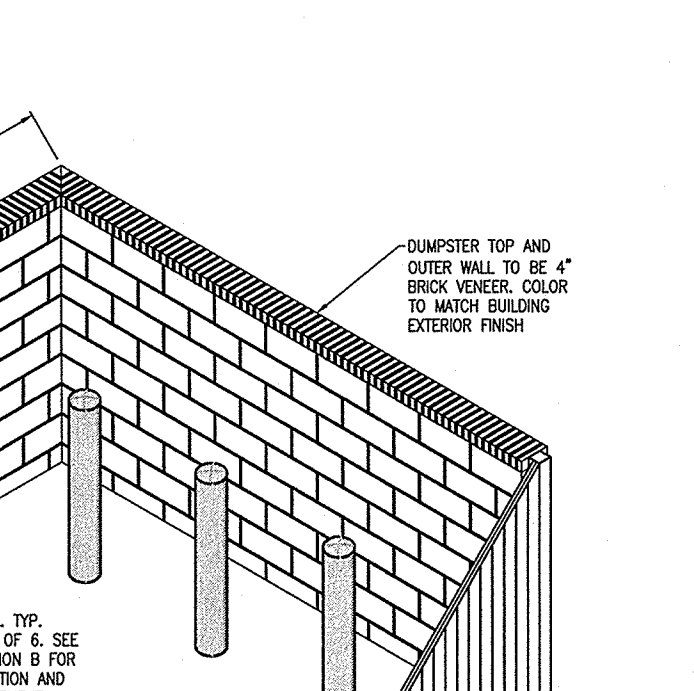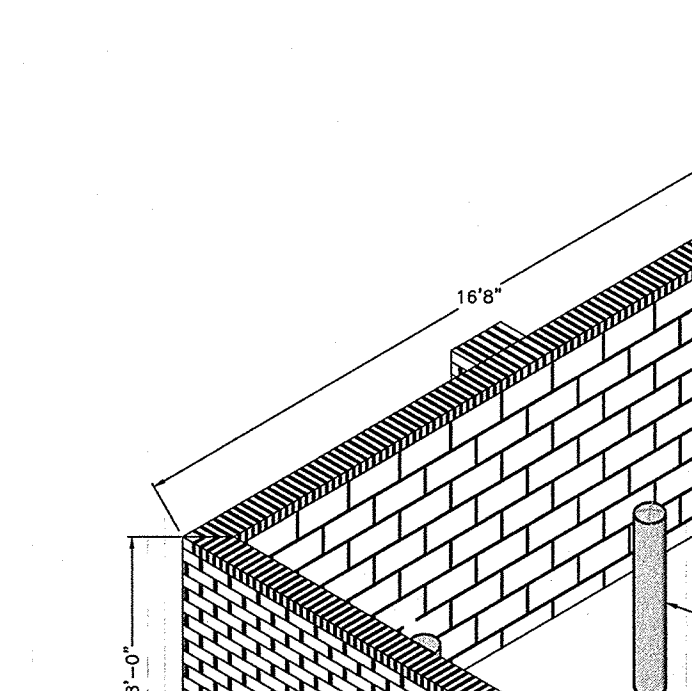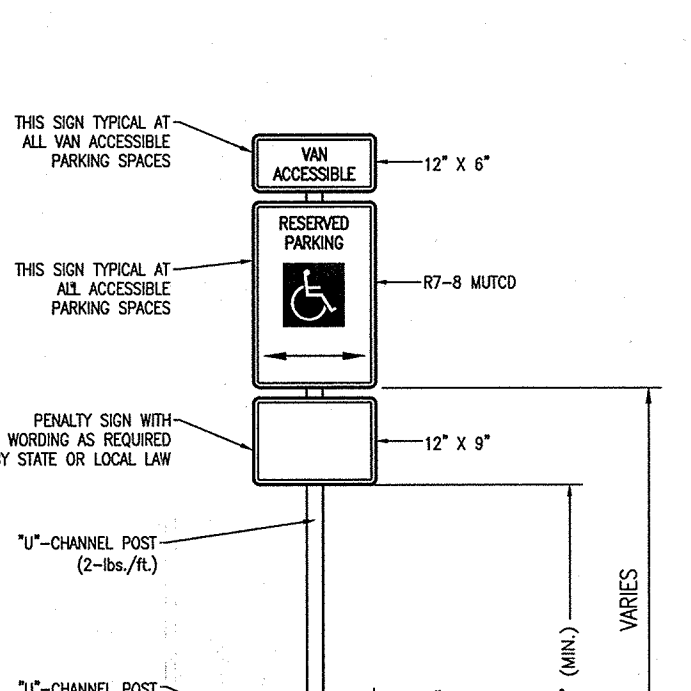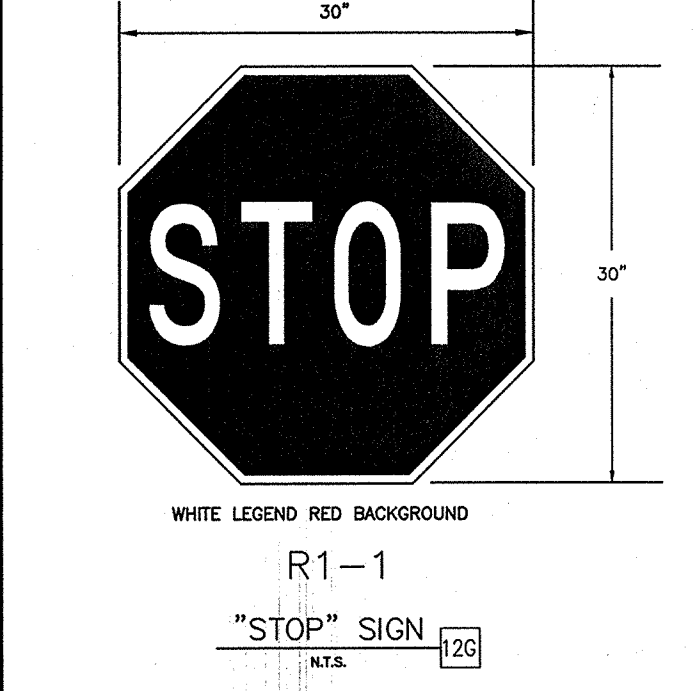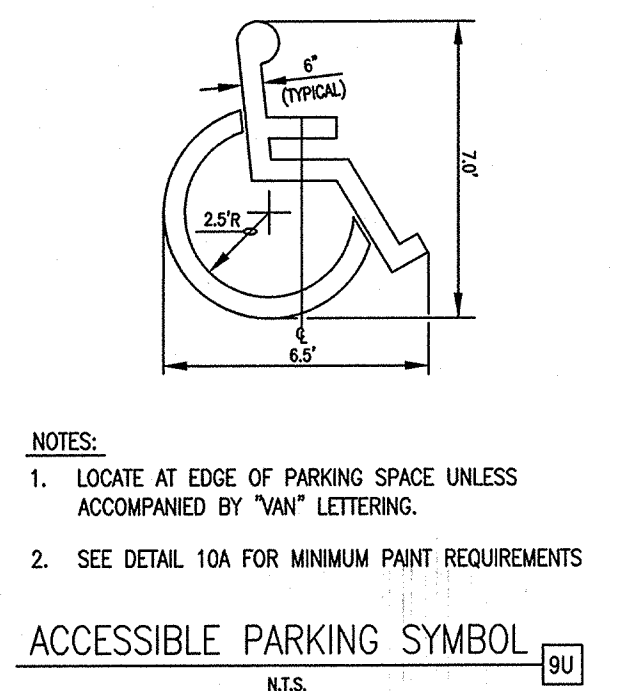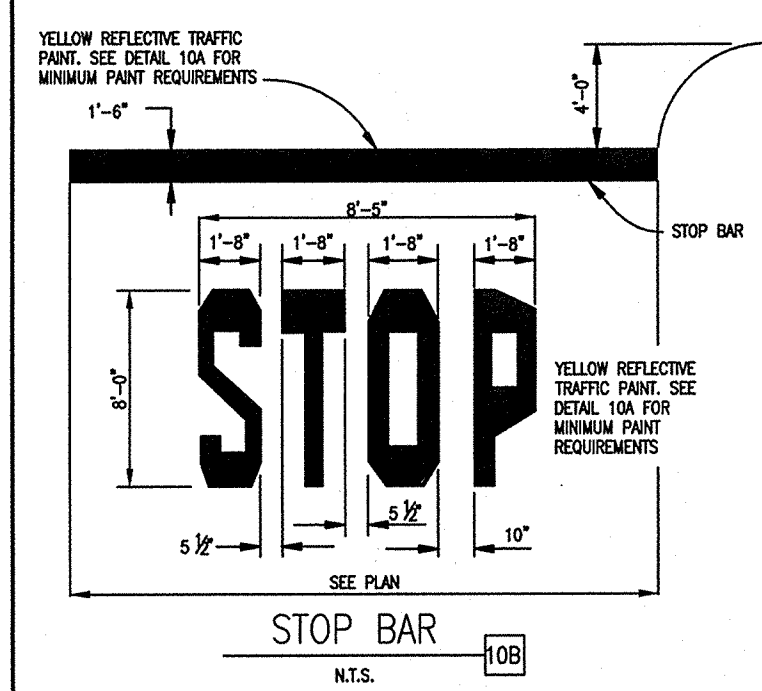

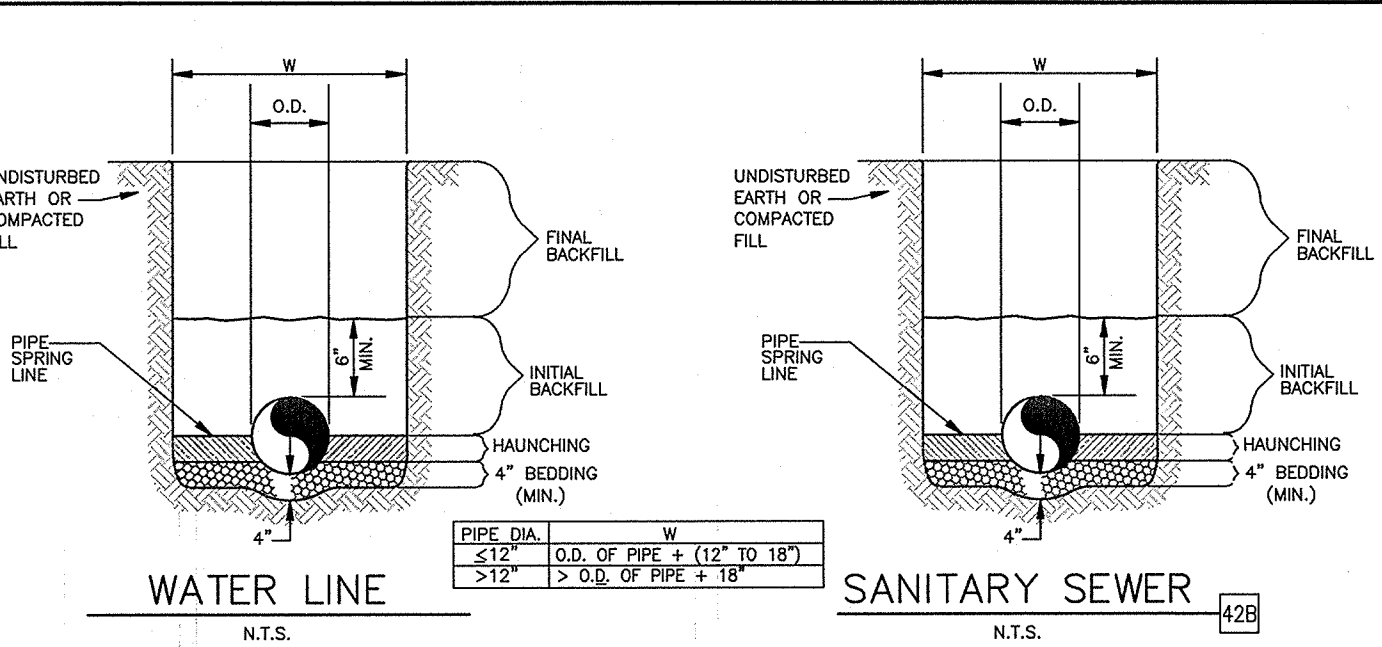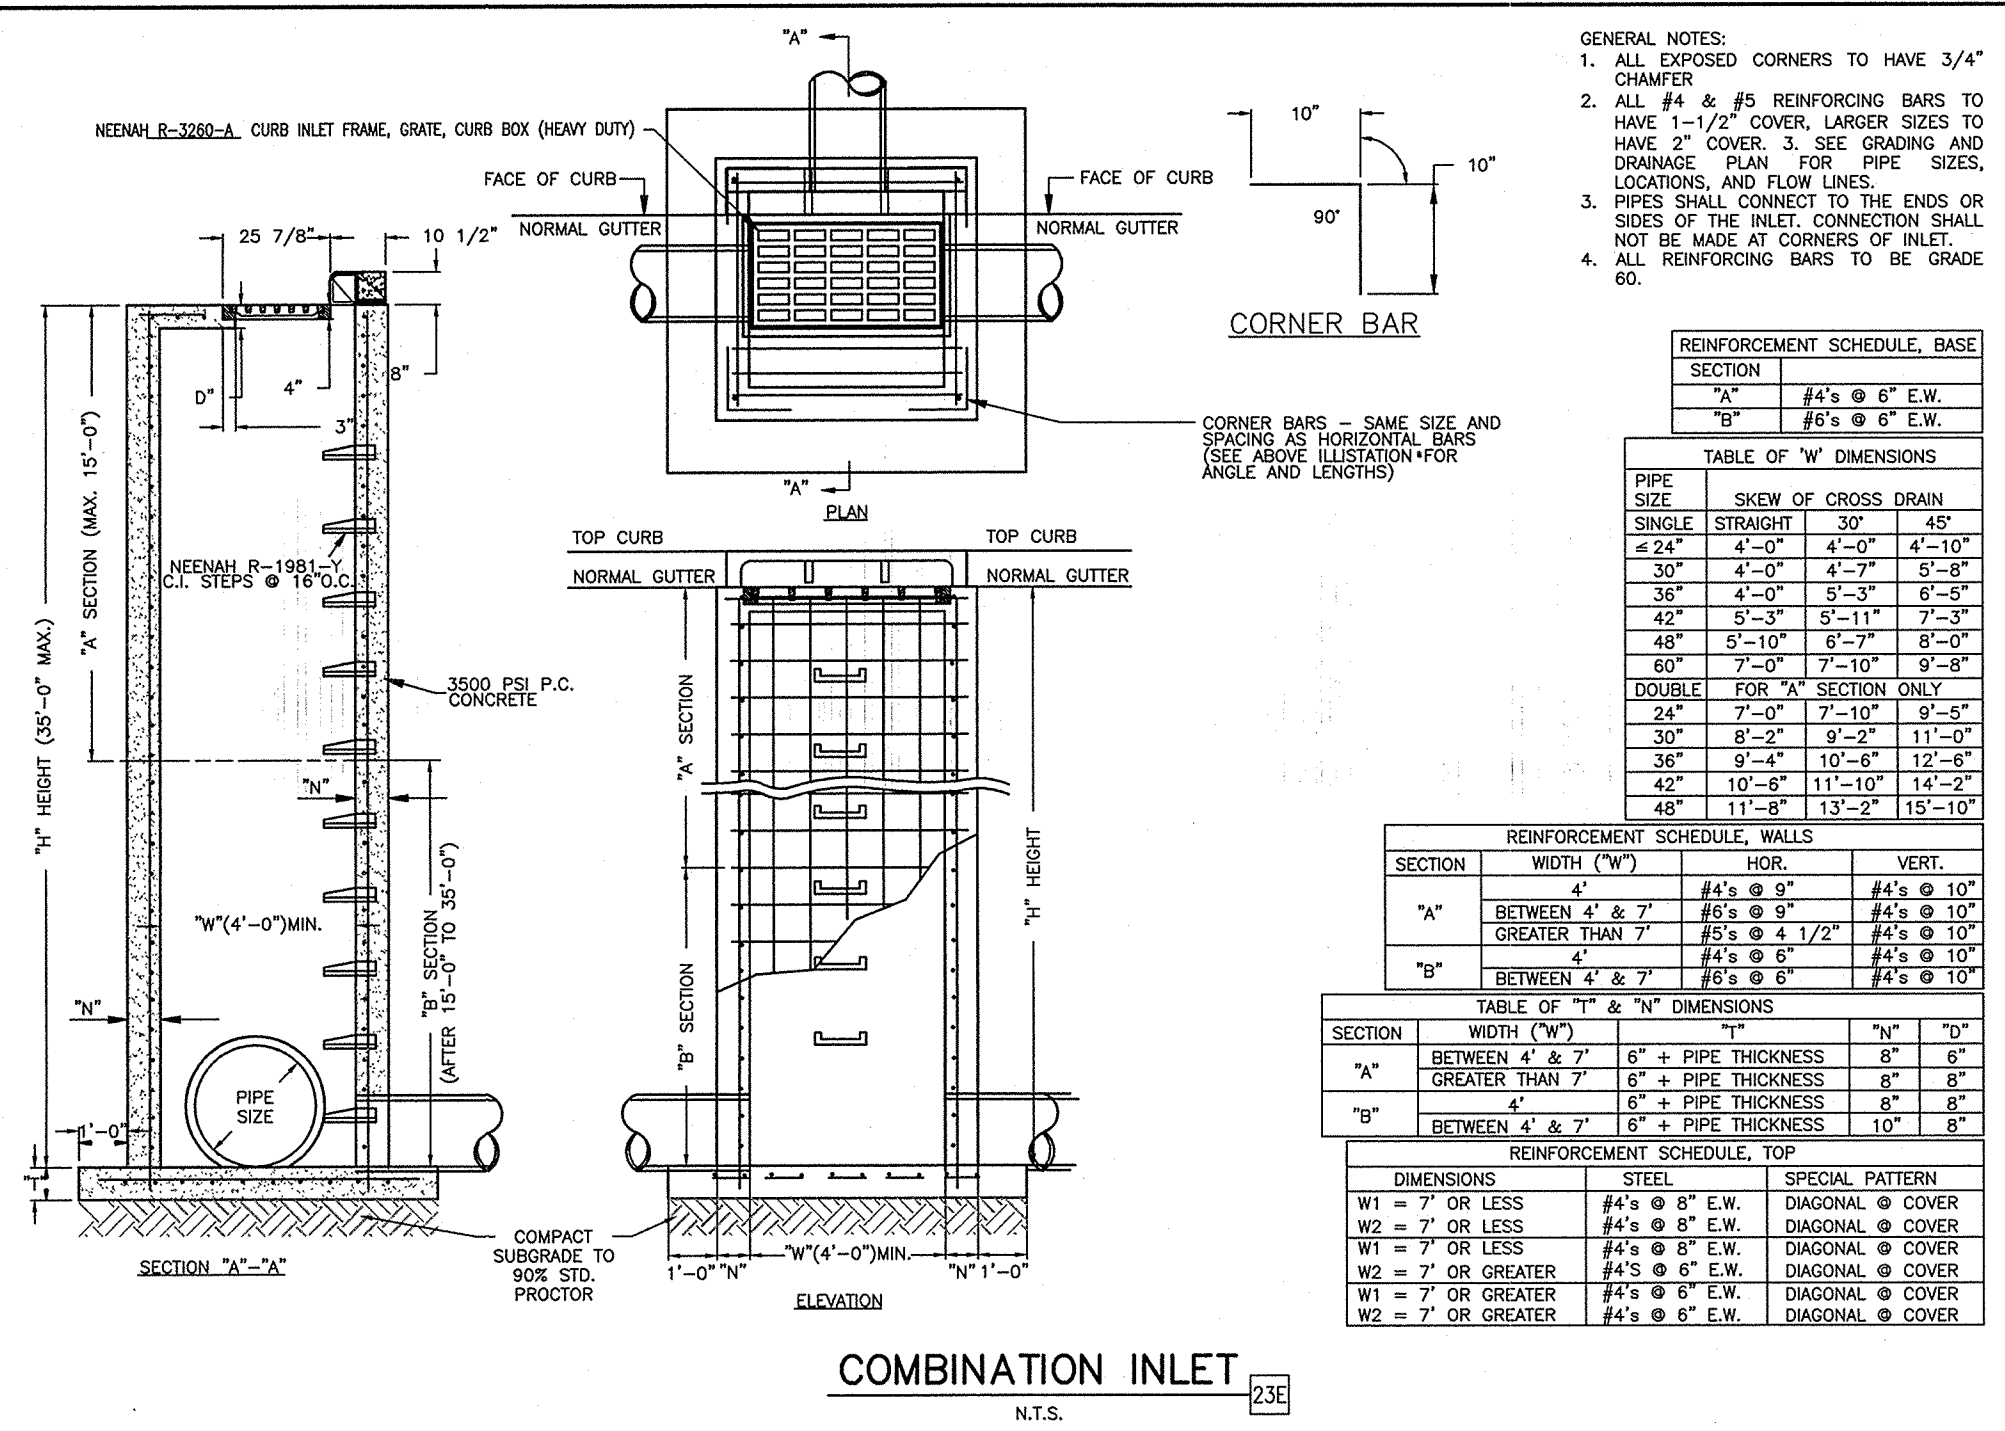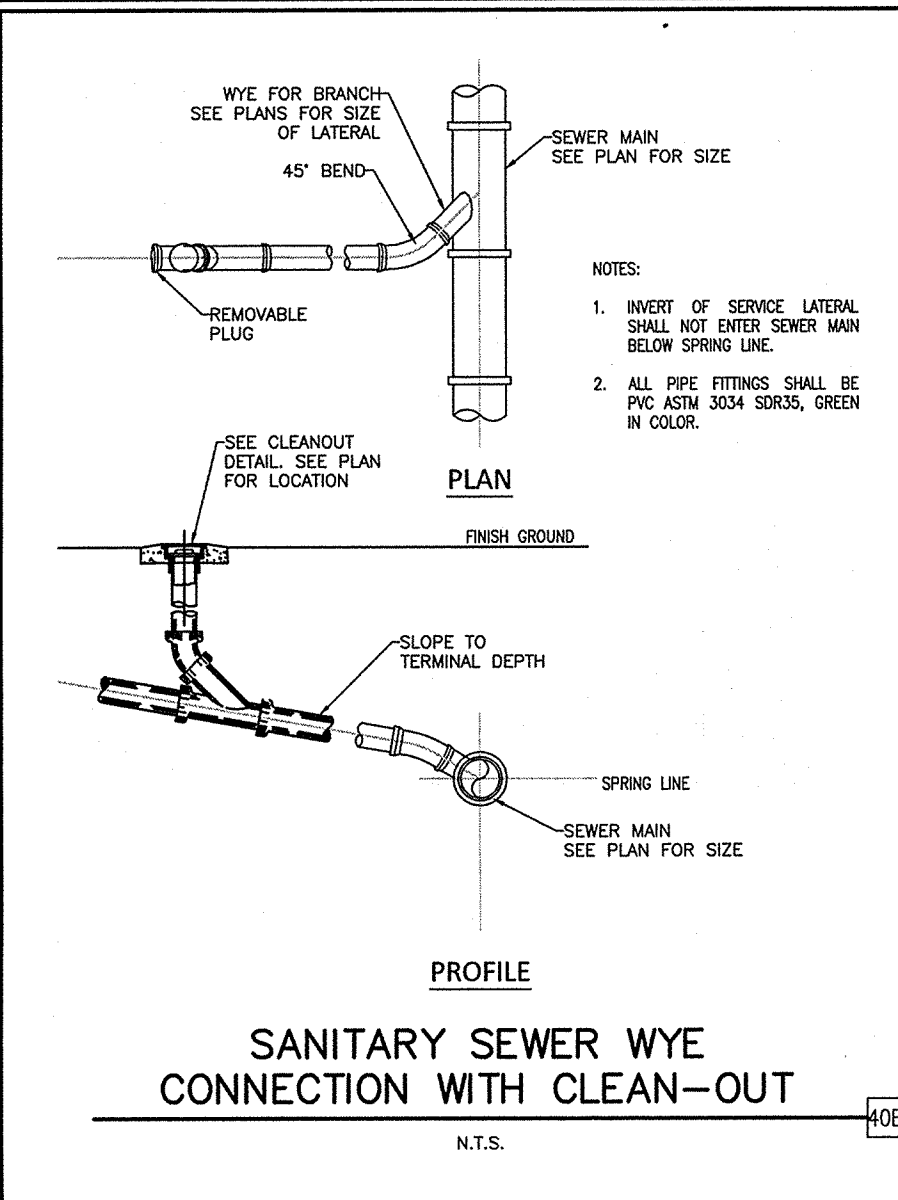

GENERAL NOTES

- ALL MATERIALS ARE CLASSIFIED IN ACCORDANCE WITH ASTM D 2321 LATEST EDITION.
- BEDDING SHALL BE CLASS I-A WORKED BY HAND, IF GROUNDWATER IS ANTICIPATED, THEN BEDDING SHALL BE CLASS I-B OR CLASS II COMPACTED TO 95% STANDARD PROCTOR.
- HAUNCHING SHALL BE WORKED AROUND THE PIPE BY HAND TO ELIMINATE VOIDS AND SHALL BE CLASS I-A OR CLASS I-B OR CLASS II COMPACTED TO 95% STANDARD PROCTOR.
- INITIAL BACKFILL SHALL BE CLASS I-A WORKED BY HAND, OR CLASS I-B OR CLASS II COMPACTED TO 95% STANDARD PROCTOR.
- INITIAL BACKFILL NOT UNDER PAVED AREAS CAN BE CLASS II COMPACTED TO 90% STANDARD PROCTOR.
- FINAL BACKFILL SHALL BE CLASS I, II, OR III COMPACTED AS NOTED IN NOTES 3, AND 4.
- FINAL BACKFILL NOT UNDER PAVED AREAS CAN BE CLASS IV-A COMPACTED TO 90% STANDARD PROCTOR.
- ALL MATERIALS SHALL BE INSTALLED IN MAXIMUM 8" LOOSE LIFTS IN ACCORDANCE WITH ASTM D 698. CLASS II AND IV-A MATERIALS SHALL BE COMPACTED NEAR OPTIMUM MOISTURE CONTENT.
- FILL SALVAGED FROM EXCAVATION SHALL BE FREE OF DEBRIS, ORGANICS AND ROCKS LARGER THAN 2".
- ALL TRENCH EXCAVATIONS SHALL BE SLOPED, SHORED, SHEETED, BRACED, OR OTHERWISE SUPPORTED IN COMPLIANCE WITH OSHA REGULATIONS AND LOCAL ORDINANCES. (SEE SPECIFICATIONS)

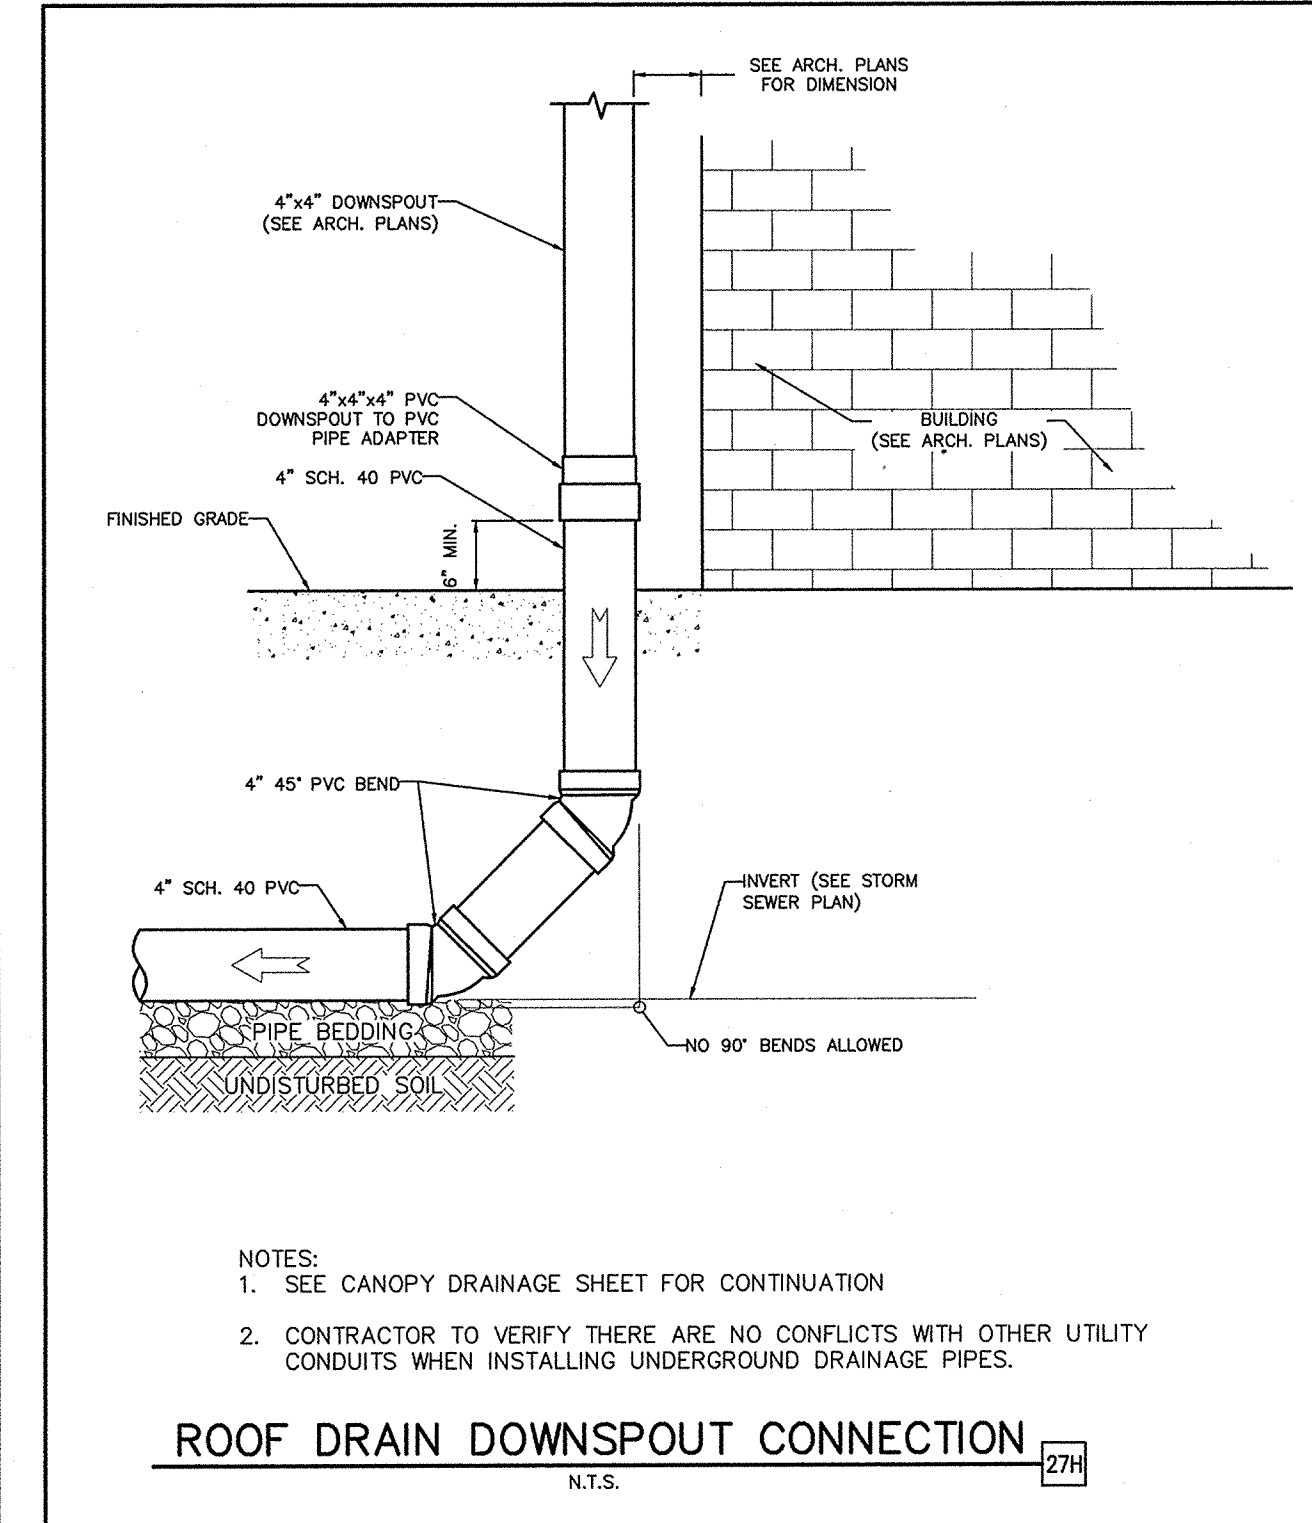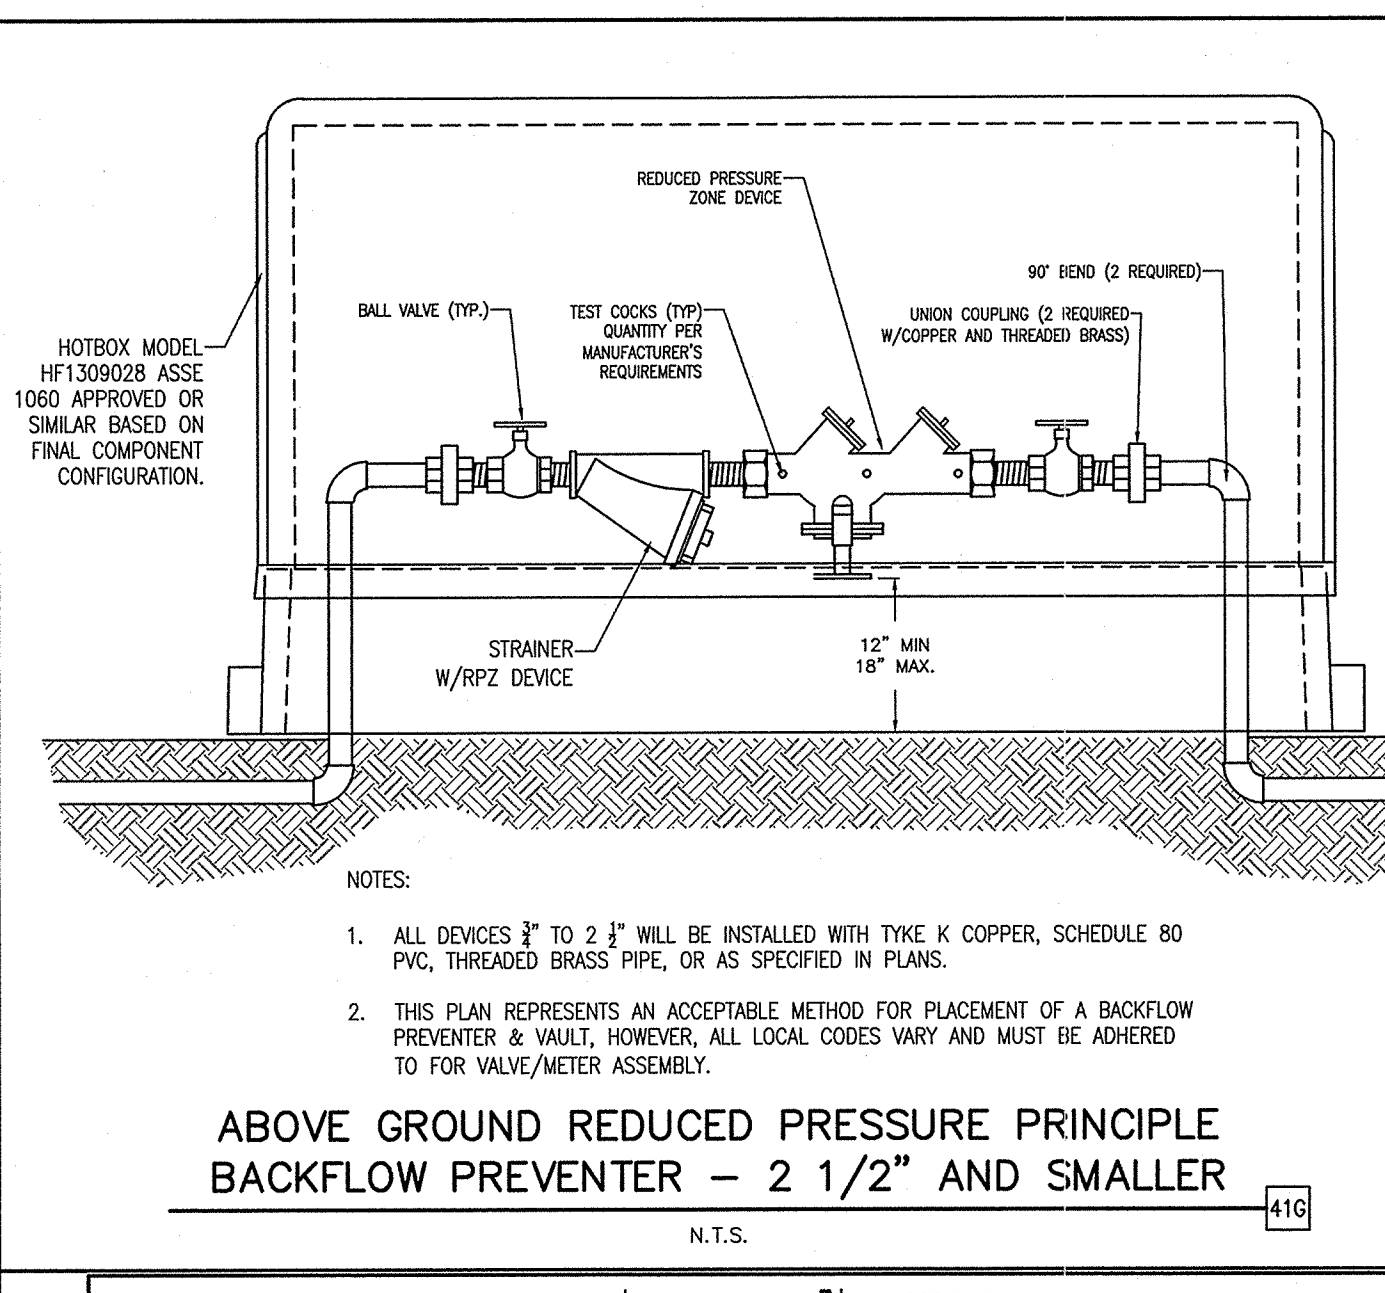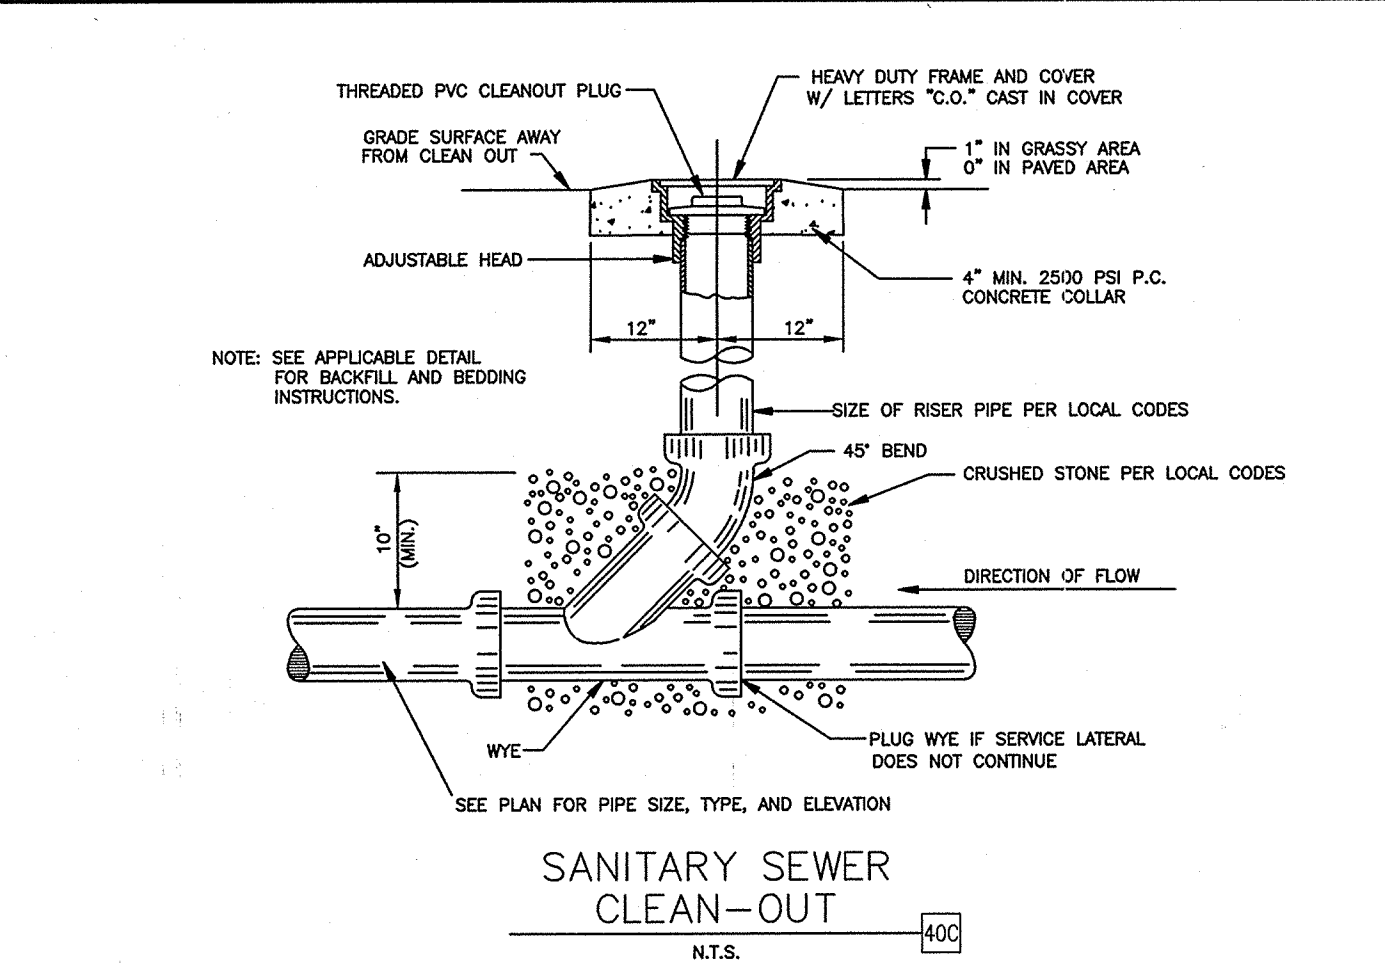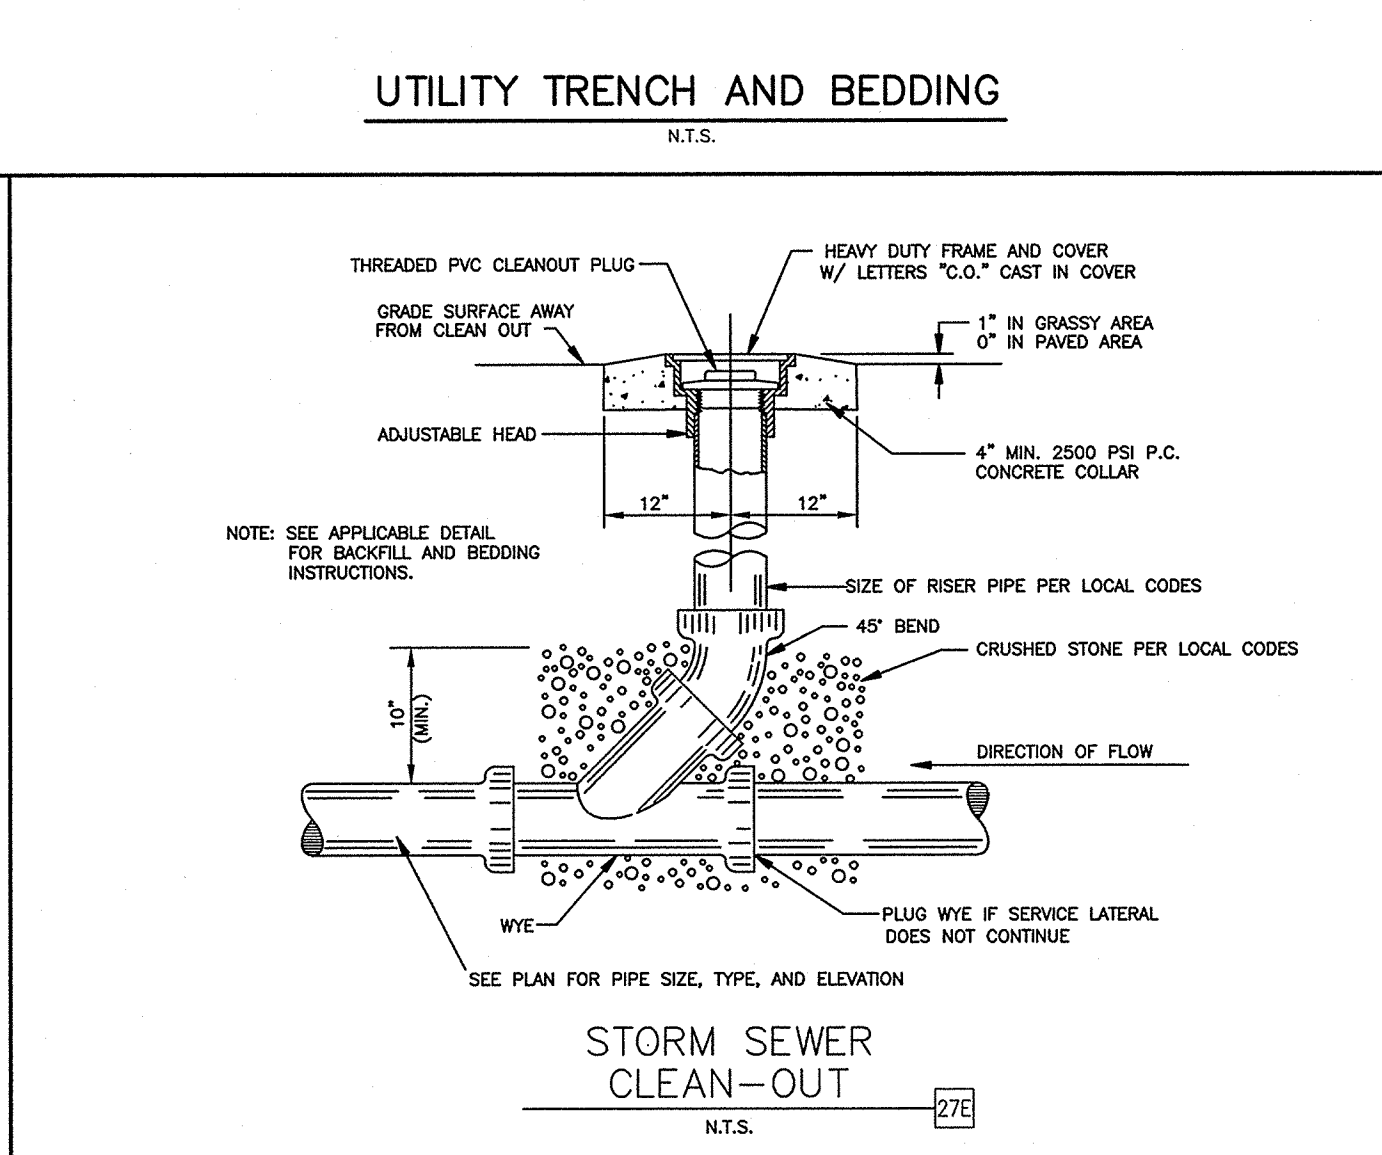

RECOMMENDED MINIMUM TRENCH WIDTHS

PIPE DIA. MIN.	TRENCH WIDTH
4"	21"
6"	23"
8"	26"
10"	28"
12"	30"
15"	34"
18"	39"
24"	48"
30"	56"
36"	64"
42"	72"
48"	80"
60"	96"

MINIMUM RECOMMENDED COVER BASED ON VEHICLE LOADING CONDITIONS*

PIPE DIA.	H-25	HEAVY CONSTRUCTION (751 AXLE LOADS)
12" - 48" (300mm - 1200mm)	12"	48"
60" (1500mm)	24"	60"

MAXIMUM RECOMMENDED COVER BASED ON VEHICLE LOADING CONDITIONS


PIPE DIA.	CLASS I		CLASS II		CLASS III	
	COMPACTED	DUMPED	95%	90%	95%	90%
4" (100mm)	34	16	23	16	17	
6" (150mm)	40	19	27	19	20	
8" (200mm)	30	14	21	14	15	
10" (250mm)	34	16	23	16	17	
12" (300mm)	35	17	24	17	18	
15" (375mm)	37	18	25	18	19	
18" (450mm)	32	15	22	15	16	
24" (600mm)	27	13	19	13	14	
30" (750mm)	22	11	16	11	11	
36" (900mm)	26	12	18	12	13	
42" (1050mm)	24	11	17	11	12	
48" (1200mm)	23	11	16	11	12	
60" (1500mm)	26	12	18	12	13	

NOTES:

- ALL PIPE SYSTEMS SHALL BE INSTALLED IN ACCORDANCE WITH ASTM D2321, "STANDARD PRACTICE FOR UNDERGROUND INSTALLATION OF THERMOPLASTIC PIPE FOR SEWERS AND OTHER GRAVITY FLOW APPLICATIONS", LATEST EDITION.
- MEASURES SHOULD BE TAKEN TO PREVENT MIGRATION OF NATIVE FINES INTO BACKFILL MATERIAL, WHEN REQUIRED.
- FOUNDATION: WHERE THE TRENCH BOTTOM IS UNSTABLE, THE CONTRACTOR SHALL EXCAVATE TO A DEPTH REQUIRED BY THE ENGINEER AND REPLACE WITH SUITABLE MATERIAL AS SPECIFIED BY THE ENGINEER. AS AN ALTERNATIVE AND AT THE DISCRETION OF THE DESIGN ENGINEER, THE TRENCH BOTTOM MAY BE STABILIZED USING A GEOTEXTILE MATERIAL.
- BEDDING: SUITABLE MATERIAL SHALL BE CLASS I, II OR III. THE CONTRACTOR SHALL PROVIDE DOCUMENTATION FOR MATERIAL SPECIFICATION TO ENGINEER. UNLESS OTHERWISE NOTED BY THE ENGINEER, MINIMUM BEDDING THICKNESS SHALL BE 4" (100mm) FOR 4" - 24" (100mm-600mm); 6" (150mm) FOR 30" - 60" (750mm-1500mm).
- INITIAL BACKFILL: SUITABLE MATERIAL SHALL BE CLASS I, II OR III IN THE PIPE ZONE EXTENDING NOT LESS THAN 6" ABOVE CROWN OF PIPE. THE CONTRACTOR SHALL PROVIDE DOCUMENTATION FOR MATERIAL SPECIFICATION TO ENGINEER. MATERIAL SHALL BE INSTALLED AS REQUIRED IN ASTM D2321, LATEST EDITION.
- MINIMUM COVER: MINIMUM COVER, H, IN NON-TRAFFIC APPLICATIONS (GRASS OR LANDSCAPE AREAS) IS 12" FROM THE TOP OF PIPE TO GROUND SURFACE. ADDITIONAL COVER MAY BE REQUIRED TO PREVENT FLATATION. FOR TRAFFIC APPLICATIONS, MINIMUM COVER, H, IS 12" UP TO 48" DIAMETER PIPE AND 24" OF COVER FOR 60" DIAMETER PIPE, MEASURED FROM TOP OF PIPE TO BOTTOM OF FLEXIBLE PAVEMENT OR TO TOP OF RIGID PAVEMENT. FOR TRAFFIC APPLICATIONS WITH LESS THAN FOUR FEET OF COVER, EMBEDEDMENT OF THE PIPE SHALL BE USING ONLY A CLASS I OR CLASS II BACKFILL.

ADVANCED DESIGN SYSTEMS, INC. (ADS) HAS PREPARED THIS DETAIL BASED ON INFORMATION PROVIDED TO ADS. THIS DRAWING IS INTENDED TO BE USED AS A GENERAL REFERENCE ONLY. ADS HAS NOT PERFORMED ANY DESIGN OR DESIGN SERVICES FOR THIS PROJECT. NOR HAS ADS INDEPENDENTLY VERIFIED THE INFORMATION SUPPLIED. THE INSTALLATION DETAILS PROVIDED HEREIN ARE GENERAL RECOMMENDATIONS AND ARE NOT SPECIFIC TO THE PROJECT. THE DESIGN ENGINEER SHALL REVIEW THESE DETAILS PRIOR TO CONSTRUCTION. IT IS THE DESIGN ENGINEER'S RESPONSIBILITY TO ENSURE THE DETAILS PROVIDED HEREIN MEET OR EXCEEDS THE APPLICABLE NATIONAL, STATE, OR LOCAL REQUIREMENTS AND TO ENSURE THE DETAILS PROVIDED HEREIN ARE ACCEPTABLE FOR THIS PROJECT.

HDPE PIPE BEDDING
N.T.S.

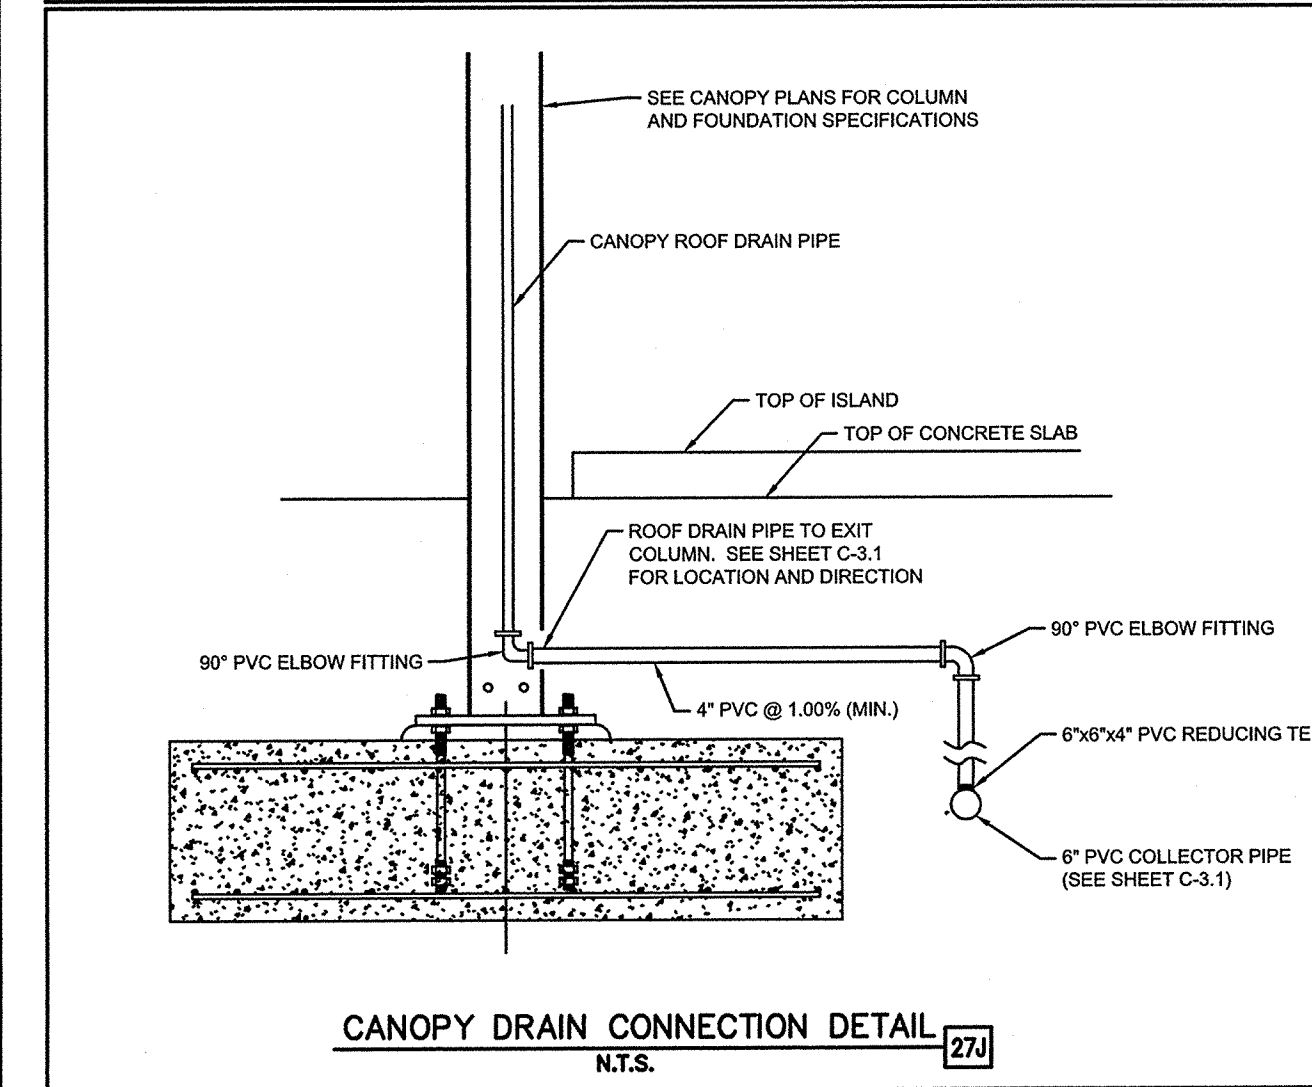

SDR 35 GASKETED BELL GRAVITY APPLICATIONS

- EQUIVALENT O BELL END ACCEPTS PIPE WITH SDR 35, ASTM D3034 OR EQUIVALENT O.D. SPECIFICATION IN 8", 10", 12", 15", 18", 21", 24", 27", AND 30" SIZES. (FOR 4" AND 6" SIZES REFER TO FATBOY SPECIFICATIONS).
- CURVATURE VARIES WITH MAINLINE DIAMETERS.
- SPIGOT END PVC SDR 35, ASTM D3034 DIAMETERS: 8", 10", 12", 15", 18", 21", 24", 27" AND 30"

PART **PART NAME**

1	HUB ADAPTOR
2	RUBBER GASKET
3	SECURING CLAMP*
4	RUBBER SLEEVE (AVAILABLE IN NITRILE AND EPDM BY SPECIAL ORDER)
4A	UPPER SEGMENT**
4B	LOWER SEGMENT**

INSERTA TEE SIZE **HOLE DIAMETER**


8" (200 mm)	8 3/4" (222mm)
10" (250 mm)	10 3/4" (278mm)
12" (300 mm)	12 3/4" (327mm)
15" (375 mm)	15 3/4" (400mm)
18" (450 mm)	18 3/4" (503mm)
21" (525 mm)	22 3/4" (573mm)
24" (600 mm)	25 3/4" (643mm)
27" (675 mm)	28 3/4" (724mm)
30" (750 mm)	32 3/4" (826mm)

MATERIALS
PVC SDR 35 ASTM D3034
ASTM F477
BAND SS #301
SCREW SS #305
HOUSING SS #301
ASTM F477

NOTE: RECOMMENDED METHOD OF CUTTING HOLE IS WITH HOLE SAW FOR PVC AND OTHER PLASTICS, AND DIAMOND BIT FOR CONCRETES, CLAY, FRP AND D.I. (SEE INSTALLATION INSTRUCTIONS). HOLE SAWS ARE AVAILABLE FOR PURCHASE OR RENT.

SDR 35 GASKETED BELL GRAVITY APPLICATION SPECIFICATIONS

SCALE: N.T.S.
DATE: 9/12/2013
DRAWN BY: KLJ

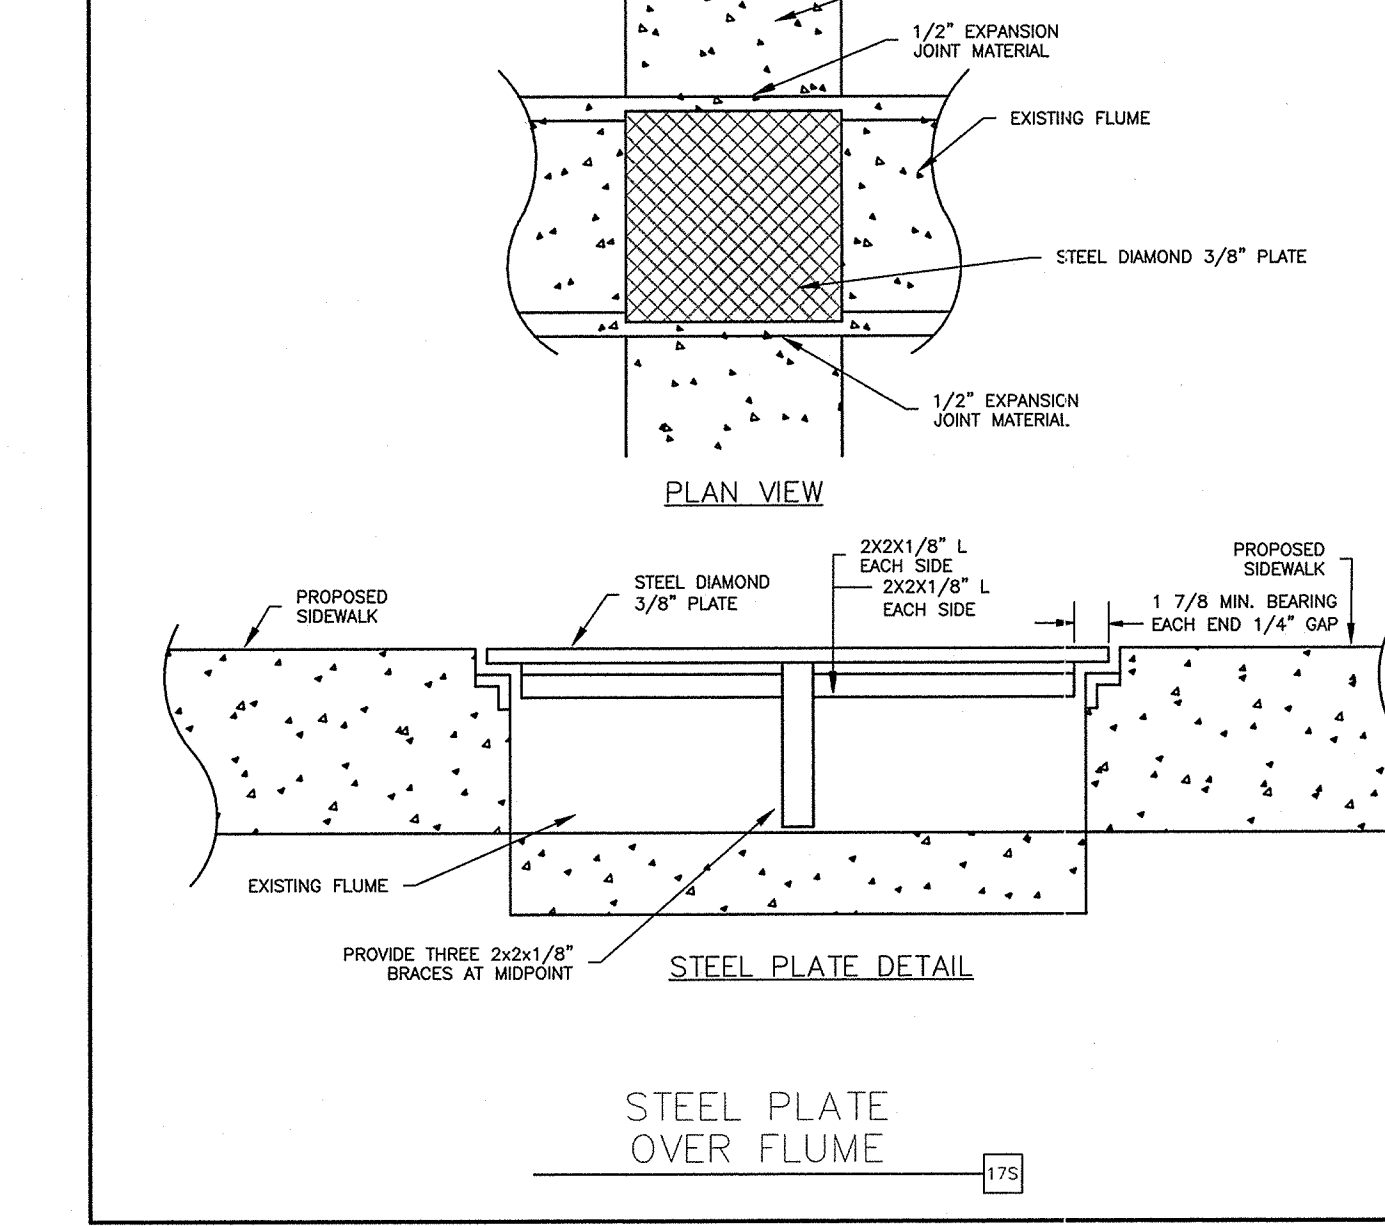

SHEET NO. C-13






JOHN H. MOURAD
NEW MEXICO
PROFESSIONAL ENGINEER
19062
AUG 23 2017


DETAILS
MURPHY EXPRESS
3761 HIGHWAY 528 NW
ALBUQUERQUE NEW MEXICO


GreenbergFarrow
1430 W. PEACHTREE ST. NW SUITE 200
ATLANTA, GA 30369
PHONE (404) 524-1000
FAX (404) 524-1001
DWG NAME: ALBUQUERQUE, NM
JOB NO.: 2016097.0

MURPHY OIL USA, INC.
200 PEACH STREET
EL DORADO, AR 71730


MURPHY USA

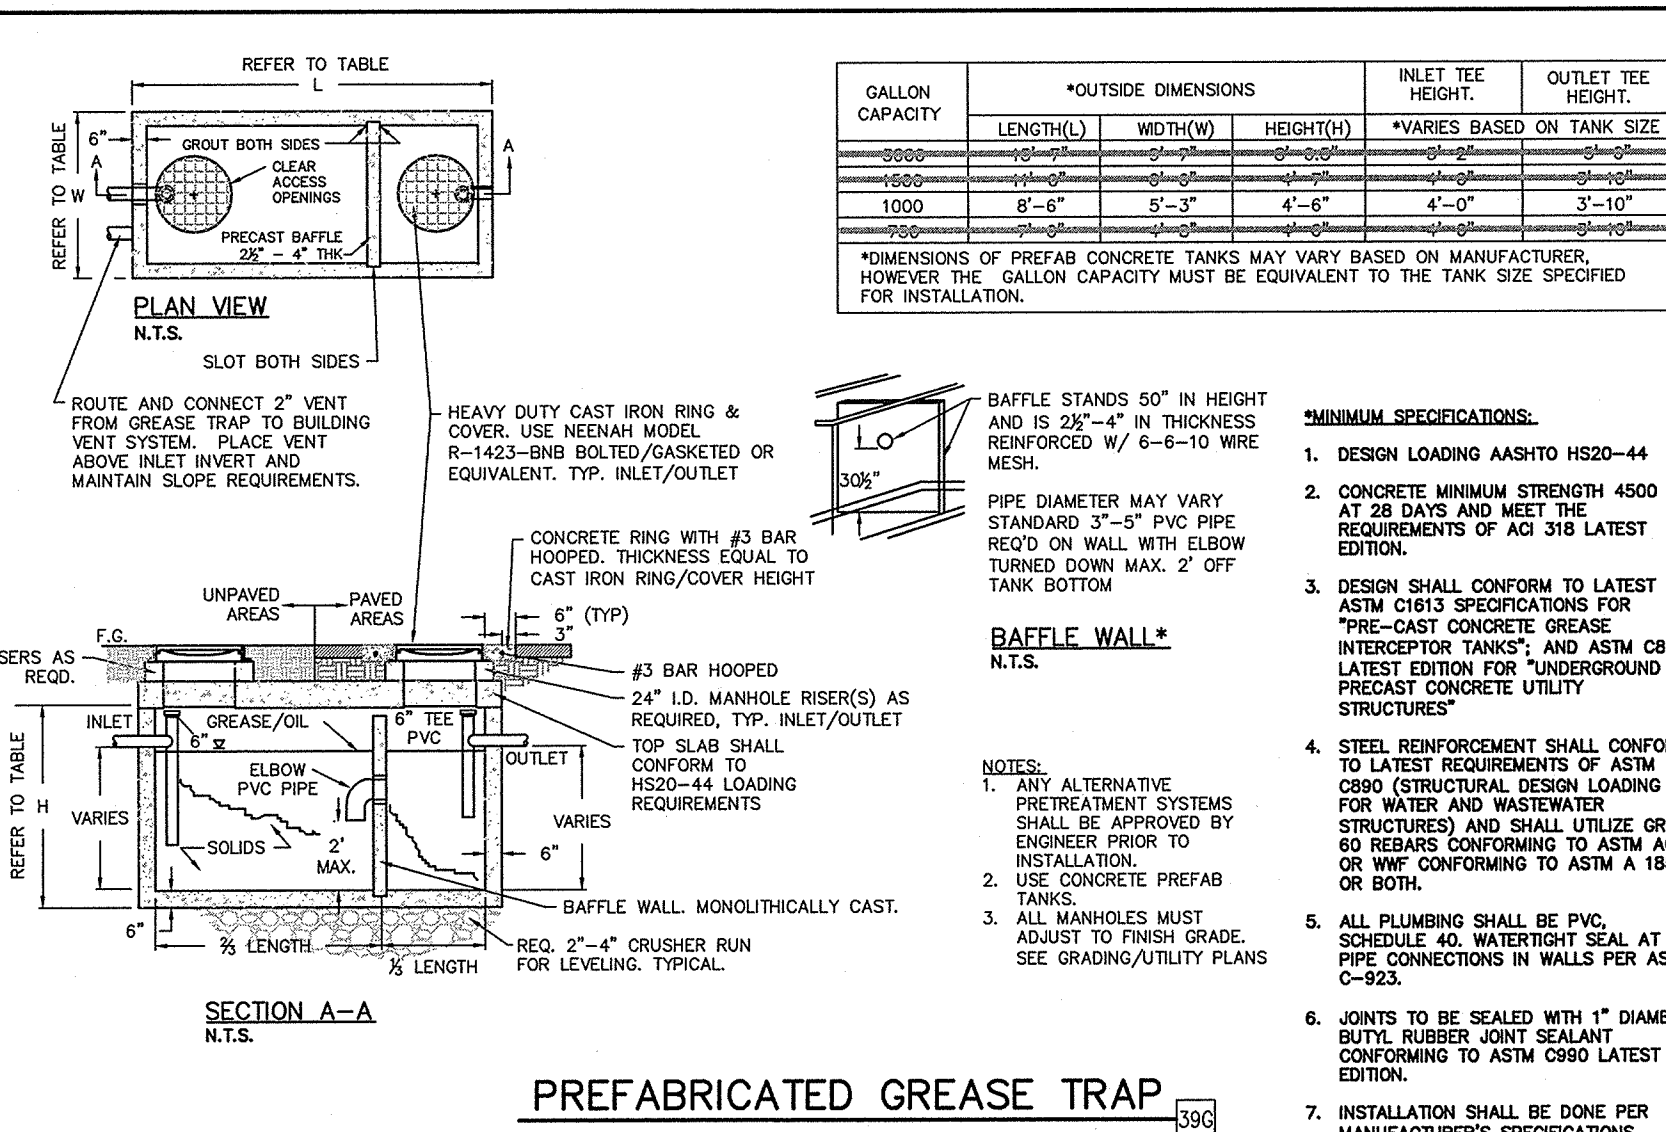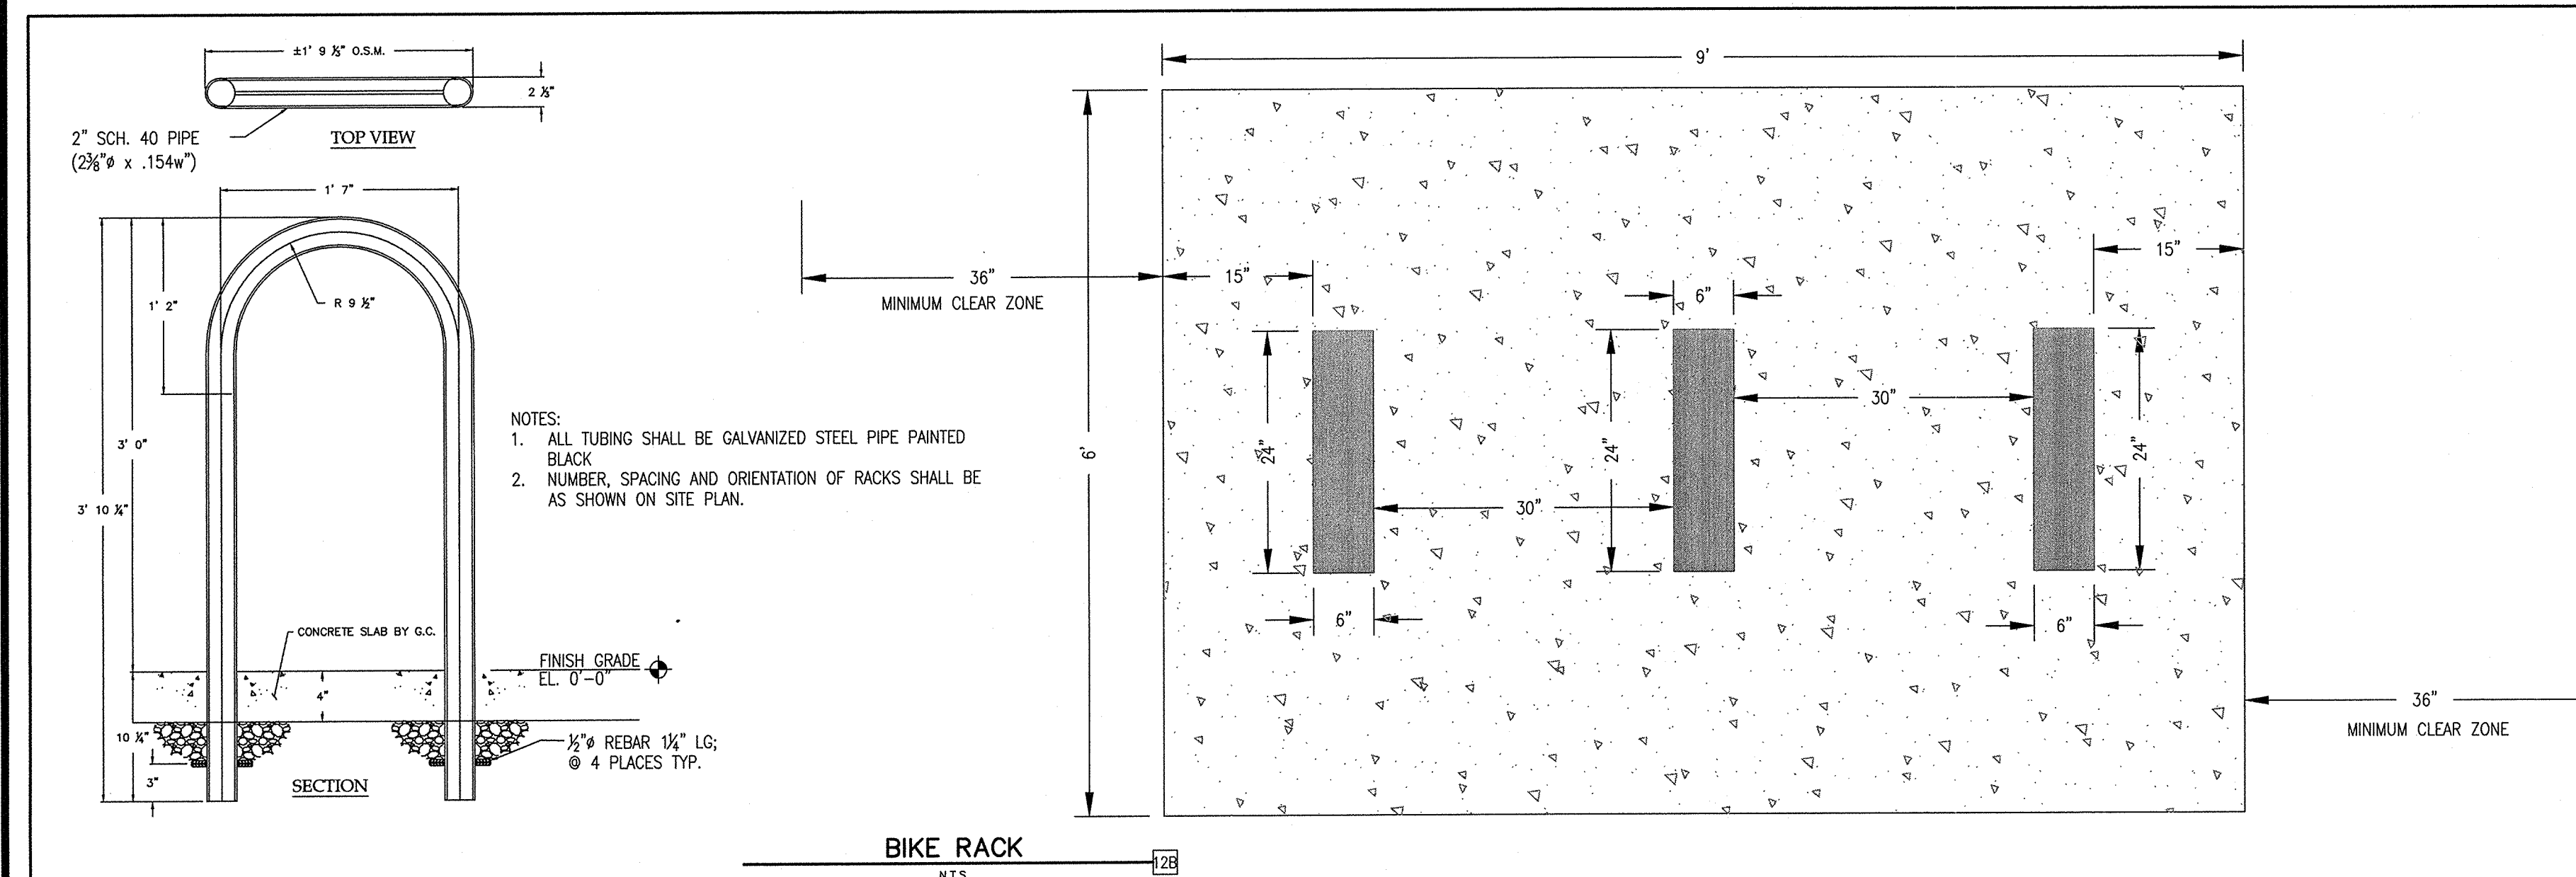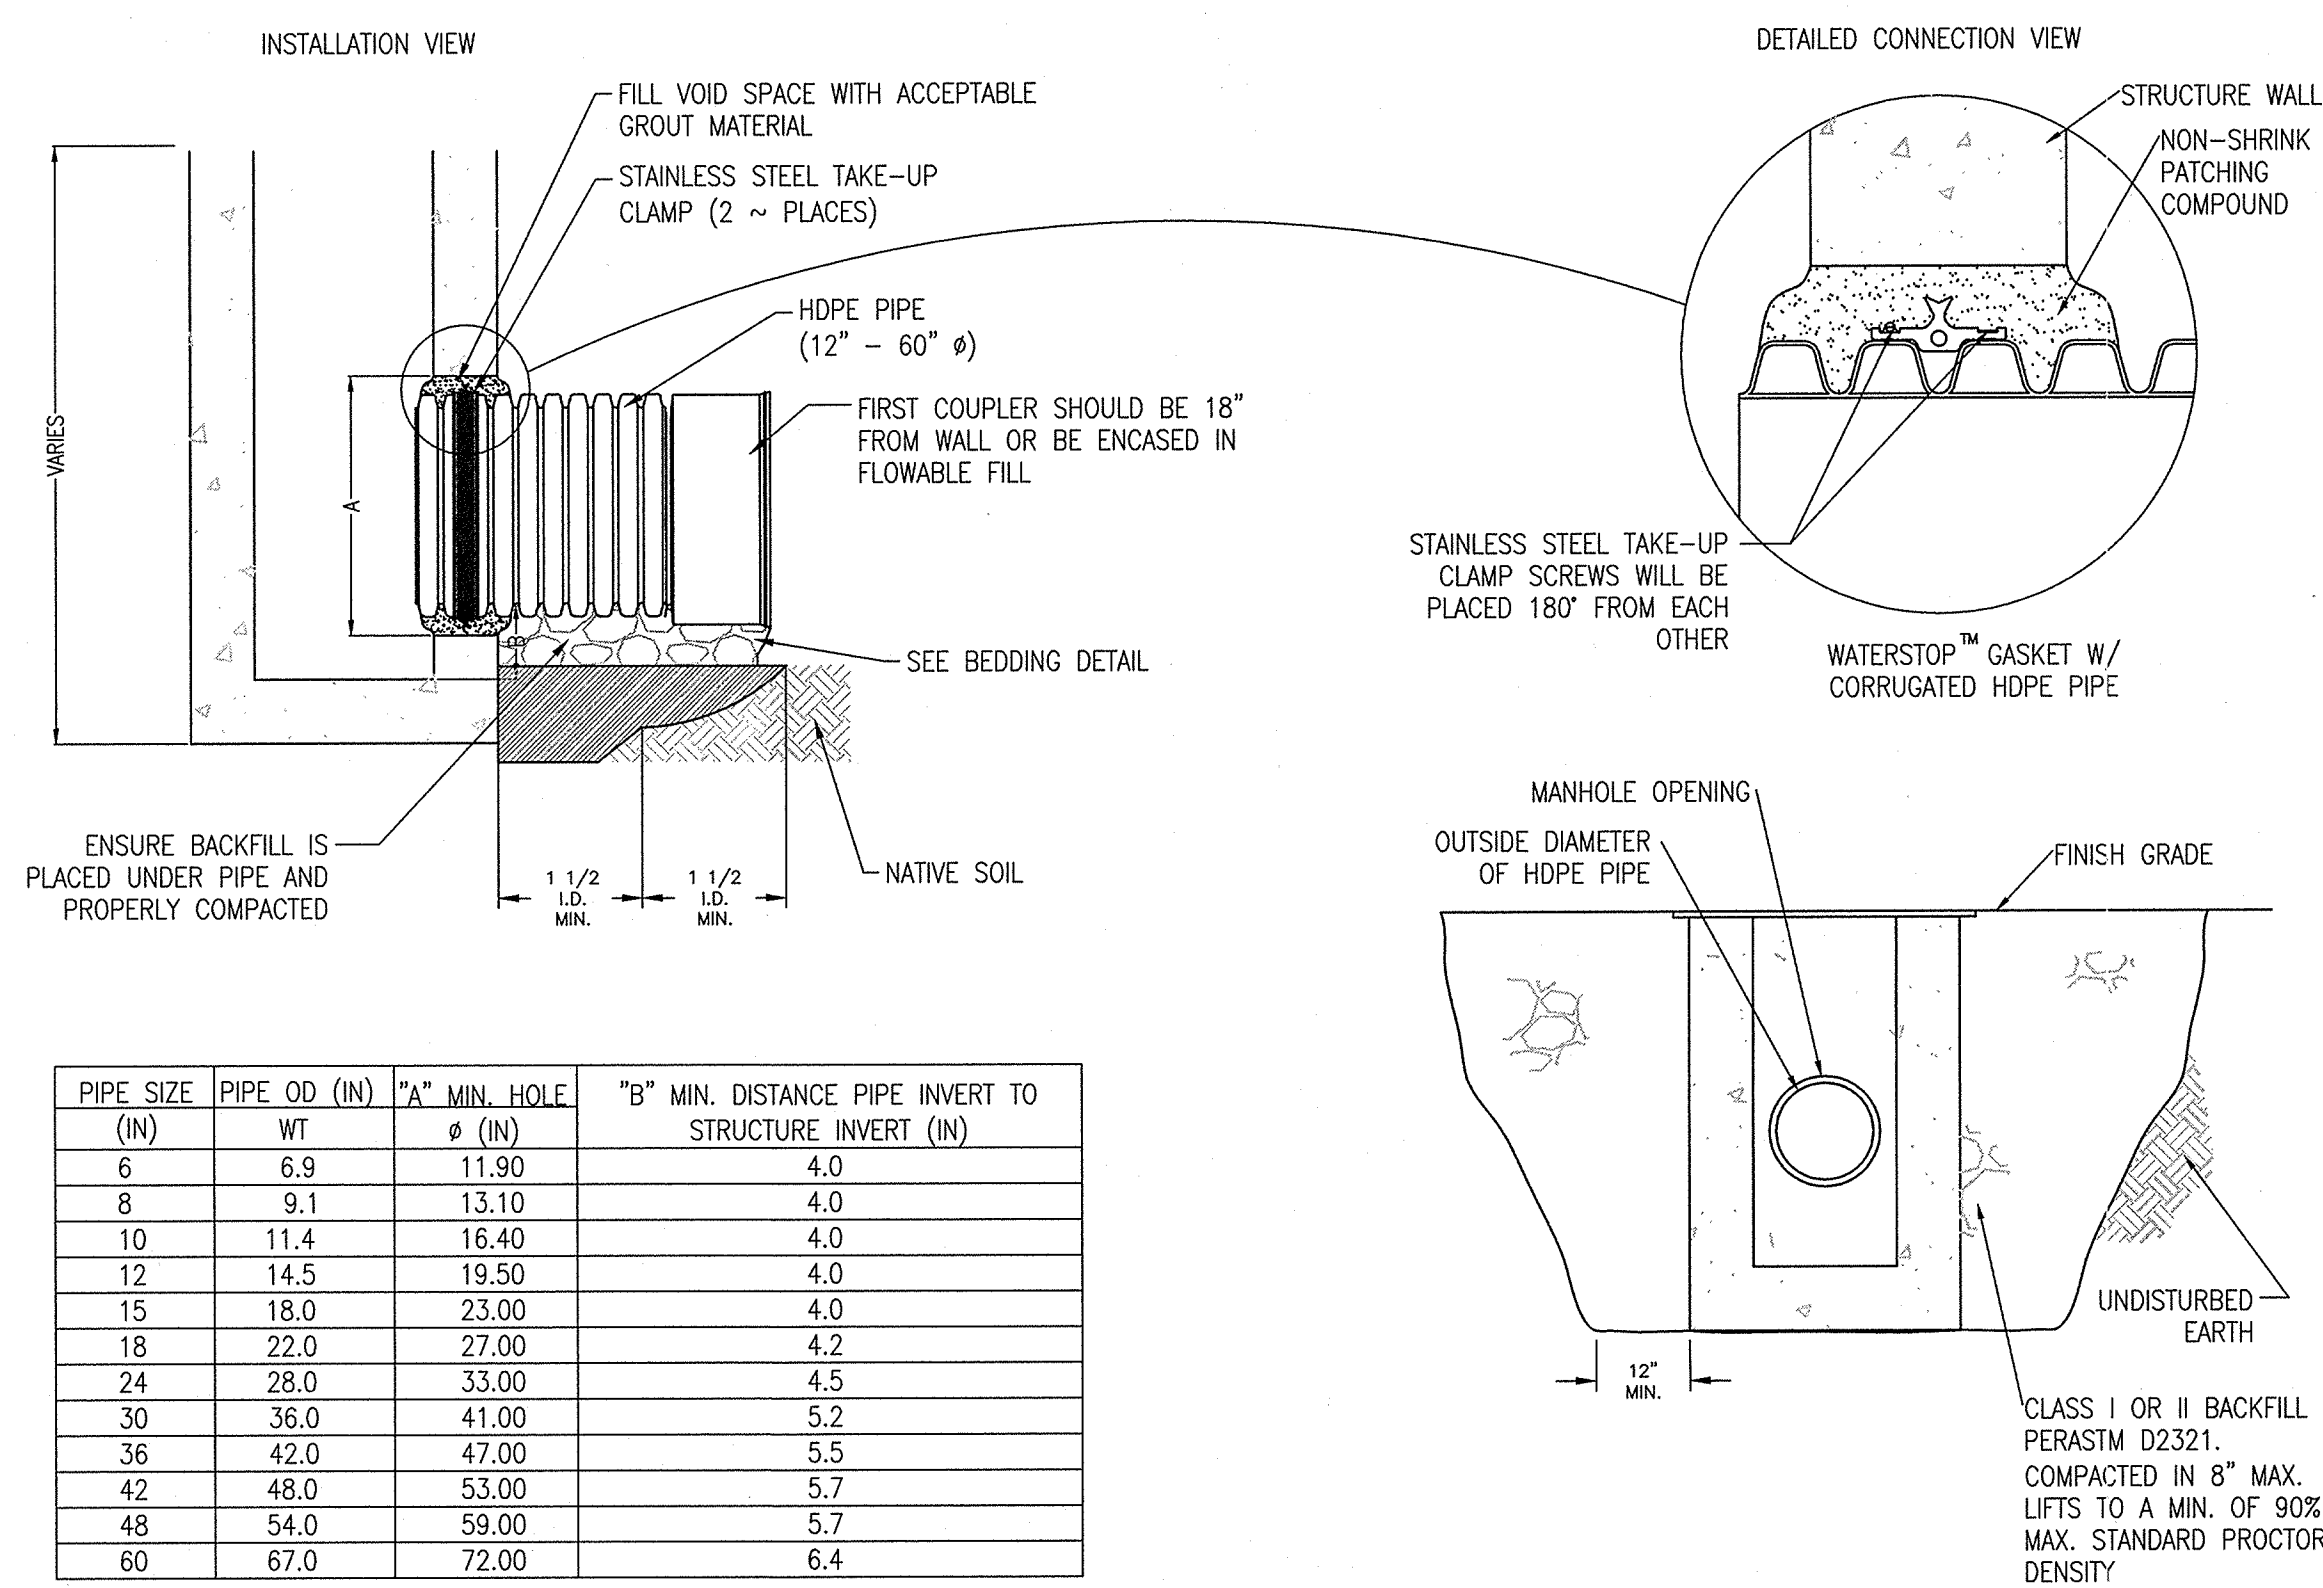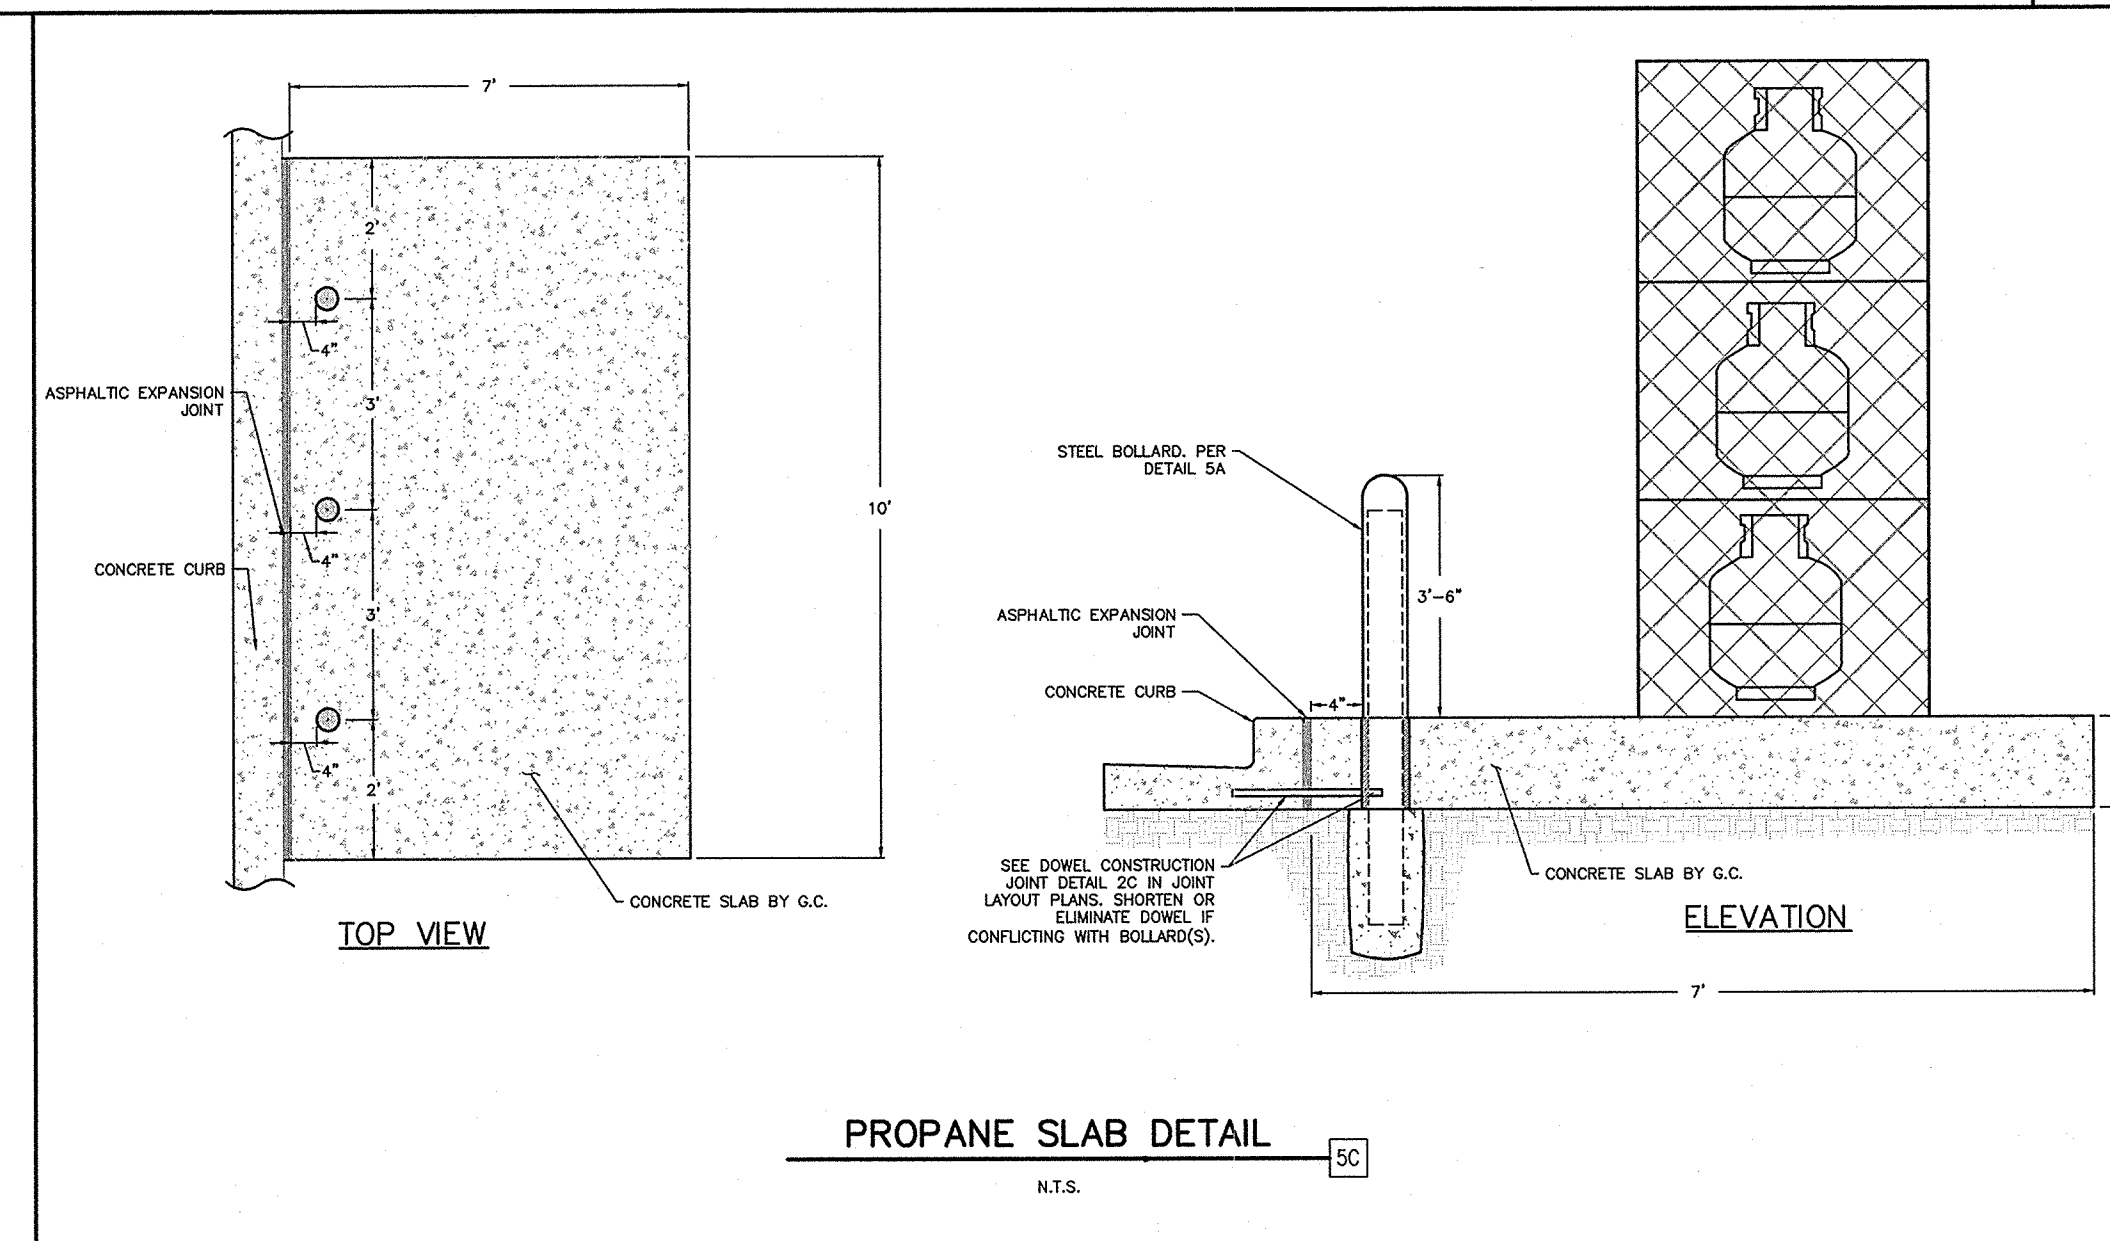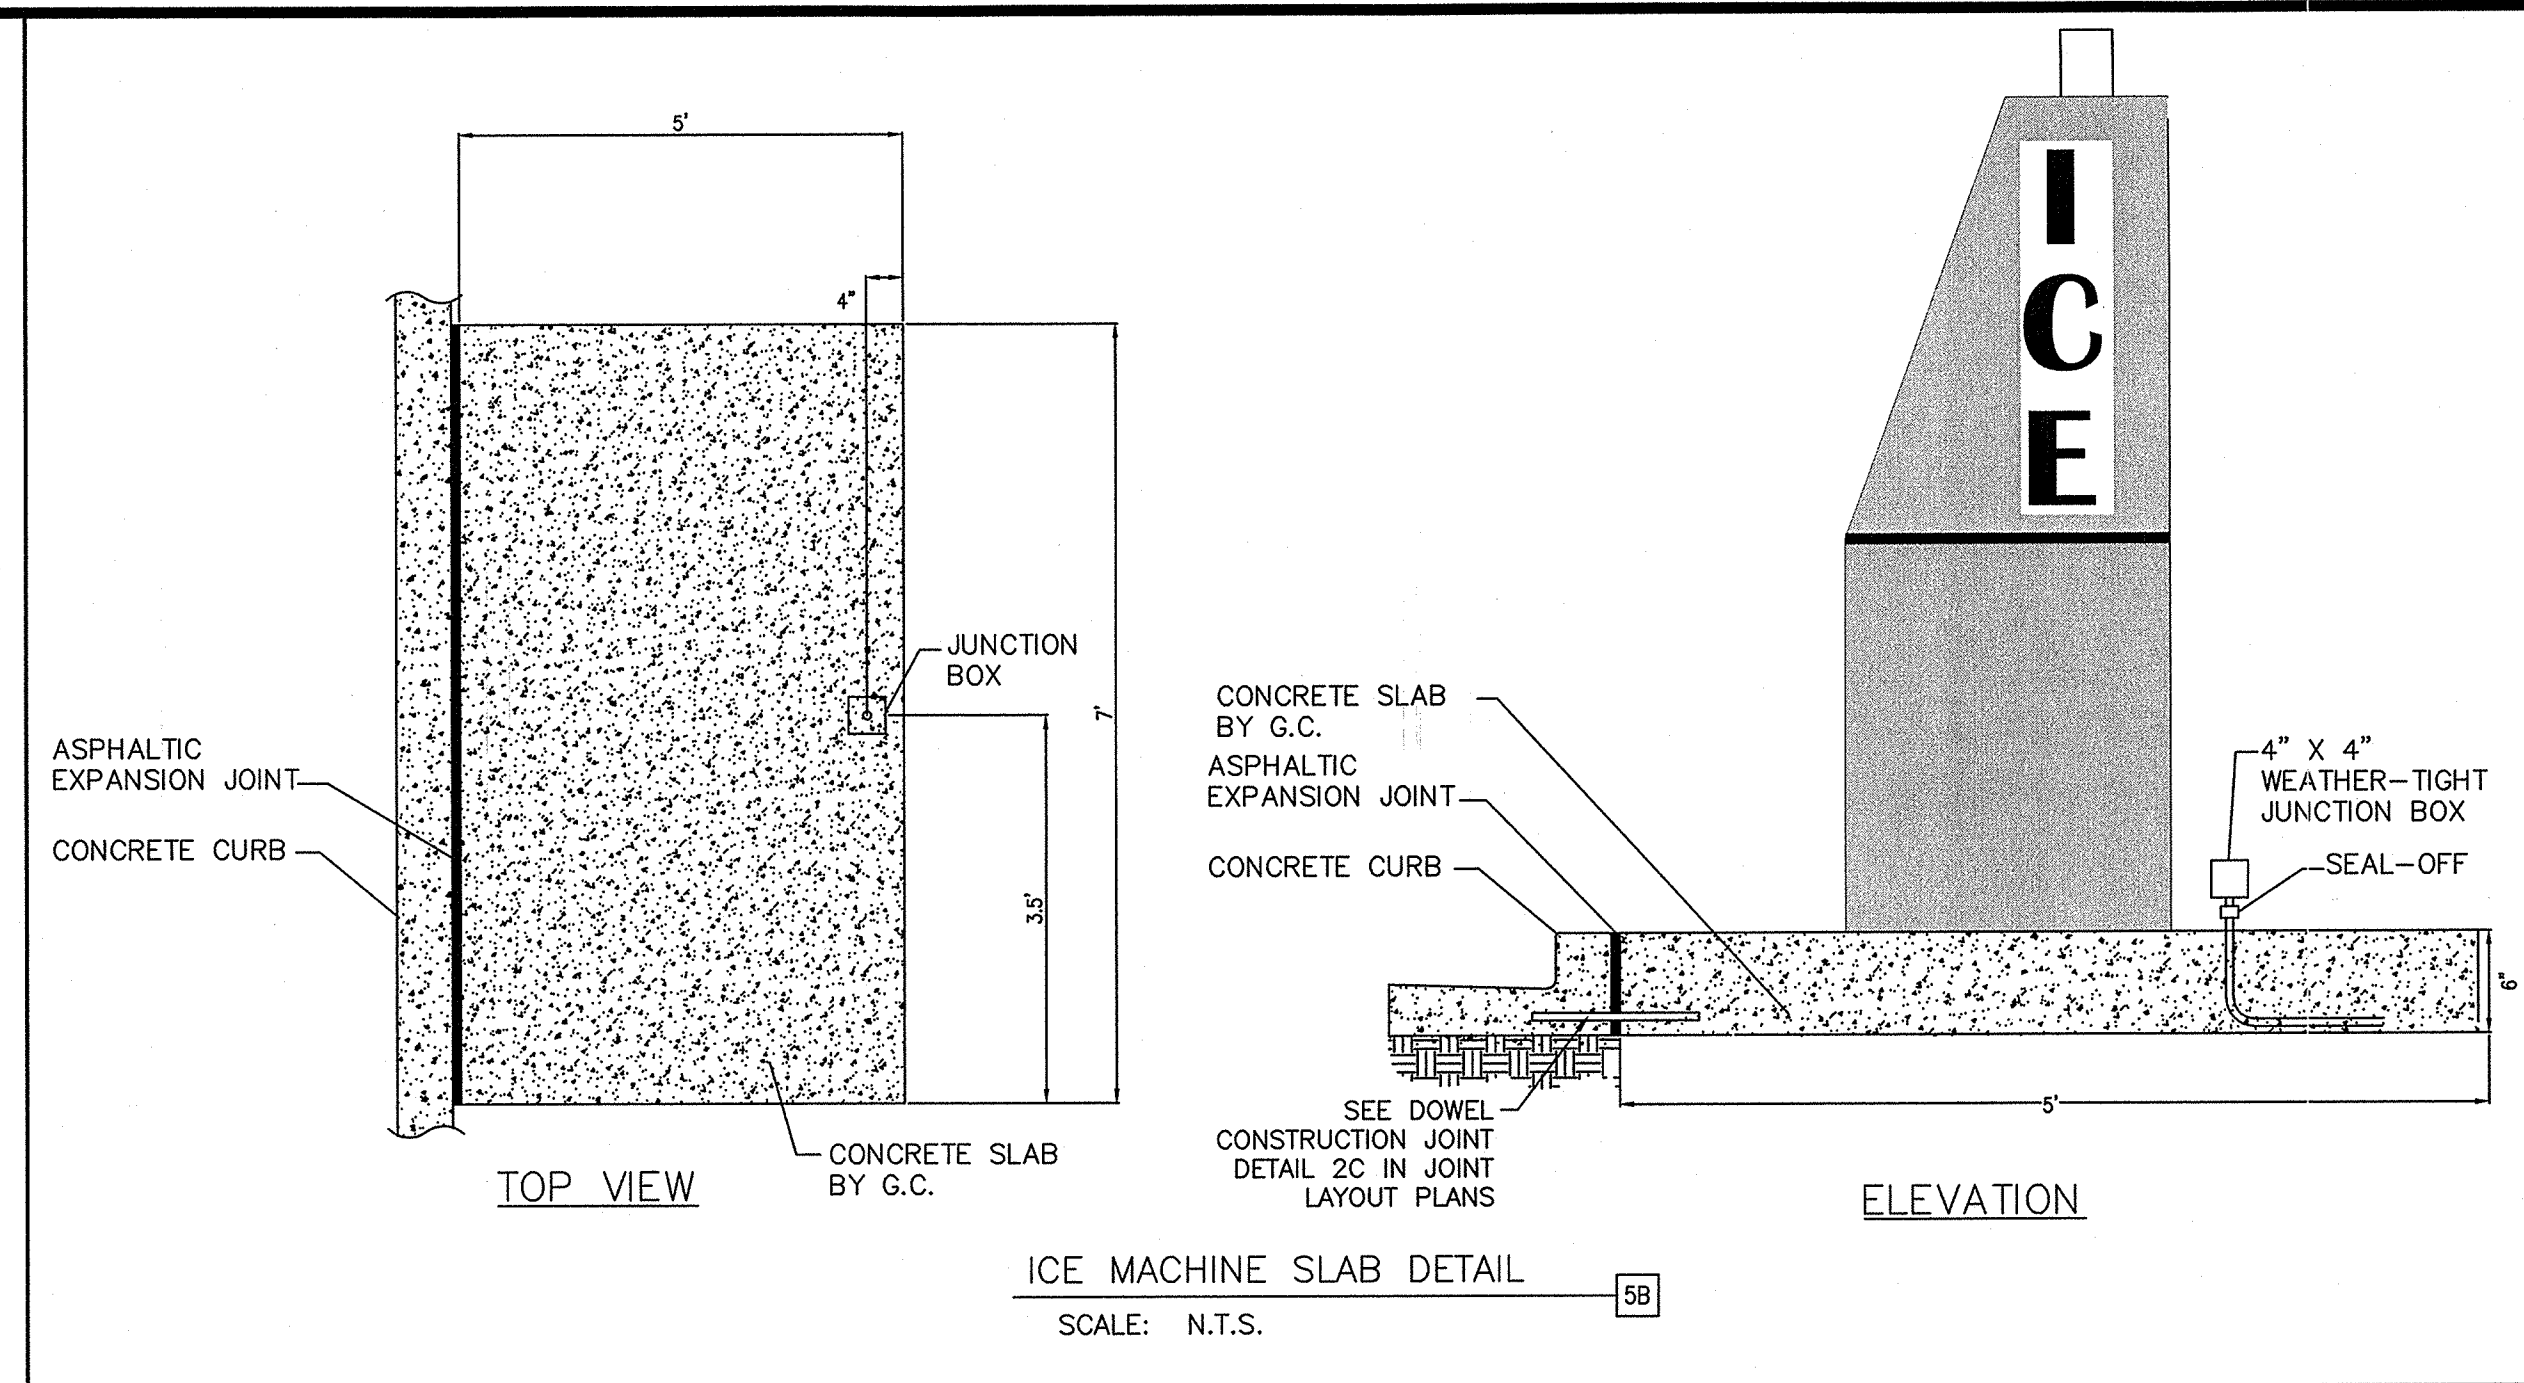

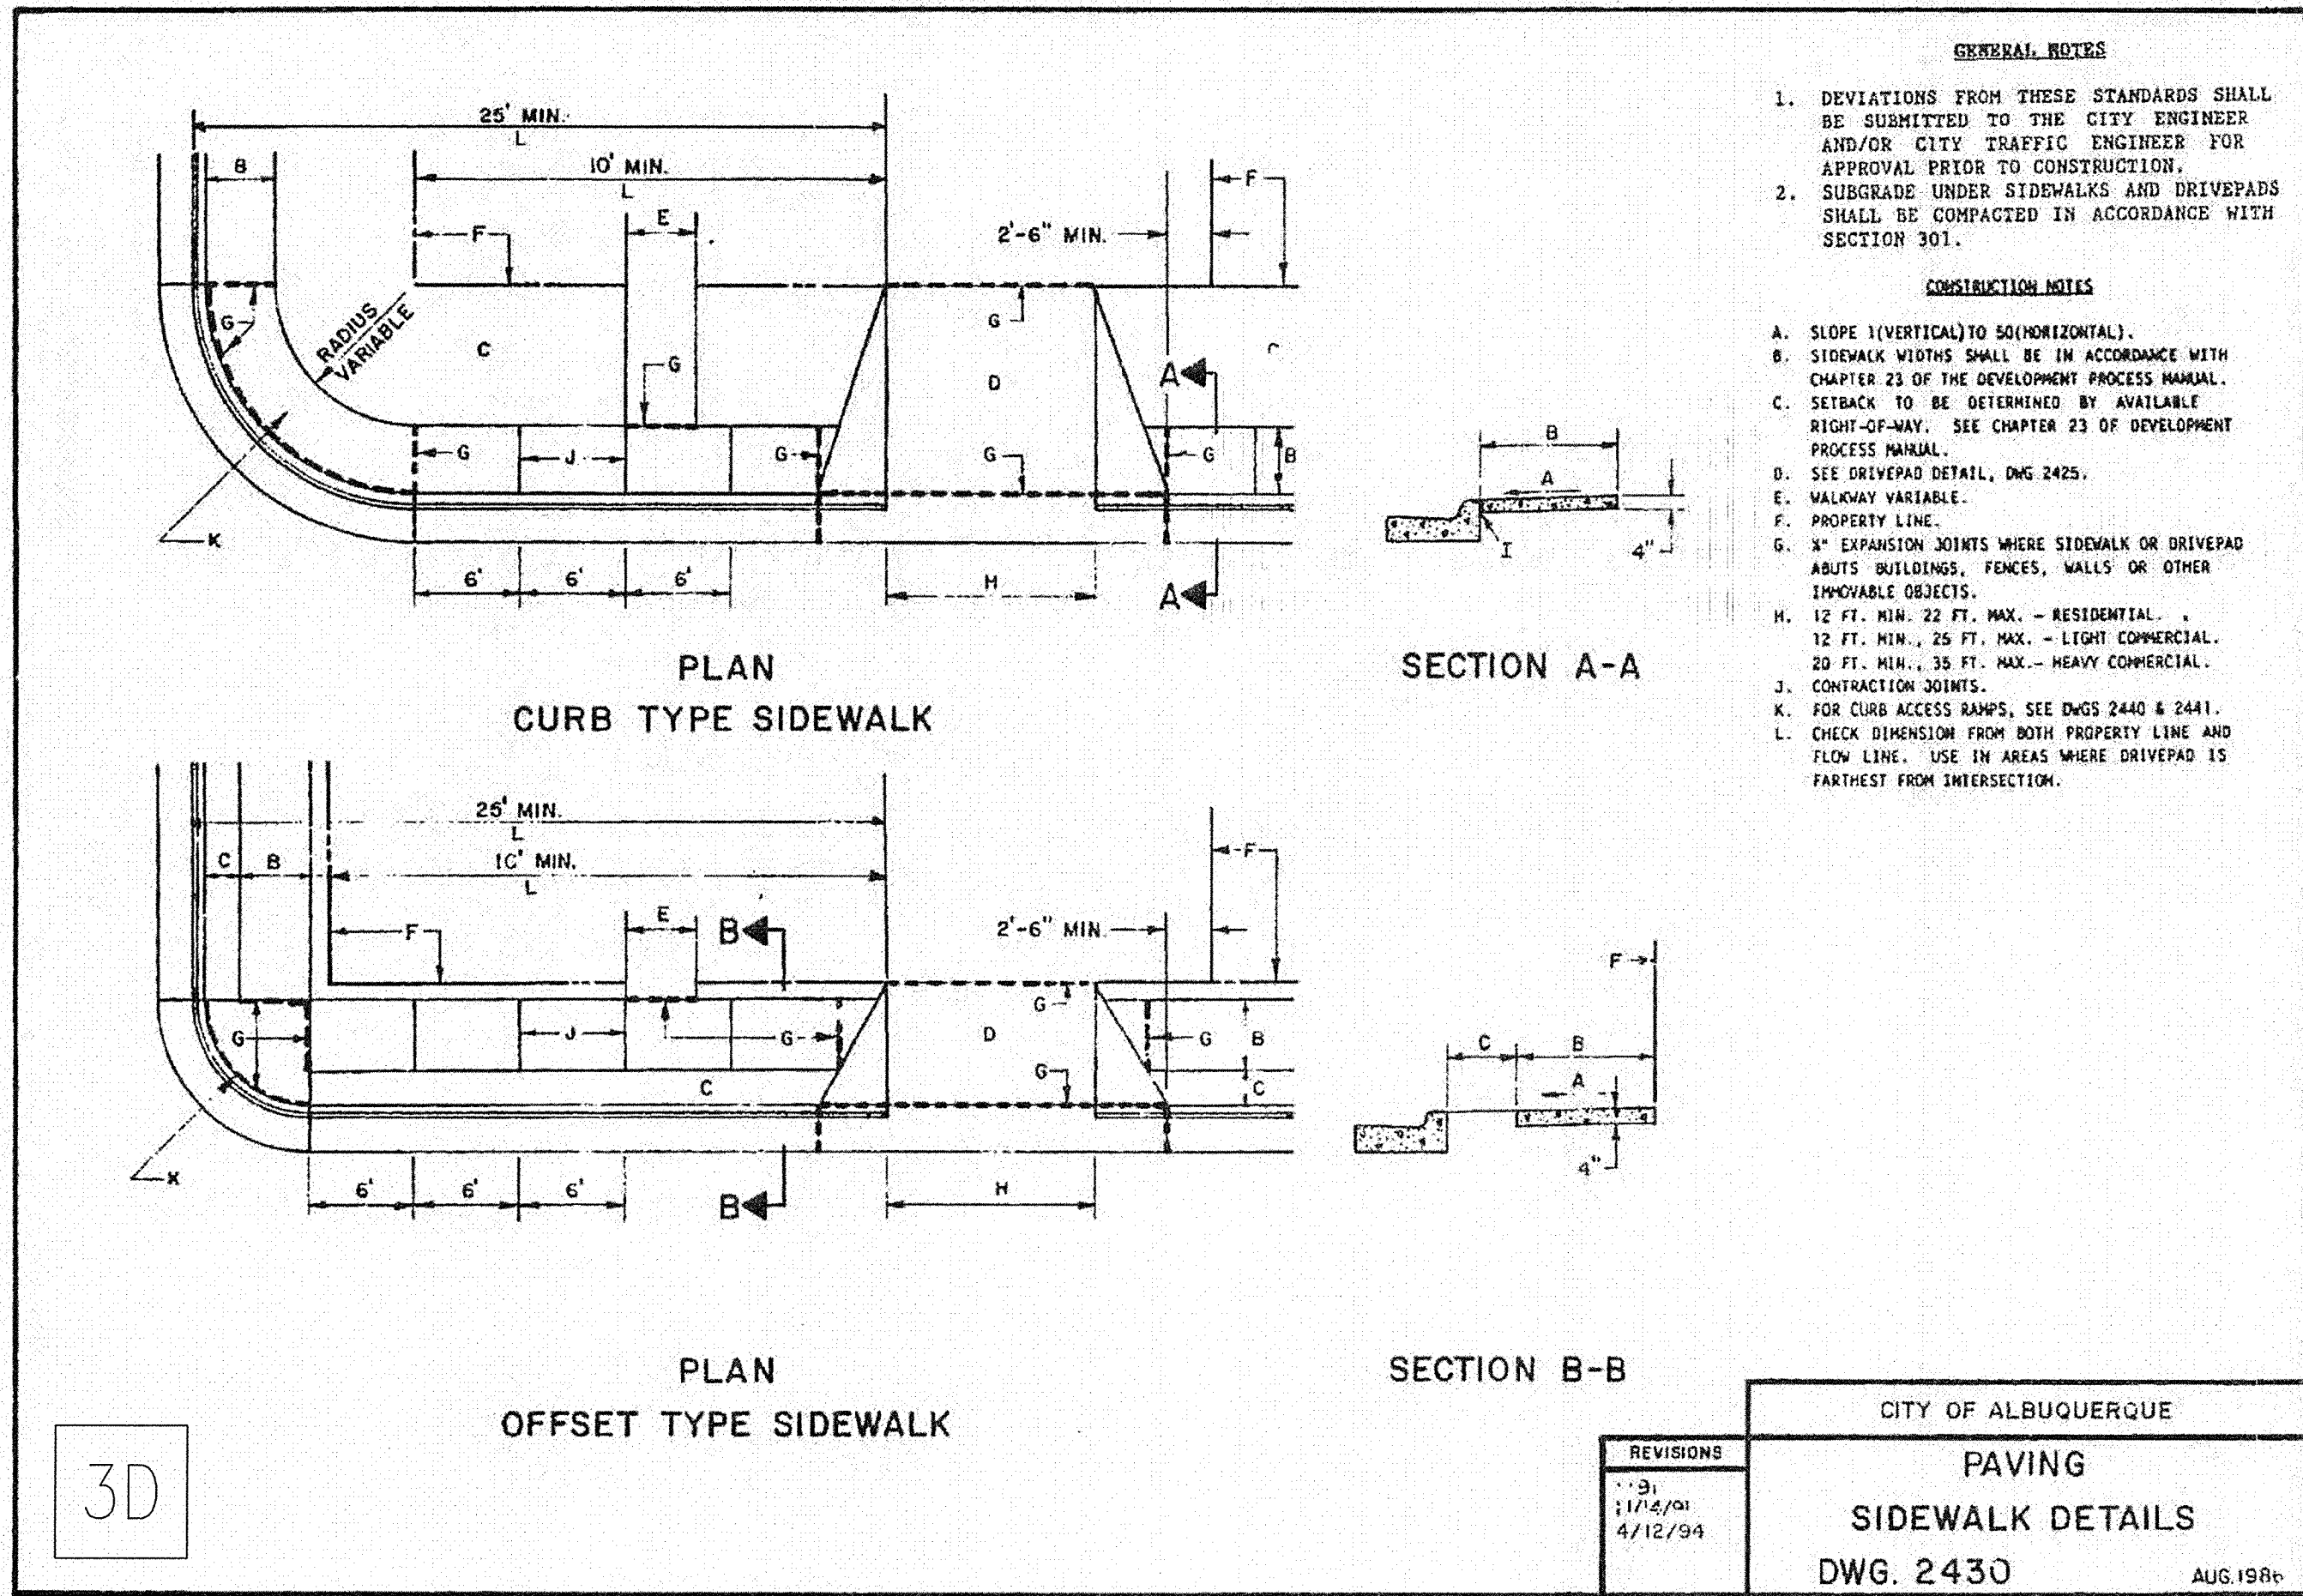


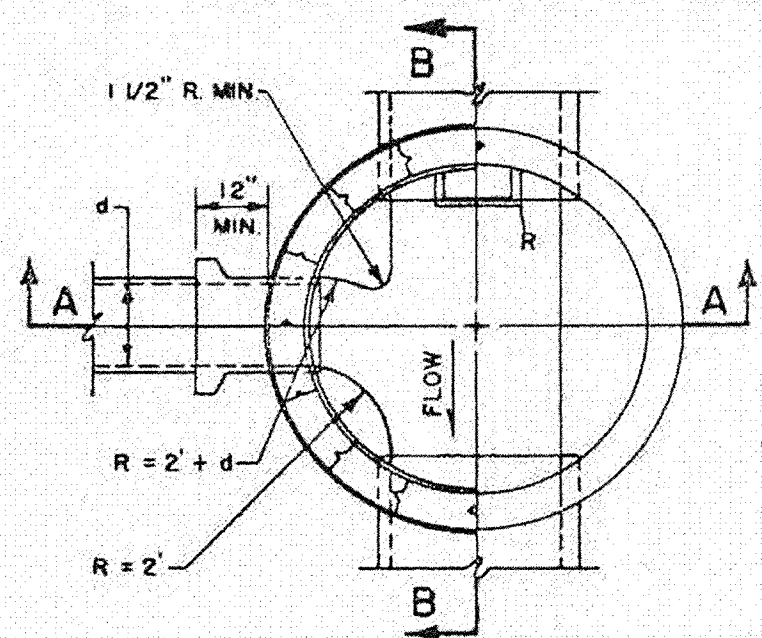


PLAN AT C-C

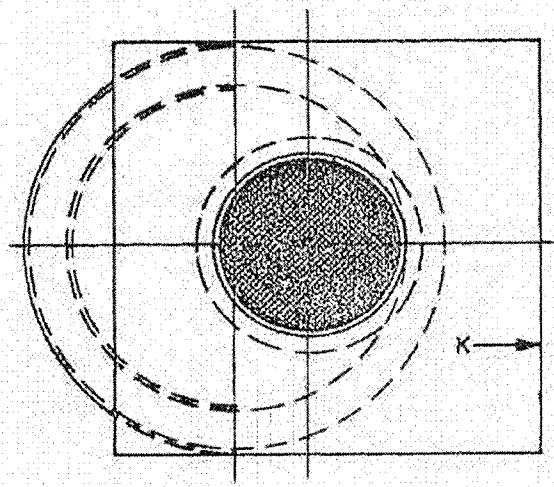

PLAN AT D-D

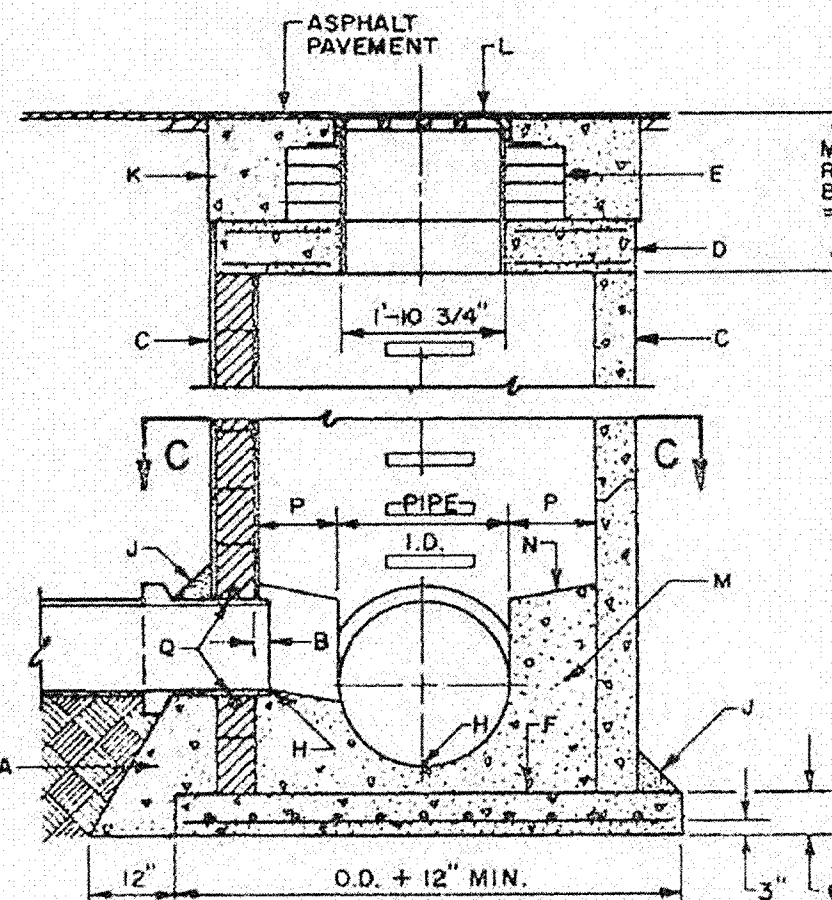

CROSS SECTION A-A

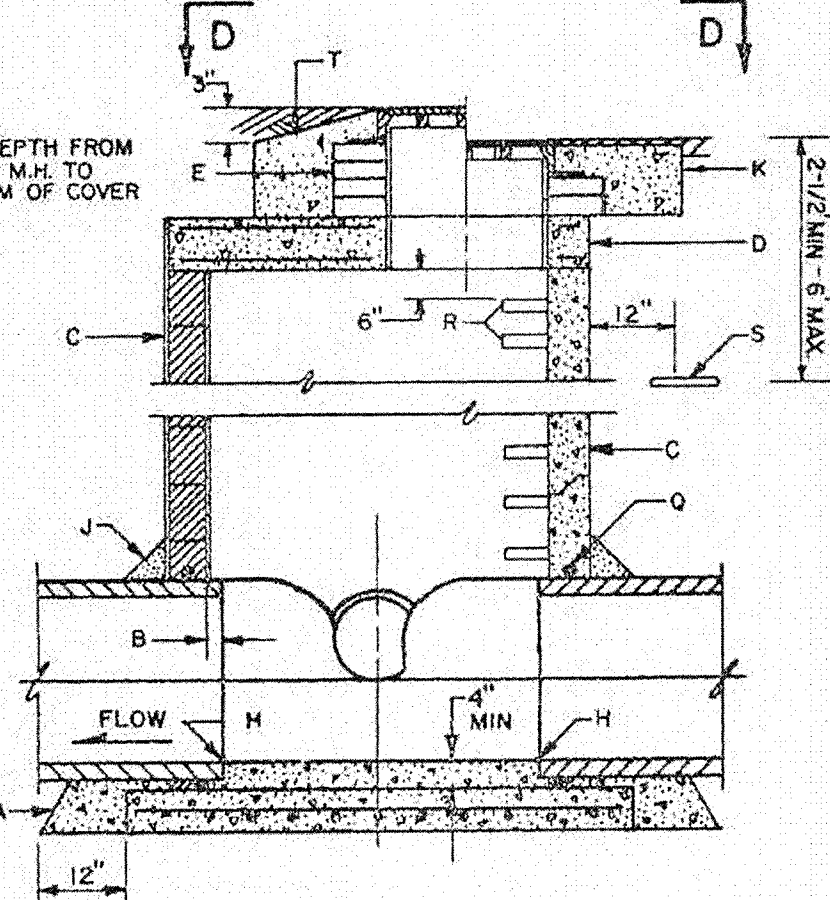

CROSS SECTION B-B

GENERAL NOTES

- USE TYPE "C" MANHOLE FOR DEPTHS OF LESS THAN 6' MEASURED FROM INVERT TO RIM.
- CONTRACTOR HAS OPTION TO CONSTRUCT TYPE "C" MANHOLE IN LIEU OF TYPE "E" MANHOLE FOR DEPTHS OF 6' OR MORE.
- DESIGN APPLIES TO 4" TO 6" I.D. MANHOLES.
- MANHOLE GREATER THAN 18" IN DEPTH SHALL ONLY BE CONSTRUCTED PRECAST CONCRETE SECTIONS.
- USE NON-SHRINK GROUT FOR JOINTS, FILLETS AND PENETRATIONS.
- COMPACT ALL BACKFILL AROUND MANHOLE TO 95%.
- POSITION MANHOLE OPENING OVER THE UPSTREAM SIDE OF MAIN LINE.


CONSTRUCTION NOTES

- CONCRETE PIPE SUPPORTS SHALL EXTEND OUTSIDE OF MANHOLE TO BELL OF FIRST JOINT AND SHALL GRADE PIPE TO SPRING LINE NOT APPLICABLE FLEXIBLE PIPE.
- PIPE PENETRATION INTO MANHOLE SHALL BE FLUSH TO 2" MAX., MEASURED AT SPRINGLINE OF PIPE.
- MANHOLE MAY BE CONSTRUCTED OF CONCRETE BLOCK, CB, NO BRICK, POURED CONCRETE OR PRECAST REINFORCED CONCRETE, IF BLOCK OR BRICK PLASTER INSIDE AND OUT WITH 1/2" MORTAR. SEE DWG. 2118 FOR DETAILS.
- PRECAST CONCRETE COVER, SEE DWG. 2107.
- USE MAX., 4 COURSES CR. MS BRICK ON UNPAVED STREET FOR FUTURE ADJUSTMENT OF MANHOLE FRAME TO PAVEMENT GRADE PLASTER INSIDE WITH 1/2" MORTAR.
- CONCRETE BASE TO BE POURED IN PLACE USING NO. 4 BARS AT 6" O.C. EA. WAY FOR MANHOLE DEPTHS OF 16' OR GREATER. NO. 4 BARS AT 12" O.C. EA. WAY FOR MANHOLE LESS THAN 16' IN DEPTH.
- INVERT ELEVATION OF STUB OR LATERAL AS SHOWN ON PLANS.
- 6" GROUT FILLET ON UPPER HALF OF PIPE AND AROUND BASE.
- USE A 5' X 5' CONCRETE PAD IN ALL AREAS.
- FRAME AND COVER, SEE DWG. 2110.
- CONCRETE, SEE SECTION 101.
- SLOPE 1" PER FT. FROM PIPE CROWN.
- SHED TO BE 9" WIDE MIN.
- APPROVED WATERSTOP TO BE COMPATIBLE WITH TYPE OF PIPE.
- STEPS TO BE INSTALLED AS PER SPEC. SECTION 920.
- END (IN UNPAVED AREAS).
- IN UNPAVED AREAS SET FRAME TO GRADE AND SLOPE TOP OF PAD.


REVISIONS

11-14-91	
----------	--


CITY OF ALBUQUERQUE
SEWER
MANHOLE TYPE "C"
DWG. 2101 **AUG. 1986**

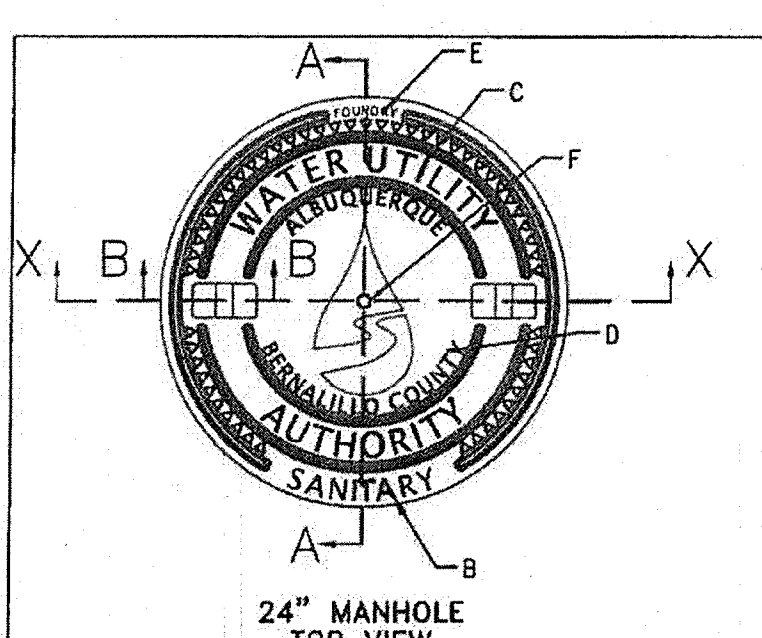


24" MANHOLE TOP VIEW

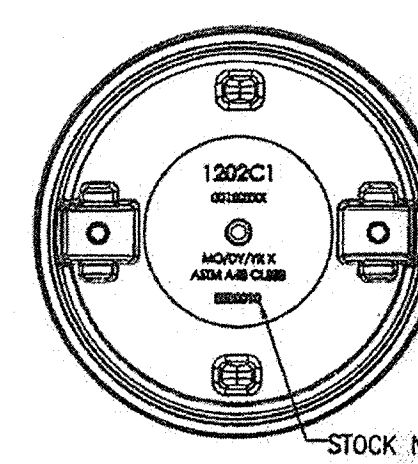


24" MANHOLE BOTTOM VIEW

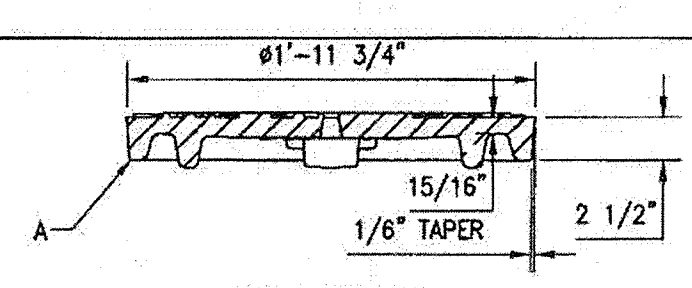


24" MANHOLE SECTION A-A

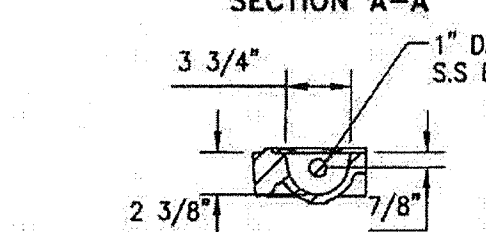


24" MANHOLE SECTION B-B

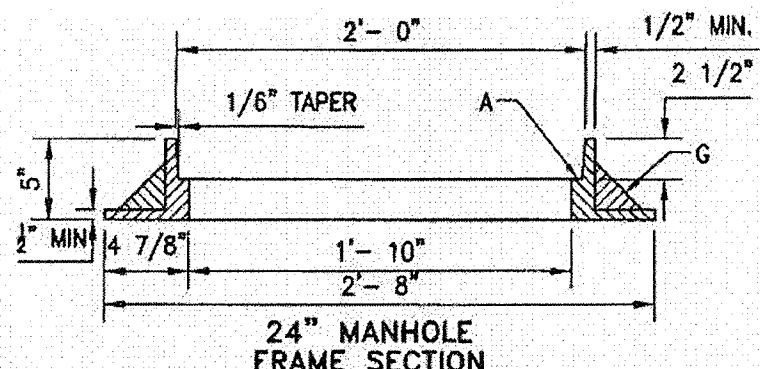


24" MANHOLE FRAME SECTION

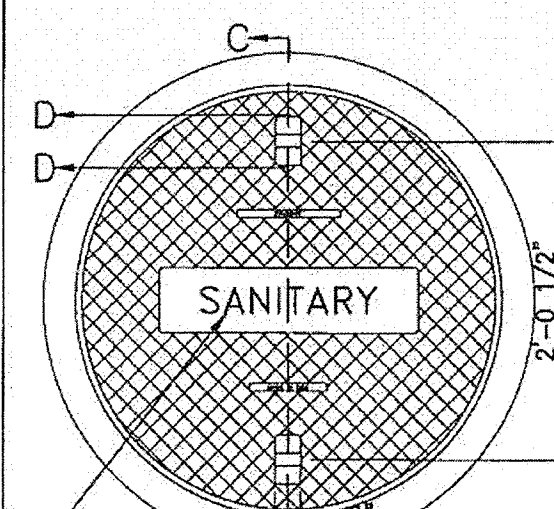


36" MANHOLE TOP VIEW

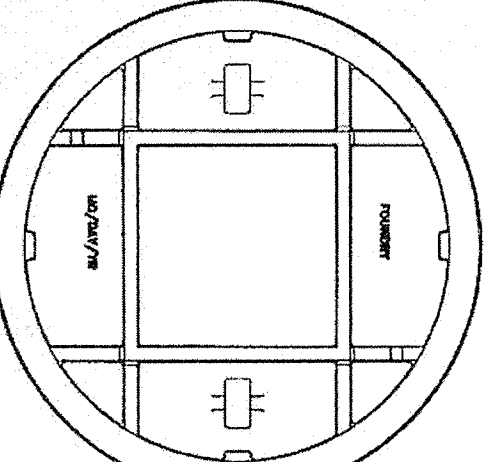

36" MANHOLE BOTTOM VIEW

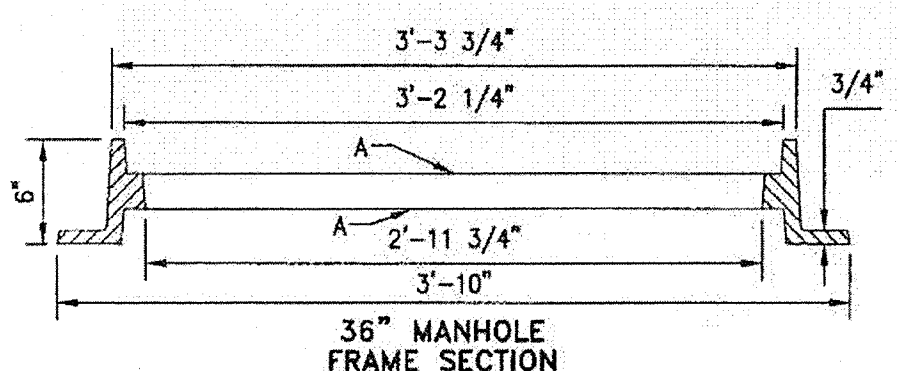

36" MANHOLE FRAME SECTION

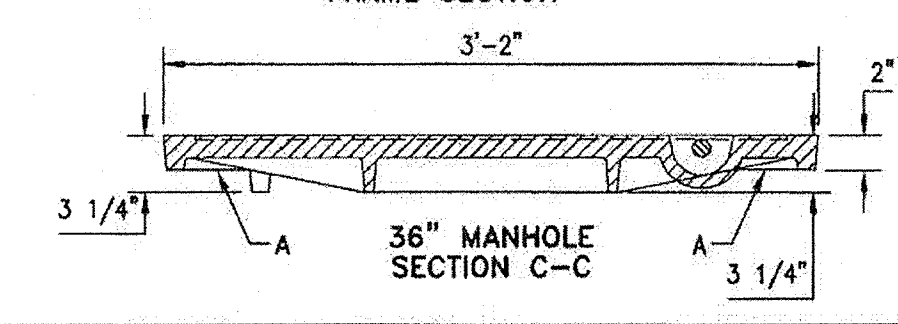

36" MANHOLE SECTION C-C

24" GENERAL NOTES:

- STANDARD 24" CAST IRON M.H. FRAME AND COVER. WEIGHTS: COVER = 127 LBS., FRAME = 150 LBS. TOTAL = 277 LBS. (TOLERANCE = ±5%)
- REFERENCE SPEC. SECTION 130.
- ONLY PRODUCTS CAST IN THE USA WILL BE ACCEPTABLE.

36" GENERAL NOTES:

- STANDARD 36" CAST IRON M.H. FRAME AND COVER. WEIGHTS: COVER = 355 LBS., FRAME = 315 LBS. TOTAL = 670 LBS. (TOLERANCE = ±5%)
- REFERENCE SPEC. SECTION 130.
- ONLY PRODUCTS CAST IN THE USA WILL BE ACCEPTABLE.


CONSTRUCTION NOTES:

- MACHINED OR GROUND BEARING SURFACES.
- "SANITARY" CAST ON COVER TO IDENTIFY SANITARY SEWER.
- LETTER SIZE TO BE 1 1/4" IN HEIGHT RAISED LETTERING.
- LETTER SIZE TO BE 3/4" IN HEIGHT RAISED LETTERING.
- LETTER SIZE TO BE 3/8" MIN. IN HEIGHT RAISED LETTERING.
- 3/4" DIA VENT HOLE REQUIRED.
- GUSSETS OPTIONAL IF REQUIRED BY MANUFACTURER.
- 2" LETTERS (RECESSED FLUSH).


REVISIONS

11-14-91	
----------	--


CITY OF ALBUQUERQUE
SEWER
MANHOLE TYPE "C"
DWG. 2101 **JANUARY 2011**

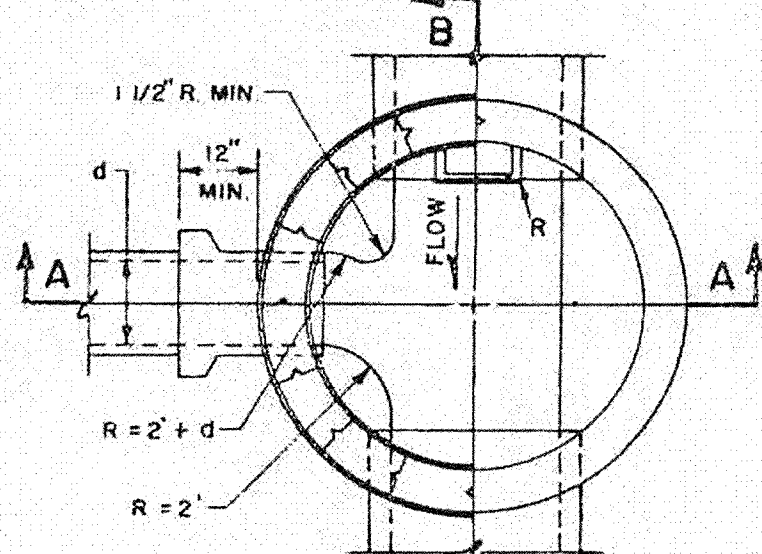


PLAN AT C-C

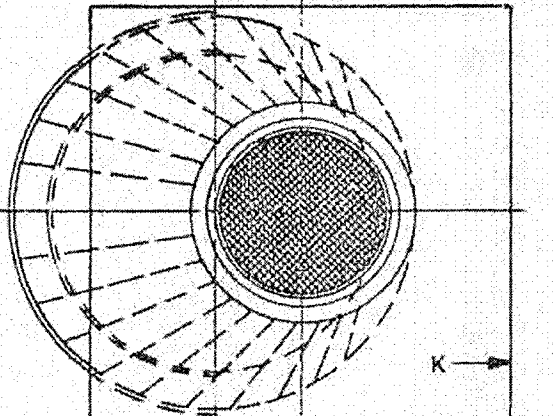

PLAN AT D-D

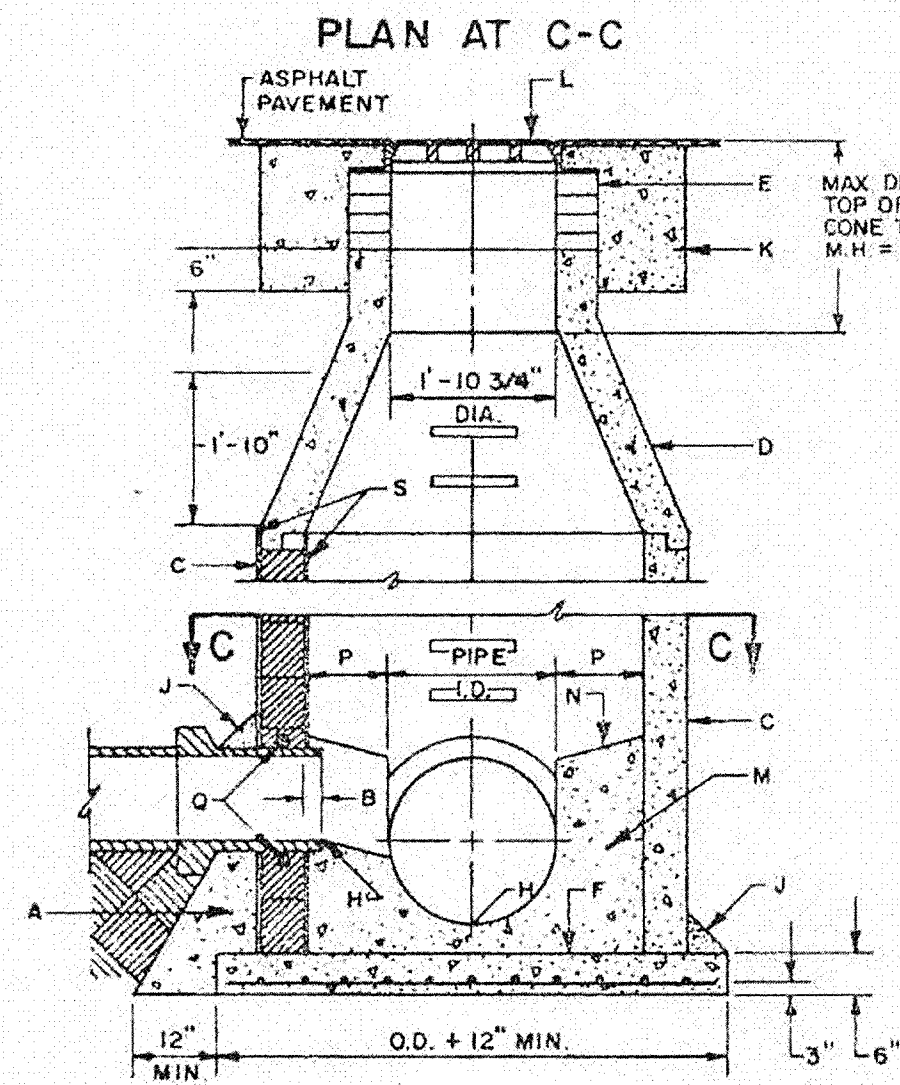

CROSS SECTION A-A

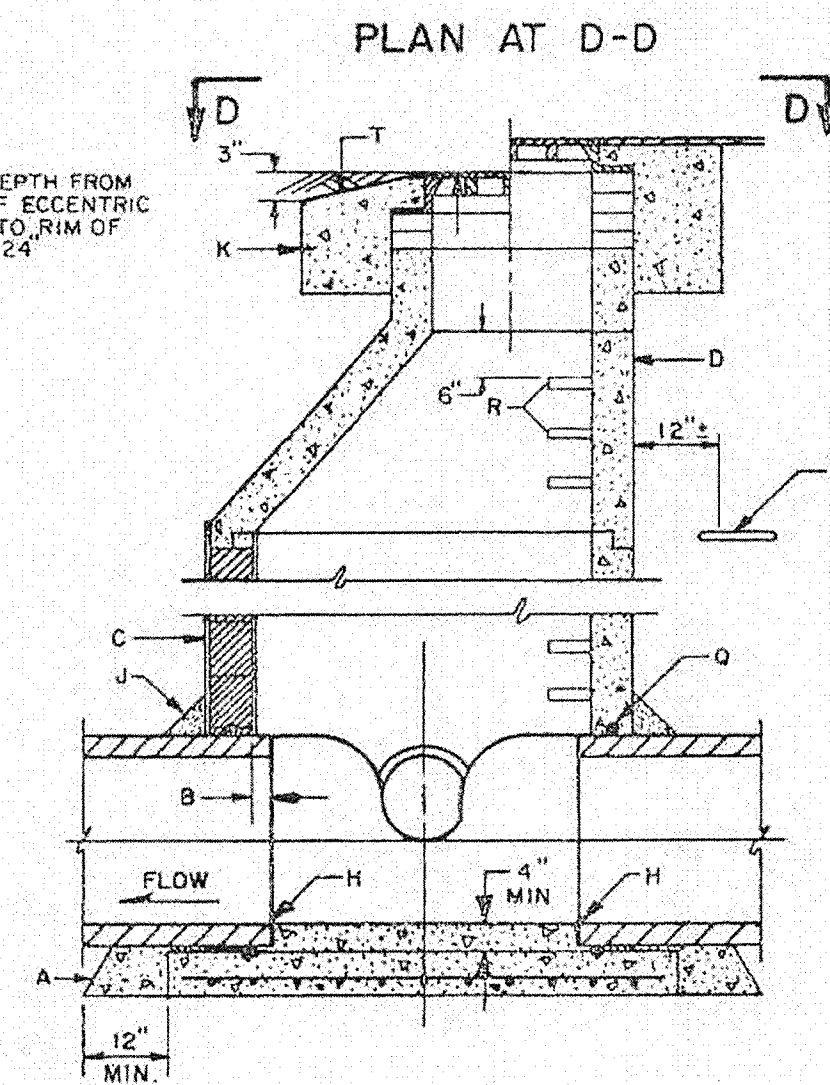

CROSS SECTION B-B

GENERAL NOTES

- TYPE "E" MANHOLE NOT TO BE USED FOR DEPTHS LESS THAN 6' MEASURED FROM INVERT TO RIM.
- MANHOLE GREATER THAN 18" IN DEPTH SHALL BE OF PRECAST CONCRETE SECTIONS ONLY.
- DESIGN APPLIES TO 4" AND 6" I.D. MANHOLES.
- USE NON-SHRINK GROUT FOR JOINTS, FILLETS AND PIPE PENETRATIONS.
- COMPACT ALL BACKFILL AROUND MANHOLES TO 95%.
- POSITION MANHOLE OPENING OVER THE UPSTREAM SIDE OF MAIN LINE.


CONSTRUCTION NOTES

- CONCRETE PIPE SUPPORTS SHALL EXTEND OUTSIDE OF MANHOLE TO BELL OF FIRST JOINT AND SHALL GRADE PIPE TO SPRING LINE NOT APPLICABLE FLEXIBLE PIPE.
- PIPE PENETRATION INTO MANHOLE SHALL BE FLUSH TO 2" MAX., MEASURED AT SPRINGLINE OF PIPE.
- MANHOLE MAY BE CONSTRUCTED OF CONCRETE BLOCK, CB, NO BRICK, POURED CONCRETE OR PRECAST REINFORCED CONCRETE, IF BLOCK OR BRICK PLASTER INSIDE AND OUT WITH 1/2" MORTAR. SEE DWG. 2118 FOR DETAILS.
- PRECAST REINFORCED CONCRETE ECCENTRIC CONE. THE CONTRACTOR SHALL PROVIDE SHOP DOWNS FOR APPROVAL.
- USE MAX., 4 COURSES CR. MS BRICK ON UNPAVED STREET FOR FUTURE ADJ. OF FRAME TO PAVEMENT GRADE PLASTER INSIDE WITH 1/2" MORTAR.
- BASE TO BE POURED IN PLACE USING NO. 4 BARS AT 6" O.C. EA. WAY FOR MANHOLE DEPTHS OF 16' OR GREATER. NO. 4 BARS AT 12" O.C. EA. WAY FOR MANHOLES LESS THAN 16' DEEP.
- INVERT ELEVATION OF STUB OR LATERAL AS SHOWN ON PLANS.
- 6" GROUT FILLET ON UPPER HALF OF PIPE AND AROUND BASE.
- USE A 5' X 5' CONCRETE PAD IN ALL AREAS.
- MANHOLE FRAME AND COVER, SEE DWG. 2110.
- CONCRETE, SEE SECTION 101.
- SLOPE 1" PER FT. FROM PIPE CROWN.
- SHED TO BE 9" WIDE MIN.
- APPROVED WATERSTOP TO BE WITH TYPE OF PIPE.
- STEPS TO BE INSTALLED AS PER SPEC. SECTION 920.
- END (IN UNPAVED AREAS).
- IN UNPAVED AREAS SET FRAME TO GRADE AND SLOPE TOP OF PAD.


REVISIONS

11-14-91	
----------	--


CITY OF ALBUQUERQUE
SEWER
MANHOLE TYPE "E"
DWG. 2102 **AUG. 1986**

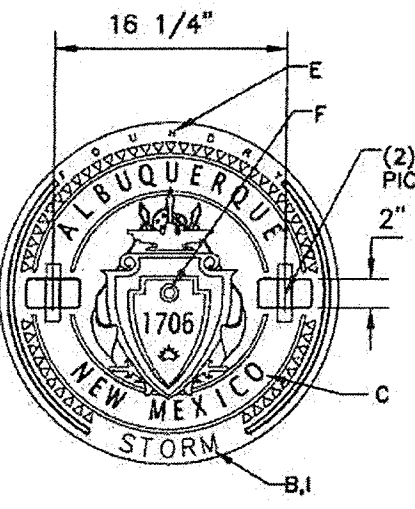


24" MANHOLE TOP VIEW

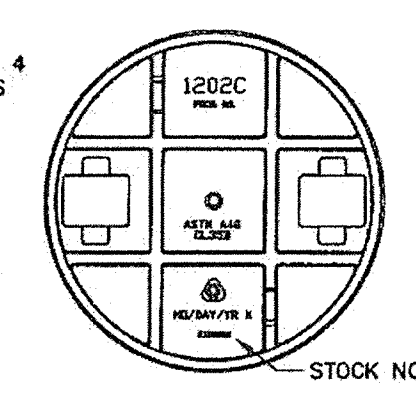


24" MANHOLE BOTTOM VIEW

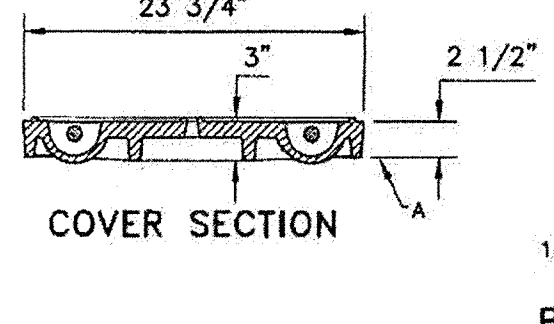


COVER SECTION

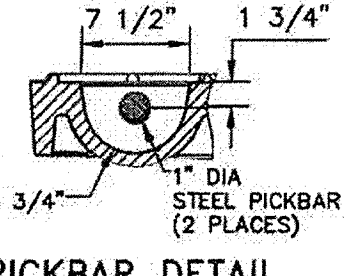


PICKBAR DETAIL

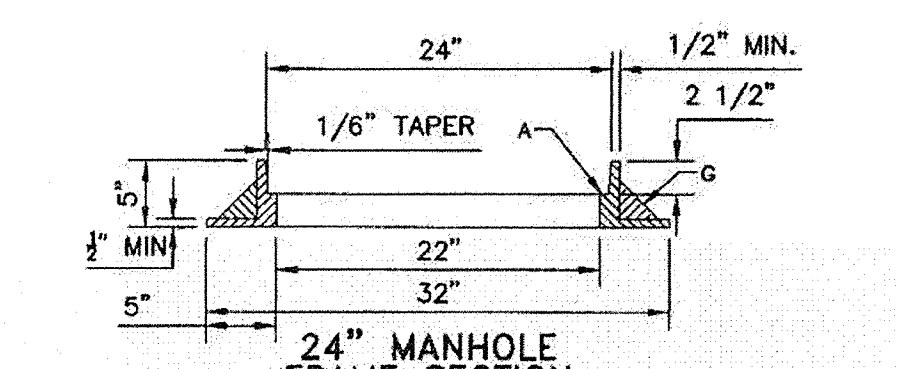


24" MANHOLE FRAME SECTION

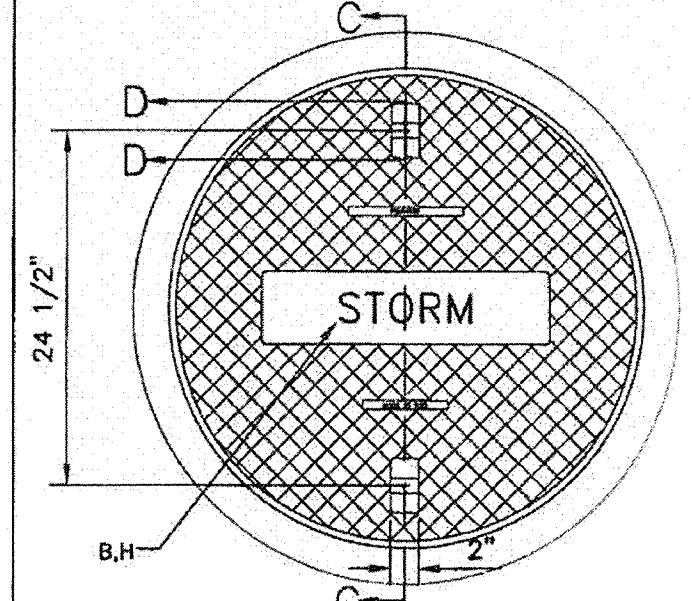


36" MANHOLE TOP VIEW

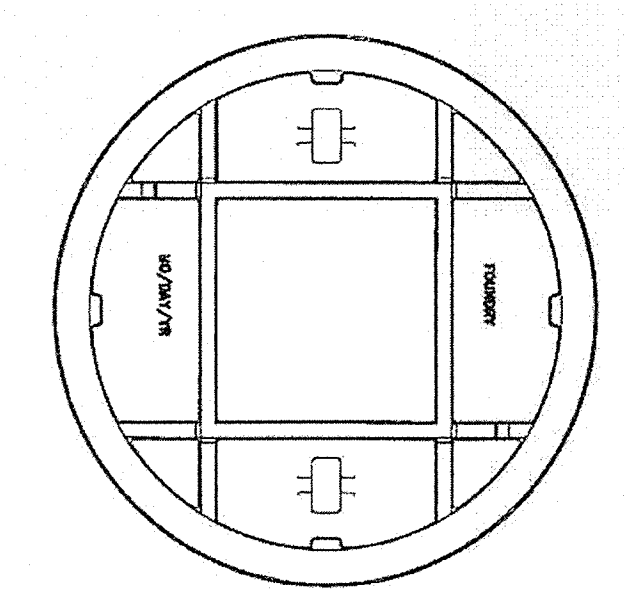

36" MANHOLE BOTTOM VIEW

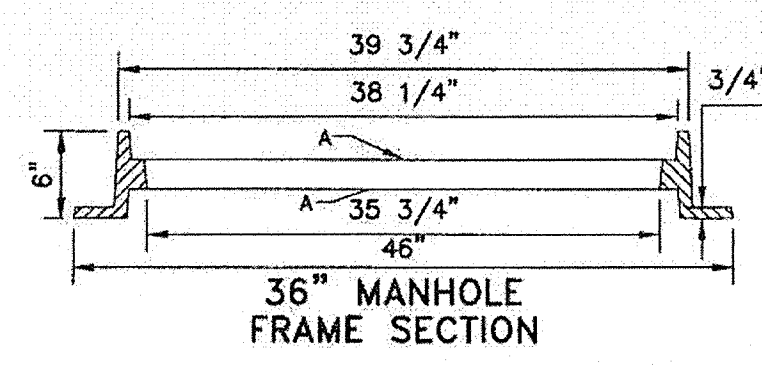

36" MANHOLE FRAME SECTION

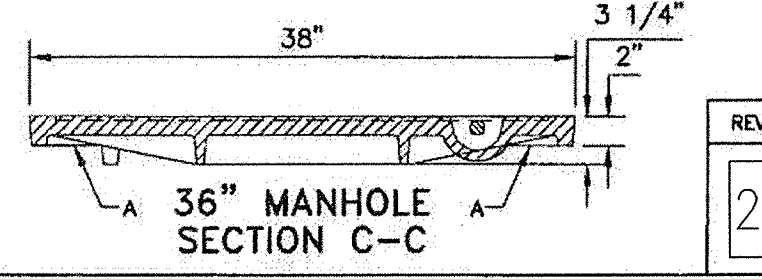

36" MANHOLE SECTION C-C

24" GENERAL NOTES:

- STANDARD 24" CAST IRON M.H. FRAME AND COVER. WEIGHTS: COVER = 180 LBS., FRAME = 145 LBS. TOTAL = 325 LBS. (TOLERANCE = ±5%)
- REFERENCE SPEC. SECTION 130.
- ONLY PRODUCTS CAST IN THE USA WILL BE ACCEPTABLE.

36" GENERAL NOTES:

- STANDARD 36" CAST IRON M.H. FRAME AND COVER. WEIGHTS: COVER = 355 LBS., FRAME = 315 LBS. TOTAL = 670 LBS. (TOLERANCE = ±5%)
- REFERENCE SPEC. SECTION 130.
- ONLY PRODUCTS CAST IN THE USA WILL BE ACCEPTABLE.

CONSTRUCTION NOTES:

- MACHINED OR GROUND BEARING SURFACES.
- "STORM" CAST ON COVER TO IDENTIFY STORM DRAINAGE.
- LETTER SIZE TO BE 1 1/4" IN HEIGHT RAISED LETTERING.
- LETTER SIZE TO BE 3/4" IN HEIGHT RAISED LETTERING.
- LETTER SIZE TO BE 3/8" MIN. IN HEIGHT RAISED LETTERING.
- 3/4" DIA VENT HOLE REQUIRED.
- GUSSETS OPTIONAL IF REQUIRED BY MANUFACTURER.
- 2" LETTERS (RECESSED FLUSH).
- LETTER SIZE TO BE 1" IN HEIGHT RAISED LETTERING.

REVISIONS

23D	
-----	--

CITY OF ALBUQUERQUE
SEWER
MANHOLE TYPE "E"
DWG. 2110 **JANUARY 2011**


CONCRETE SPECIFICATIONS

- A. CEMENT
1. PROVIDE AN APPROVED STANDARD BRAND PORTLAND CEMENT CONFORMING TO ASTM C 150.
 2. PROVIDE TYPE I NORMAL STRENGTH OR TYPE III HIGH EARLY STRENGTH.
- B. AIR ENTRAINED CEMENT
1. PROVIDE AN APPROVED STANDARD BRAND TYPE I-A PORTLAND CEMENT CONFORMING TO ASTM C 494.
- C. ALL CONCRETE FLAT WORK SHALL HAVE A MINIMUM OF 4" COMPACTED GRANULAR BEDDING.
- D. FINE AGGREGATES
1. PROVIDE FINE AGGREGATES CONFORMING TO ASTM C 33 CONSISTING OF NATURAL SAND HAVING CLEAN, HARD, STRONG, DURABLE, UNCOATED GRAINS, FREE OF INJURIOUS AMOUNTS OF DUST, LUMPS, SOFT OR FLAKY PARTICLES, SHALE, ALKALI, ORGANIC MATTER, OR OTHER DELETERIOUS SUBSTANCES.
 2. PROVIDE FINE AGGREGATES WITH A MINIMUM OF NINE PERCENT PASSING THROUGH A NO. 100 SIEVE.
 3. IN ADDITION NOT MORE THAN 45 PERCENT IS TO BE RETAINED BETWEEN ANY TWO CONSECUTIVE SIEVES.
- E. COARSE AGGREGATES
1. PROVIDE COARSE AGGREGATES CONFORMING TO ASTM C 33 CONSISTING OF CRUSHED STONE OR WASHED GRAVEL, HAVING A CLEAN, HARD, STRONG, DURABLE, UNCOATED, PARTICLE FREE FROM INJURIOUS AMOUNTS OF SOFT OR FLAKY PIECES, ALKALI, ORGANIC MATTER, OR OTHER DELETERIOUS SUBSTANCES.
 2. PROVIDE COARSE AGGREGATE WITH A MAXIMUM OF 1-1/2 INCHES, WITH A MINIMUM OF 95 PERCENT PASSING A 1-1/2 INCH SIEVE.
 3. NOT MORE THAN FIVE PERCENT IS TO PASS A NO. 4 SIEVE.
- F. WATER
1. USE CLEAN WATER FREE OF INJURIOUS AMOUNTS OF OILS, ACIDS, ALKALI, SILTS, ORGANIC MATERIALS, OR OTHER SUBSTANCES THAT MAY BE DELETERIOUS TO CONCRETE OR STEEL.
- G. ALL CONCRETE SHALL BE PLACED ON VAPOR BARRIER OF 4 MIL OR GREATER POLYETHYLENE TO ASSURE COMPLETE HYDRATION OCCURS.
- H. CONCRETE MIX DESIGN
1. REQUIRE BATCH TICKETS TO BE FURNISHED UPON DELIVERY OF THE CONCRETE TO ENSURE CONCRETE MEETS THE SPECIFICATION. CONTRACTOR TO PROVIDE PLANT BATCH CERTIFICATIONS TO OWNER'S FIELD REPRESENTATIVE.
 2. PROVIDE CONCRETE WITH A MINIMUM COMPRESSIVE STRENGTH OF 4,000 PSI AT 28 DAYS WITH A MINIMUM OF SIX BAGS (564 LBS.) OF CEMENT IN EACH CUBIC YARD OF CONCRETE CONFORMING TO ASTM C 94 FOR READY-MIXED CONCRETE. ALL CONCRETE SHALL BE CERTIFIED AS HIGH-EARLY STRENGTH, 4000 P.S.I. 28-DAY COMPRESSIVE STRENGTH READY-MIXED CONCRETE.
 3. DO NOT EXCEED THE MAXIMUM WATER CEMENT RATIO OF 0.44 (FIVE GALLONS/BAG OF CEMENT).
 4. PROVIDE CONCRETE WITH A MAXIMUM FOUR INCH SLUMP WHEN TESTED WITH A STANDARD SLUMP CONE CONFORMING TO ASTM C 143. SLUMP SHALL BE 4-5".
 - a. IF CONCRETE DEVELOPS CONSISTENCY OF DIFFICULT WORKABILITY, THEN A SUPER PLASTICIZER ADMIXTURE MAY BE USED WHEN APPROVED BY MURPHY OIL USA, INC.
 - b. DO NOT ADD WATER TO INCREASE SLUMP.
 5. CALCIUM CHLORIDE SHALL NOT BE USED.
 6. CURING COMPOUND TO BE MASTER BUILDERS' MASTERKURE OR TAMS INDUSTRIES' TRI-DOR 44, APPLIED PER MANUFACTURER'S SPECIFICATIONS.
- I. PROVIDE AIR ENTRAINED CONCRETE FOR ALL CONCRETE TO BE FINISHED INCLUDING FOUNDATIONS, WALKS, PAVEMENTS, AND RETAINING WALLS.
1. AIR ENTRAINED IS TO BE A MINIMUM OF FIVE PERCENT AND MAXIMUM OF SEVEN PERCENT BY VOLUME.
 2. MEASURE THE AIR CONTENT AT THE POINT OF DISCHARGE INTO FORMS.
- J. PLACING CONCRETE
1. MIX AND PLACE CONCRETE FOLLOWING ACI 318 "BUILDING CODE REQUIREMENTS FOR REINFORCED CONCRETE".
 2. SCHEDULE CONCRETING THAT ONCE STARTED REMAINS A CONTINUOUS OPERATION UNTIL THE PARTICULAR SECTION OR PANEL HAS BEEN COMPLETED.
 3. PROVIDE CONSTRUCTION JOINTS AS INDICATED.
 4. DEPOSIT CONCRETE INTO THE FINAL POSITION AT THE SPECIFIED SLUMPS WITHOUT SEGREGATION BY RE-HANDLING OR FLOWING.
 - a. DEPOSIT CONCRETE AT A RATE THAT CONCRETE REMAINS PLASTIC AND FLOWABLE INTO THE SPACES BETWEEN THE REINFORCING BARS.
 - b. DO NOT DEPOSIT FRESH CONCRETE ON CONCRETE THAT HAS HARDENED SUFFICIENTLY TO CAUSE FORMATION OF SEAMS OR PLANES OF WEAKNESS WITH THE SECTION OR PANEL.
 - c. DO NOT DEPOSIT PARTIALLY HARDENED CONCRETE OR CONCRETE THAT HAS BEEN CONTAMINATED BY FOREIGN MATERIALS.
 - d. DO NOT RE-TEMPER CONCRETE.
 5. THOROUGHLY COMPACT CONCRETE BY MEANS OF MECHANICAL VIBRATORS SUPERVISED BY EXPERIENCED PERSONNEL.
 - a. PROVIDE SUFFICIENT VIBRATION INTENSITY TO CAUSE FLOW OR SETTLEMENT AROUND REINFORCEMENT, EMBEDDED ITEMS, AND CORNERS OF THE FORMS; BUT NOT LONG ENOUGH TO CAUSE SEGREGATION OF THE MIX.
 - b. SUPPLEMENT MECHANICAL VIBRATION BY HAND SPADING IN CORNERS AND ANGLES OF THE FORMS AND ALONG FORM SURFACES WHILE THE CONCRETE IS PLASTIC TO ENSURE EVEN DENSE SURFACES FREE FROM AGGREGATE POCKETS OR HONEYCOMBS.
 6. PROTECT CONCRETE FROM EXCESSIVE HEAT AND PREMATURE DRYING BY THE USE OF KRAFT PAPER AND WATER MIST.
 7. COAT CONCRETE AFTER ALL FINISHING IS COMPLETE USING THE SPECIFIED CURATIVE AGENTS.
 8. IF SAW CUTTING IS EMPLOYED, IT MUST OCCUR FROM 8-12 HOURS AFTER INITIAL SET. a) SPALLING DUE TO SAW CUTTING ACTIONS MAY RESULT IN REJECTION OF THE CONCRETE WORK.
- K. COLD WEATHER REQUIREMENTS
1. FOLLOW THE REQUIREMENTS OF ACI 306.1-90 AND THE FOLLOWING
 - a. REFER TO: "RECOMMENDED PRACTICES FOR COLD WEATHER MASONRY CONSTRUCTION" AS PUBLISHED BY INTERNATIONAL MASONRY INDUSTRY ALL WEATHER COUNCIL FOR TYPICAL COLD WEATHER MASONRY PRACTICES TO BE FOLLOWED.
 - b. PROVIDE ADEQUATE EQUIPMENT FOR HEATING CONCRETE MATERIALS, AND FOR PROTECTION OF THE CONCRETE DURING FREEZING OR NEAR FREEZING WEATHER.
 - c. MAINTAIN CONCRETE MATERIALS, REINFORCEMENT, FORM WORK, FILLEES, AND GROUND TO BE IN CONTACT WITH THE CONCRETE FREE OF FROST. DO NOT USE FROZEN MATERIALS OR MATERIALS CONTAINING ICE.
 - d. PROVIDE CONCRETE, DELIVERED IN COLD WEATHER, WITH THE FOLLOWING TEMPERATURES AIR TEM MIN. CONCRETE TEMP. 30-40 F 60 F 0-30 F 65 F BELOW 0 F 70 F
 - e. WHEN PRODUCING CONCRETE WITH HEATED AGGREGATES, HEATED WATER OR BOTH, DO NOT ALLOW CONCRETE TO EXCEED 90F DURING PRODUCTION OR TRANSPORTATION.
 - f. ALL CONCRETE SLABS PLACED AT AIR TEMPERATURES FROM 20F TO 50F MAY HAVE AN ACCELERATING WATER REDUCING ADMIXTURE ADDITIVE ADDED TO ACCELERATE SETTING TIME AND STRENGTH ADMIXTURE COMPLYING WITH ASTM C 494, TYPE C.
 1. ACCEPTABLE ADMIXTURES ARE EUCLID CHEMICAL COMPANY'S "ACCELGARD 90", OR EQUAL PRODUCTS BY W.R. MEADOWS, INC. OR W.R. GRACE & CO.
 - (a) ADD ACCELGARD 80 W./ WATER & AGGREGATE TO THE READY MIX CONCRETE TRUCK, BUT DO NOT DISPENSE ONTO DRY CONCRETE.
 - (b) FOR TEMPERATURES 32° F - 60° F, ADD AT A RATE OF 160Z./100 LBS. OF CONCRETE.
 - (c) FOR TEMPERATURES BELOW 32° F, HEAT AGGREGATE AND USE WARM WATER SO THAT WHEN MIXED CONCRETE TEMPERATURE WILL BE ABOVE 60°.
 2. FOLLOW THE MANUFACTURER'S INSTRUCTION FOR THE QUANTITY TO BE ADDED TO THE CONCRETE MIX, DEPENDING UPON THE AMBIENT TEMPERATURE, DESIRED RATE OF ACCELERATION, EARLY STRENGTH GAIN, AND STRIPPING SCHEDULE. g) MAINTAIN CONCRETE ABOVE 50F IN A MOIST CONDITION FOR A MINIMUM OF SEVEN DAYS AFTER PLACEMENT FOLLOWING THE RECOMMENDATIONS OF ACI 308-92.

CONCRETE (CONTINUED)

- L. HOT WEATHER REQUIREMENTS
1. FOLLOWING THE REQUIREMENTS OF ACI 305R.
 2. DURING HOT WEATHER, TAKE STEPS TO REDUCE CONCRETE TEMPERATURE AND WATER EVAPORATION BY PROPER ATTENTION TO INGREDIENTS, PRODUCTION METHODS, HANDLING, PLACING, PROTECTION, AND CURING.
 3. THE PREFERRED PROTECTION IS A COVERING OF KRAFT PAPER, CONFORMING TO ASTM C 171, FOR A TWENTY FOUR HOUR PERIOD AFTER PLACEMENT.
- M. CONCRETE FORMWORK
1. PROVIDE DRESSED LUMBER OR MANUFACTURED FORMS CONFORMING TO THE SHAPE, LINES, AND DIMENSIONS OF CONCRETE STRUCTURES INDICATED ON THE DRAWINGS: FREE FROM DEFECTS AND SUFFICIENTLY TIGHT TO PREVENT LEAKAGE OF MORTAR.
 2. ALL WOODEN FORMS TO BE NO LESS THAN THE SPECIFIED DEPTH OF THE SLAB TO BE POURED, AND NOT LESS THAN NOMINAL 2' X 4' SIZE.
 3. STAKING FOR STRAIGHT SECTIONS SHALL OCCUR NOT LESS FREQUENTLY THAN EVERY FOUR FEET AND SHALL BE BOTH INSIDE AND OUTSIDE OF THE FORM.
 4. FOR CURVES, STAKING SHALL OCCUR NOT LESS THAN EVERY FOOT, AND SHALL BE BOTH INSIDE AND OUTSIDE OF THE FORM.
 5. STEEL FORMS SHALL BE STAKED ACCORDING TO THEIR DESIGN REQUIREMENTS.
 6. ALL REMOVABLE FORMS SHALL BE COATED WITH FORM - RELEASE OIL PRIOR TO PLACEMENT OF CONCRETE.
 7. CYLINDRICAL FORMS SHALL BE OF NEW SONOTUBE OR EQUIVALENT DISPOSABLE MATERIALS.
 - a. THESE MATERIALS MUST BE REMOVED COMPLETELY AFTER USE. ISLAND FORMS SHALL BE POSITIONED USING MASONRY BLOCKING AND STEEL STAKES BOTH INSIDE AND OUTSIDE OF THE FORM, TO ACHIEVE AN AVERAGE AS PER REVEAL HEIGHT AS MEASURED AT THE CENTER OF ANY LONG SIDE OF THE ISLAND, SEE DRAWINGS FD-1 AND FD-2
 8. THE SIDES OF THE ISLAND FORM SHALL BE SHIMMED AGAINST THE STAKES TO PROVIDE A PERFECTLY PLUMB FREEBOARD.
 9. ALL EDGES CREATED BY REMOVABLE FORMS SHALL BE TOOL-RADIUSED AFTER SURFACE FINISHING TO PROVIDE A SMOOTH BORDER ON ALL SLABS.
 10. FORMS SHALL BE REMOVED NO SOONER THAN 24 HOURS FROM THE TIME OF THE POUR.
 11. PROPERLY BRACE OR TIE FORMS TOGETHER TO MAINTAIN SHAPE AND POSITION.
 12. PROVIDE SQUARE EDGE WOOD OR, IF AVAILABLE, METAL FORMS FOR FLOOR SLABS.
 13. BEFORE POURING CONCRETE, REMOVE ALL DEBRIS FROM THE FORMWORK.
 14. WET DOWN FORMWORK PRIOR TO PLACEMENT, OR APPLY A FORM RELEASE AGENT FOLLOWING MANUFACTURER'S RECOMMENDATIONS.
 15. DO NOT REMOVE FORMWORK AND BRACING UNTIL CONCRETE HAS GAINED SUFFICIENT STRENGTH TO CARRY ITS OWN WEIGHT, CONSTRUCTION LOADS, AND DESIGN LOADS WHICH ARE LIABLE TO BE IMPOSED ON IT.
 16. REMOVE FORMS IN A MANNER TO ASSURE THE COMPLETE SAFETY OF THE STRUCTURE.
 17. DO NOT PLACE ANY CONCRETE IF THE SUB GRADE HAS STANDING WATER OR IS MUDDY.
- N. STEEL REINFORCEMENT
1. PROVIDE REINFORCING BARS CONFORMING TO ASTM A 615, GRADE 60 FREE OF LOOSE FLAKY RUST, MUD, OIL, OR OTHER COATINGS WHICH WILL ADVERSELY AFFECT BONDING CAPACITY.
 2. PLACE REINFORCEMENT ACCURATELY AND ADEQUATELY SUPPORTED BY CONCRETE MASONRY UNITS OR OTHER APPROVED SPACERS.
 3. SECURE REINFORCEMENT AGAINST DISPLACEMENT WITHIN TOLERANCES SPECIFIED IN "BUILDING CODE REQUIREMENTS FOR REINFORCED CONCRETE" (ACI 318).
 4. HOLD BARS IN PLACE USING A MINIMUM 18 GAUGE ANNEALED IRON WIRE.
 5. SPLICES IN DEFORMED REINFORCING BARS WILL NOT BE PERMITTED UNLESS APPROVED BY MURPHY OIL USA, INC.
 6. REINFORCING ROD TO COMPLY WITH ASTM 615, GRADE 60.
- O. ALTERNATE WELDED WIRE FABRIC REINFORCEMENT
1. ONLY WHEN INDICATED ON THE DRAWINGS, PROVIDE WELDED WIRE FABRIC CONFORMING TO ASTM A 185 FOR 6X6 W2.9 X W2.9 IN FLAT SHEETS UNLESS OTHERWISE INDICATED.
 2. INSTALL WELDED WIRE FABRIC IN LENGTHS AS LONG AS PRACTICAL.
 3. THE MINIMUM OVERLAP LENGTH, MEASURED BETWEEN OUTERMOST CROSS WIRES OF EACH FABRIC SHEET, IS NOT TO BE LESS THAN ONE SPACING OF CROSS WIRES PLUS TWO INCHES.
- P. FOUNDATIONS
1. PROVIDE SMOOTH FINISH AT ALL EXPOSED SURFACES.
 2. CONSTRUCT CORNERS WITH A ONE INCH CHAMFER.
 3. INCREASE THE DEPTH OF FOUNDATIONS, IF REQUIRED BY FROST LINE CONDITIONS OR BY LOCAL CODES.
 4. OBTAIN MURPHY OIL USA, INC. APPROVAL OF ADDITIONAL DEPTH REQUIREMENTS BEFORE PLACING CONCRETE.
 5. CONSTRUCT TOP ELEVATION OF FOUNDATIONS TO WITHIN +1/4 INCH OF THE ELEVATION INDICATED ON THE DRAWINGS. 6. INSTALL ANCHOR BOLTS WITH A HORIZONTAL TOLERANCE OF +1/8 INCH AND A VERTICAL ALIGNMENT OF +1/8 INCH OUT OF PLUMB.
- Q. GROUT
1. PROVIDE NON-METALLIC, NON-SHRINK, PREMIXED NON-STAINING GROUT CONTAINING SELECTED SILICA SANDS, ASTM C 150 TYPE I PORTLAND CEMENT, AND SHRINKAGE COMPENSATING AGENTS.
 2. ACCEPTABLE PRODUCTS ARE "EMBECCO" BY MASTER BUILDERS AND "FIVE STAR GROUT" BY U.S. GROUT CORPORATION.

MURPHY OIL USA, INC.

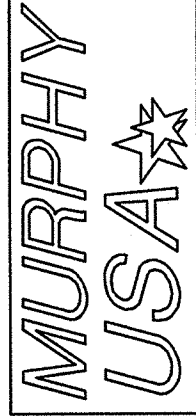


200 PEACH STREET
EL DORADO, AR 71730

GreenbergFarrow

1430 W. PEACHTREE ST. NW SUITE 200
ATLANTA, GA 30309
PHONE (404) 525-0000
FAX (404) 525-0070
DWC NAME: ALBUQUERQUE, NM
JOB NO.: 20160697.0

DETAILS
MURPHY EXPRESS
3751 HIGHWAY 528 NW
ALBUQUERQUE NEW MEXICO

REV-0	DATE	IN	DS	DS	DS	DRW
	08-23-17	PRN	PM	DES		

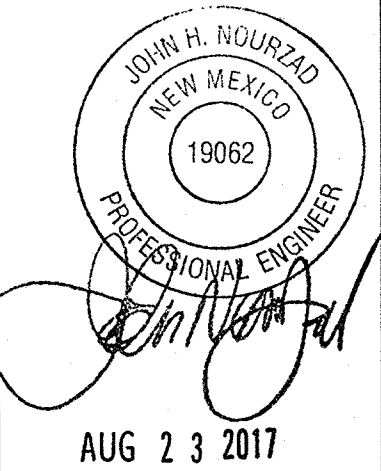

SHEET NO.
C-17

