

CITY OF ALBUQUERQUE

Planning Department
Alan Varela, Interim Director



Mayor Timothy M. Keller

February 1, 2022

Ronald Bohannon, P.E.
Tierra West, LLC
5571 Midway Park Place NE
Albuquerque, NM 87109

**RE: Dutch Brothers - 528
3615 Hwy 528 NW
Grading & Drainage Plans
Engineer's Stamp Date: 01/31/22
Hydrology File: A14D019**

Dear Mr. Bohannon:

PO Box 1293

Based upon the information provided in your submittal received 10/14/2021, the Grading & Drainage Plan is approved for Building Permit, Grading Permit, and for action by the DRB on Site Plan for Building Permit. Please attach a copy of this approved plan in the construction sets for Building Permit processing along with a copy of this letter.

Albuquerque

PRIOR TO CERTIFICATE OF OCCUPANCY:

NM 87103

1. Engineer's Certification, per the DPM Part 6-14 (F): *Engineer's Certification Checklist For Non-Subdivision* is required.
2. Please provide the Drainage Covenant with Exhibit A for the stormwater quality pond per Article 6-15(C) of the DPM prior to Permanent Release of Occupancy. Please submit the original copies along with the \$ 25.00 recording fee check made payable to Bernalillo County to Marion G. Velasquez (mgvelasquez@cabq.gov) on the 4th floor of Plaza de Sol.
3. Please provide a private Drainage Easement for the stormwater quality pond. Please submit the original copies along with the \$ 25.00 recording fee check made payable to Bernalillo County to Marion G. Velasquez (mgvelasquez@cabq.gov) on the 4th floor of Plaza de Sol.

www.cabq.gov

As a reminder, if the project total area of disturbance (including the staging area and any work within the adjacent Right-of-Way) is 1 acre or more, then an Erosion and Sediment Control (ESC) Plan and Owner's certified Notice of Intent (NOI) is required to be submitted to the Stormwater Quality Engineer (Doug Hughes, PE, jhughes@cabq.gov, 924-3420) 14 days prior to any earth disturbance.

CITY OF ALBUQUERQUE

Planning Department
Alan Varela, Interim Director



Mayor Timothy M. Keller

If you have any questions, please contact me at 924-3995 or rbrissette@cabq.gov.

Sincerely,

Renée C. Brissette

Renée C. Brissette, P.E. CFM
Senior Engineer, Hydrology
Planning Department

PO Box 1293

Albuquerque

NM 87103

www.cabq.gov



City of Albuquerque

Planning Department
Development & Building Services Division

DRAINAGE AND TRANSPORTATION INFORMATION SHEET (REV 6/2018)

Project Title: Dutch Brothers -528 **Building Permit #:** _____ **Hydrology File #:** A14D019
DRB#: PR-2021-005222 **EPC#:** PR-2021-005301 **Work Order#:** _____
Legal Description: Lots(s) Tract C-4-A Plat of Tracts C3A, C2B, C3C, & C4A Seven Bar Ranch
City Address: 3615 Hwy 528 NW Albuquerque, NM 87114

Applicant: Tierra West, LLC **Contact:** Luis Noriega
Address: 5571 Midway Park Place NE Albuquerque NM 87109
Phone#: 505-858-3100 **Fax#:** 505-858-1118 **E-mail:** lnoriega@tierrawestllc.com

Other Contact: _____ **Contact:** _____
Address: _____
Phone#: _____ **Fax#:** _____ **E-mail:** _____

TYPE OF DEVELOPMENT: _____ PLAT (# of lots) _____ RESIDENCE _____ DRB SITE ☒ ADMIN SITE

IS THIS A RESUBMITTAL? _____ Yes ☒ No

DEPARTMENT _____ TRANSPORTATION ☒ HYDROLOGY/DRAINAGE

Check all that Apply:

TYPE OF SUBMITTAL:

_____ ENGINEER/ARCHITECT CERTIFICATION
_____ PAD CERTIFICATION
_____ CONCEPTUAL G & D PLAN
☒ GRADING PLAN
_____ DRAINAGE REPORT
_____ DRAINAGE MASTER PLAN
_____ FLOODPLAIN DEVELOPMENT PERMIT APPLIC
_____ ELEVATION CERTIFICATE
_____ CLOMR/LOMR
_____ TRAFFIC CIRCULATION LAYOUT (TCL)
_____ TRAFFIC IMPACT STUDY (TIS)
_____ STREET LIGHT LAYOUT
_____ OTHER (SPECIFY) _____
_____ PRE-DESIGN MEETING?

TYPE OF APPROVAL/ACCEPTANCE SOUGHT:


☒ BUILDING PERMIT APPROVAL
_____ CERTIFICATE OF OCCUPANCY
_____ PRELIMINARY PLAT APPROVAL
_____ SITE PLAN FOR SUB'D APPROVAL
☒ SITE PLAN FOR BLDG. PERMIT APPROVAL
_____ FINAL PLAT APPROVAL
_____ SIA/ RELEASE OF FINANCIAL GUARANTEE
_____ FOUNDATION PERMIT APPROVAL
_____ GRADING PERMIT APPROVAL
_____ SO-19 APPROVAL
_____ PAVING PERMIT APPROVAL
_____ GRADING/ PAD CERTIFICATION
_____ WORK ORDER APPROVAL
_____ CLOMR/LOMR
_____ FLOODPLAIN DEVELOPMENT PERMIT
_____ OTHER (SPECIFY) _____

DATE SUBMITTED: 10/14/2021 **By:** Luis Noriega

COA STAFF:

ELECTRONIC SUBMITTAL RECEIVED: _____

FEE PAID: _____

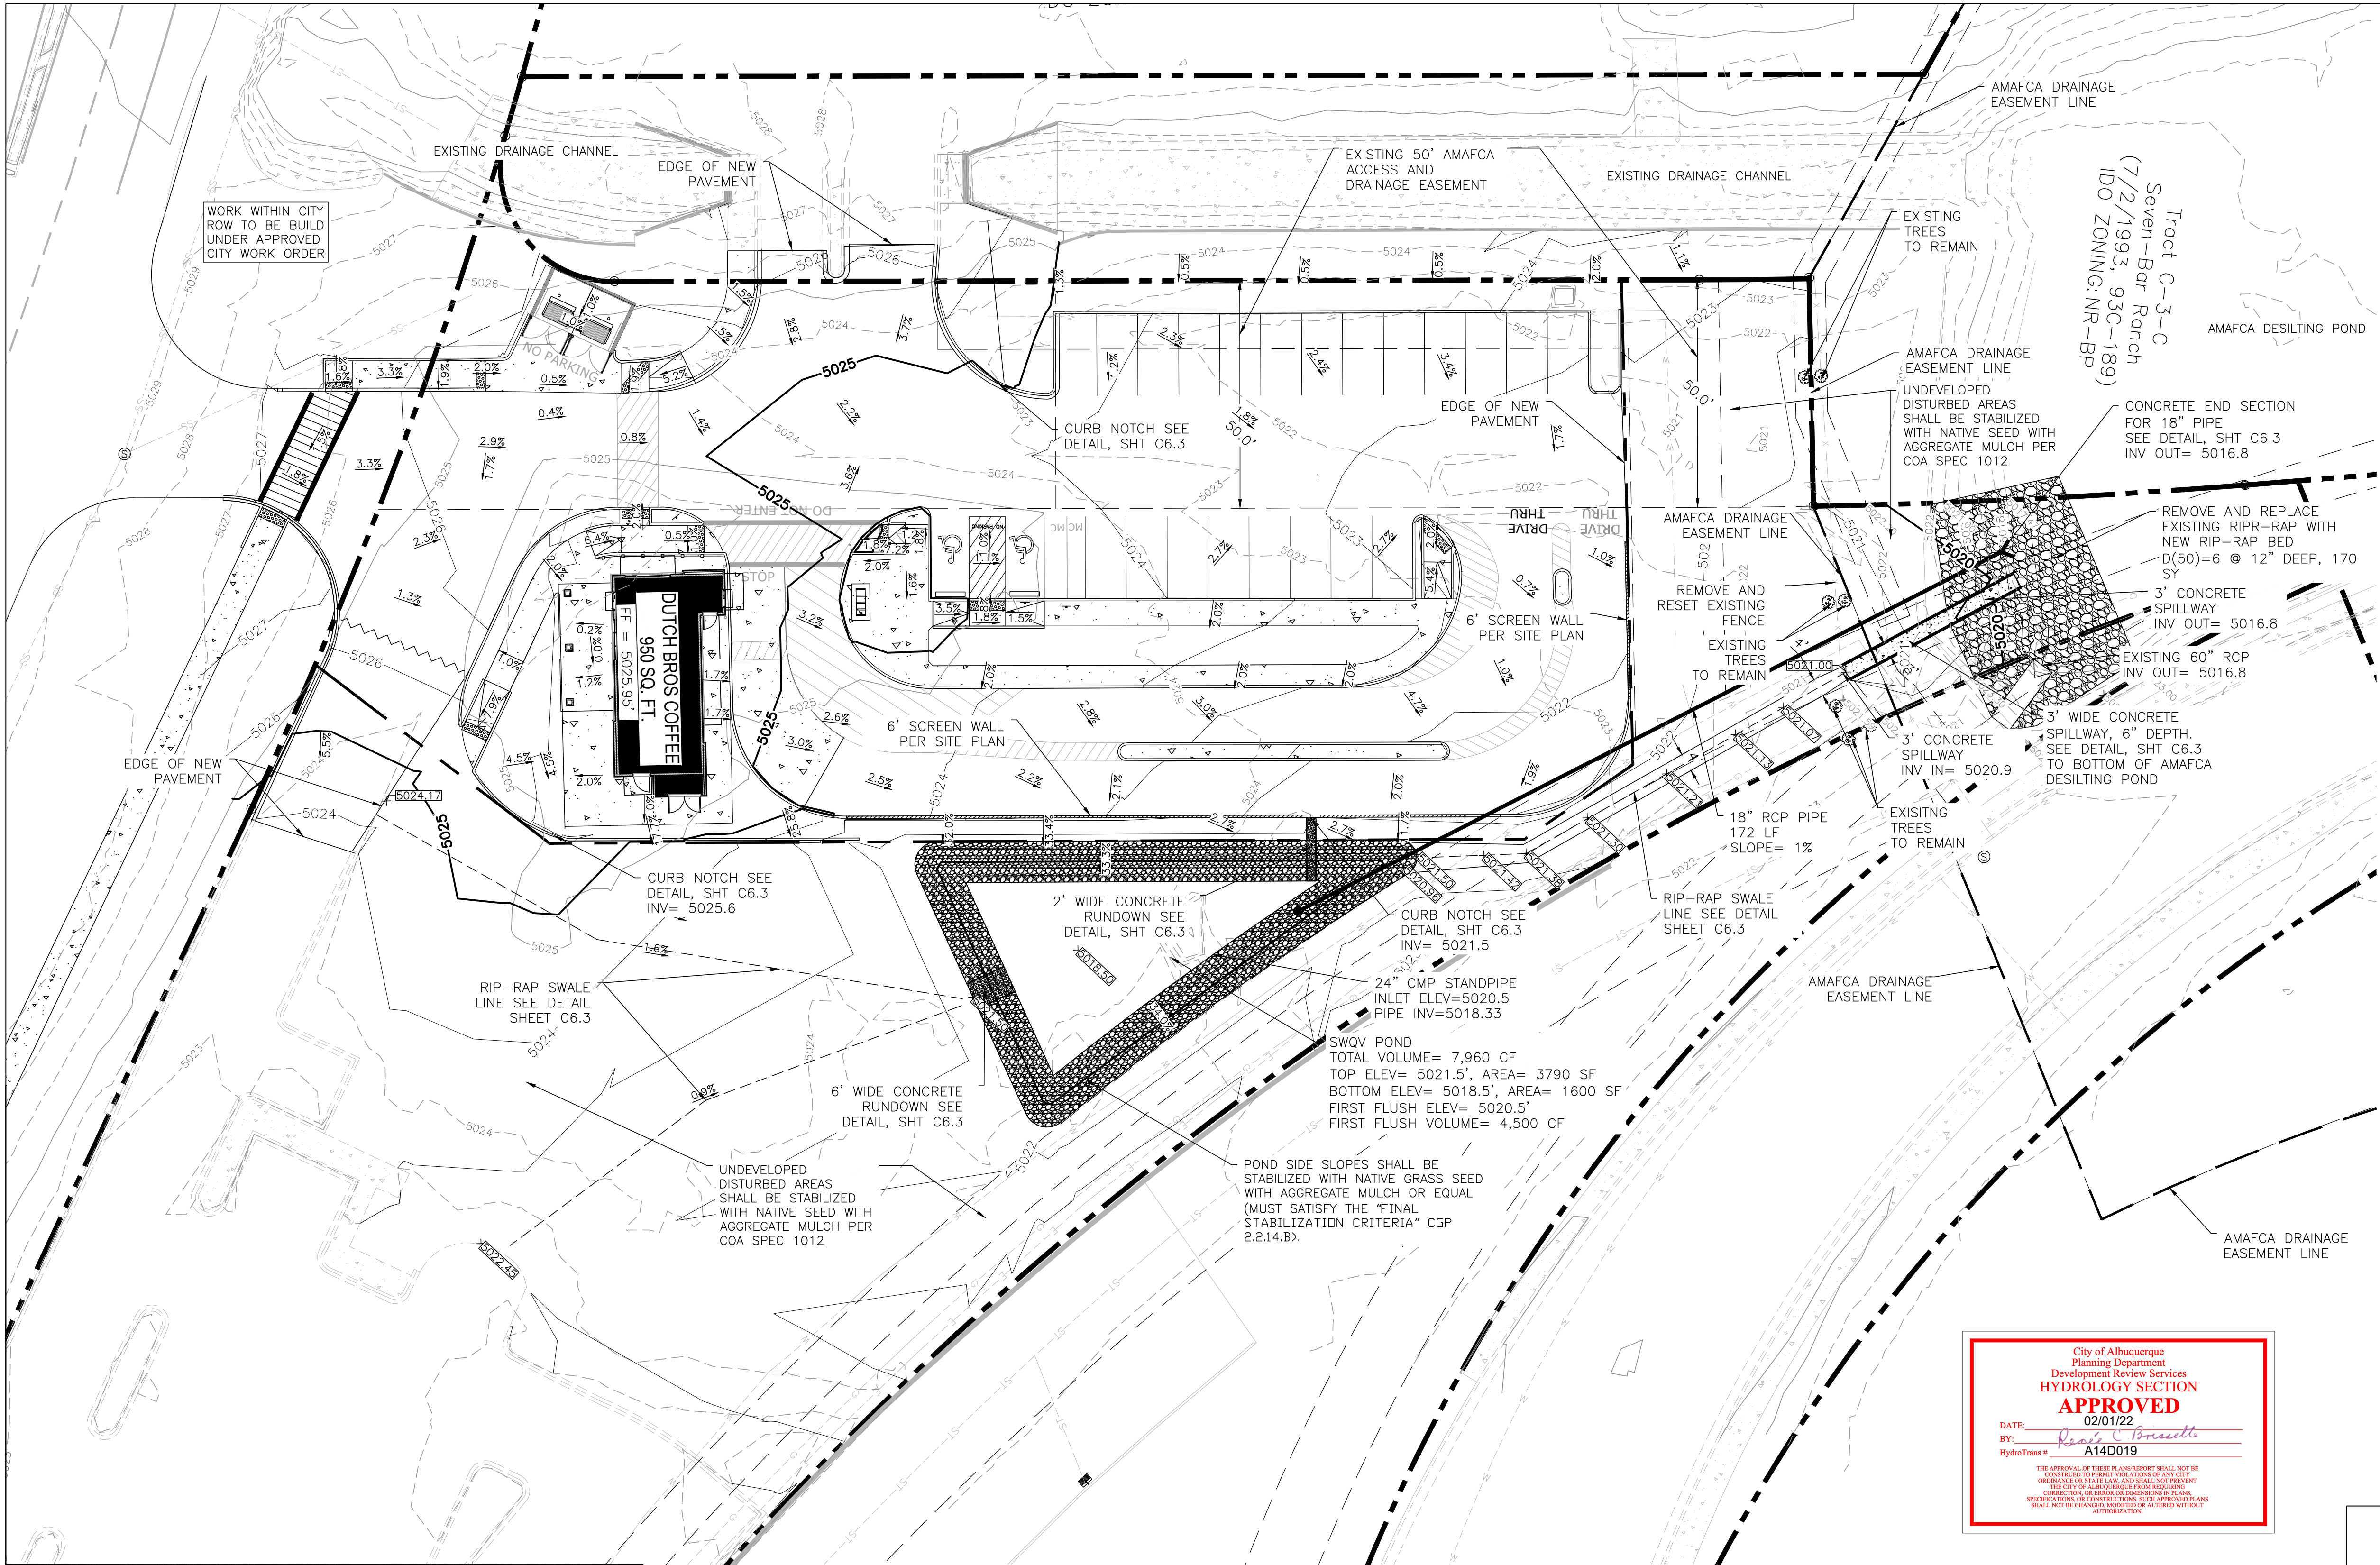


LEGEND

- CURB & GUTTER
- BOUNDARY LINE
- EASEMENT
- SIDEWALK
- BUILDING
- SCREEN WALL
- 5010 CONTOUR MAJOR
- 5011 CONTOUR MINOR
- SPOT ELEVATION
- FLOW ARROW
- GRADE BREAK
- EXISTING CURB & GUTTER
- EXISTING EASEMENT
- EXISTING BOUNDARY LINE
- EXISTING RETAINING WALL
- EXISTING CONCRETE
- EXISTING CONTOUR MAJOR
- EXISTING CONTOUR MINOR
- EXISTING STORM DRAIN LINE
- SPOT ELEVATION
- EXISTING STORM DRAIN MH
- EXISTING STORM DRAIN INLET
- SURVEY MONUMENT
- EXISTING TREE TO REMAIN
- RIP-RAP
- GRAVEL MULCH

SPOT ELEVATION NOTE:
ALL SPOT ELEVATIONS ARE FLOWLINE UNLESS OTHERWISE NOTED.


- AMAFCA GENERAL NOTES:**
- AMAFCA FIELD ENGINEER SHALL BE NOTIFIED 48 HOURS PRIOR TO ANY WORK WITHIN THE AMAFCA R/W. TELEPHONE (505)884-2215.
 - NO WORK SHALL BE PERFORMED IN THE AMAFCA R/W BETWEEN MAY 15 AND OCTOBER 15 WITHOUT WRITTEN PERMISSION FROM AMAFCA.
 - ALL SUB-GRADE, BACKFILL, AND EMBANKMENT SHALL BE COMPACTED TO 95% (± 2% OF OPTIMUM MOISTURE PER ASTM D-1557) WITHIN THE AMAFCA R/W. TESTING REPORTS SHALL BE PROVIDED TO AMAFCA FIELD ENGINEER.
 - AMAFCA FIELD ENGINEER SHALL BE NOTIFIED 48 HOURS PRIOR TO FINAL INSPECTION OF ANY FACILITIES WITHIN THE AMAFCA R/W.
 - ALL DISTURBED GROUND AREAS SHALL BE REVEGETATED IN ACCORDANCE WITH CITY OF ALBUQUERQUE STANDARD SPECIFICATIONS FOR PUBLIC WORKS CONSTRUCTION, SECTION 1012 NATIVE GRASS SEEDING, AS CURRENTLY UPDATED.
 - ANY MONUMENTS DISTURBED OR DESTROYED SHALL BE REPLACED BY A NM LICENSED SURVEYOR AT THE CONTRACTOR'S EXPENSE. AMAFCA SHALL BE NOTIFIED 48 HOURS PRIOR TO ANY MONUMENT PLACEMENT.
 - THE MAXIMUM WHEEL LOAD ALLOWED IN AMAFCA CHANNELS IS 12,000 POUNDS.
 - NO TRACKED VEHICLES ARE ALLOWED IN AMAFCA CHANNELS REGARDLESS OF LOCATION WITHOUT WRITTEN PERMISSION FROM AMAFCA.
 - CRANES OPERATING IN AMAFCA CHANNELS WITH OUTRIGGERS SHALL LIMIT THE OUTRIGGER FOOTPRINT LOAD AREA TO LESS THAN 12,000 POUNDS.
 - ALL CULVERT PIPE PLACED UNDER THE CHANNEL LINING OR WITHIN AMAFCA RIGHT-OF-WAY SHALL BE RCP CLASS III MIN.

DATE	APPROVED BY AMAFCA REVIEW
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- NOTICE TO CONTRACTORS**
- ALL WORK DETAILED ON THESE PLANS TO BE PERFORMED, EXCEPT AS OTHERWISE STATED OR PROVIDED HERON, SHALL BE CONSTRUCTED IN ACCORDANCE WITH THE CITY OF ALBUQUERQUE.
 - TWO WORKING DAYS PRIOR TO ANY EXCAVATION, CONTRACTOR MUST CONTACT LINE LOCATING SERVICE, FOR LOCATION OF EXISTING UTILITIES.
 - PRIOR TO CONSTRUCTION, THE CONTRACTOR SHALL EXCAVATE AND VERIFY THE HORIZONTAL AND VERTICAL LOCATIONS OF ALL CONNECTIONS. SHOULD A CONFLICT EXIST, THE CONTRACTOR SHALL NOTIFY THE ENGINEER SO THAT THE CONFLICT CAN BE RESOLVED WITH A MINIMUM AMOUNT OF DELAY.
 - BACKFILL COMPACTION SHALL BE ACCORDING TO TRAFFIC/STREET USE.
 - MAINTENANCE OF THESE FACILITIES SHALL BE THE RESPONSIBILITY OF THE OWNER OF THE PROPERTY SERVED.
 - WORK ON ARTERIAL STREETS SHALL BE PERFORMED ON A 24-HOUR BASIS.

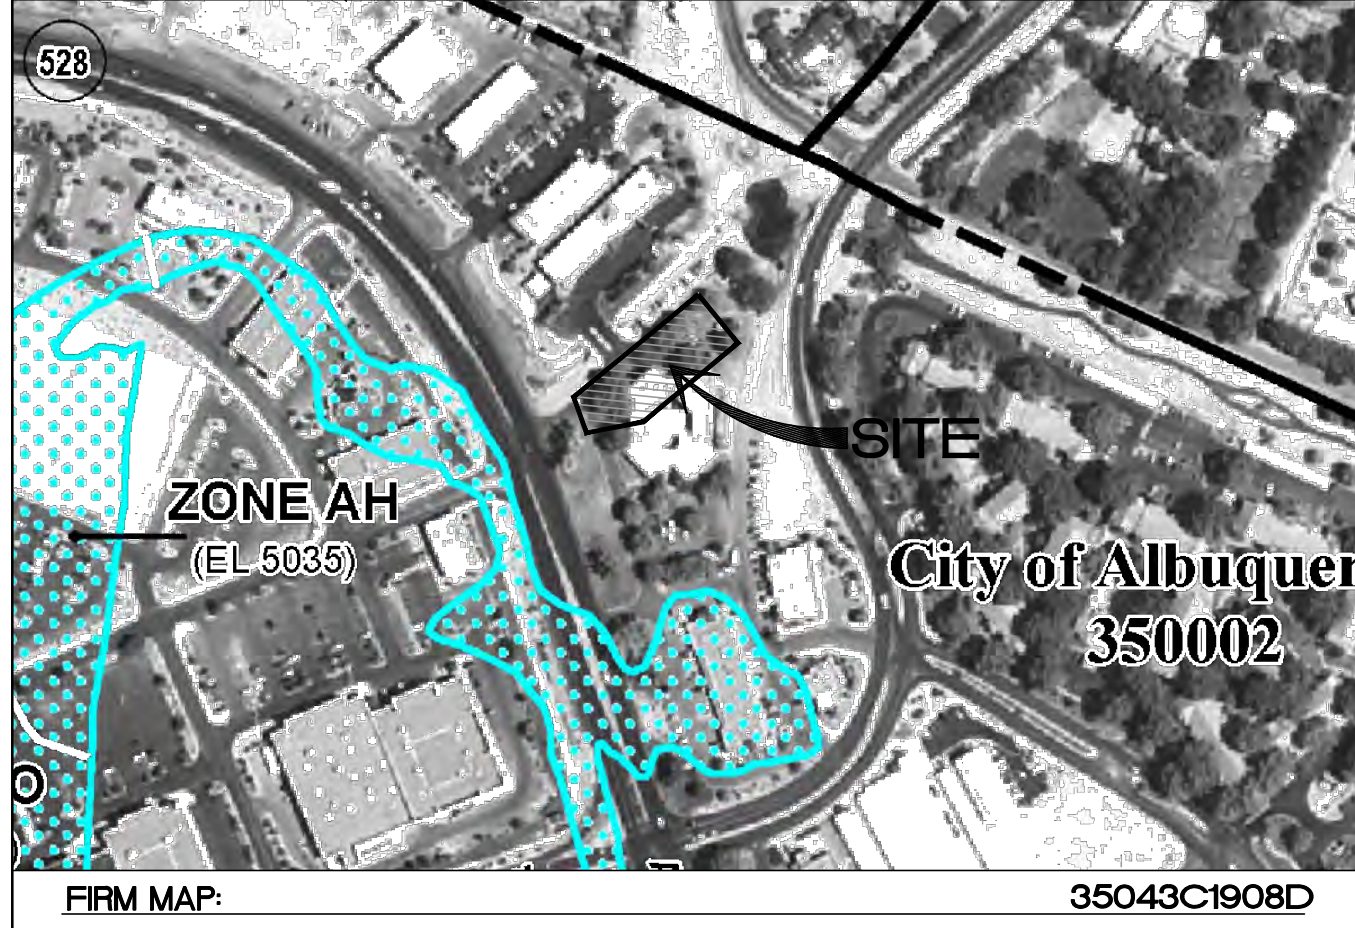- EROSION CONTROL NOTES:**
- CONTRACTOR IS RESPONSIBLE FOR MAINTAINING RUN-OFF ON SITE DURING CONSTRUCTION.
 - CONTRACTOR IS RESPONSIBLE FOR CLEANING ALL SEDIMENT THAT GETS INTO EXISTING ROADWAY.
 - REPAIR OF DAMAGED FACILITIES AND CLEANUP OF SEDIMENT ACCUMULATIONS ON ADJACENT PROPERTIES AND IN PUBLIC FACILITIES IS THE RESPONSIBILITY OF THE CONTRACTOR.
 - ALL EXPOSED EARTH SURFACES MUST BE PROTECTED FROM WIND AND WATER EROSION PRIOR TO FINAL ACCEPTANCE OF ANY PROJECT.
- CAUTION:**
ALL EXISTING UTILITIES SHOWN WERE OBTAINED FROM RESEARCH, AS-BUILTS, SURVEYS OR INFORMATION PROVIDED BY OTHERS. IT SHALL BE THE SOLE RESPONSIBILITY OF THE CONTRACTOR TO CONDUCT ALL NECESSARY FIELD INVESTIGATIONS PRIOR TO AND INCLUDING ANY EXCAVATION, TO DETERMINE THE ACTUAL LOCATION OF UTILITIES AND OTHER IMPROVEMENTS, PRIOR TO STARTING THE WORK. ANY CHANGES FROM THIS PLAN SHALL BE COORDINATED WITH AND APPROVED BY THE ENGINEER.



- NOTE:**
- REFERENCE GEOTECHNICAL REPORT CONSTRUCTION REQUIREMENTS/MINIMUMS
 - REFERENCE LANDSCAPE PLAN FOR FINAL STABILIZATION REQUIREMENTS.

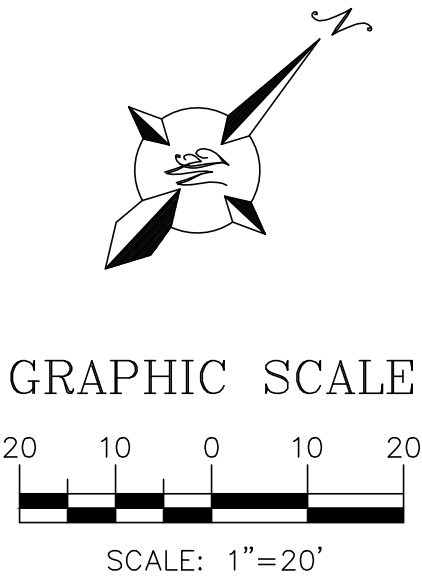

ENGINEER'S SEAL

RONALD R. BOHANNAN
NEW MEXICO
7868
PROFESSIONAL ENGINEER


01/31/2022
RONALD R. BOHANNAN
P.E. #7868

DUTCH BROS
3615 NM 528
**GRADING PLAN
OVERALL**

TIERRA WEST, LLC
5571 MIDWAY PARK PL NE
ALBUQUERQUE, NEW MEXICO 87109
(505) 858-3100
www.tierrawestllc.com

DRAWN BY
LN
DATE
10/04/2021
DRAWING
2020091-GRE
SHEET #
C3.1
JOB #
2020091

\\TNAS\Z_Drive\2020\2020091 Dutch Bros Coffee.dwg DBR 2020091-GRE.dwg Jan 31, 2022 - 9:06am

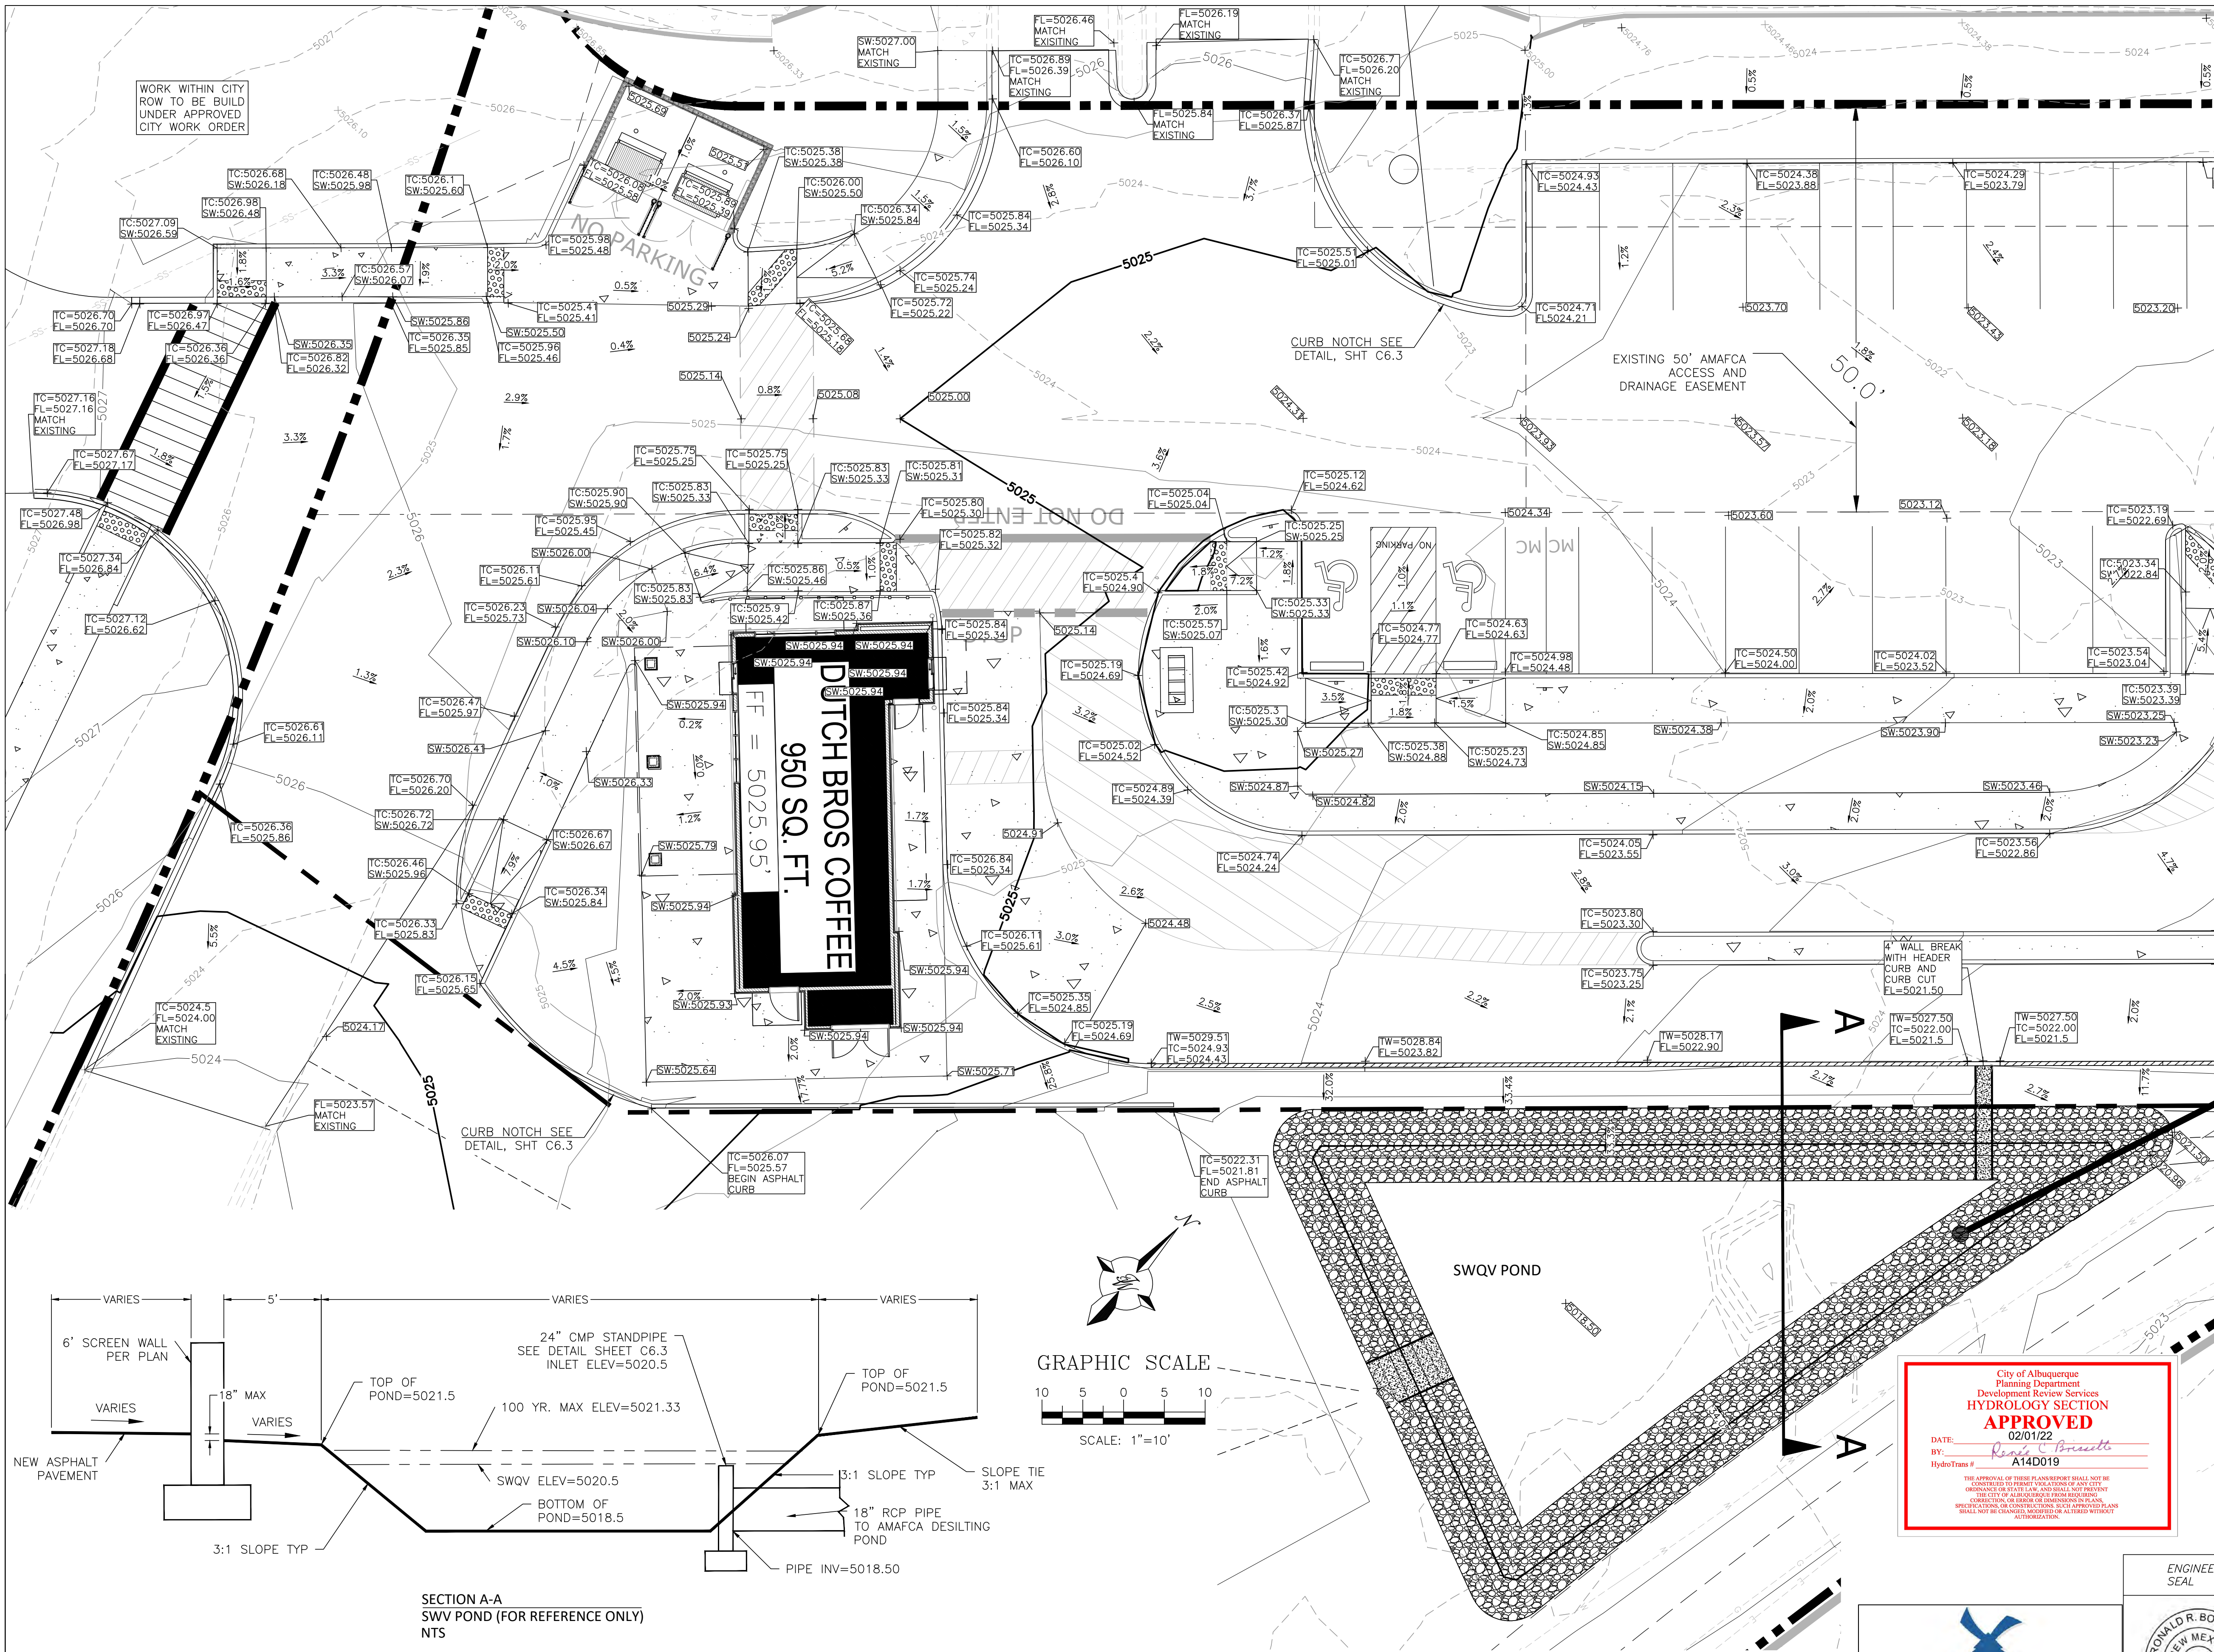

LEGEND	
	CURB & GUTTER
	BOUNDARY LINE
	EASEMENT
	SIDEWALK
	BUILDING
	SCREEN WALL
	CONTOUR MAJOR
	CONTOUR MINOR
	PROPOSED SPOT ELEVATION
	FLOW ARROW
	GRADE BREAK
	EXISTING CURB & GUTTER
	EXISTING EASEMENT
	EXISTING BOUNDARY LINE
	EXISTING RETAINING WALL
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	EXISTING SPOT ELEVATION
	EXISTING STORM DRAIN MH
	EXISTING STORM DRAIN INLET
	SURVEY MONUMENT
	EXISTING TREE TO REMAIN
	GRAVEL MULCH

MATCHLINE (SEE SHEET C3.3)

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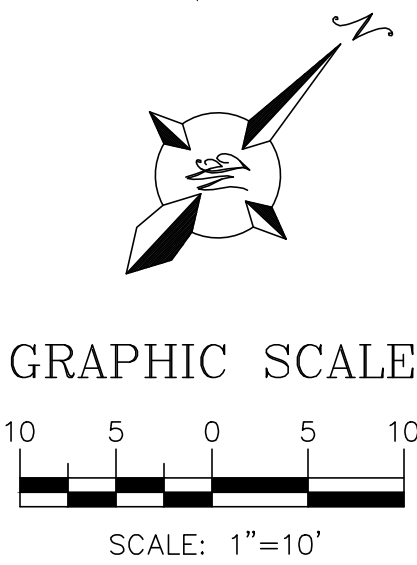
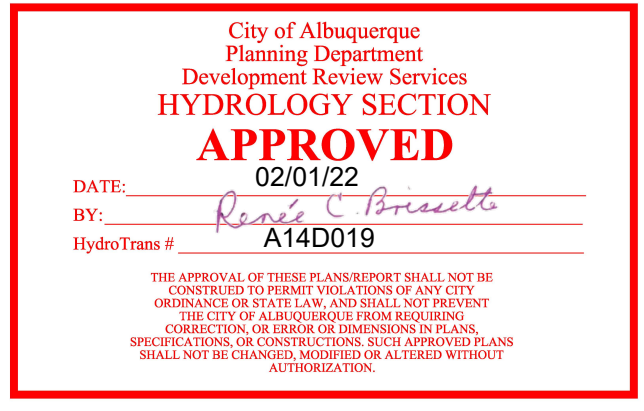
SW=TOP OF SIDEWALK
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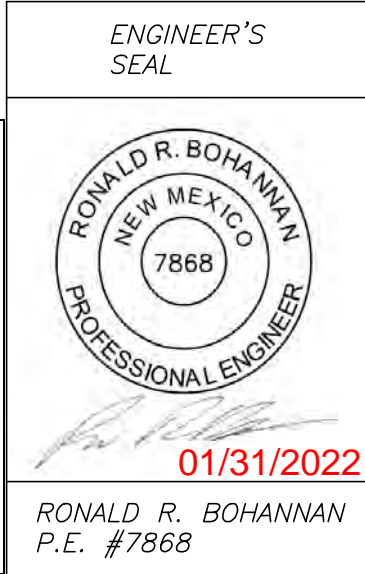
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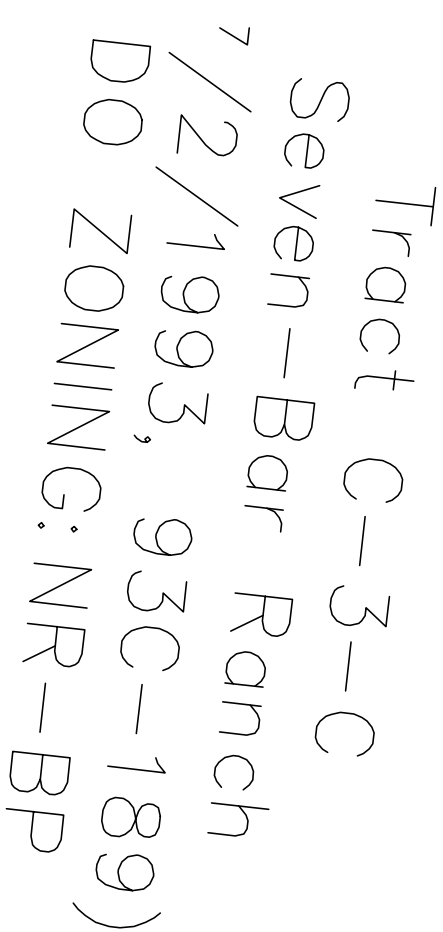


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DUTCH BROS 3615 NM 528	DRAWN BY LN
	DATE 10/04/2021
GRADING PLAN SOUTHWEST	DRAWING 2020091-GRE
	SHEET # C3.2
TERRA WEST, LLC 5571 MIDWAY PARK PL NE ALBUQUERQUE, NEW MEXICO 87109 (505) 858-3100 www.tierrowestllc.com	JOB # 2020091



- ## NOTICE TO CONTRACTORS

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DUTCH BRO'S
3615 NM 528

GRADING PLAN NORTHEAST



TIFERRA WEST LLC

5571 MIDWAY PARK PL NE
ALBUQUERQUE, NEW MEXICO 87109
(505) 858-3100
www.tierrawestllc.com

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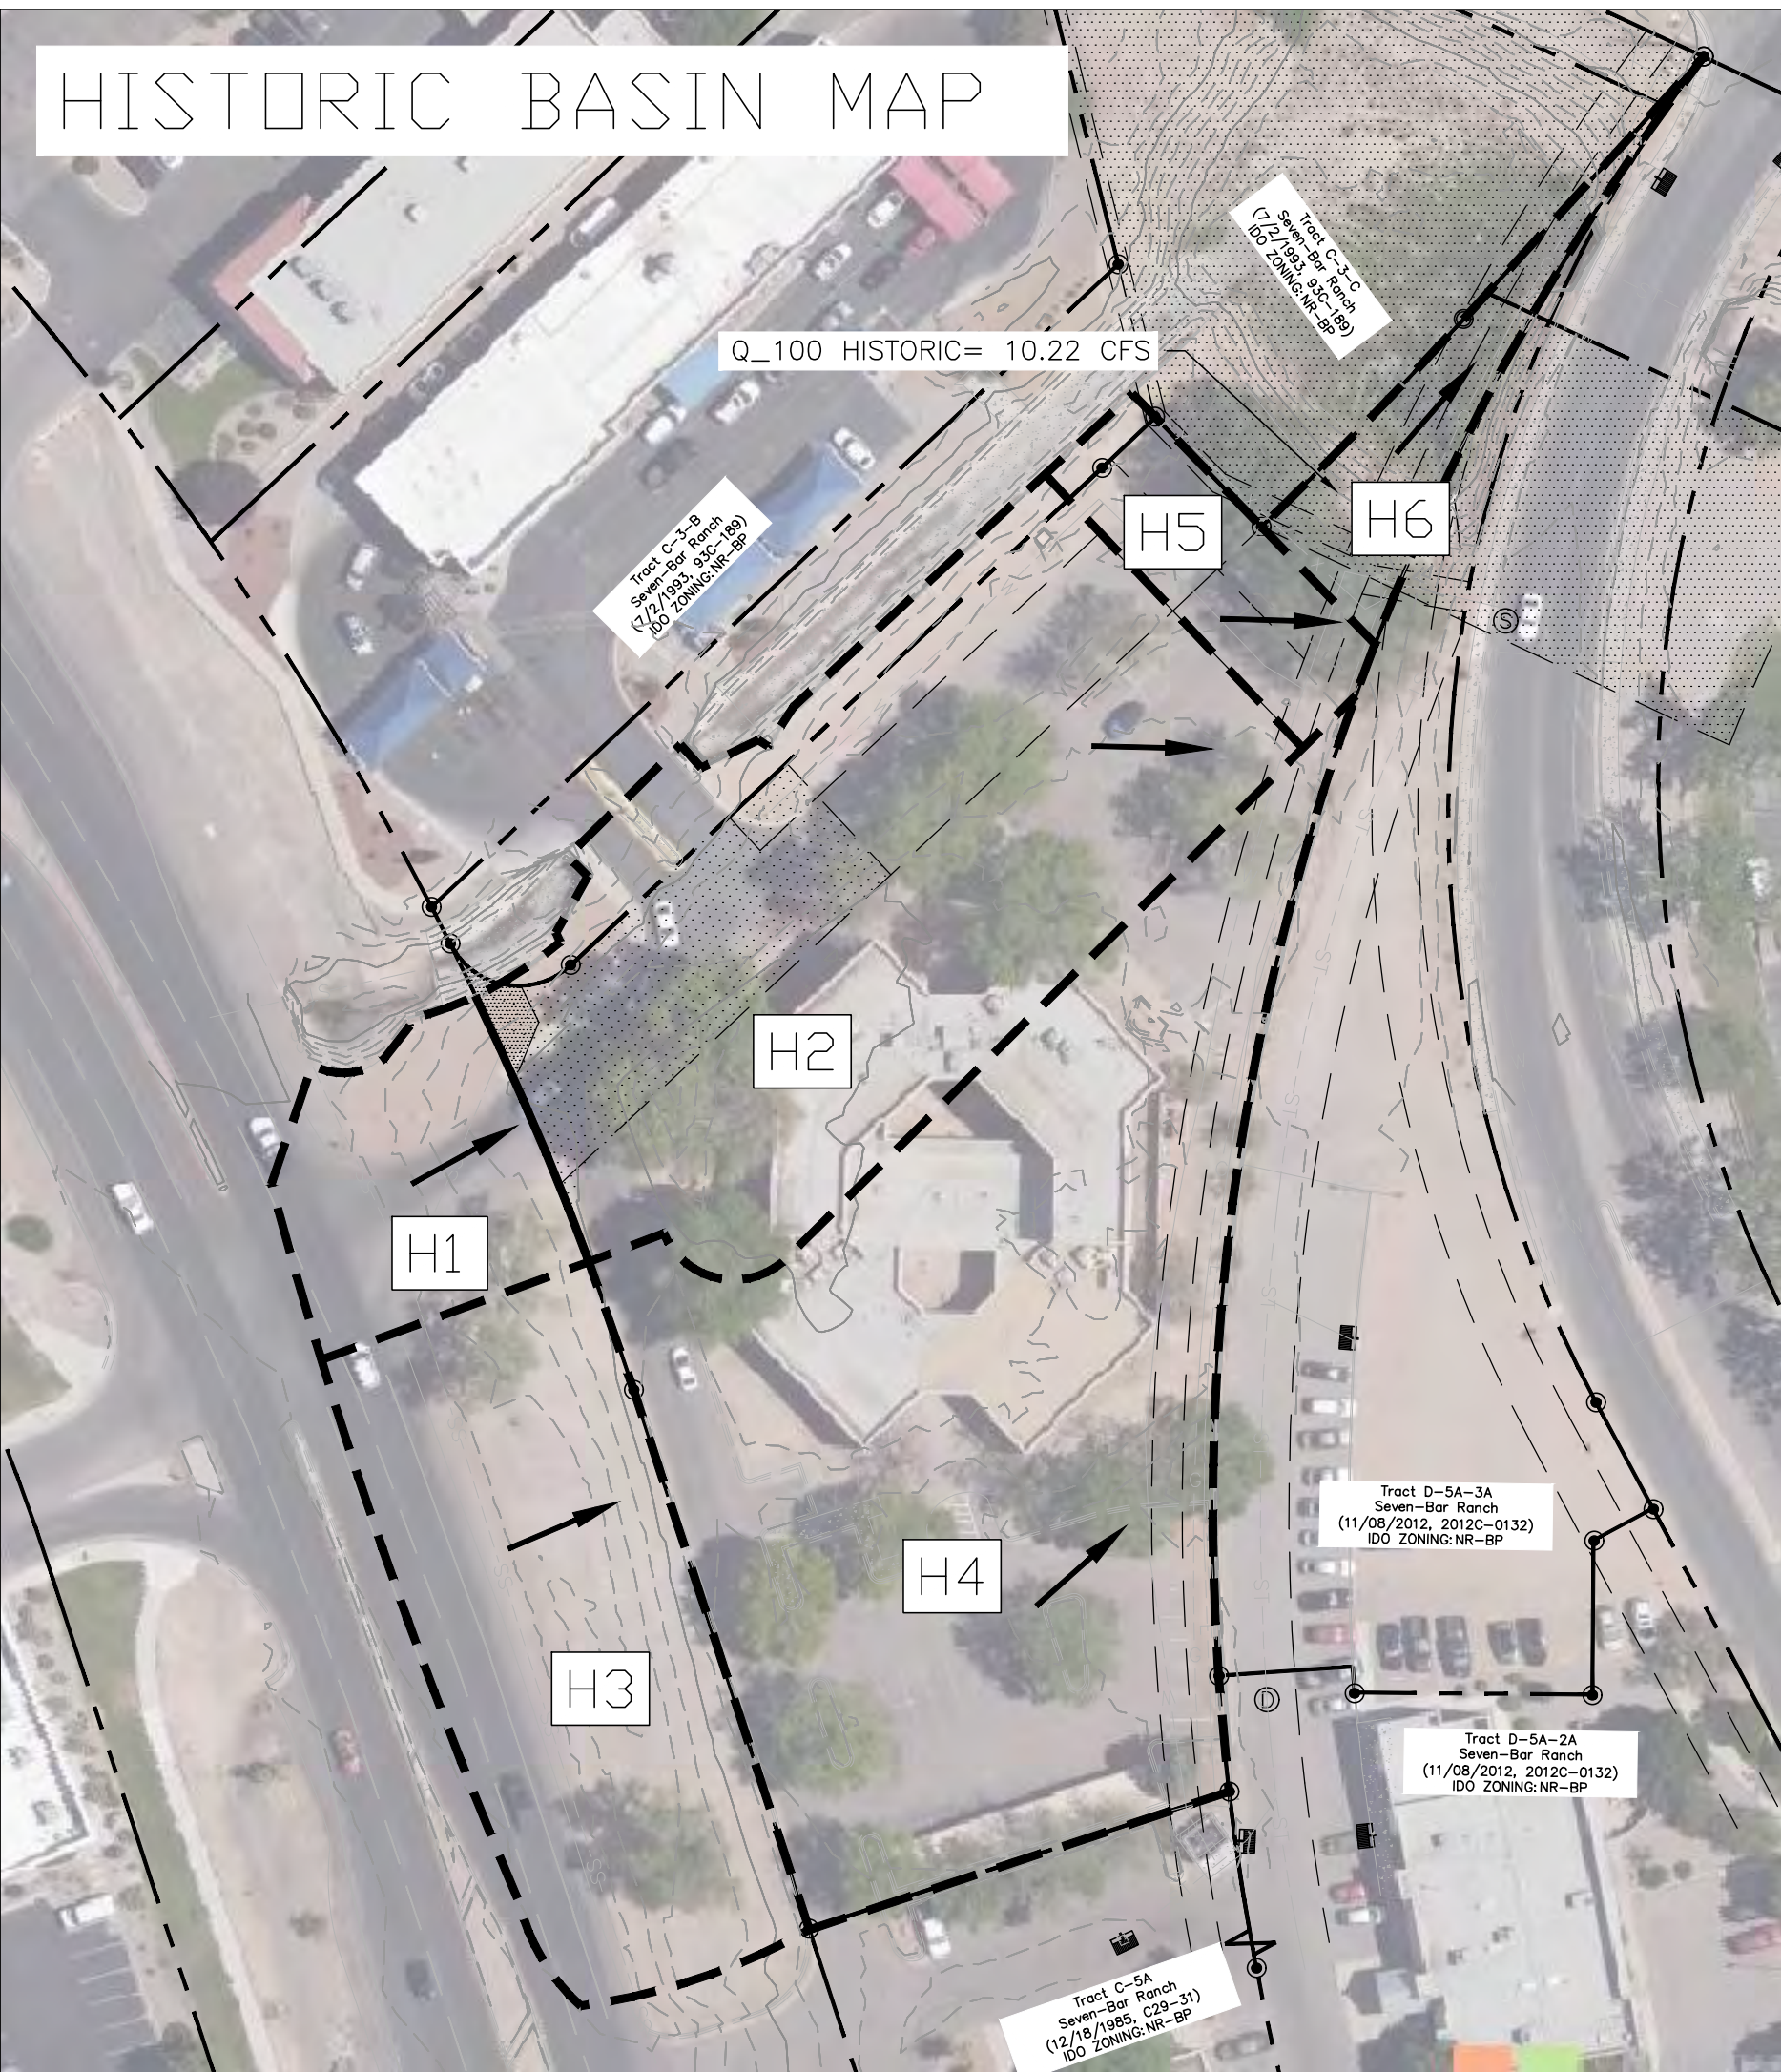
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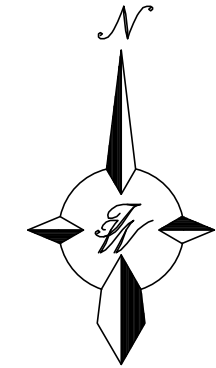
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JOB #
2020091




LEGEND

- BASIN BOUNDARY
- FLOW ARROW
- D5 BASIN NAME



GRAPHIC SCALE

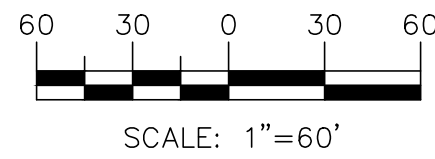

SITE INFORMATION


THE PROPOSED DEVELOPMENT IS A 1.99 ACRE MULTI-PAD COMMERCIAL DEVELOPMENT PROJECT, LOCATED AT 3615 HWY 528 ALBUQUERQUE, NM 87114. THE PROPOSED DEVELOPMENT IS LOCATED IN PRECIPITATION ZONE 1, WEST OF THE RIO GRANDE RIVER AS SPECIFIED IN THE DEVELOPMENT PROCESS MANUEL CH. 6. THE PROJECT SITE IS LOCATED WITHIN SAD 223, WHERE DRAINAGE IS COLLECTED FROM A LARGE AREA AROUND THE COTTONWOOD MALL. THE PROJECT SITE PREVIOUSLY CONTAINED A TWO STORY OFFICE BUILDING WHICH HAS SINCE BEEN DEMOLISHED AND REMOVED. THE PROJECT SITE HAS BEEN PREVIOUSLY GRADED AND IS PARTLY PAVED. THE SITE IS BORDERED BY A VARIETY OF COMMERCIAL AND RESIDENTIAL ZONE DISTRICTS. TO THE SOUTH LAYS THE INTERSECTION OF NM-528 AND ELLISON DR. TO THE NORTH THE SITE IS BORDERED BY AN AMAFCA DRAINAGE CHANNEL AND A DE-SILTING POND. THE PROPOSED SITE LIES WITHIN HYDROLOGY NUMBER A14D019 AND DOES NOT CONTAIN A FLOOD PLAIN.

EXISTING CONDITIONS

THE SITE IS CURRENTLY PARTLY PAVED WHICH INCLUDES ACCESS AISLES AND PARKING ON THE SOUTH SIDE OF THE PROPERTY. THE REMAINDER OF THE LOT REMAINS VACANT WITH GROWING VEGETATION. BASED ON THE TOPOGRAPHY, RUNOFF SURFACE FLOWS NORTH-EAST AND DISCHARGES INTO THE AMAFCA DE-SILTING POND VIA AN EXISTING ROCK SWALE, LOCATED ON THE SOUTH-EAST SIDE OF THE DE-SILTING POND. CROSS LOT DRAINAGE FROM THE NEIGHBORING LOTS IS REDUCED DUE TO EXISTING WALLS AND CURBING ALONG THE SOUTH, EASTERN AND NORTHERN PROPERTY LINE. OFFSITE DRAINAGE FROM A PORTION OF HWY NM-528'S RIGHT OF WAY FLOWS EAST INTO THE SUBJECT PROPERTY AND IS TAKEN INTO CONSIDERATION.

PROPOSED CONDITIONS

THE CONCEPTUAL GRADING AND DRAINAGE REPORT AND PLAN FOR THIS SITE HAS BEEN PREVIOUSLY APPROVED BY HYDROLOGY UNDER HYDRO NUMBER A14D019. THE DEVELOPED FLOWS WILL SURFACE FLOW INTO A STORM WATER QUALITY (SWQ) POND LOCATED ON THE EASTERN SIDE OF THE PROJECT SITE. THE SWQ POND IS DESIGNED TO RETAIN THE FIRST 0.62 INCHES OF RUNOFF. ANY FLOWS BEYOND THAT WILL BE CONVEYED INTO AN UNDERGROUND STORM DRAIN PIPE, WHICH OUTFALLS INTO THE AMAFCA DE-SILTING POND NORTH OF THE SITE. IN AN EMERGENCY SITUATION, AS THE SWQ POND REACHES MAXIMUM CAPACITY THE STORM WATER RUNOFF WILL BE ROUTED INTO AN EMERGENCY SPILLWAY WHICH DRAINS INTO THE AMAFCA DE-SILTING POND. THE EMERGENCY SPILLWAY IS A CONCRETE RUNDOWN LOCATED SOUTH-EAST OF THE DE-SILTING POND.

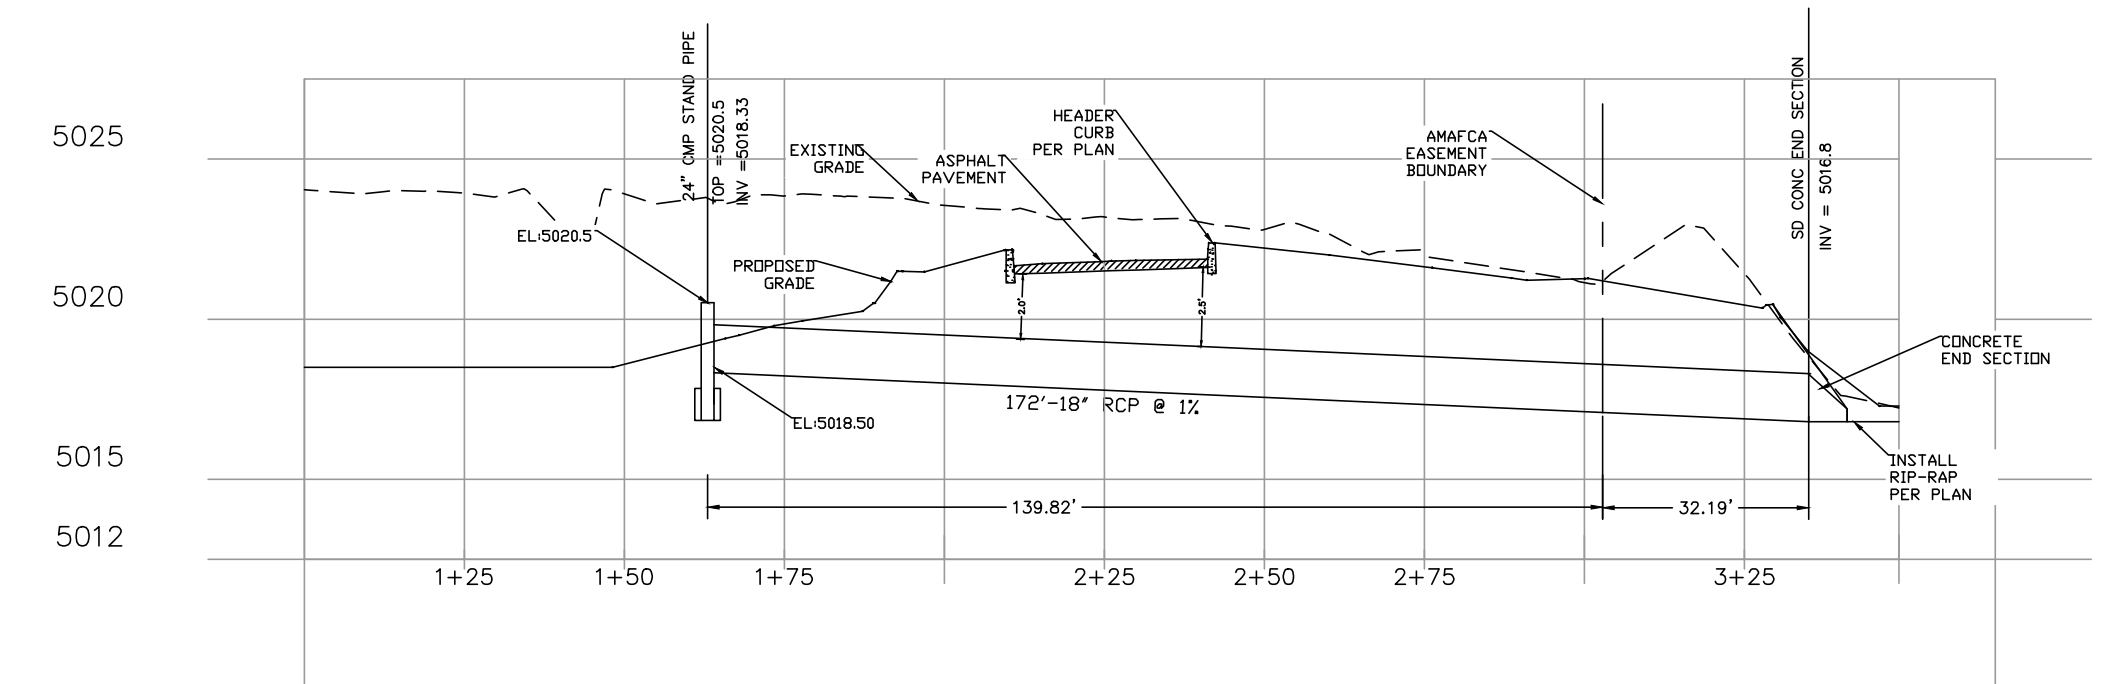

18' STORM DRAIN PROFILE
HORIZONTAL SCALE: 1"=30'
VERTICAL SCALE: 1"=6'

SWQV		
Vol Required (cf)		Provided (cf)
216		0
1,526		0
490		0
2,057		4,500
210		0
0		0
4,500		4,500

Excess Precipitation, E (in.)		
Zone 1	100-Year	10-Year
Ea	0.44	0.08
Eb	0.67	0.22
Ec	0.99	0.44
Ed	1.97	1.24

Peak Discharge (cfs/acre)		
Zone 1	100-Year	10-Year
Qa	1.29	0.24
Qb	2.03	0.76
Qc	2.87	1.49
Qd	4.37	2.89



Historic Conditions

Basin Descriptions												100-Year, 6-Hr			
Basin ID	Tract	Area (sf)	Area (acres)	Area (sq miles)	Treatment A		Treatment B		Treatment C		Treatment D		Weighted E (in)	Volume (ac-ft)	Flow cfs
H1	OFFSITE	7,634	0.18	0.00027	0%	0.000	0%	0.000	50%	0.088	50%	0.088	1.595	0.023	0.61
H2	1	34,754	0.80	0.00125	0%	0.000	0%	0.000	15%	0.120	85%	0.678	2.047	0.136	3.14
H3	OFFSITE	21,115	0.48	0.00076	0%	0.000	0%	0.000	70%	0.339	30%	0.145	1.337	0.054	1.57
H4	2	46,848	1.08	0.00168	0%	0.000	0%	0.000	15%	0.161	85%	0.914	2.047	0.183	4.23
H5	2	4,812	0.11	0.00017	0%	0.000	0%	0.000	50%	0.055	50%	0.055	1.595	0.015	0.39
H6	2	4,280	0.10	0.00015	0%	0.000	0%	0.000	100%	0.098	0%	0.000	0.950	0.008	0.28
Total		119,443	2.74	0.00428		0.000		0.000		0.861		1.881	1.835	0.419	10.22

Developed Conditions

Basin Descriptions													100-Year, 6-Hr		
Basin	Tract	Area	Area	Area	Treatment A	Treatment B		Treatment C		Treatment D		Weighted E	Volume	Flow	
ID		(sf)	(acres)	(sq miles)	%	(acres)	%	(acres)	%	(acres)	%	(acres)	(in)	(ac-ft)	cfs
D1	OFFSITE	7,634	0.18	0.00027	0%	0.000	0%	0.000	45%	0.079	55%	0.096	1.660	0.024	0.62
D2	1	34,754	0.80	0.00125	0%	0.000	5%	0.040	10%	0.080	85%	0.678	2.036	0.135	3.11
D3	OFFSITE	21,115	0.48	0.00076	0%	0.000	0%	0.000	55%	0.267	45%	0.218	1.531	0.062	1.66
D4	2	46,848	1.08	0.00168	0%	0.000	5%	0.054	10%	0.108	85%	0.914	2.036	0.182	4.19
D5	2	4,812	0.11	0.00017	0%	0.000	0%	0.000	15%	0.017	85%	0.094	2.047	0.019	0.43
D6	2	4,280	0.10	0.00015	0%	0.000	0%	0.000	100%	0.098	0%	0.000	0.950	0.008	0.28
Total		119,443	2.74	0.00428		0.000		0.094		0.648		2.001	1.884	0.430	10.304

SWQV Pond Volume Calculation		
Area at Mid Depth	2,695	Sq. Ft.
Depth of Pond	3	Ft.
Total Volume	8,085	Cubic Ft.

Equations:

Weighted E = Ea*Aa + Eb*Ab + Ec*Ac + Ed*Ad / (Total Area)

Volume = Weighted E * Total Area

Flow = Qa*Aa + Qb*Ab + Qc*Ac + Qd*Ad

Stormwater Quality Volume

Total Impervious Area =


Retention depth = 0.62" Per DPM Pg. 272


Retention Volume =

ΣArea in "Treatment D"

0.0517 foot

=0.0517 x area CF

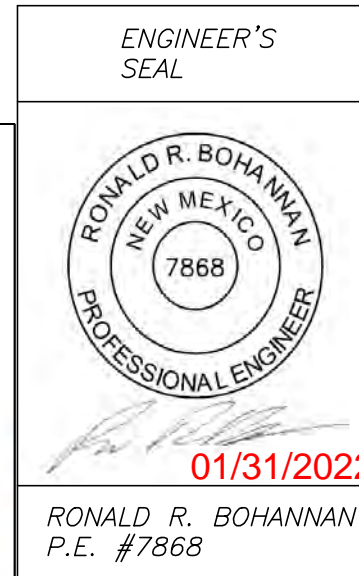

DUTCH BRO'S 3615 NM 528 DRAINAGE PLAN	DRAWN BY LN
	DATE 10/04/2021
	DRAWING 2020091--BASIN
 <i>TIERRA WEST, LLC</i> 5571 MIDWAY PARK PL NE ALBUQUERQUE, NEW MEXICO 87109 (505) 858-3100 www.tierrowestllc.com	SHEET # C4
	JOB # 2020091

