CITY OF ALBUQUERQUE

Planning Department Alan Varela, Director



Mayor Timothy M. Keller

October 20, 2022

Amanda Herrera, PE Tierra West, LLC 5571 Midway Park Pl. NE Albuquerque, NM 87109

Re: Fliz Drinks

Corner of Cottonwood Dr. and Old Airport Rd. NW Conceptual Traffic Circulation Layout for DRB Approval

Engineer's Stamp 10-19-22 (A14 D049)

Dear Ms. Herrera,

The conceptual TCL submittal received 09-14-2022 is approved for DRB submittal. When submitting this project through the building permit process, please provide a copy of the approved DRB Site plan along with a more detailed site plan for construction purposes through a second Traffic Circulation Layout submittal process. The detailed plan will be compared against the approved DRB site plan to ensure that all previously approved site infrastructure is shown with exact paving layout, dimensioning, and parking capacity. Ultimately, a copy of the approved DRB Site Plan and the more detailed stamped and signed plan will both be needed for each of the building permit plans. Please keep these originals to be used for certification of the site for final C.O. for Transportation.

Albuquerque

PO Box 1293

NM 87103

www.cabq.gov

When the site construction is completed and an inspection for Certificate of Occupancy (C.O.) is requested, use the original City stamped approved TCL for certification. Redline any minor changes and adjustments that were made in the field. A NM registered architect or engineer must stamp, sign, and date the certification TCL along with indicating that the development was built in "substantial compliance" with the TCL. Submit this certification, the TCL, and a completed <u>Drainage and Transportation Information Sheet</u> to front counter personnel for log in and evaluation by Transportation.

Once verification of certification is completed and approved, notification will be made to Building Safety to issue Final C.O. To confirm that a final C.O. has been issued, call Building Safety at 924-3690.

Sincerely,

Ernest Armijo, P.E.

Principal Engineer, Planning Dept.

Development Review Services

C: CO Clerk, File



City of Albuquerque


Planning Department

Development & Building Services Division

DRAINAGE AND TRANSPORTATION INFORMATION SHEET (REV 6/2018)

Project Title: Fiiz Drinks	Building Permit #:	Hydrology File #:	
DRB#:	EPC#:	Work Order#:	
Legal Description: TR MM-1A and MM-1B	Seven Bar Ranch		
City Address: Old Airport Rd and Cottonwoo	od DR.		
Applicant: Tierra West, LLC		Contact: Amanda Herrera	
Address: _5571 Midway Park Place NE Albuque			
Phone#: 505-858-3100 Fax#: 505-858-1118		E-mail: aherrera@tierrawestllc.com	
Other Contact: RSF Land & Cattle Company	y LLC	Contact: Casey Allman	
Address: 5740 Night Whisper Rd NW #100 A	Albuquerque, NM 87114		
Phone#: 505-803-8187	Fax#:	E-mail: caseyallman@gmail.com	
TYPE OF DEVELOPMENT:PLAT	(# of lots)RESIDENCE	DRB SITE ADMIN SITE	
IS THIS A RESUBMITTAL? Yes	X No		
DEPARTMENT X TRANSPORTATION	HYDROLOGY/DRAINAG	ΣE	
Check all that Apply: TYPE OF SUBMITTAL: ENGINEER/ARCHITECT CERTIFICATION PAD CERTIFICATION CONCEPTUAL G & D PLAN GRADING PLAN DRAINAGE REPORT DRAINAGE MASTER PLAN FLOODPLAIN DEVELOPMENT PERMIT ELEVATION CERTIFICATE CLOMR/LOMR X TRAFFIC CIRCULATION LAYOUT (TCI TRAFFIC IMPACT STUDY (TIS) STREET LIGHT LAYOUT OTHER (SPECIFY) PRE-DESIGN MEETING?	BUILDING I CERTIFICAT X PRELIMINA SITE PLAN SITE PLAN FINAL PLAT APPLIC SIA/ RELEA FOUNDATIO GRADING I SO-19 APPR PAVING PE GRADING/ I WORK ORDI CLOMR/LOI	TYPE OF APPROVAL/ACCEPTANCE SOUGHT: BUILDING PERMIT APPROVAL CERTIFICATE OF OCCUPANCY X PRELIMINARY PLAT APPROVAL SITE PLAN FOR SUB'D APPROVAL SITE PLAN FOR BLDG. PERMIT APPROVAL FINAL PLAT APPROVAL SIA/ RELEASE OF FINANCIAL GUARANTEE FOUNDATION PERMIT APPROVAL GRADING PERMIT APPROVAL SO-19 APPROVAL PAVING PERMIT APPROVAL GRADING/ PAD CERTIFICATION WORK ORDER APPROVAL CLOMR/LOMR FLOODPLAIN DEVELOPMENT PERMIT	
DATE SUBMITTED: 9-8-22	By: Amanda Herrera		
COA STAFF:	ELECTRONIC SUBMITTAL RECEIVED:_		

FEE PAID:

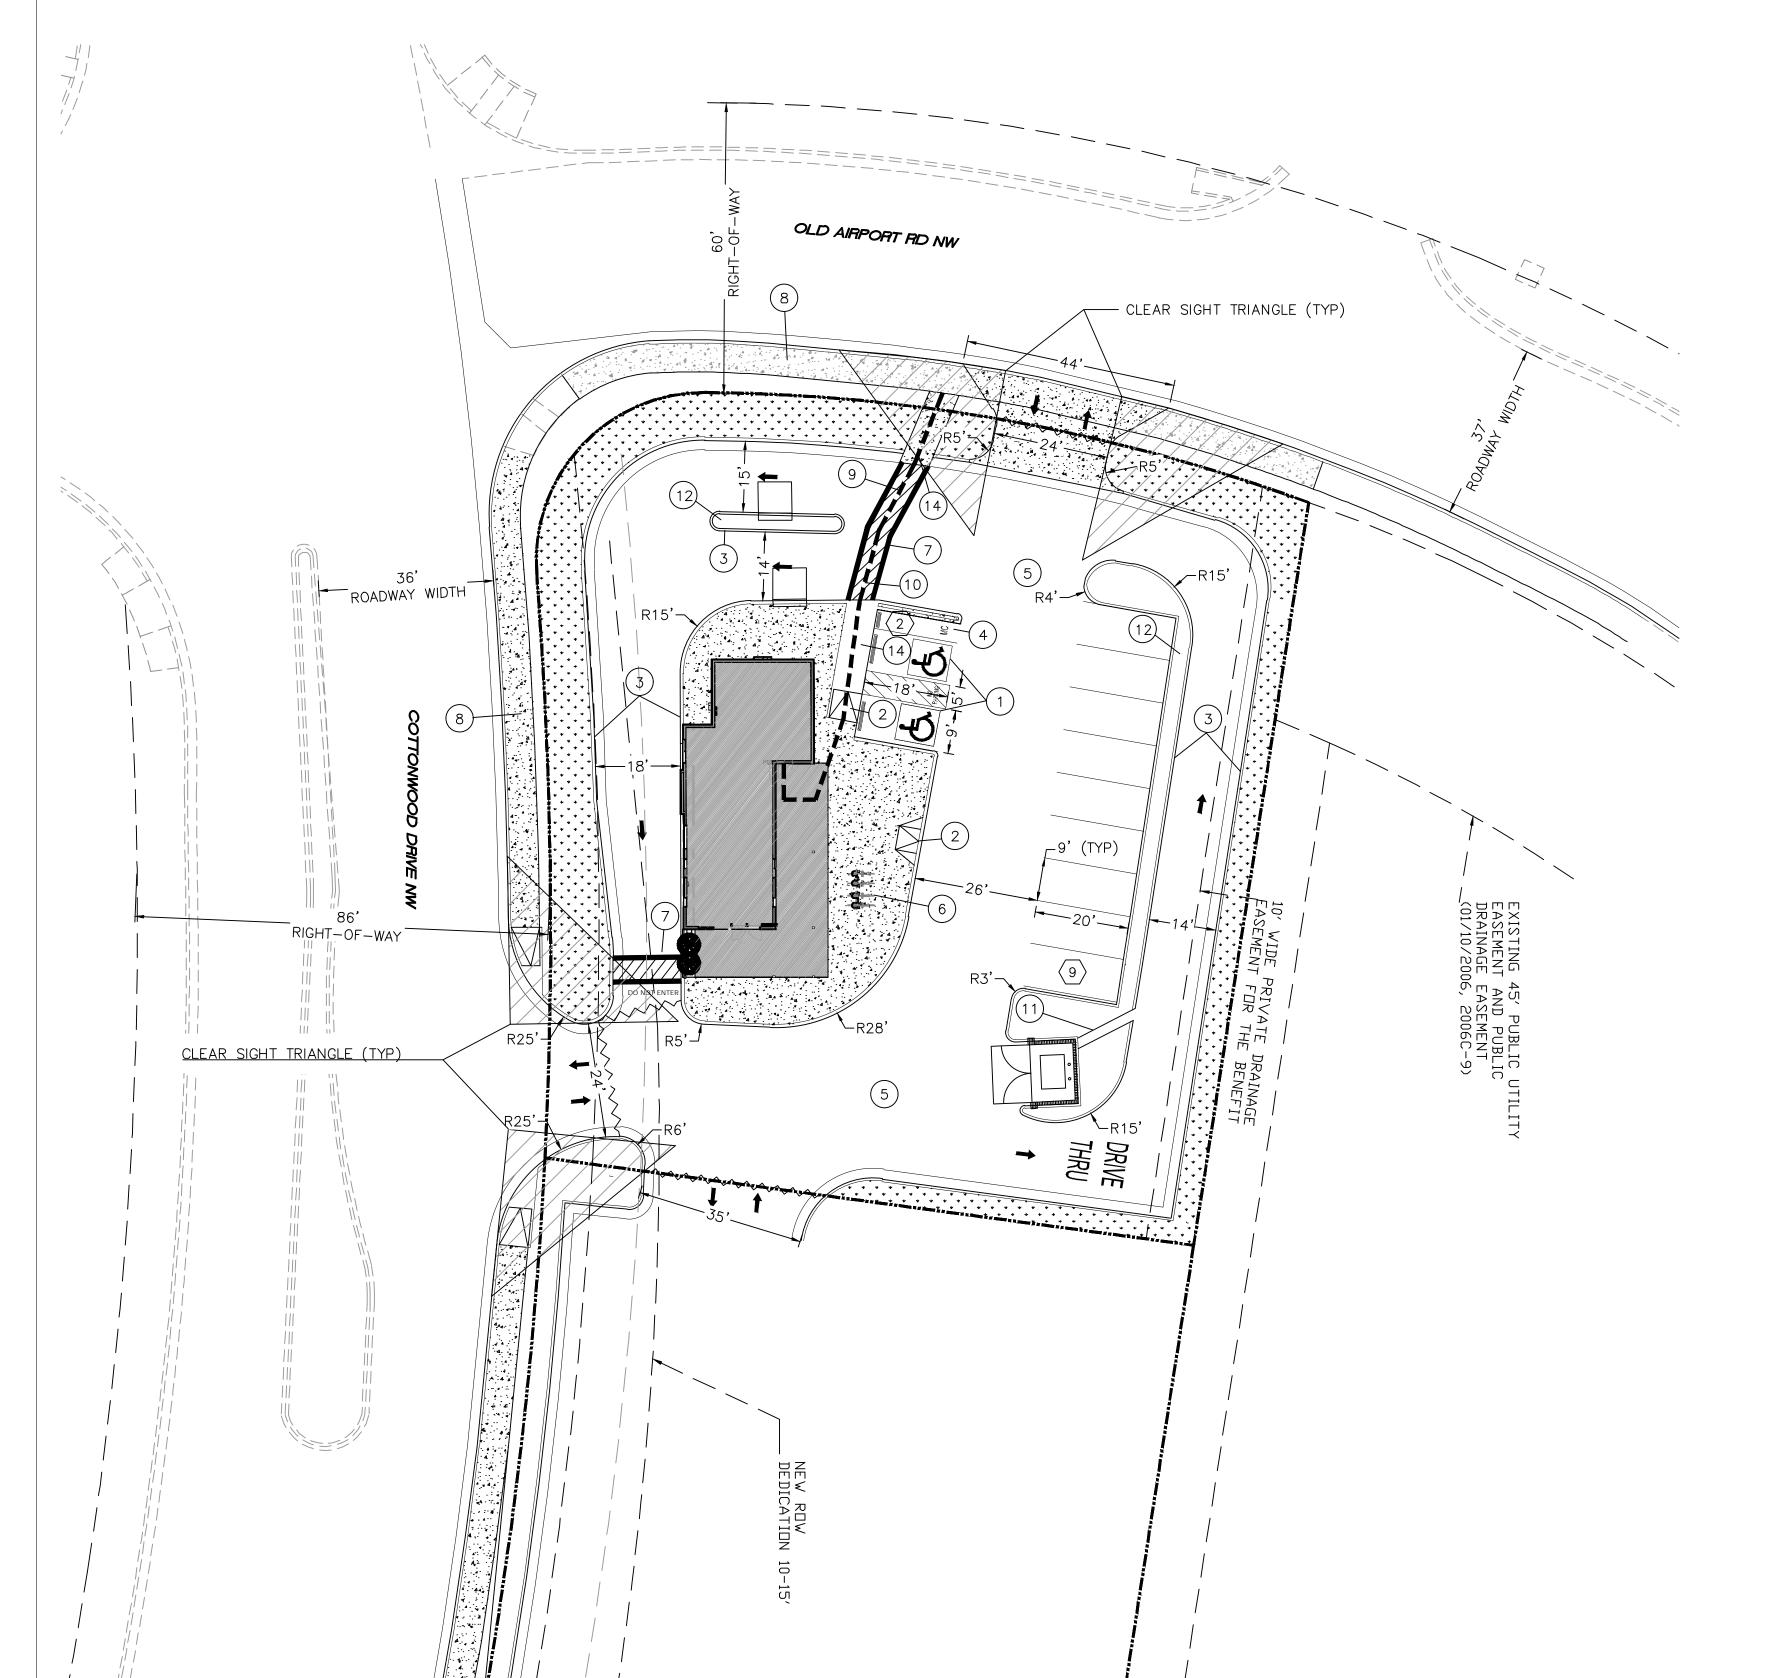


LEGEND

CURB & GUTTER ---- BOUNDARY LINE --- -- EASEMENT BUILDING PROPOSED SIDEWALK EXISTING CURB & GUTTER EXISTING BOUNDARY LINE PARKING COUNT CLEAR SIGHT TRIANGLE

KEYED NOTES

- 1) ACCESSIBLE PARKING W/SIGN PER ADA STANDARDS (1.0% MIN 2.0% MAX SLOPE) SEE DETAIL SHEET DET-1
- (2) UNIDIRECTIONAL ACCESSIBLE RAMP, SEE DETAIL SHEET DET-1
- (3) STANDARD CURB AND GUTTER (TYP) PER COA STD DWG 2415A, SEE DETAIL SHEET DET-1
- (4) MOTORCYCLE SPACE (4'X8' MIN) W/SIGN
- (5) NEW ASPHALT PAVING SEE DETAIL SHEET DET-1
- (6) BICYCLE RACK, SEE DETAIL SHEET DET-1
- (7) 5' PEDESTRIAN CROSSING, SEE DETAIL SHEET DET-1
- (8) NEW 6' CONCRETE SIDEWALK PER COA STD DWG 2430 SEE DETAIL SHEET DET-1
- (9) ADA PUBLIC ACCESS PATHWAY
- (10) ADA PARKING ACCESSIBLE PATHWAY
- (11) CURB CUT SEE DETAIL SHEET DET-1
- (12) DRIVE-THRU MEDIAN
- (13) ADA ACCESSIBLE RAMP PER COA STD DWG 2426, SEE DET-2
- (14) ZERO-FLUSH CURB, SEE DETAIL SHEET DET-1

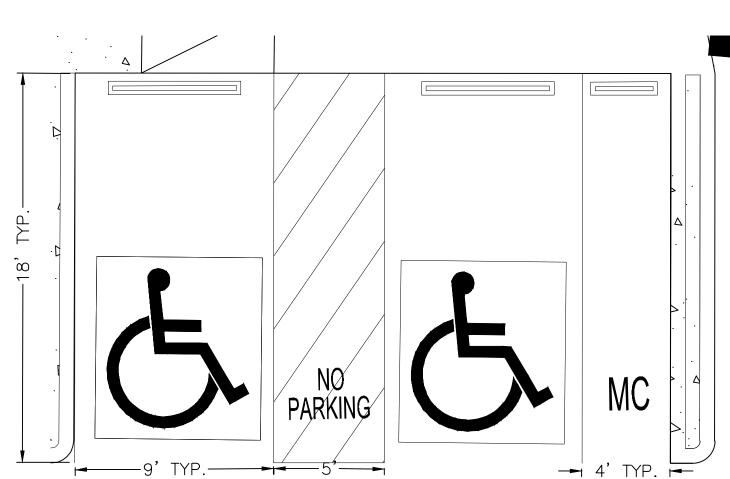

TYPICAL HANDICAP AND MOTORCYCLE PARKING

CAUTION

ALL EXISTING UTILITIES SHOWN WERE OBTAINED FROM RESEARCH, AS-BUILTS, SURVEYS OR INFORMATION PROVIDED BY OTHERS. IT SHALL BE THE SOLE RESPONSIBILITY OF THE CONTRACTOR TO CONDUCT ALL NECESSARY FIELD INVESTIGATIONS PRIOR TO AND INCLUDING ANY EXCAVATION, TO DETERMINE THE ACTUAL LOCATION OF UTILITIES AND OTHER IMPROVEMENTS, PRIOR TO STARTING THE WORK. ANY CHANGES FROM THIS PLAN SHALL BE COORDINATED WITH AND APPROVED BY THE ENGINEER.

GENERAL NOTES - SITE PLANS:

1. THE CONTRACTOR SHALL FIELD VERIFY ALL EXISTING CONDITIONS PRIOR TO COMMENCING THIS WORK. IN CASE OF ANY DISCREPANCIES, THE ARCHITECT SHALL BE NOTIFIED IMMEDIATELY AND WORK SHALL NOT COMMENCE WITHOUT APPROVAL FROM THE ARCHITECT. 2. WRITTEN DIMENSIONS OF DRAWINGS SHALL HAVE PRECEDENCE OVER SCALED DIMENSIONS. THE GENERAL CONTRACTOR SHALL VERIFY AND BE RESPONSIBLE FOR ALL DIMENSIONS AND CONDITIONS AT THE BUILDING SITE, AND REPORT ANY DISCREPANCIES TO THE ARCHITECT PRIOR TO PROCEEDING WITH THE WORK.

3. GC AND LIGHTING CONTRACTOR TO ENSURE SITE LIGHTING FIXTURE HEADS HAVE THE CORRECT ORIENTATION. REFER TO PHOTOMETRIC DRAWINGS FOR HEAD PLACEMENT. 4. GC TO COORDINATE SITE SECURITY LAYOUT AND CONDUIT SIZE & LOCATION WITH THE OWNER. 5. GC TO ENSURE PAVING AT ALL EXITS SHALL NOT EXCEED A 2% MAX SLOPE IN ALL

- 6. PAVING SHALL BE LOWER THAN THE BUILDING SLAB BY THE FOLLOWING AMOUNTS UNO:
- •1/2" @ ALL EXIT DOORS • 1/2" @ ALL SHOWROOM GLAZING LOCATIONS
- •1 1/2" @ OVERHEAD DOORS
- 1 1/2" @PRE-FAB METAL WALL PANELS 7. PARKING LOT SHALL BE ASPHALT PAVING
- 8. ALL BROKEN OR CRACKED SIDEWALK MUST BE REPLACED WITH NEW SIDEWALK AND CURB &:GUTTFR

NOTICE TO CONTRACTORS

- 1. AN EXCAVATION/CONSTRUCTION PERMIT WILL BE REQUIRED BEFORE BEGINNING ANY WORK WITHIN CITY RIGHT-OF-WAY. AN APPROVED COPY OF THESE PLANS MUST BE SUBMITTED AT THE TIME OF APPLICATION FOR THIS PERMIT.
- 2. ALL WORK DETAILED ON THESE PLANS TO BE PERFORMED, EXCEPT AS OTHERWISE STATED OR PROVIDED HEREON, SHALL BE CONSTRUCTED IN ACCORDANCE WITH CITY OF ALBUQUERQUE INTERIM STANDARD SPECIFICATIONS FOR PUBLIC WORKS CONSTRUCTION, 1985.
- 3. TWO WORKING DAYS PRIOR TO ANY EXCAVATION, CONTRACTOR MUST CONTACT LINE LOCATING SERVICE, 260-1990 (OR DIAL 811 LOCALLY), FOR LOCATION OF EXISTING UTILITIES.
- 4. PRIOR TO CONSTRUCTION, THE CONTRACTOR SHALL EXCAVATE AND VERIFY THE HORIZONTAL AND VERTICAL LOCATIONS OF ALL CONSTRUCTIONS. SHOULD A CONFLICT EXIST, THE CONTRACTOR SHALL NOTIFY THE ENGINEER SO THAT THE CONFLICT CAN BE RESOLVED WITH A MINIMUM AMOUNT OF DELAY.
- 5. BACK FILL COMPACTION SHALL BE ACCORDING TO RESIDENTIAL STREET USE. 6. MAINTENANCE OF THESE FACILITIES SHALL BE THE RESPONSIBILITY OF THE OWNER OF THE
- PROPERTY SERVED.



LEGAL DESCRIPTION:

MM-1-B SEVEN-BAR RANCH (BEING A REPLAT OF TRACT MM-1 SEVEN-BAR RANCH) CONT 0.55 AC

SITE DATA

PROPOSED USAGE RESTAURANT

LOT AREA 23,958 SF (0.55 ACRES)

ZONING $\mathsf{MX}\mathbf{-X}$

PARKING REQUIRED


8 SPACES/1,000 SQ.FT. GFA= 1,073 SF

8.6 SPACES 9 SPACES PARKING PROVIDED HC PARKING REQUIRED 1 SPACES HC PARKING PROVIDED 2 SPACES MC PARKING REQUIRED 1 SPACES MC PARKING PROVIDED 1 SPACES 12 SPACES

BICYCLE SPACES REQUIIRED 2 SPACES BICYCLE SPACES PROVIDED 4 SPACES


CLEAR SIGHT TRIANGLE NOTE:

LANDSCAPING, SIGNAGE, WALLS, FENCES, TREES, AND SHRUBBERY BETWEEN 3 FEET AND 8 FEET TALL (AS MEASURED FROM THE GUTTER PAN) ARE NOT ALLOWED WITHIN THE CLEAR SIGHT TRIANGLE.

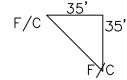



GRAPHIC SCALE (IN FEET) 1 inch = 20 ft.

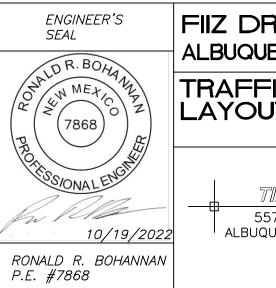

	FIIZ DRINKS ALBUQUERQUE, NM	<i>DRAWN BY</i> JL
	ALBOQUERQUE, INIVI	DATE
.\	TRAFFIC CONTROL	7-14-22
z\	LAYOUT	DRAWING
\ \f		
7		SHEET #
2022	TIERRA WEST, LLC 5571 MIDWAY PARK PL NE ALBUQUERQUE, NEW MEXICO 87109	TCL-1
INAN	(505) 858—3100 www.tierrawestllc.com	<i>JOB #</i> 2022048

SCALE: NTS

 $@2018 \ \ GRABER \ \ MANUFACTURING, \ INC. \qquad ALL \ \ PROPRIETARY \ RIGHTS \ RESERVED.$

21 7/8

NUTES:
1. INSTALL BIKE RACKS ACCORDING TO MANUFACTURER'S SPECIFICATIONS.
2. CONSULTANT TO SELECT COLOR (FINISH), SEE MANUFACTURER'S SPECIFICATIONS.
4. SEE SITE PLAN FOR LOCATION OR CONSULT DWNER.
5. BIKE RACK SHALL HAVE A 1-FOOT CLEAR ZONE ALL ARDUND.
6. EACH BIKE RACK SPACE SHALL BE AT LEAST 6 FEET LONG AND 2 FEET WIDE.
7. A 1-FOOT CLEAR ZONE ARDUND THE BICYCLE PARKING TALL SHALL BE PROVIDED.

BIKE RACK DETAIL

PLAN VIEW MADRAX DIVISION ø 2 3/8" STEEL TUBING----GRADE 19 1/2±1 ----CHECK DESIRED MOUNT —CONCRETE □ SURFACE FLANGE M□UNT (SF) ☐ IN GROUND MOUNT (IG) PRODUCT: U238-IG(SF) DESCRIPTION: 'U' BIKE RACK 2 BIKE, SURFACE OR IN GROUND MOUNT

1.80

1.80 1.80

STANDARD CURB / GUTTER COA STD DWG 2415A

1'-4"

R1==""-

1. ALL CURBS TO BE CONSTRUCTED OF PORTLAND

CEMENT CONCRETE, PER WAL-MART SPECIFICATIONS.

2. PROVIDE CONTRACTION JTS. 12' MAX., SPACING, 1/2"

SEPARATELY CONSTRUCTED DRIVEWAYS. CONTRACTION JTS.,

SHALL BE EITHER SAWED OR TOOLED A MINIMUM OF 1"

3. ALL EDGES SHALL BE EDGED WITH A 3/8" RADUIS

4. 1/4" ISOLATION JOINT SHALL BEARSTANDENGE STANEEN

SIDEWALK AND CURB WHEN CAST ADJACENT TO EACH


EXP. JTS. AT CURB RETURNS AND AT A MAX. SPACING OF 120' BETWEEN CURB RETURNS AND EACH SIDE OF

CURB GENERAL NOTES:


DEEP AT FINISHED FACES.

EDGING TOOL.


OTHER.

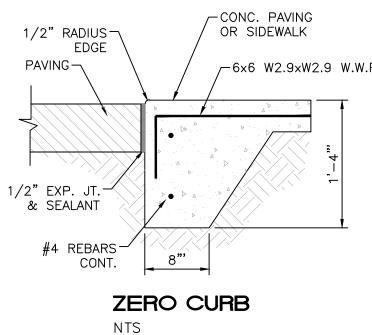

_ PER PLAN CONC. HC RAMP-SLOPE 12:1 MAX. SIDEWALK-/─6×6 W2.9×W2.9 W.W.F. PLAN 5' MIN. LANDING-

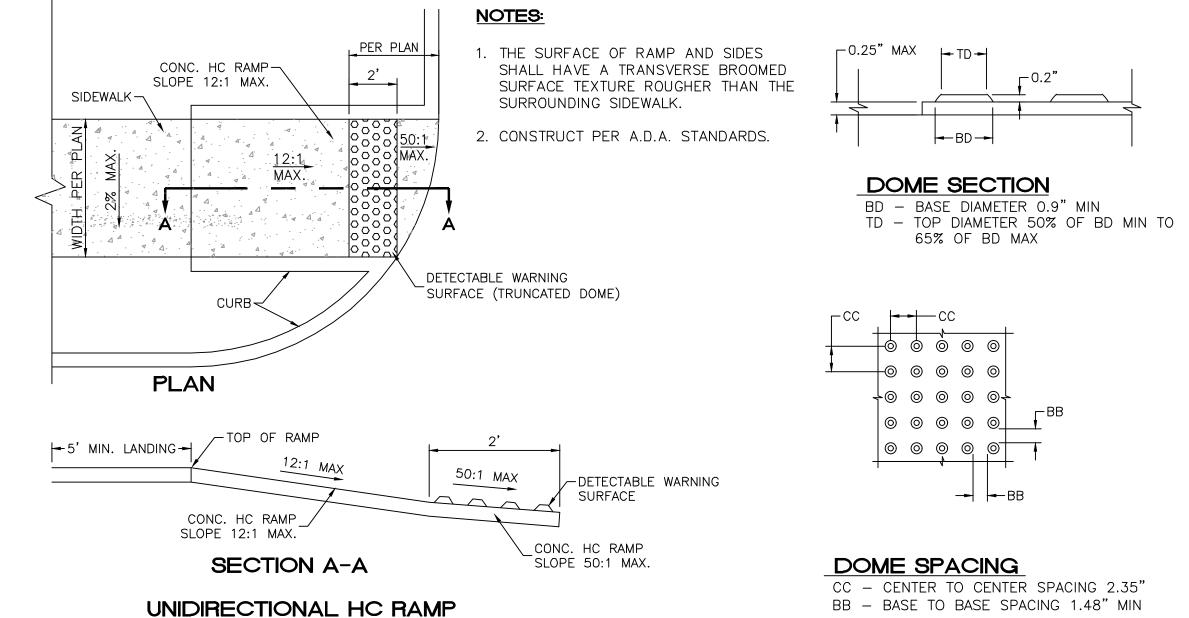


COA **STD DWG 2443**

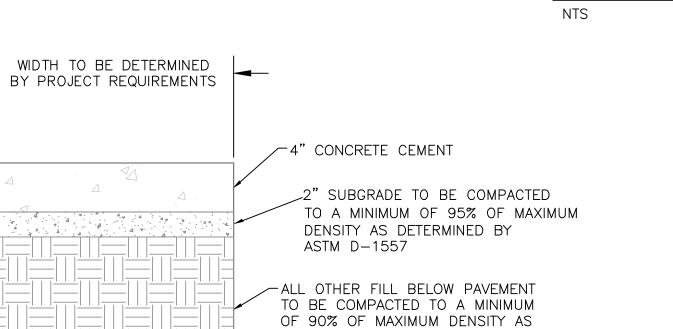

DETERMINED BY ASTM D-1557


CONCRETE SIDEWALK SECTION COA STD DWG 2430

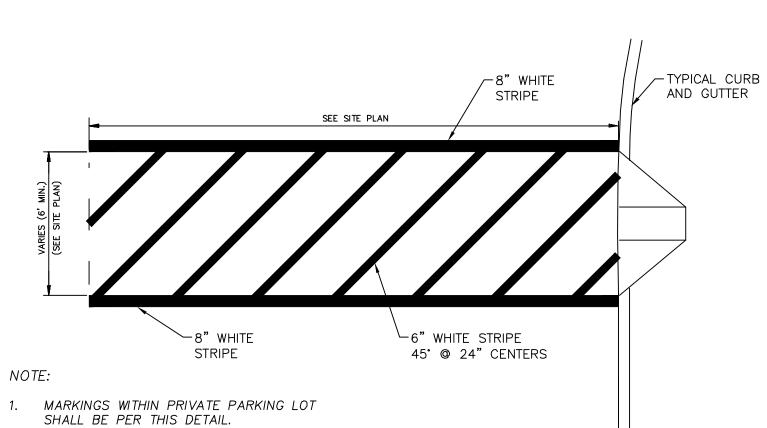

1. MARKINGS WITHIN PRIVATE PARKING LOT SHALL BE PER THIS DETAIL.

THESE MARKINGS ARE TO BE PAINTED REFLECTIVE WHITE.


CROSSWALK/PED. CROSSING

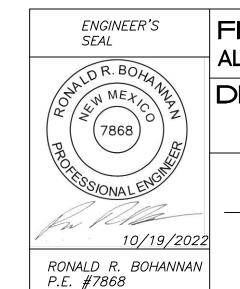



ENGINEER'S SEAL	FIIZ DRINKS	<i>DRAWN BY</i> JL
OR. BOHANA WMEXICOZ	ALBUQUERQUE, NM DETAILS	<i>DATE</i> 7–14–22
((7868))		DRAWING
PROFILES CONTROLLED		SHEET #
10/19/2022	TIERRA WEST, LLC 5571 MIDWAY PARK PL NE ALBUQUERQUE, NEW MEXICO 87109	DET-1
RONALD R. BOHANNAN P.E. #7868	(505) 858—3100 www.tierrawestllc.com	<i>JOB #</i> 2022048


DOME SPACING CC - CENTER TO CENTER SPACING 2.35" BB - BASE TO BASE SPACING 1.48" MIN


65% OF BD MAX

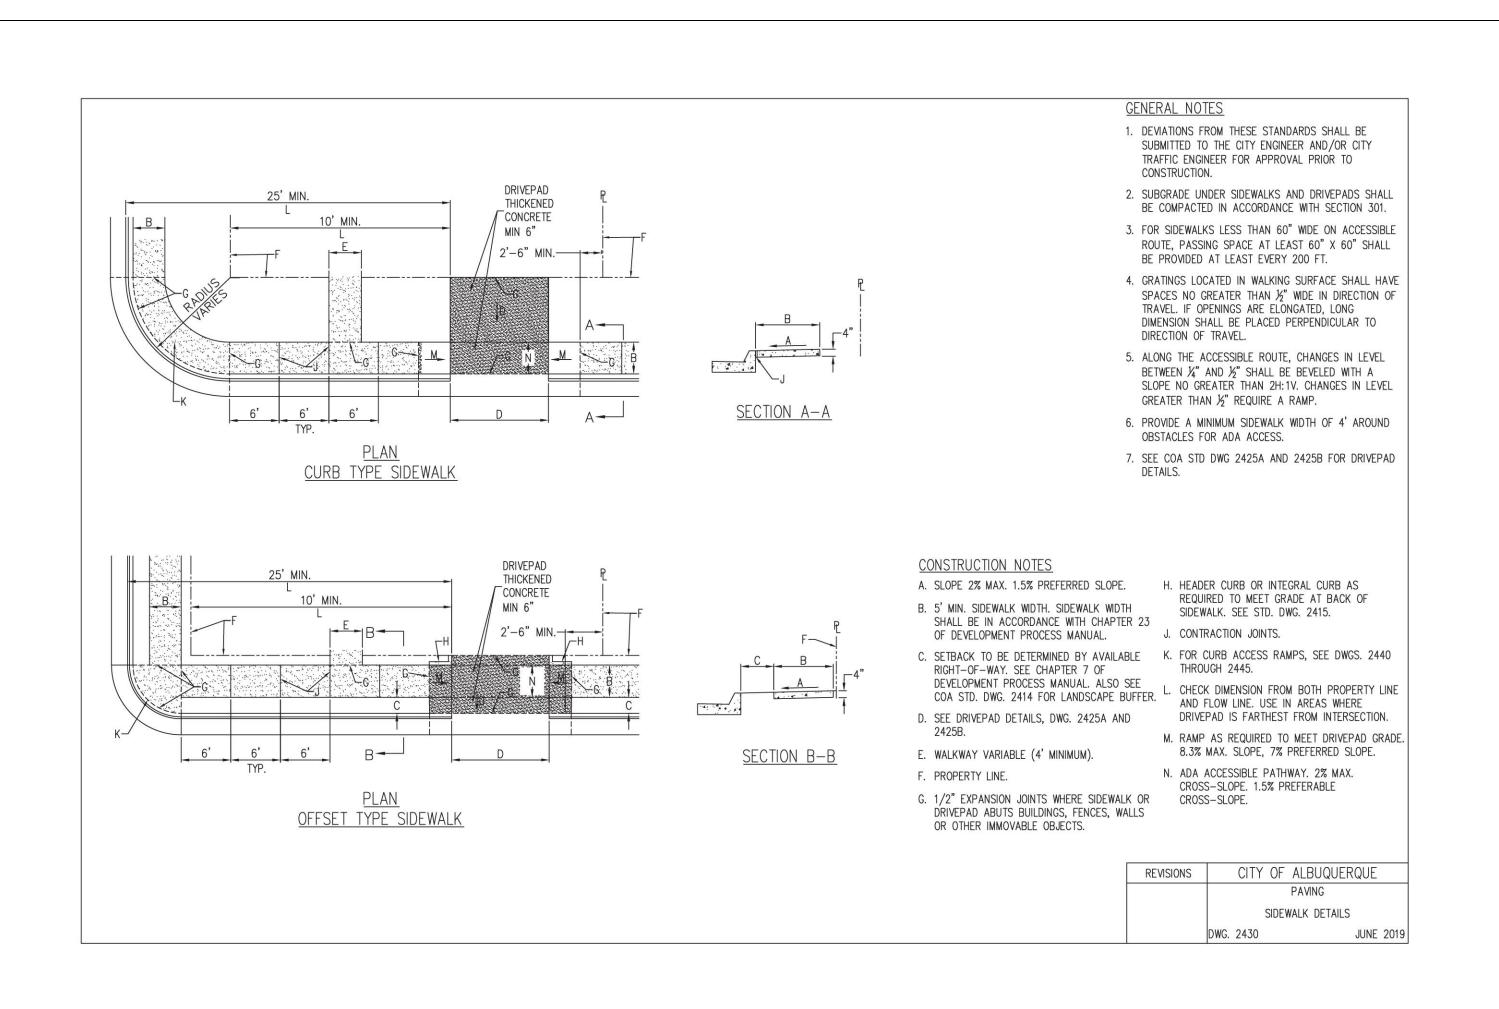

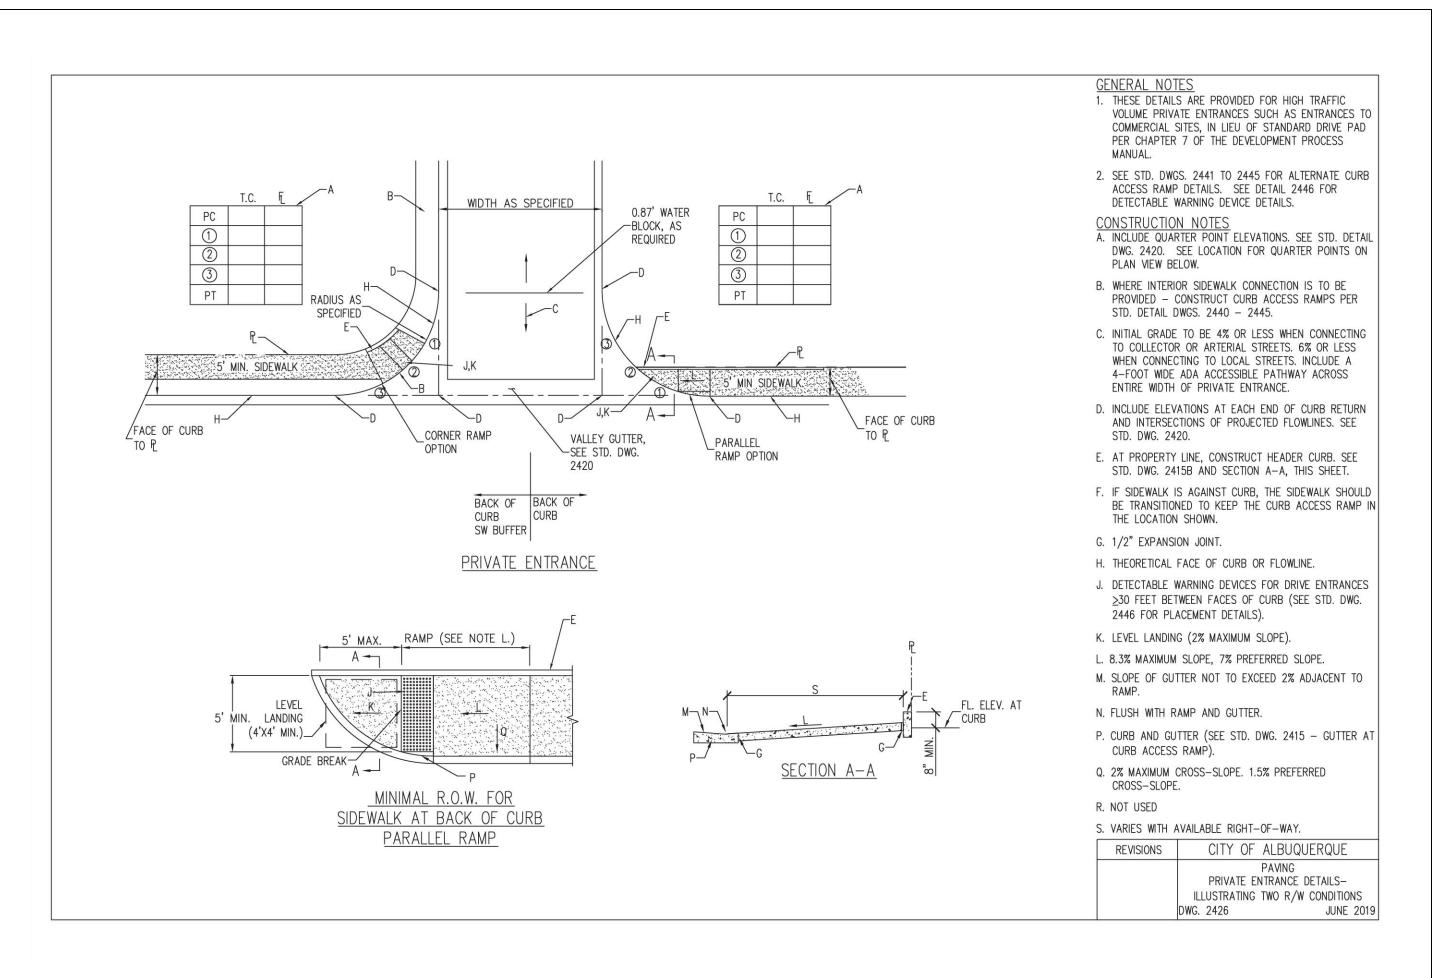


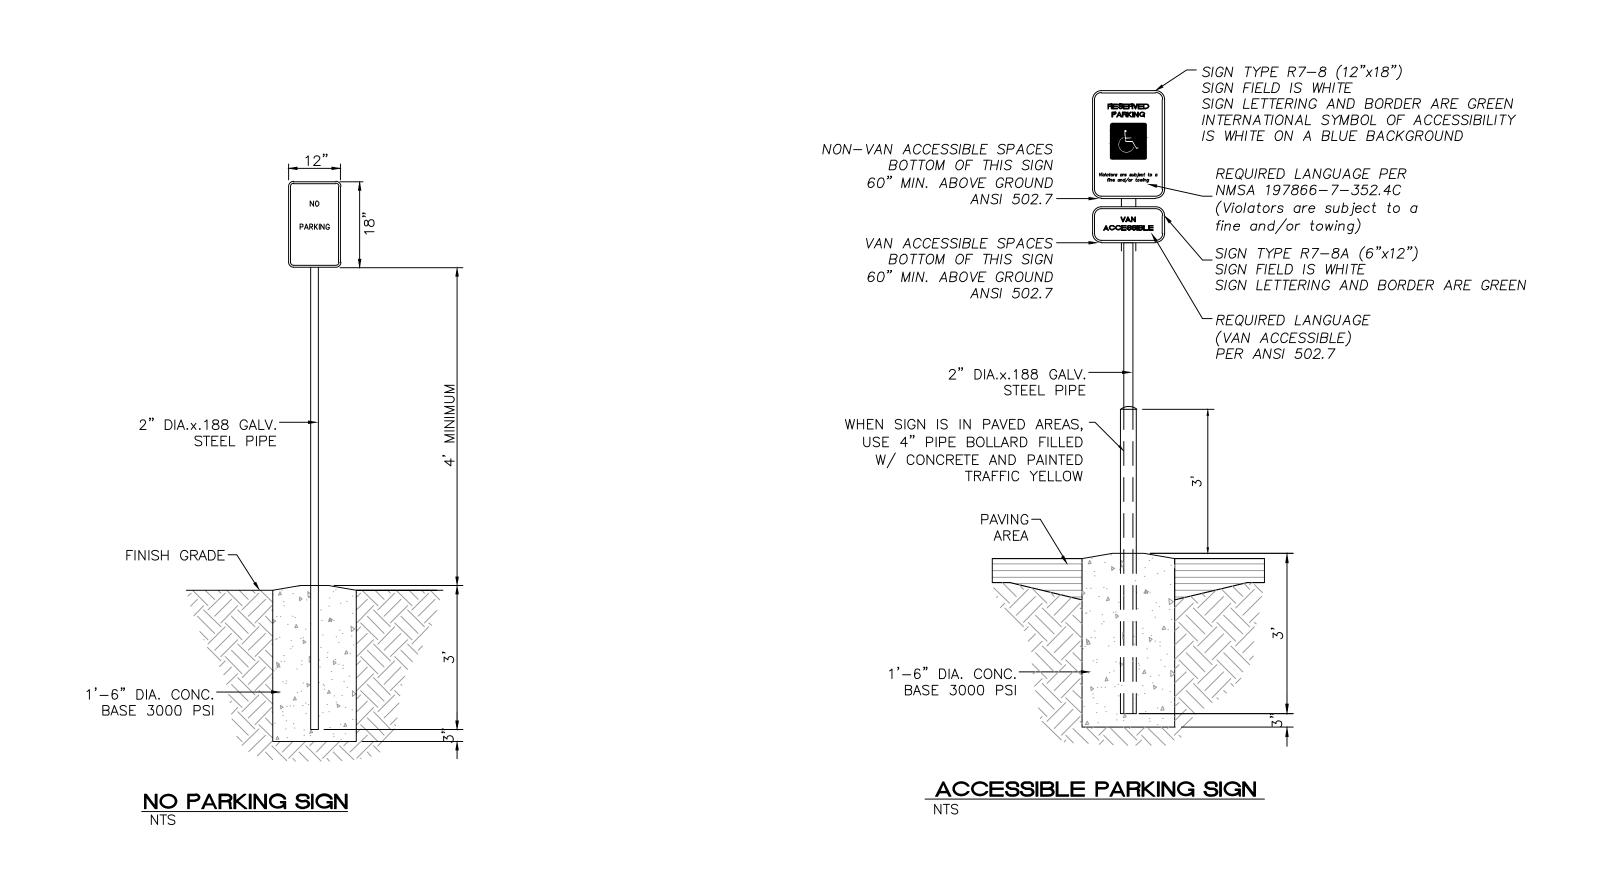

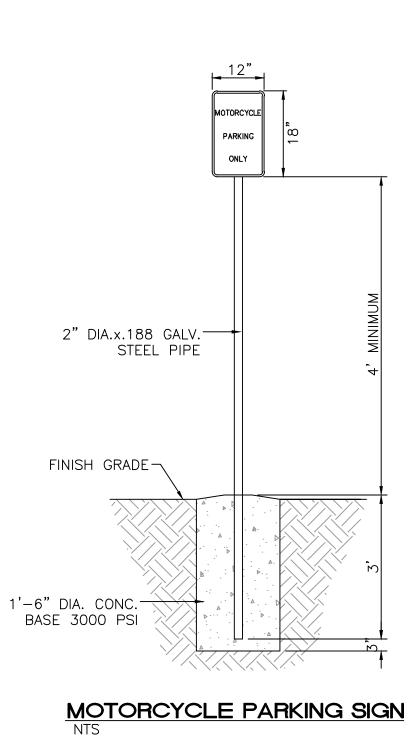

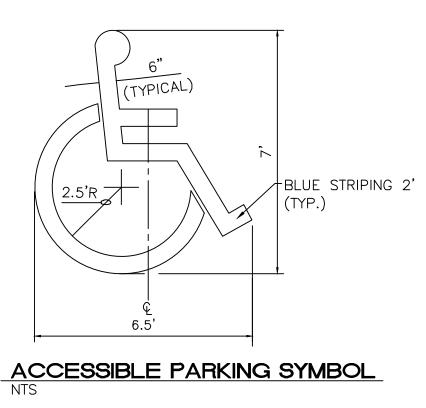


LOCATE AT EDGE OF PARKING SPACE UNLESS ACCOMPANIED BY "VAN" LETTERING

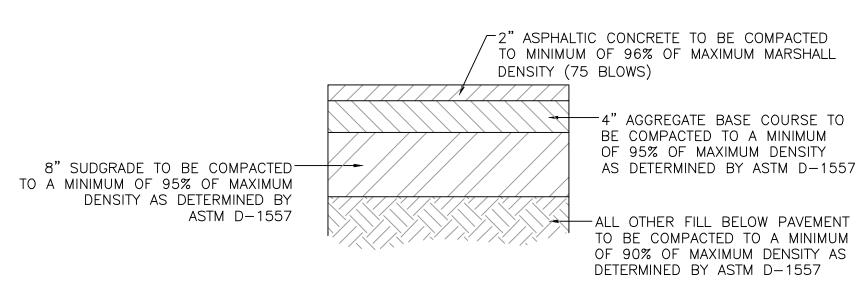

AUTOMOBILE PARKING TYPICAL PAVING SECTION

ENGINEER'S SEAL	FIIZ DRINKS ALBUQUERQUE, NM	<i>DRAWN BY</i> JL
DR. BOH	ALBOQUERQUE, NIVI	DATE
OR. BOHANA ON WEXICO	DETAILS	7-14-22
(7868) Z		DRAWING
PROFILES IONAL ENGINE		SHEET #
10/19/2022	TIERRA WEST, LLC 5571 MIDWAY PARK PL NE ALBUQUERQUE, NEW MEXICO 87109	DET-2
RONALD R. BOHANNAN P.E. #7868	(505) 858-3100 www.tierrawestllc.com	<i>JOB #</i> 2022048

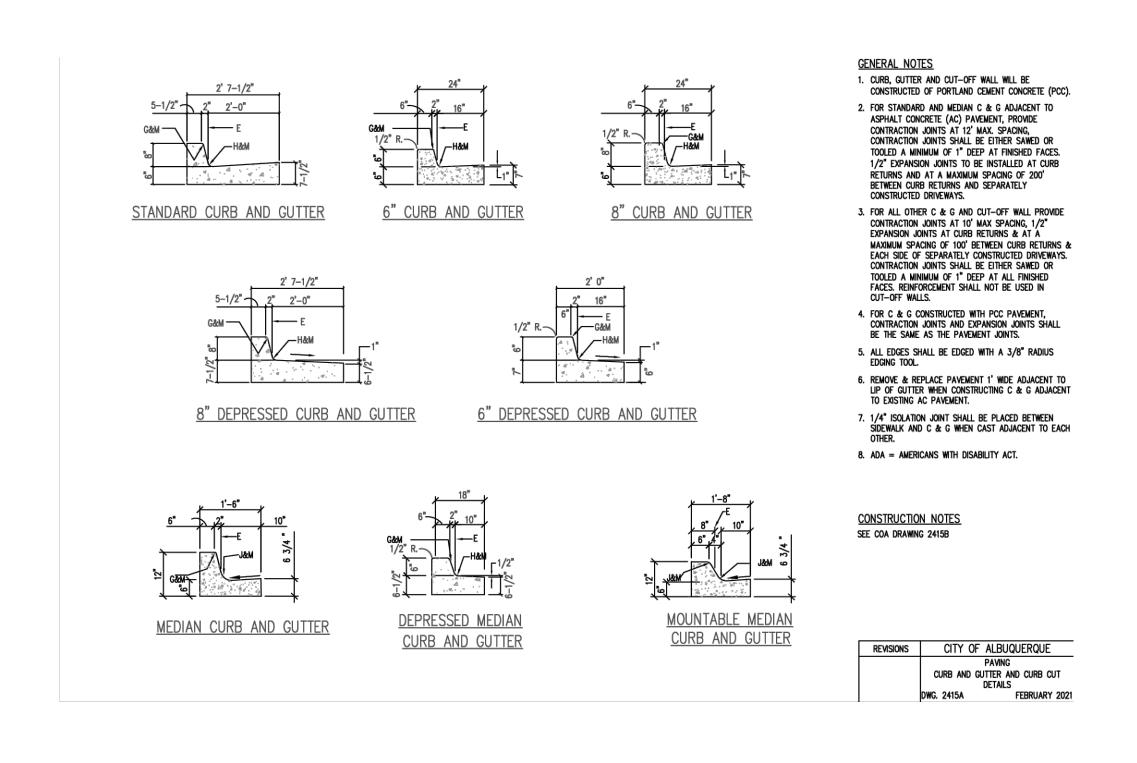

SIDEWALK AREA -

RAMP WIDTH 5'-0" MIN

DETECTABLE WARNING -

SURFACE (TYP)


DETAIL A-PARALLEL CURB


<u>ramp</u>


CONCRETE HEADER

─ SIDEWALK WIDTH

TURNING SPACE WIDTH

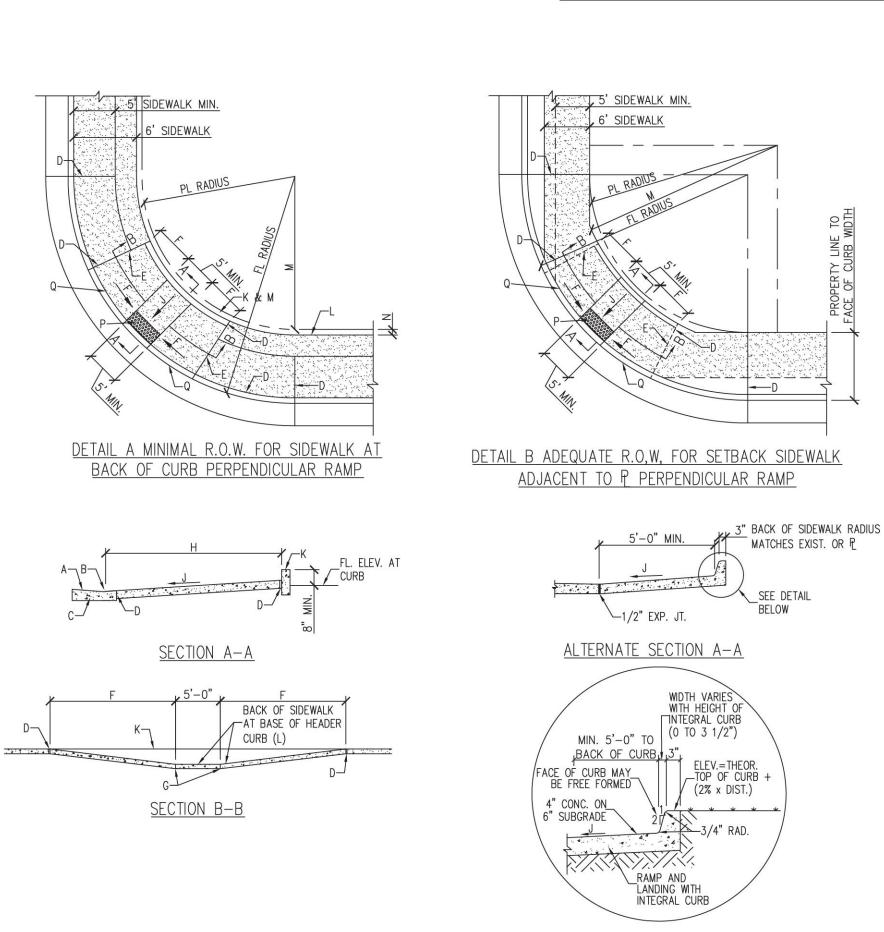

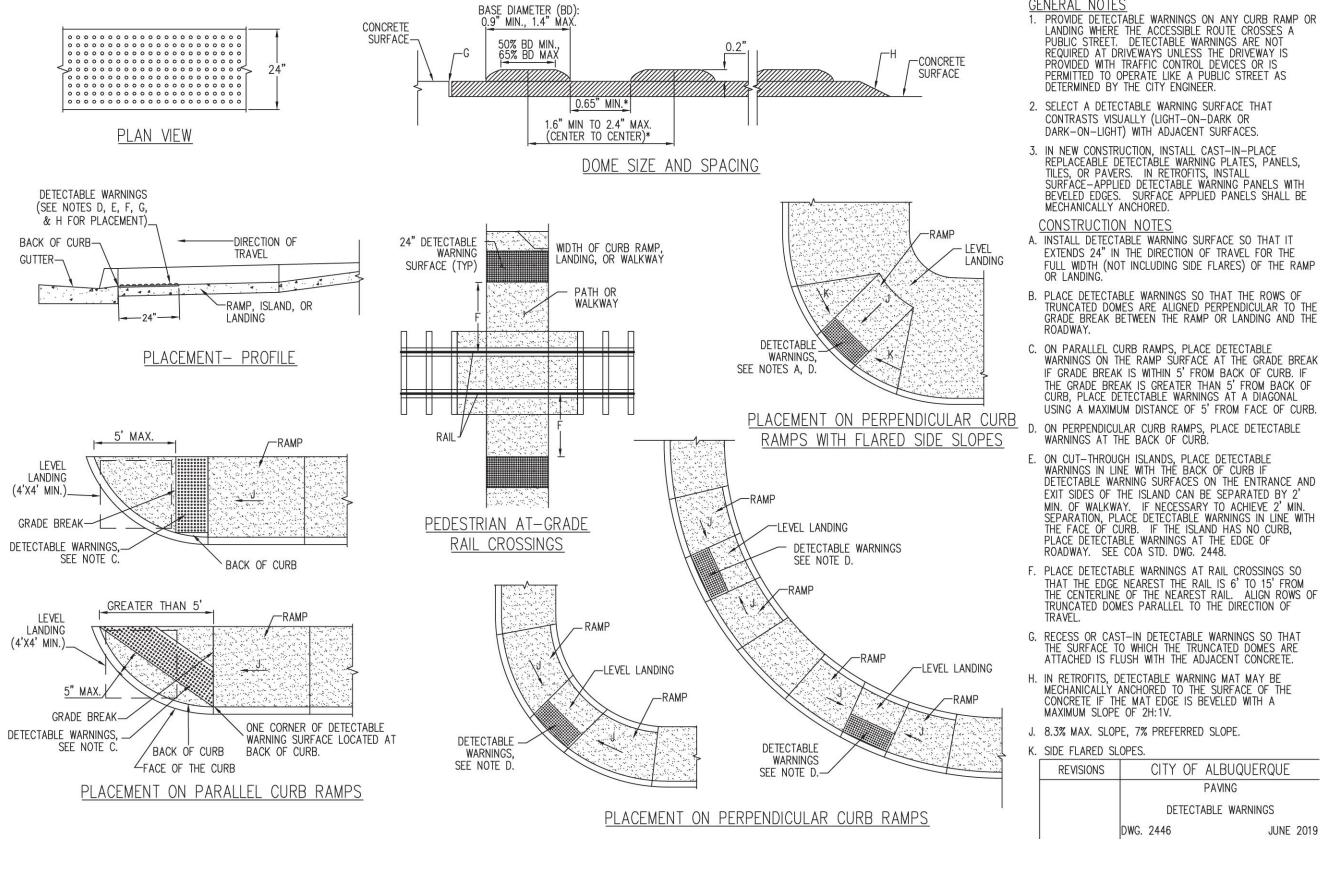

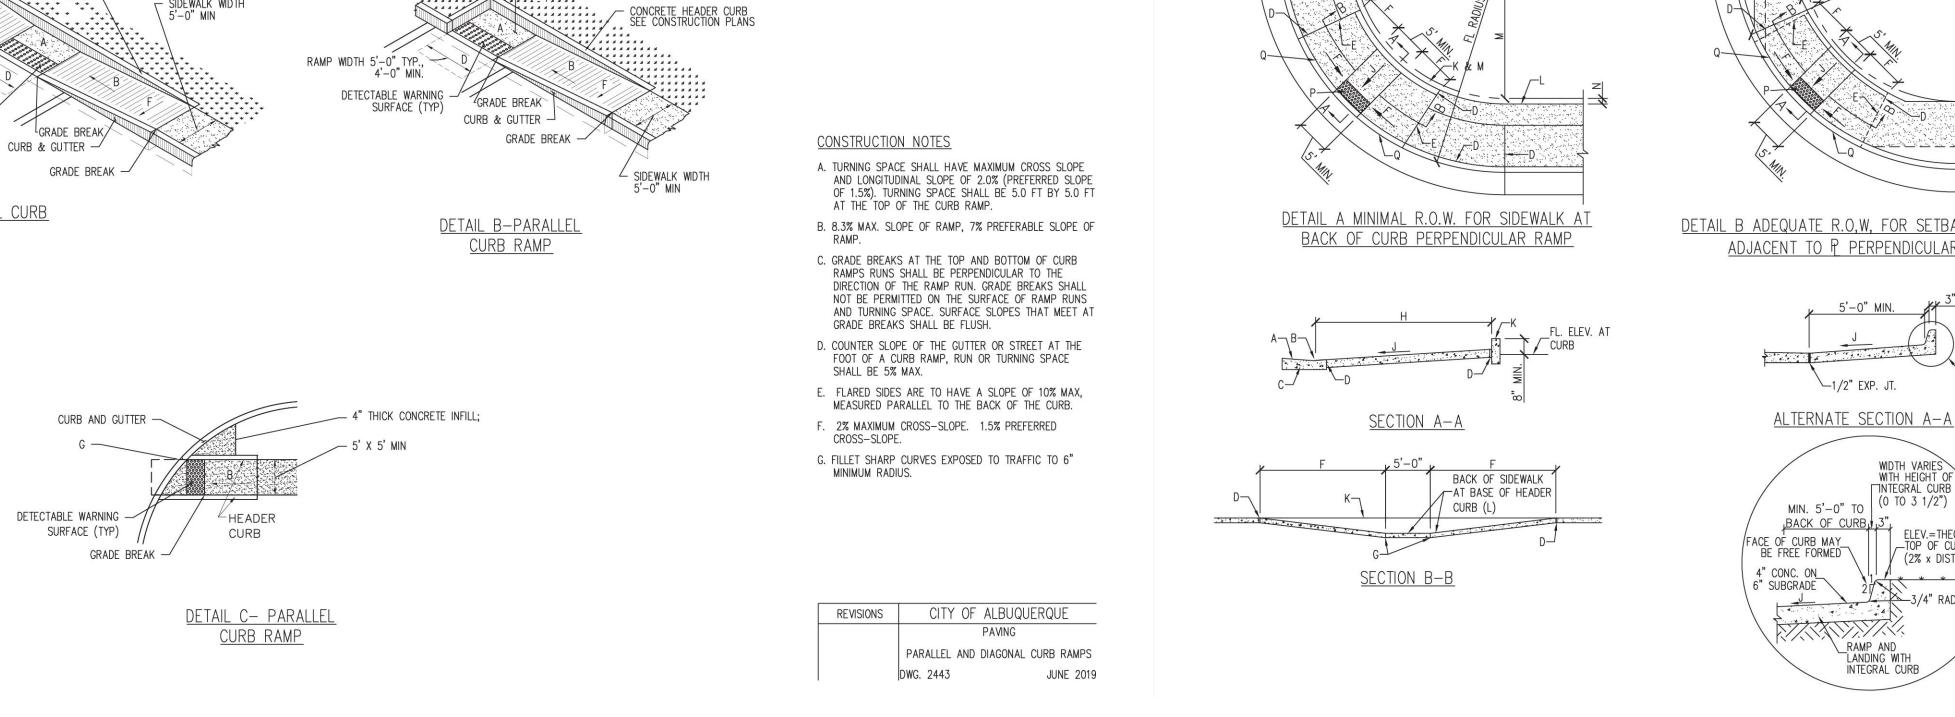

GENERAL NOTES

EXTENT AS FEASIBLE.

DEVICE DETAILS.

1. RUNNING SLOPE OF A CURB RAMP SHALL NOT REQUIRE THE RAMP LENGTH TO EXCEED 15 FEET TO AVOID

CHASING THE SLOPE INDEFINITELY WHEN CONNECTING

MAXIMUM LENGTH, THE RUNNING SLOPE OF THE CURB RAMP SHALL BE EXTENDED AS FLAT AS THE MAXIMUM

TO STEEP GRADES. WHEN APPLYING THE 15-FOOT

2. SEE COA STD. DWG. 2446 FOR DETECTABLE WARNING

ſ	ENGINEER'S FIIZ DRINKS
	CORNER ACCESS RAMP DWG. 2441 JUNE 2019
	PAVING
	REVISIONS CITY OF ALBUQUERQUE
	Q. CURB TO MATCH SLOPE OF SIDEWALK.
	N. 4-1/2" MAX.P. DETECTABLE WARNINGS (SEE STD. DWG. 2446).
	AS TO MAINTAIN A 5'-0" RAMP WIDTH (MINIMUM) THROUGHOUT. SEE STD. DWG. 2440 (NOTE 6) IF LESS THAN 5'-0" IS AVAILABLE DUE TO UNRESOLVABLE CONSTRAINTS.
	M. BACK OF SIDEWALK RADIUS TO BE ESTABLISHED SO
	K. HEADER CURB, SEE DWG. 2415C.L. BACK OF SIDEWALK.
	J. 2% MAXIMUM CROSS—SLOPE. 1.5% PREFERRED CROSS—SLOPE.
	H. VARIES WITH AVAILABLE R.O.W.
	G. CONTRACTION JOINT.
	F. 8.3% MAX. SLOPE OF RAMP, 7% PREFERABLE SLOPE OF RAMP.
	E. RADIAL LINES - TOP AND BOTTOM OF RAMP.
	D. 1/2" EXPANSION JOINT.
	C. CURB AND GUTTER (SEE STD. DWG. 2415 – GUTTER AT CURB ACCESS RAMP).
	B. FLUSH WITH RAMP AND GUTTER.
	CONSTRUCTION NOTES A. SLOPE OF GUTTER NOT TO EXCEED 2% ADJACENT TO RAMP. 1.5 % PREFERRED.
	 WIDTH OF SIDEWALK AND RAMP MUST BE MAINTAINED AT A MINIMUM OF 5'-0" THROUGH ENTIRE RAMP LENGTH.

GENERAL NOTES

THE CITY TRAFFIC ENGINEER.

AS SHOWN ON PLANS.

CURB ACCESS RAMPS ARE NORMALLY TO BE LOCATED

2. WHEN MODIFYING ONE QUADRANT OF AN INTERSECTION TO IMPROVE ACCESSIBILITY, MODIFY THE REMAINING

INTERSECTION COMPLY WITH ADA (PROWAG) REGULATIONS

3. SURFACE TEXTURE OF CURB ACCESS RAMPS SHALL BE OBTAINED BY HEAVY BROOMING (TEXTURE DEPTH .0625"),

QUADRANTS SO THAT ALL QUADRANTS OF THE

TRANSVERSE TO THE SLOPE OF THE RAMP.

4. GUTTER FLOW-LINE PROFILE SHALL BE MAINTAINED THROUGH THE AREA OF THE RAMP. DRAINAGE CATCH BASIN STRUCTURES SHALL NOT BE PLACED IN LINE WITH

AT THE CENTER OF THE RETURN OR AS DIRECTED BY

ENGINEER'S SEAL	FIIZ DRINKS	<i>DRAWN BY</i> JL
OF W MEXICO Z	ALBUQUERQUE, NM	DATE
ON MEXICO Z	DETAILS	7-14-22
((7868)		DRAWING
PRO JEJ		
PROTESSIONAL ENGINE		SHEET #
OONALES		DET-3
10/19/2022	5571 MIDWAY PARK PL NE ALBUQUERQUE, NEW MEXICO 87109	
	(505) 858-3100	100 //
RONALD R. BOHANNAN P.E. #7868	www.tiérrawestllc.com	<i>JOB #</i> 2022048