CITY OF ALBUQUERQUE

Planning Department Alan Varela, Interim Director



Mayor Timothy M. Keller

September 7, 2021

Ronald Bohannan, P.E. Tierra West, LLC 5571 Midway Park Place NE Albuquerque, NM 87109

RE: AutoZone - Ventana Square Grading and Drainage Plan Engineer's Stamp Date: 04/01/21 Hydrology File: B10D003C3A

Dear Mr. Bohannan:

PO Box 1293 Based upon the information provided in your submittal received 05/05/2021, the Grading & Drainage Plan is approved for Building Permit, Grading Permit, and for action by the DRB on Site Plan for Building Permit.

Albuquerque Please attach a copy of this approved plan in the construction sets for Building Permit processing along with a copy of this letter. Prior to approval in support of Permanent Release of Occupancy by Hydrology, Engineer Certification per the DPM checklist will be required.

NM 87103As a reminder, if the project total area of disturbance (including the staging area and any work
within the adjacent Right-of-Way) is 1 acre or more, then an Erosion and Sediment Control
(ESC) Plan and Owner's certified Notice of Intent (NOI) is required to be submitted to the
Stormwater Quality Engineer (Doug Hughes, PE, jhughes@cabq.gov, 924-3420) 14 days prior to
any earth disturbance.

If you have any questions, please contact me at 924-3995 or <u>rbrissette@cabq.gov</u>.

Sincerely,

Renée C. Brissette

Renée C. Brissette, P.E. CFM Senior Engineer, Hydrology Planning Department


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City of Albuquerque


Planning Department Development & Building Services Division

DRAINAGE AND TRANSPORTATION INFORMATION SHEET (REV 6/2018)

Project Title: Autozone	Building Permit #:	Hydrology File #:
DRB#:	EPC#:	Work Order#:
Legal Description: <u>TR H-11 Plat of Tracts</u>	<u>H-1 Thru H-11 Ventana Square At Ventana Ra</u>	anch a Replat of Tract H-AVentana Ranch
City Address:		
Applicant: Tierra West, LLC		Contact:
Address: 5571 Midway Park Place NE Alt	ouquerque NM 87109	
Phone#: 505-858-3100	Fax#: 505-858-1118	E-mail:
Other Contact:		Contact:
Address:		
Phone#:	Fax#:	E-mail:
TYPE OF DEVELOPMENT:F	PLAT (# of lots) RESIDENCE	DRB SITE X ADMIN SITE
IS THIS A RESUBMITTAL?	Yes X No	
DEPARTMENT TRANSPORTAT	IONHYDROLOGY/DRAI	NAGE
Check all that Apply:		PPROVAL/ACCEPTANCE SOUGHT:
TYPE OF SUBMITTAL: ENGINEER/ARCHITECT CERTIFIC PAD CERTIFICATION CONCEPTUAL G & D PLAN X GRADING PLAN DRAINAGE REPORT DRAINAGE MASTER PLAN FLOODPLAIN DEVELOPMENT PER ELEVATION CERTIFICATE CLOMR/LOMR TRAFFIC IMPACT STUDY (TIS) TREET LIGHT LAYOUT OTHER (SPECIFY) PRE-DESIGN MEETING?	ATION CERTIN ATION CERTIN PRELIN SITE PI X SITE PI X SITE PI FINAL GRADI (TCL) SO-19 A GRADI GRADI GRADI GRADI GRADI GRADI FLOOD	G PERMIT APPROVAL NG/ PAD CERTIFICATION ORDER APPROVAL
DATE SUBMITTED: <u>5/5/2021</u>	<i>.</i>	
COA STAFF:	ELECTRONIC SUBMITTAL RECEI	VED:



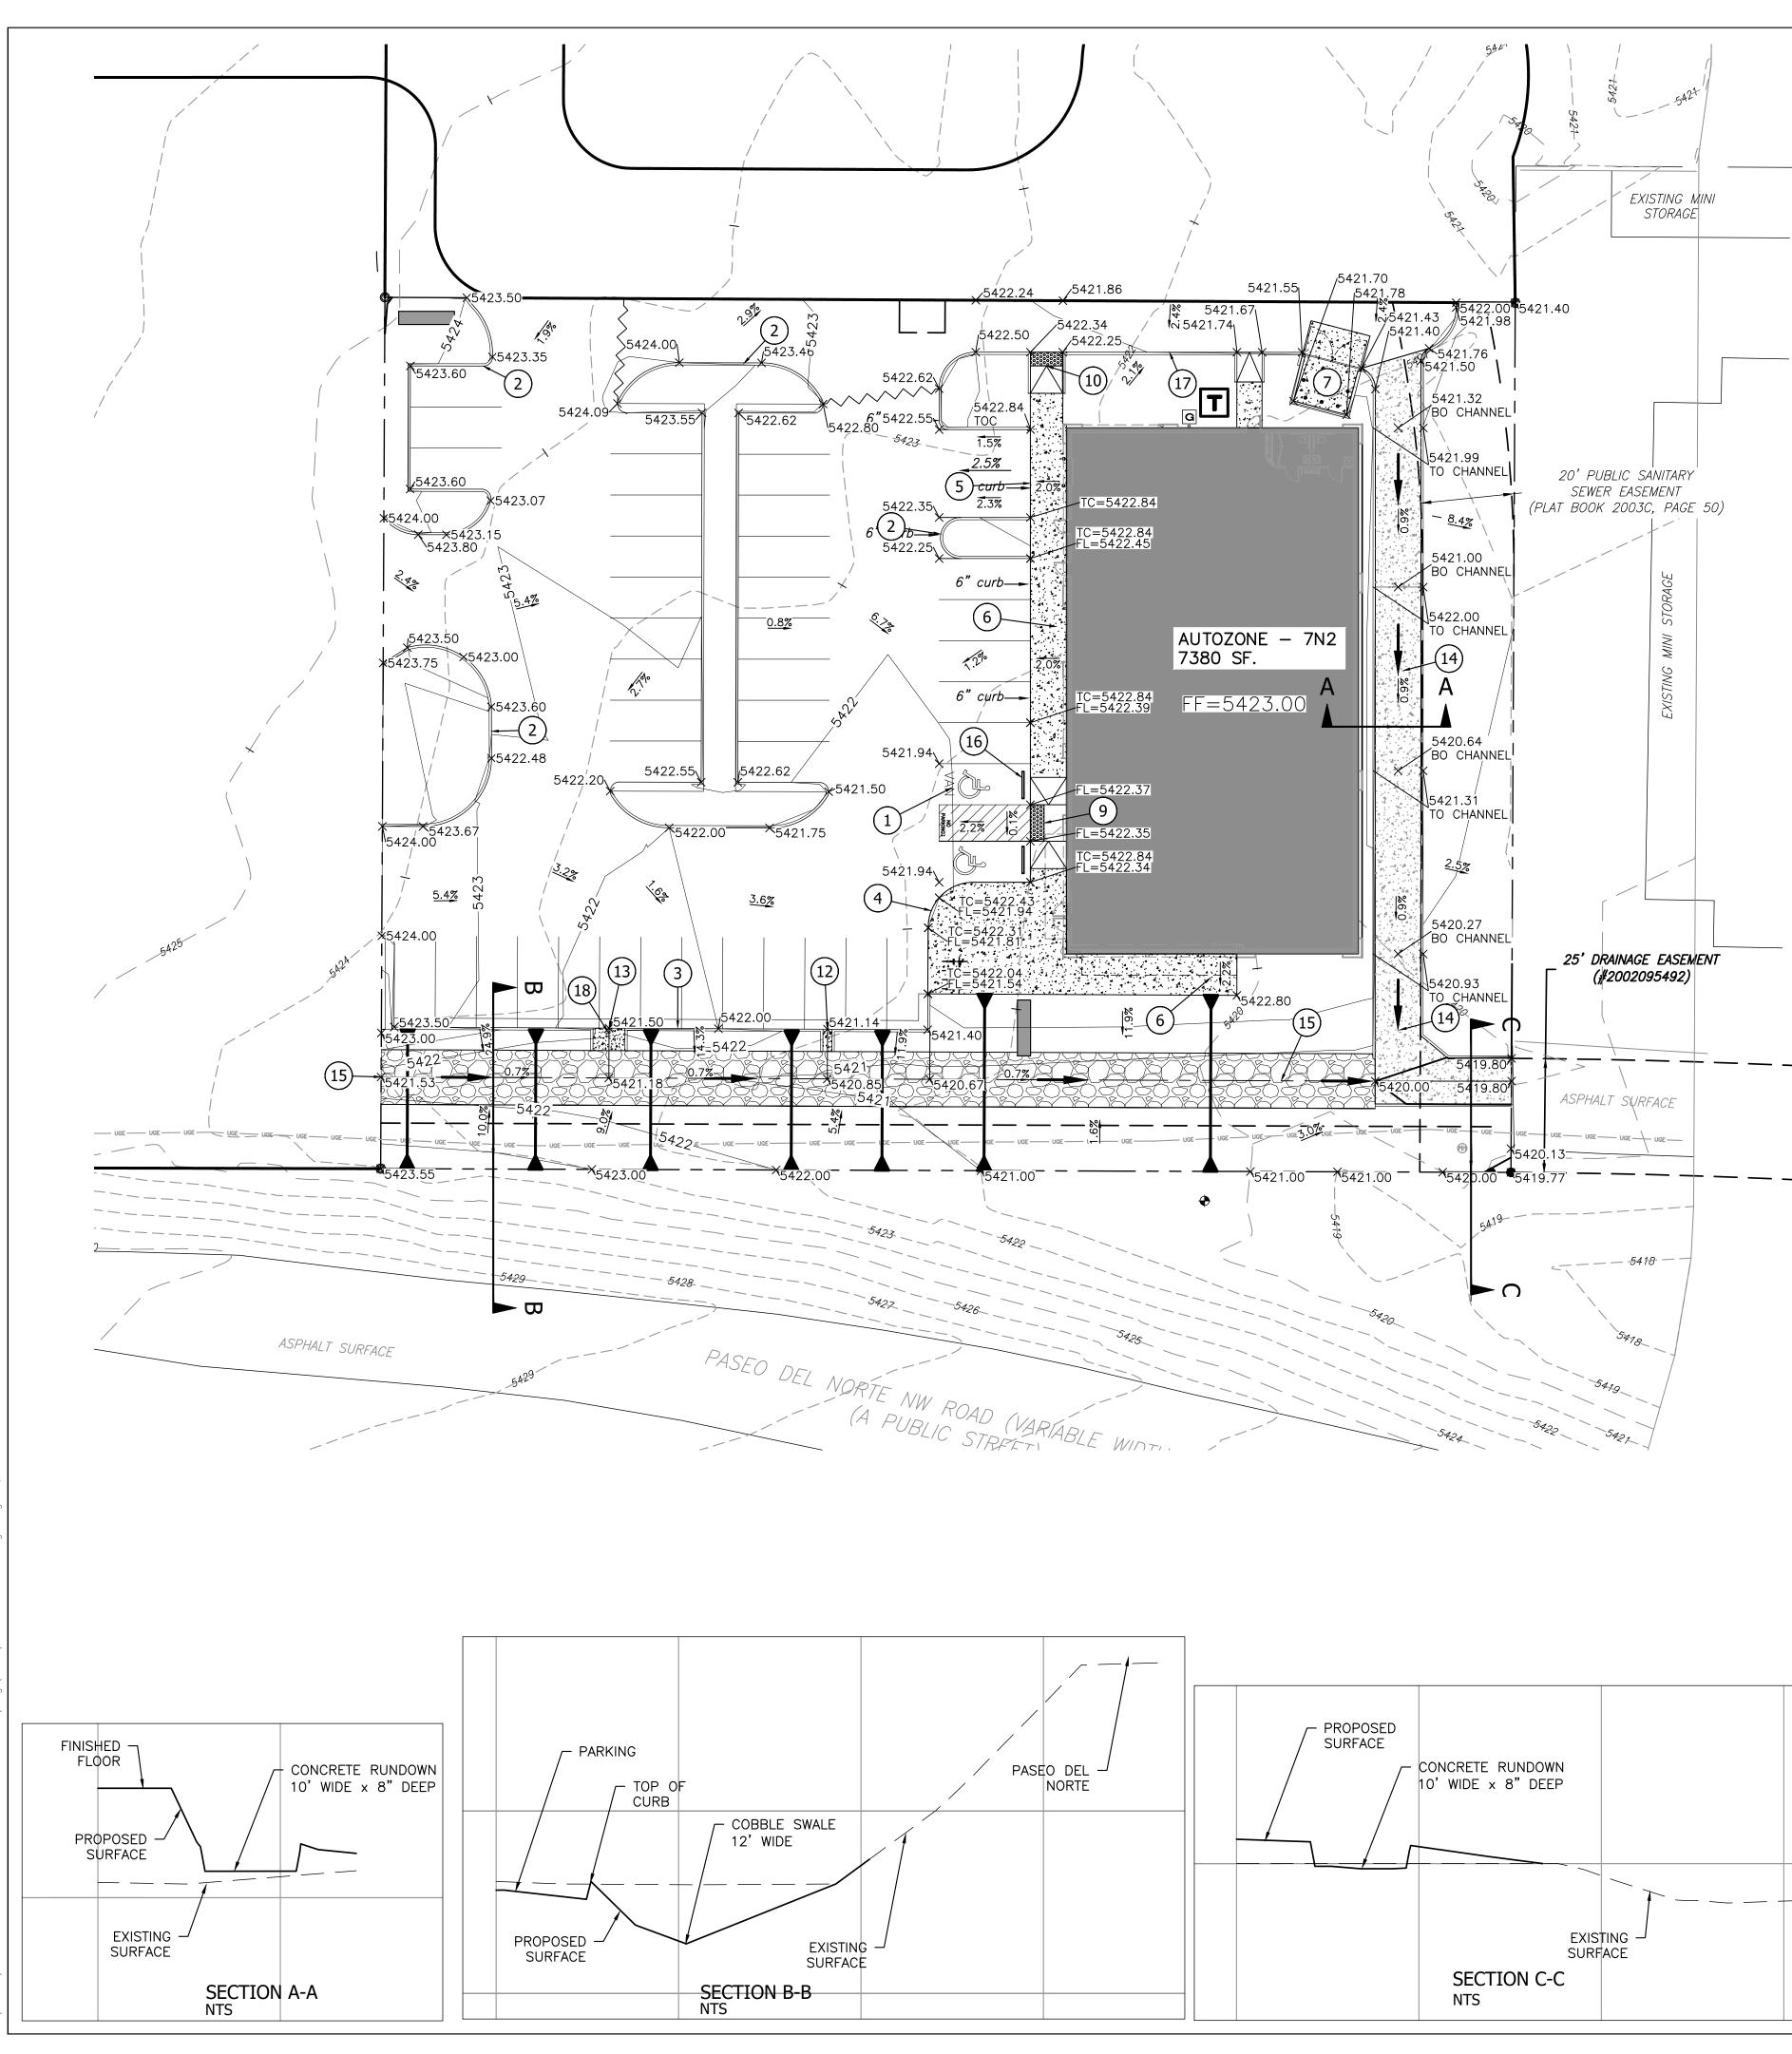


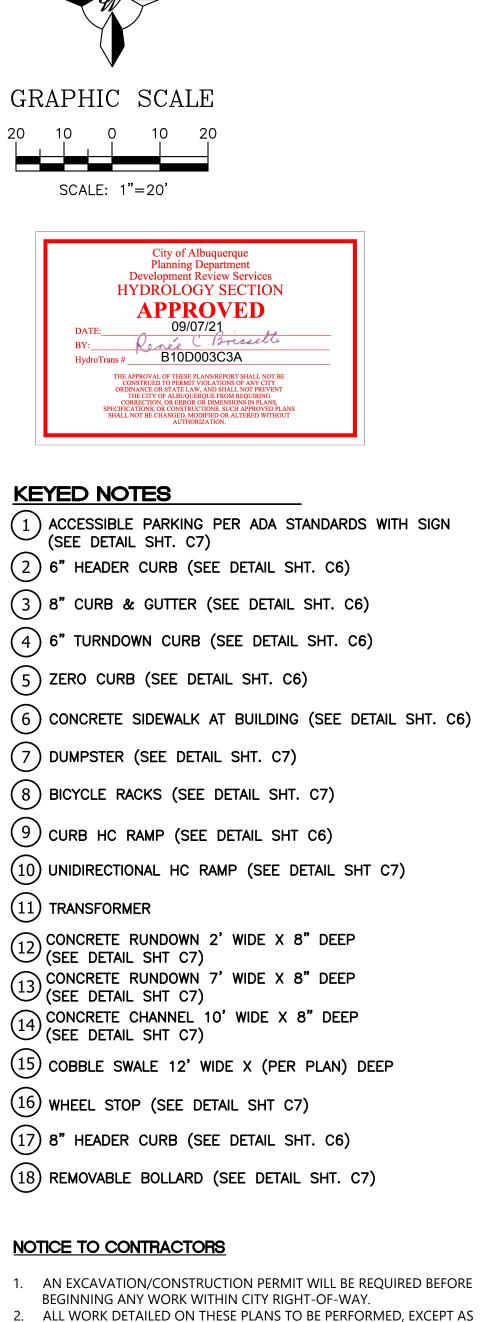

- OTHERWISE STATED OR PROVIDED HERON, SHALL BE CONSTRUCTED IN ACCORDANCE WITH CITY OF ALBUQUERQUE INTERIM STANDARD
- SPECIFICATIONS FOR PUBLIC WORKS CONSTRUCTION, 1985. 3. TWO WORKING DAYS PRIOR TO ANY EXCAVATION, THE CONTRACTOR MUST CONTACT NEW MEXICO ONE CALL, DIAL "811" [OR (505) 260-1990] FOR THE LOCATION OF EXISTING UTILITIES.
- 4. PRIOR TO CONSTRUCTION, THE CONTRACTOR SHALL EXCAVATE AND VERIFY THE HORIZONTAL AND VERTICAL LOCATIONS OF ALL
- 5. NOTIFY THE ENGINEER SO THAT THE CONFLICT CAN BE RESOLVED WITH A MINIMUM AMOUNT OF DELAY.
- 6. BACKFILL COMPACTION SHALL BE ACCORDING TO TRAFFIC/STREET USE. 7. MAINTENANCE OF THESE FACILITIES SHALL BE THE RESPONSIBILITY OF THE OWNER OF THE PROPERTY SERVED.
- WORK ON ARTERIAL STREETS SHALL BE PERFORMED ON A 24-HOUR BASIS. CONTRACTOR MUST CONTACT JASON RODRIGUEZ AT 235-8016 AND CONSTRUCTION COORDINATION AT 924-3416 TO SCHEDULE AN INSPECTION.

ALL EXISTING UTILITIES SHOWN WERE OBTAINED FROM RESEARCH, AS-BUILTS, SURVEYS OR INFORMATION PROVIDED BY OTHERS. IT SHALL BE THE SOLE RESPONSIBILITY OF THE CONTRACTOR TO CONDUCT ALL NECESSARY FIELD INVESTIGATIONS PRIOR TO AND INCLUDING ANY EXCAVATION, TO DETERMINE THE ACTUAL LOCATION OF UTILITIES AND OTHER IMPROVEMENTS, PRIOR TO STARTING THE WORK. ANY CHANGES FROM THIS PLAN SHALL BE COORDINATED WITH AND APPROVED BY THE ENGINEER.

CONNECTIONS. SHOULD A CONFLICT EXIST, THE CONTRACTOR SHALL

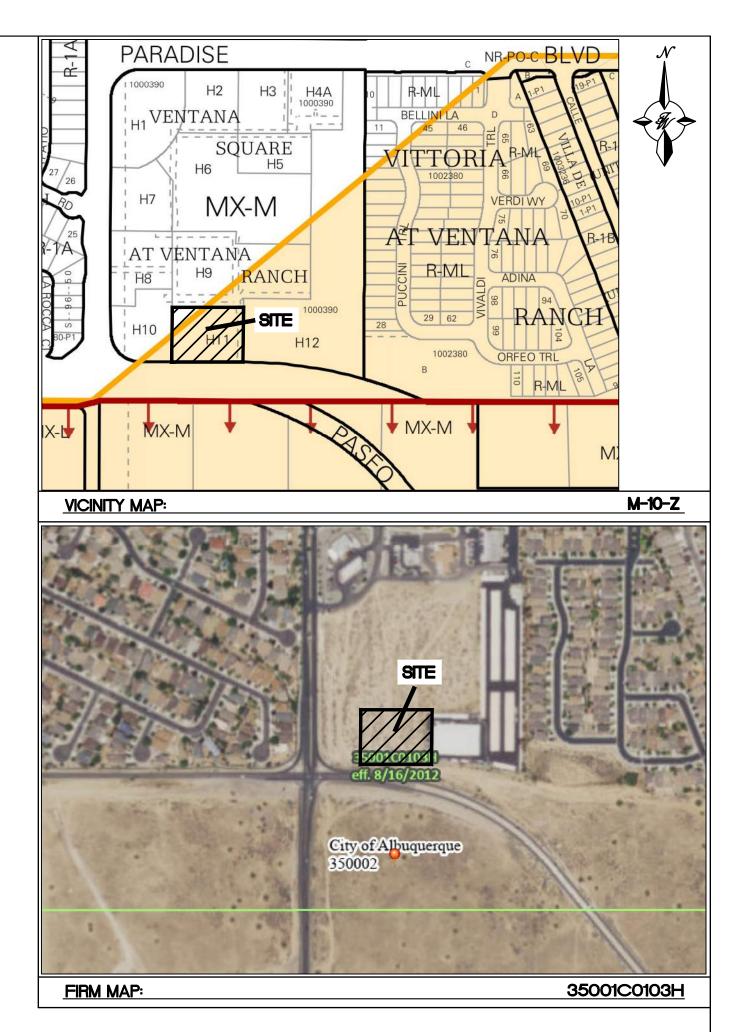

LEGEND

ENGINEER'S

DR. BON

NMEY

7868)

4/1/2021

RONALD R. BOHANNAN P.E. #7868

Fressional ENG

SEAL

	CURB & GUTTER
	BOUNDARY LINE
	EASEMENT
	CENTERLINE
	RIGHT-OF-WAY
	BUILDING
	SIDEWALK
	SCREEN WALL
	RETAINING WALL
5010	CONTOUR MAJOR
	CONTOUR MINOR
x 5048.25	SPOT ELEVATION
	FLOW ARROW
	EXISTING CURB & GUTTER
	EXISTING BOUNDARY LINE
5010	EXISTING CONTOUR MAJOR
— — — —5011– — — –	EXISTING CONTOUR MINOR
x 5048.25	EXISTING SPOT ELEVATION

AUTOZONE PASEO DEL NORTE & UNIVERSE BLVD

GRADING PLAN

TIERRA WEST, LLC 5571 MIDWAY PARK PLACE NE ALBUQUERQUE, NM 87109 (505) 858–3100

www.tierrawestllc.com


DRAWN BY BF DATE 04/01/21

2020074_GRE

SHEET #

C4

JOB # 2020074

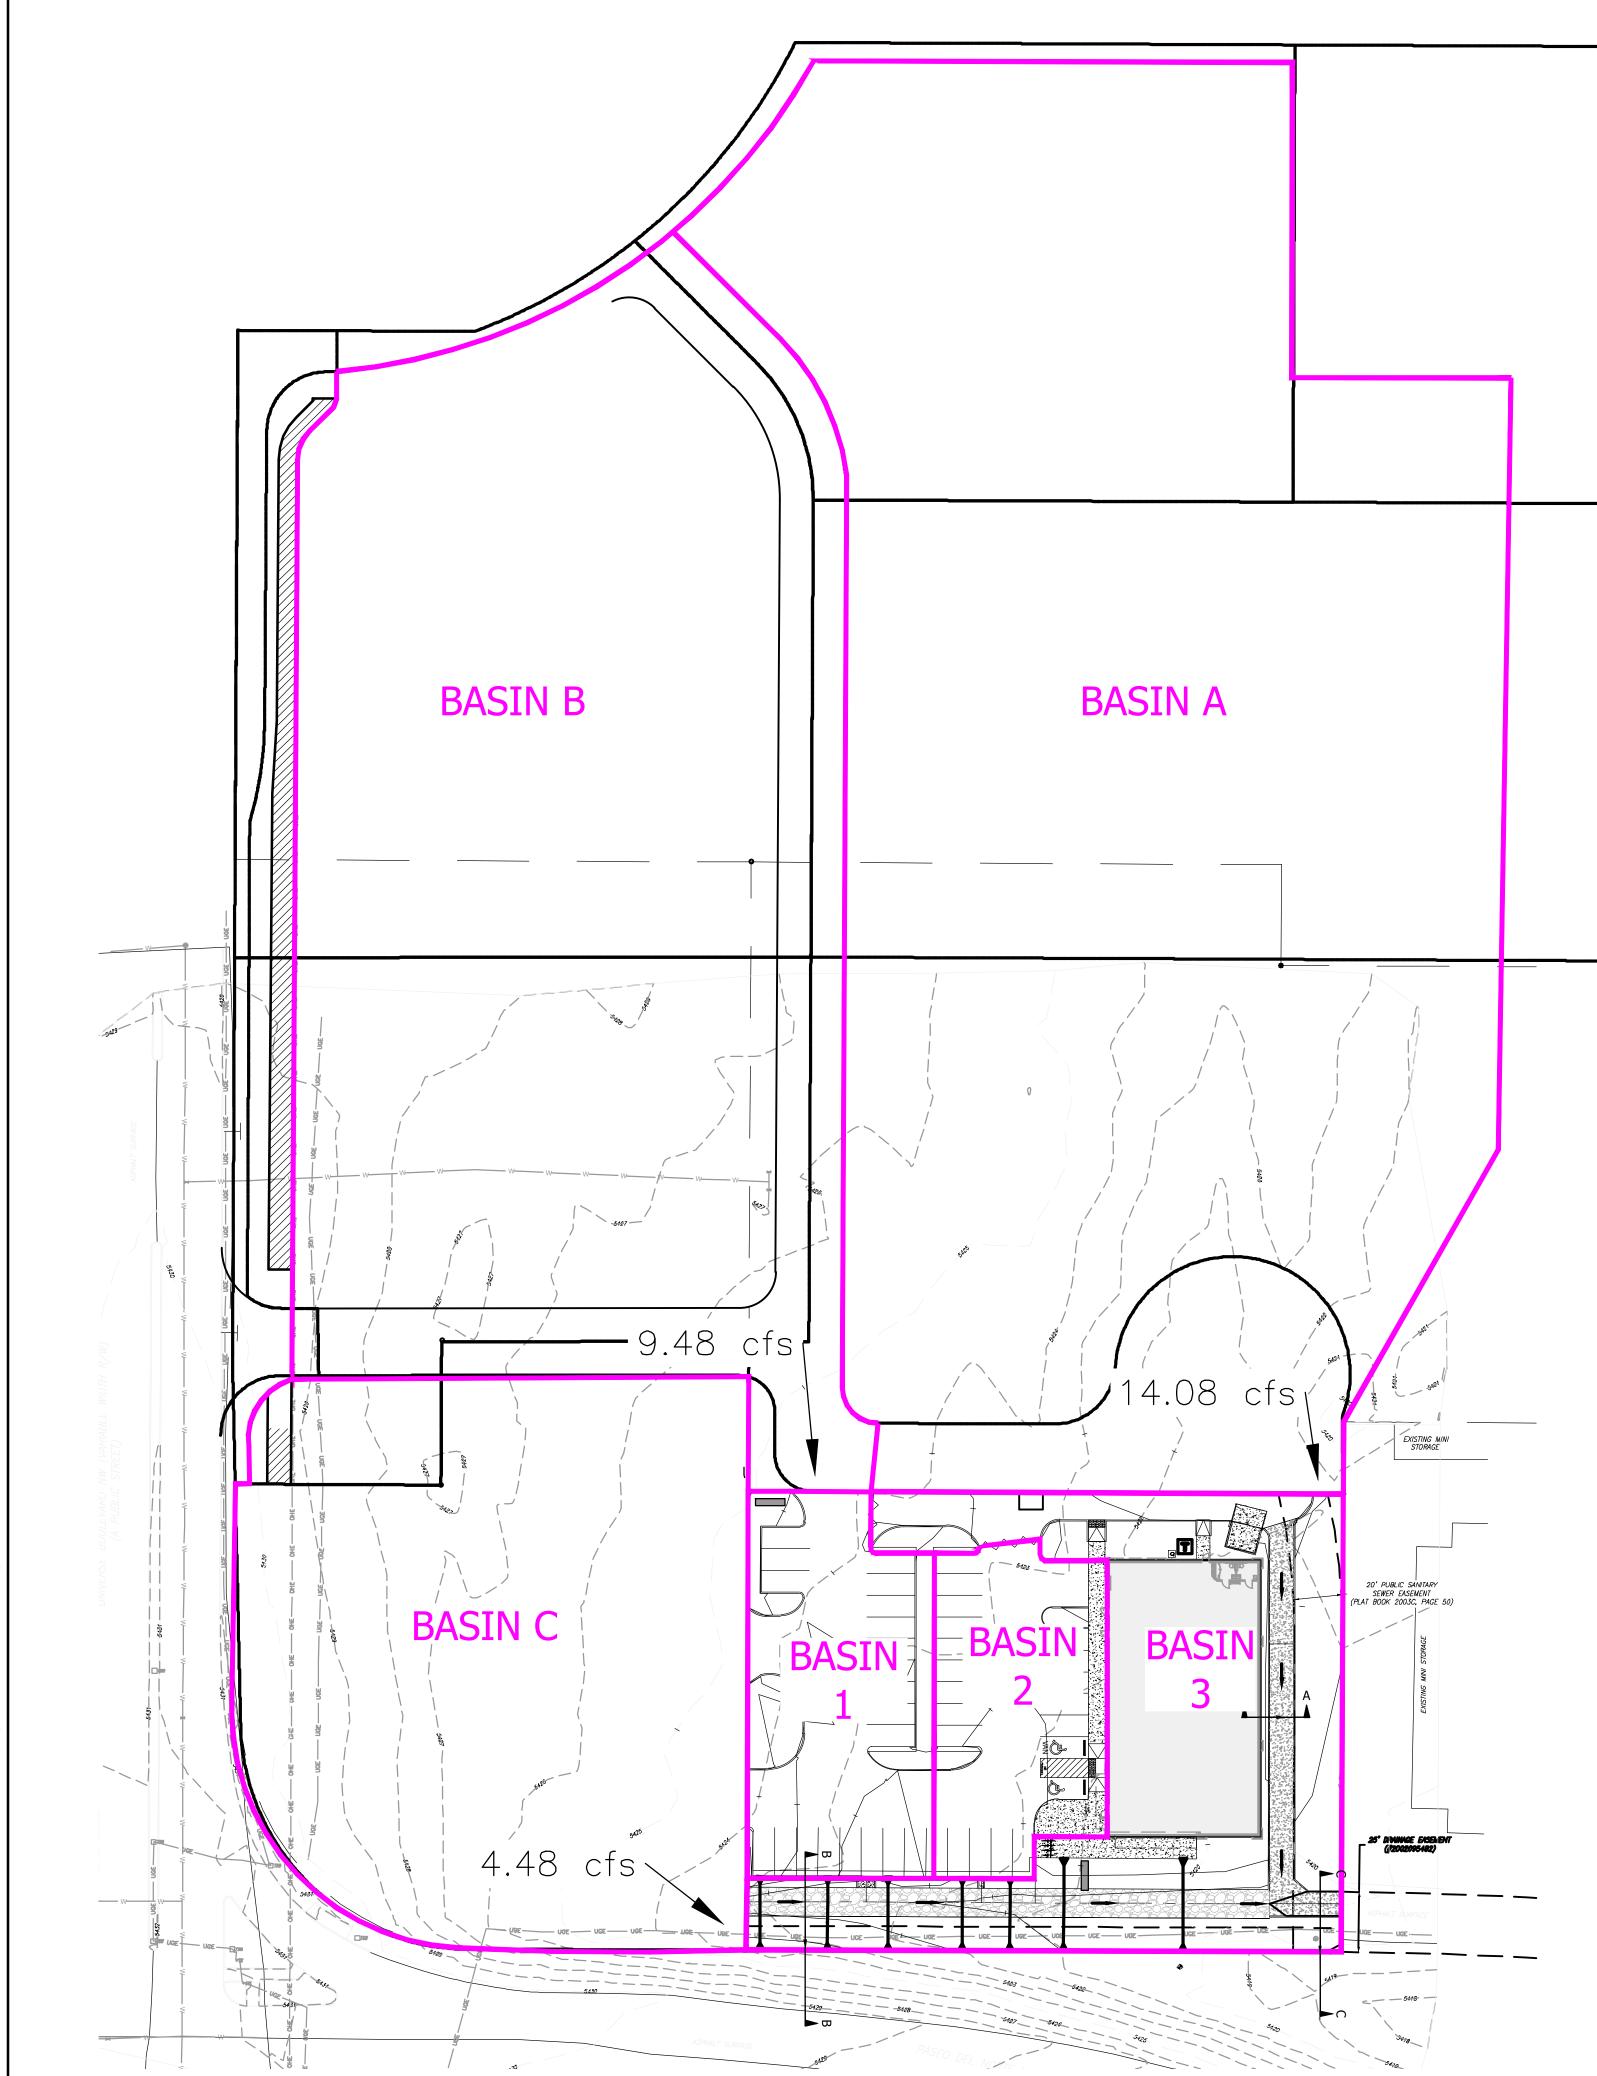

						Weigh	ted E	Method								
												100-Year			10-Year	
Basin	Area	Area	Trea	tment A	Trea	itment B	Treat	ment C	Treat	ment D	Weighted E	V olume	Flow	Weighted E	Volume	Flow
	(sf)	(acres)	%	(acres)	%	(acres)	%	(acres)	%	(acres)	(in)	(ac-ft)	cfs	(in)	(ac-ft)	cfs
A	150,847	3.46	V alues f	for the off-sit	e Basins	taken from /	Approved G	and E	rainage	Plan for \	/entana Squar	e	14.08			
В	112,080	2.57	complet	ed by Thom	ipson Eng	gineering dat	ed 07/30/2	1. (Hydrology	# B 10[0003C3			9.48			
C	51,665	1.19											4.48			
1	11,823	0.27	0%	0	15%		0%		85%	0.23	2.014	0.046	1.04	1.255	0.028	0.63
2	9,262	0.21	0%	0	5%	0.01	0%	0.00	95%	0.20	2.165	0.038	0.86	1.372	0.024	0.53
3	26,174	0.60	0%	0	13%	0.08	25%	0.15	62%	0.37	1.721	0.086	2.13	1.028	0.051	1.24
													32.07			
quatio	ns:															
						Excess Precipitation, E (inches)				Peak	Discharge (cf	s/acre)				
Veighte	dE=Ea*Aa+Eb*A	b+Ec*Ac	+ Ed*Ad	/ (Total Are	a)	Zone 1	100-Year	10 - Year		Zone 1	100-Year	10 - Year				
						Ea	0.55	0.11		Qa	1.54	0.3				
/ olume :	= Weighted D * Tota	al Area				Eb	0.73	0.26		Qb	2.16	0.81				
						Ec	0.95	0.43		Qo	2.87	1.46				
low = Q	a * Aa + Qb * Ab +	Qc*Ac+C	d*Ad			Ed	2.24	1.43		Qd	4.12	2.57				

		······		Cobble	Swale C	apacity				
	Top Width (ft)	Bottom Width (ft)	Depth (ft)	Area (ft^2)	WP (ft)	R	Slope (%)	Q Provided (cfs)	Q Required (cfs)	Velocity (ft/s)
Channel	12	0	1.5	9.00	12.37	0.7276	0.7	25.93	15.86	1.76
Manning's Equ										
Q = 1.49/n * A * F	R^(2/3) * S^(1/2	2)								
	Area									
R =	D/4									
S =	Slope									
n =	0.035									

Channel Capacity

Weir Equation:

- Q= Flow C = 2.95
- L= Length of weir H = Height of Weir

AutoZone Basin 1 Curb Opening

 $Q = 2.95 * 7 * 0.67 \frac{3}{2}$ Q = 11.32 cfs < Q = 10.52 cfs

AutoZone Basin 2 Curb Opening

 $Q = 2.95 * 2 * 0.67 \frac{3}{2}$

Q = 3.24 cfs < Q = 0.86 cfs

AutoZone Basin 3 Concrete Channel

 $Q = 2.95 * 10 * .67 \frac{3}{2}$

Q = 16.18 cfs < Q = 15.15 cfs

EXISTING DRAINAGE:

THIS SITE IS CURRENTLY VACANT AND LOCATED NEAR THE NORTHEAST CORNER OF PASEO DEL NORTE AND UNIVERSE BOULEVARD. THE PARCEL IS TRACT 11 OF THE VENTANA SQUARE AT VENTANA RANCH SUBDIVISION. THE SITE IS BOUNDED BY VACANT LOTS ON THE NORTH AND WEST SIDE AND A SELF-STORAGE DEVELOPMENT ON THE EAST AND PASEO DEL NORTE ON THE SOUTH AND CONTAINS APPROXIMATELY 1.09 ACRES. THE SITE DRAINS FROM NORTH TO SOUTH ENTERING A SWALE ALONG PASEO DEL NORTE AND EVENTUALLY INTO AN EXISTING RETENTION POND.

THIS PARCEL IS INCLUDED IN THE OVERALL DRAINAGE REPORT FOR VENTANA SQUARE TRACTS H-5-A THRU H-11 PREPARED BY THOMPSON ENGINEERING CONSULTANTS, INC. (B10D003C3) APPROVED ON 01/21/21. THIS PARCEL IS INCLUDED WITHIN DRAINAGE BASIN 400 WHICH DISCHARGES 32.55 CFS THRU THE AUTOZONE PARCEL AND TO THE EXISTING RETENTION POND.

THE SITE IS NOT LOCATED WITH IN A FLOOD PLAIN AS SHOWN ON THE FIRM MAP. THERE ARE NO OFFSITE FLOWS THAT ENTER THE SITE.

PROPOSED DRAINAGE:


SINCE ALL OF THE DRAINAGE FROM BASIN 400 DRAINS THROUGH THE AUTOZONE PARCEL THAT LARGE BASIN WAS BROKEN UP INTO 6 BASINS TO SPLIT THE FLOWS AROUND THE AUTOZONE BUILDING. BASIN "A" WILL DISCHARGE 13.43 CFS TO A CONCRETE CHANNEL LOCATED BEHIND THE AUTOZONE BUILDING. BASIN "B" WILL DISCHARGE 9.98 CFS THROUGH THE PARKING LOT OF THE AUTOZONE AND BE COLLECTED IN A PROPOSED COBBLE SWALE ALONG THE SOUTH PROPERTY LINE. BASIN "C" WILL DRAIN DIRECTLY TO THE PROPOSED COBBLE SWALE.

THE AUTOZONE SITE IS DIVIDED INTO 3 BASINS. BASIN 1 WILL ACCEPT THE 9.98 CFS FROM OFF-SITE AND DRAIN THROUGH A CURB OPENING SIZED FOR THE FLOWS TO THE COBBLE SWALE. BASIN 2 WILL DRAIN THROUGH A CURB OPENING TO THE COBBLE SWALE. BASIN 3 CONSISTS OF THE CONCRETE CHANNEL AND COBBLE SWALE.

THE COBBLE SWALE AND CONCRETE CHANNEL WILL CONNECT TO THE CONCRETE CHANNEL THAT WAS PROPOSED IN THE THOMPSON DRAINAGE REPORT TO BE BUILT BY OTHERS. THE TOTAL DISCHARGE TO THAT CHANNEL IS 32.04 CFS WHICH IS SLIGHTLY LESS THAN WHAT THE THOMPSON REPORT HAD CALCULATED.

THE WATER QUALITY VOLUME WILL BE CONTAINED IN THE EXISTING RETENTION POND WHICH IS SIZED FOR THE 100-YR, 10-DAY STORM AS STATED IN THE THOMPSON REPORT.



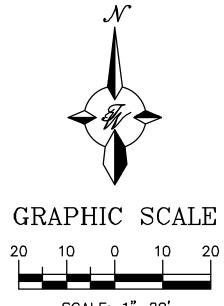

SCALE: 1"=20'

ALL EXISTING UTILITIES SHOWN WERE OBTAINED FROM RESEARCH, AS-BUILTS, SURVEYS OR INFORMATION PROVIDED BY OTHERS. IT SHALL BE THE SOLE RESPONSIBILITY OF THE CONTRACTOR TO CONDUCT ALL NECESSARY FIELD INVESTIGATIONS PRIOR TO AND INCLUDING ANY EXCAVATION, TO DETERMINE THE ACTUAL LOCATION OF UTILITIES AND OTHER IMPROVEMENTS, PRIOR TO STARTING THE WORK. ANY CHANGES FROM THIS PLAN SHALL BE COORDINATED WITH AND APPROVED BY THE ENGINEER.

ENGINEER'S SEAL	AUTOZONE	DRAWN BY
	PASEO DEL NORTE & UNIVERSE BLVD	BF
NALD R. BOHANNAL		<i>DATE</i> 04/01/21
NN METICO	DEVELOPED DRAINAGE	
(((7868)))	PLAN	2020074_GRE
PROFILES		SHEET #
4/1/2021	5571 MIDWAY PARK PLACE NE ALBUQUERQUE, NM 87109	C5
RONALD R. BOHANNAN P.E. #7868	(505) 858–3100 www.tierrawestllc.com	јов # 2020074