

Zone: "MX-M" Mised Use - Medium Intensity Zone District Proposed Use: Car Wash

## **Building Setbacks**

Front: 5 ft. (min.) Side, Interior: 0 ft. (min.) Side, Street: 5 ft. (min.) Rear:15 ft. (min.)

PERMITTING CONTACT INFORMATION:

PLANNING / ZONING / BUILDING City of Albuquerque - Planning Department **Contact: Brennon Williams** Telephone: 505.924.3860 Email: bnwilliams@cabq.gov

ROADS, ACCESS, & RIGHT-OF-WAY City of Albuquerque - Traffic Department Contact: MARWA AL NAJJAR Telephone: 505.924.3675 Email: malnajjar@cabq.gov

Albuquerque Bernalillo County Water Utility Authority Contact: Robert Strong Telephone: 505.261.4429 Email: rstrong@abcwua.org

## STORM SEWER

City of Albuquerque - Planning Hydrology Department Contact: Renee Brissette Telephone: 505.924.3995 Email: rbrissett@cabq.gov

New Mexico Gas Company Contact: Jacob Gallegos Telephone: 505.697.3120 Email: Jacob.Gallegos@nmgco.com

## **ELECTRIC** PNM (Public Service Company of New Mexico)

Contact: Chase LeJeune Telephone: 505-362-4180 Email: Chase.LeJeune2@pnm.com

TELECOM CenturyLink Contact: Customer Service Telephone: 865.465.2313

# 12'4 \_ | 4 412' \_ VACUUM BOOM AND CANOPY SYSTEM -SEE ARCHITECTURAL PLANS FOR DETAILS

TYPICAL VACUUM BOOM AND **CANOPY SYSTEM LAYOUT** NOT TO SCALE

WORK WITHIN PUBLIC RIGHT-OF-WAY REQUIRES DRC-APPROVED PLANS.

TAKE CAUTION DURING EXCAVATION: THERE ARE UNDERGROUND UTILITY MAINS IN THE CONSTRUCTION AREA WHICH MAY NOT HAVE BEEN LOCATED ACCURATELY BY THE SURVEYOR / UTILITY OWNERS. NOTIFY "811" IN ADVANCE OF DIGGING TO HAVE LINES MARKED.

## ACCESSIBLE PARKING SYMBOL & MARKING NOTES A paved accessible parking space must include: -The International Symbol if Accessibility conspicuously on the surface

in a color that contrasts the pavement. - The words "NO PARKING" painted on any access aisle adjacent to the parking space. Words must be painted in all capital letters with a letter height of at least


each access aisle adjacent to the parking space.


twelve inches, a stroke width of at least two inches, and centered within

Additional site elements are necessary to service the auto wash such as gates, floor mat cleaners, vending machines, vacuum equipment enclosures, vacuums, canopies, signage,

provided by the owner at the request of the contractor or the City of Albuquerque.

etc. which may not be shown on this plan. Locations and details of these elements can be

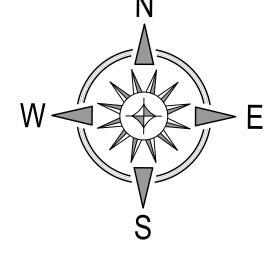

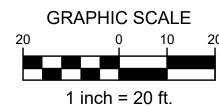

## SITE KEYNOTES

(01) NEW SINGLE TENANT SIGN - COORDINATE SIZE, LOCATION, AND PERMITTING WITH CHAMPION XPRESS CAR WASH PROJECT MANAGER. - CODE REQUIREMENTS:

POLE SIGN - MAX SIZE = 72 SQ-FT, MAX HEIGHT = 15 FT

(02) PAY STATION CANOPY

(03) TRAFFIC CIRCULATION SIGNAGE "DO NOT ENTER" - PER DETAIL / SHEET C-5.0

- SEE ARCHITECTURAL PLANS FOR DETAILS.

(04) ADA PARKING SIGNAGE - PER DETAIL / SHEET C-5.0

(05) ADA PARKING SYMBOL - PER DETAIL / SHEET C-5.0

(06) ADA ACCESSIBLE RAMP - PER DETAIL / SHEET C-5.0

(07) PARKING STRIPE / HATCH - 4" WIDE PAINTED STRIPES / 24" FOR STOP BAR. - HATCHING TO BE AT 45 DEGREE AND 2'-0" O.C. - STRIPING ON CONCRETE PAVEMENT TO BE PAINTED YELLOW.

- PROVIDE PIPE BOLLARDS PER DETAIL / SHEET C-5.0

(08) CONCRETE DUMPSTER PAD & APRON PAD TO BE CONSTRUCTED OF MIN. 8 IN. THICK 3500 PSI CONCRETE REINFORCED WITH MIN. #4 REBARS @ 12 IN. O.C. IN EACH DIRECTION LOCATED IN THE UPPER THIRD OF SLAB.

- PROVIDE ONE (1) DUMPSTER. - SEE ARCHITECTURAL PLANS & CITY DETAILS FOR TRASH ENCLOSURE DETAILS AND PIPE BOLLARD LAYOUT.

(09) VACUUM EQUIPMENT ENCLOSURE - SEE ARCHITECTURAL PLANS FOR DETAILS

(10) CONCRETE PAVEMENT - TRAFFIC - PER PAVEMENT SECTION / SHEET C-5.0

(11) CONCRETE SIDEWALK - PER DETAILS / SHEET C-5.0

(12) CONCRETE WHEEL STOP - PER DETAIL / SHEET C-5.0

(13) CONCRETE BARRIER CURB

- PER DETAIL / SHEET C-5.0 (14) CURB CUT FOR CROSS DRAINAGE (5' WIDE)

(15) CONCRETE LAYDOWN CURB - PER DETAIL / SHEET C-5.0

- PER DETAIL / SHEET C-5.0

(16) CURB FLUSH WITH DRIVE PAVEMENT IN ADA PARKING AREA.

(17) BICYCLE PARKING (2 RACKS) - PER DETAIL / SHEET C-2.0

(18) MOTORCYCLE PARKING SIGNAGE - PER DETAIL / SHEET C-2.0

PLANNING AND ZONING REQUIREMENTS Reference: City of Albuquerque Integrated Development Code

Zone: "MX-M" Mised Use - Moderate Intensity Zone District

**Building Setbacks** Front: 5 ft. (min.) Side, Interior: 0 ft. (min.) Side, Street: 5 ft. (min.) Rear:15 ft. (min.)

Proposed Use: Car Wash

12" WIDE SECTION OF ASPHALT PAVEMENT ADJACENT TO NEW CURB AND GUTTER SHALL BE SAWCUT, REMOVED, AND REPLACED AS PER CITY OF ALBUQUERQUE STANDARD SPECIFICATIONS. PAVEMENT SECTION PER DETAIL / SHEET C-2.2 OR MATCH EXISTING SECTION. PER CITY OF ALBUQUERQUE STANDARD DETAIL DRAWING No. 2407 & 2408

## SITE AND PAVEMENT LEGEND

(E/P) EDGE-OF-PAVEMENT

(B/C) BACK-OF-CURB TYPICAL PARKING STALL WIDTH

RADIUS - FACE OF CURB

CONCRETE WHEEL STOP

ADA PARKING SYMBOL

PROPOSED LIGHT POLE


DIRECTIONAL PARKING LOT ARROW

CONCRETE SIDEWALK

ASPHALT PAVEMENT - TRAFFIC

CONCRETE PAVEMENT - TRAFFIC

Know what's below. Call before you dig.

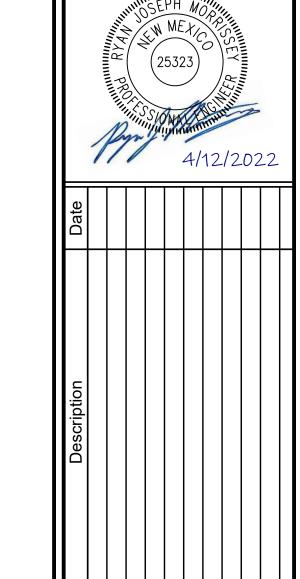

တြ  $\Box$ 



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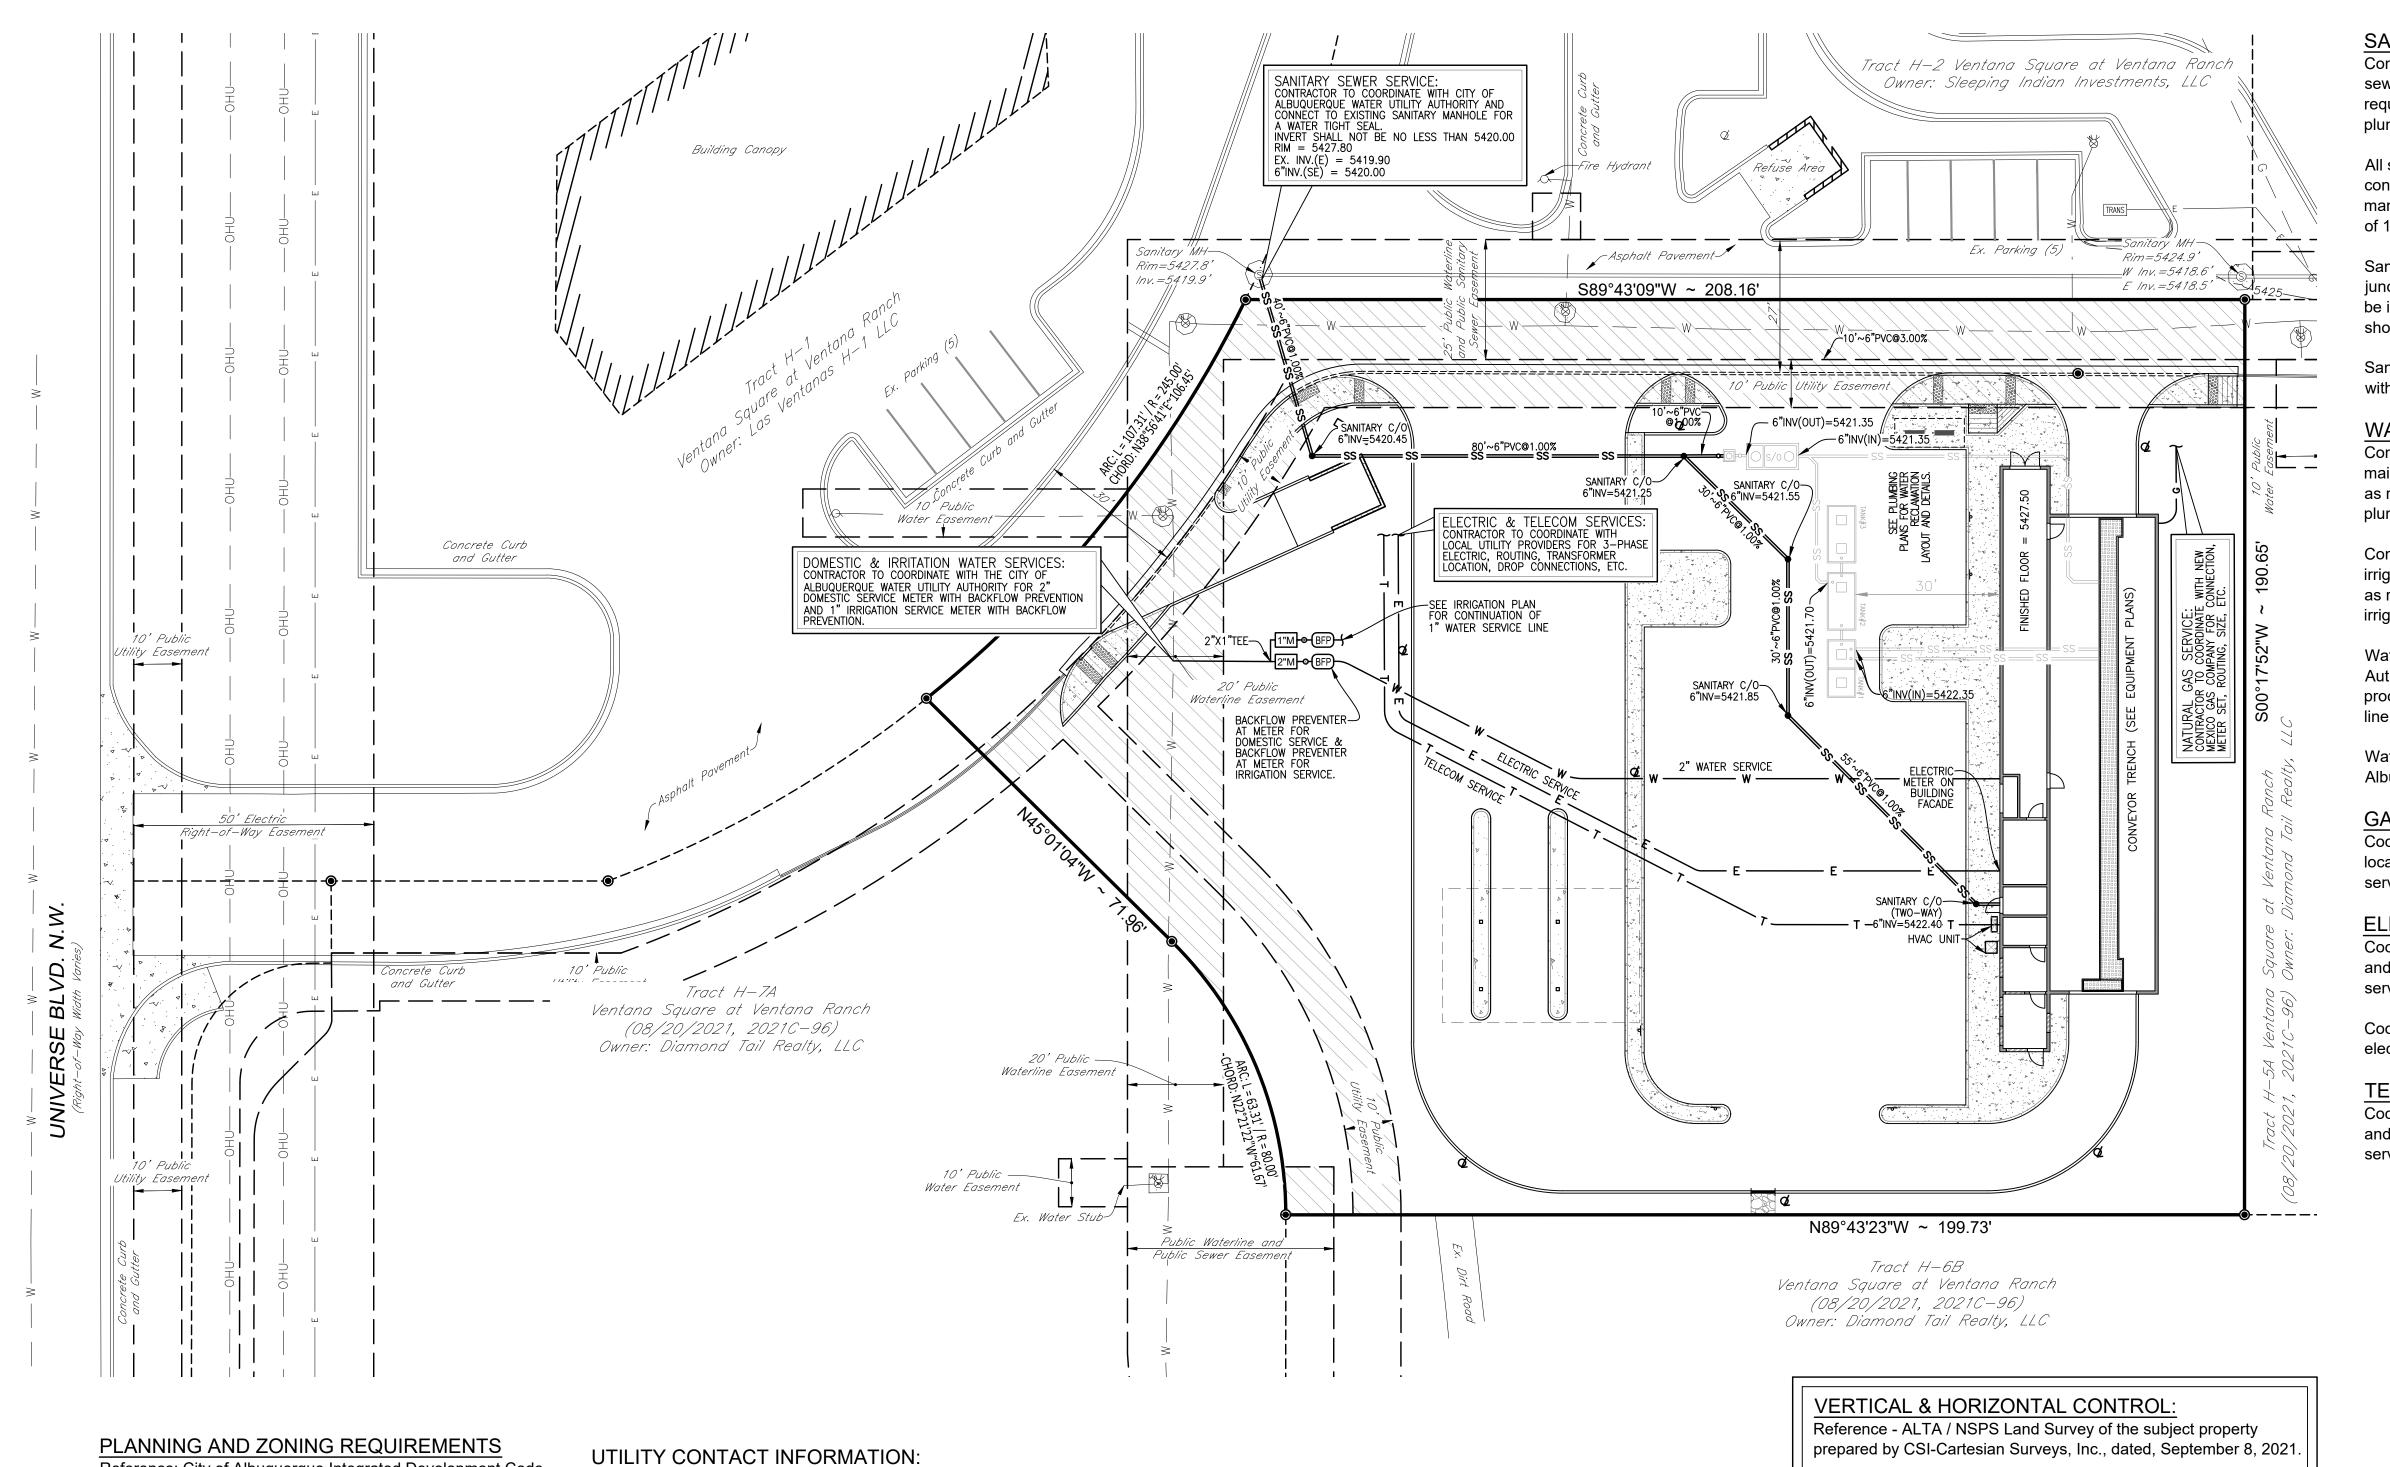
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Scale: 1" = 20'

04.12.2022

SITE PLAN

Sheet No.:



Reference: City of Albuquerque Integrated Development Code Zone: "MX-M" Mised Use - Medium Intensity Zone District Proposed Use: Car Wash

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SANITARY SEWER / WATER Albuquerque Bernalillo County Water Utility Authority Contact: Robert Strong Telephone: 505.261.4429 Email: rstrong@abcwua.org

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## GAS

Contact: Jacob Gallegos Telephone: 505.697.3120

## **ELECTRIC**


PNM (Public Service Company of New Mexico) Contact: Chase LeJeune Telephone: 505-362-4180 Email: Chase.LeJeune2@pnm.com


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## **SANITARY SEWER NOTES:**

Contractor to provide 6" (min.) sanitary sewer service line from building to public sewer main. Install tap, manholes, cleanouts and other appurtenances as required by the local utility provider. Coordinate building connection with plumbing plans.

All sanitary sewer pipe shall be P.V.C. SDR 35, ASTM D-3034 with joints conforming to ASTM 3212. All pipe shall be installed in accordance with the manufacturer's recommended procedures and shall maintain a minimum slope of 1.00%.

Sanitary sewer clean-outs shall be installed at all sewer pipe bends, angles, and junctions, unless a manhole is indicated. All cleanouts in pavement areas shall be installed with traffic bearing lids and concrete collars. Cleanout spacing should not exceed 100'. Per detail / Sheet C-5.0.

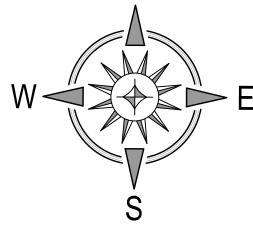Sanitary sewer service connection, permit and construction to be coordinated with Albuquerque Water Utility Authority.
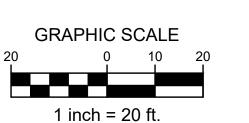
## **WATER NOTES:**

Contractor to provide 2" (min.) domestic water service line from public water main to building. Install tap, meter, backflow preventer, and other appurtenances as required by the local utility provider. Coordinate building connection with plumbing plans.

Contractor to provide 1" (min.) irrigation service line from public water main to irrigation meter. Install tap, meter, backflow preventer, and other appurtenances as required by the local utility provider. Coordinate with Irrigation Contractor, irrigation plans and plumbing/electrical plans.

Water service lines shall be Polyethylene PE4710 or Albuquerque Water Utility Authority approved material, installed per manufacturer's recommended procedures. Lines shall be installed with a minimum cover of 42" or below frost line, whichever is greater.

Water service connection, meter, permit and construction to be coordinated with Albuquerque Water Utility Authority.

### **GAS NOTES:**

Coordinate gas service lines, meter, and connections with mechanical plans and local utility provider. Contractor shall verify both location and availability of service prior to the start of construction.


### **ELECTRIC NOTES:**


Coordinate electric service lines, meter, and connections with electrical plans and local utility provider. Contractor shall verify both location and availability of service prior to the start of construction.

Coordinate site lighting, signage wiring, conduit locations, connections, etc. with electrical plans. Notify Engineers of any potential conflicts.

## **TELECOM NOTES:**

Coordinate telecommunication service lines and connections with electrical plans and local utility provider. Contractor shall verify both location and availability of service prior to the start of construction.

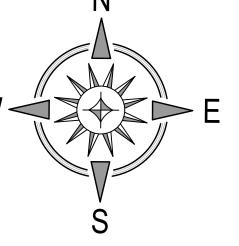

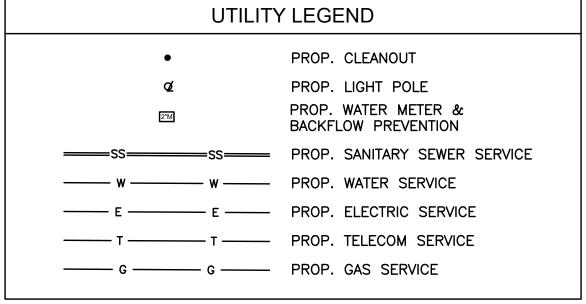



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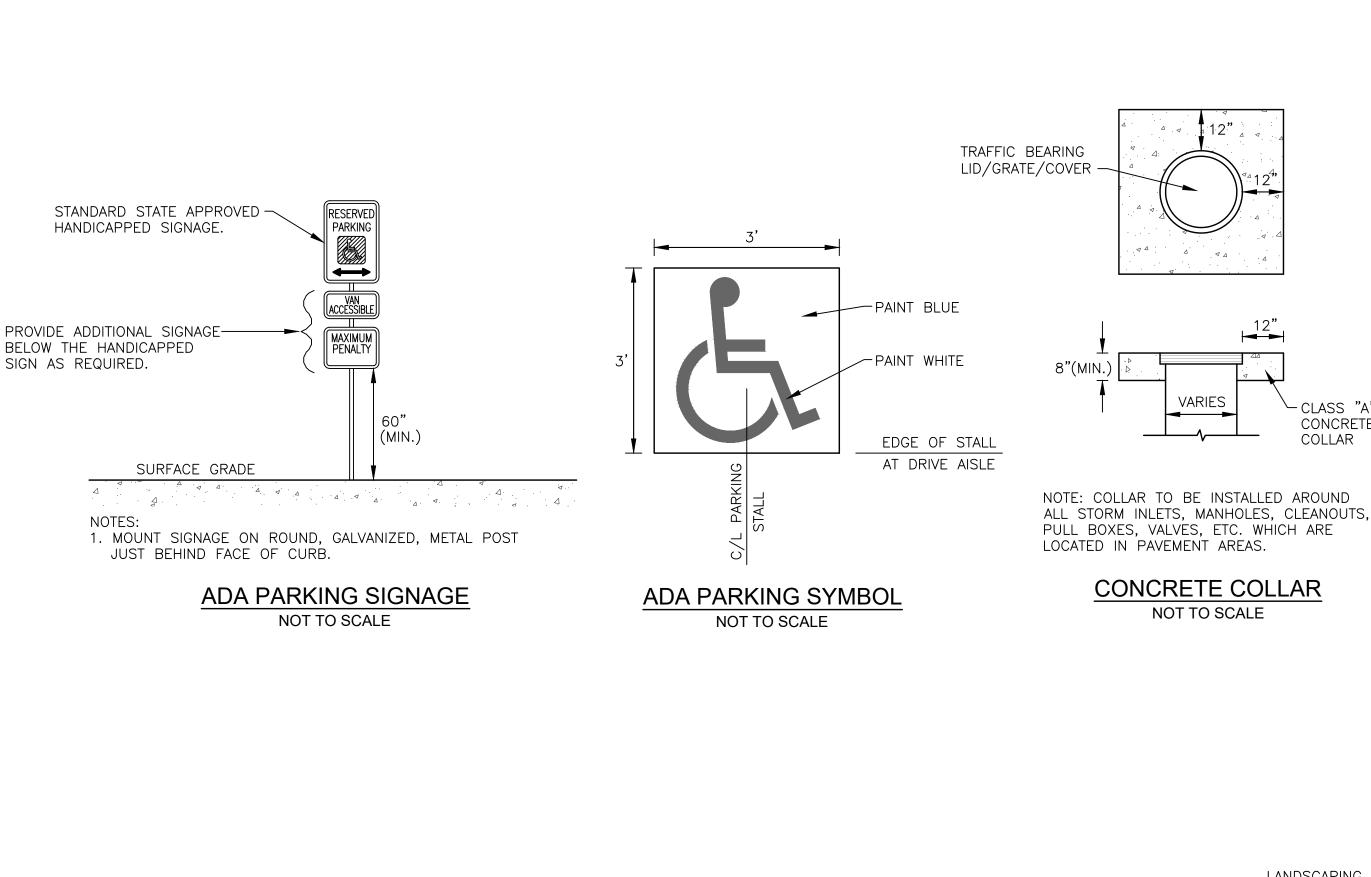
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04.12.2022

UTILITY PLAN

Sheet No.:

C-4.0



1. PRE-CAST CONCRETE WHEEL STOPS SHALL

BE DOWELED TO PAVEMENT & LOCATED 2 FT.

2. PAINT ALL WHEEL STOPS "SAFETY YELLOW"

CONCRETE WHEEL STOP

NOT TO SCALE

FROM EDGE OF OBSTRUCTION.

5/8" DOWEL. 1 FT. TROM EACH END

5"(MIN)

OR AS LOCAL CODES REQUIRE.

R5-1 SIGN-

SURFACE GRADE

"DO NOT ENTER" SIGNAGE


NOT TO SCALE

INSTALL SIGNAGE ON ROUND,—— GALVANIZED, METAL POST 2'(MIN.)

FROM FACE OF CURB.

Know what's below.

Call before you dig.

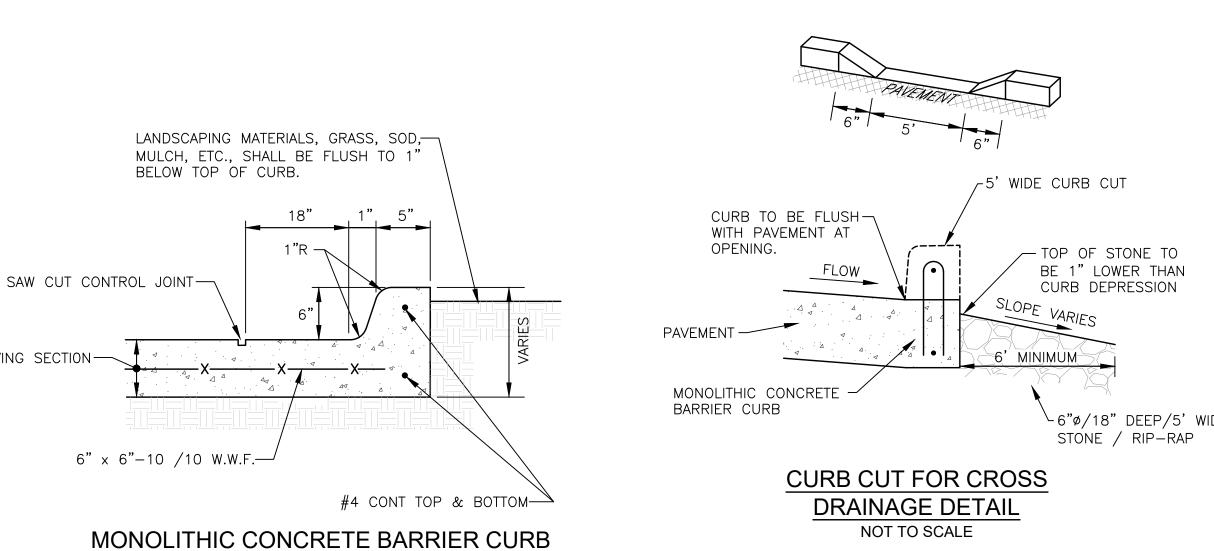

6" CLEAN-OUT W/-

FINISHED GRADE

6" PVC SEWER LATERAL -

@ 1.00% MINIMUM SLOPE

NOTE: CLEAN OUT TO HAVE TRAFFIC BEARING LID AND CONCRETE COLLAR IF INSTALLED IN PAVEMENT AREAS.

**SANITARY CLEAN-OUT** 


NOT TO SCALE

-6" 45° BEND

LID SET TO GRADE

NOT TO SCALE

- CLASS "A" CONCRETE COLLAR

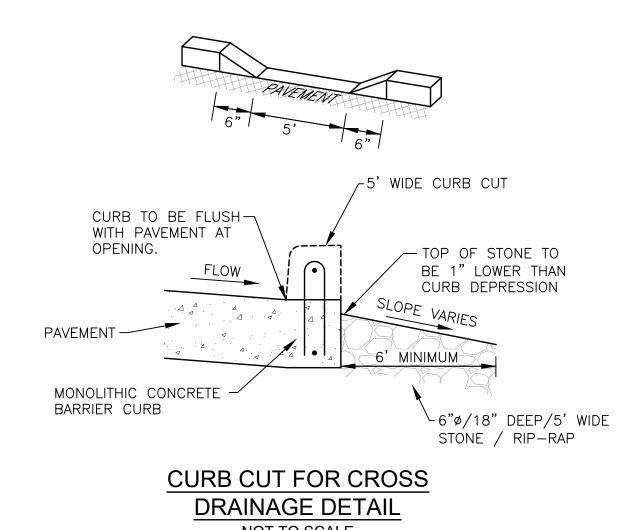

- C.I. CLEANOUT FERRULE AND BRONZE SCREW PLUG SET

· <sup>Δ</sup>

— 6" PVC SEWER LATERAL

@ 1.00% MINIMUM SLOPE

SANITARY TWO-WAY CLEAN-OUT DETAIL

NOT TO SCALE


FLUSH IN ADJACENT SURFACE

FINISHED GRADE

-4" CONCRETE COLLAR

FERNCO FITTING

-6"X6" WYE

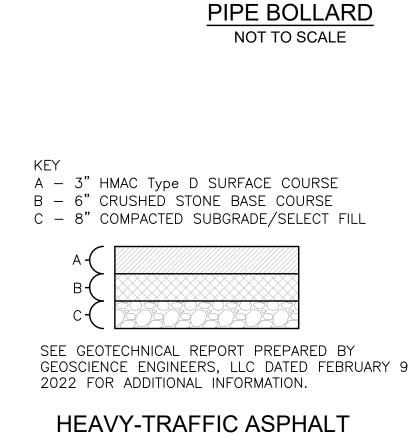

"DRIVEWAY AREA"

PAVEMENT SECTION

NOT TO SCALE

A - 7" PORTLAND CEMENT CONCRETE

REINFORCED WITH #3 REBAR

SEE GEOTECHNICAL REPORT PREPARED BY

**CONCRETE PAVEMENT SECTION** 

- TRAFFIC -NOT TO SCALE

2022 FOR ADDITIONAL INFORMATION.

GEOSCIENCE ENGINEERS, LLC DATED FEBRUARY 9

3500 PSI, AIR ENTRAINED

AT 24" O.C., EACH WAY

B - 8" SELECT FILL SUPPORT

6" DIAMETER STEEL -(PAINTED) PIPE BOLLARD

CONCRETE. PROVIDE DOME

FINISHED GRADE T


3'-0"

TOP. SET IN 4000 PSI

FILLED SOLID WITH

CONCRETE.

4'-0"

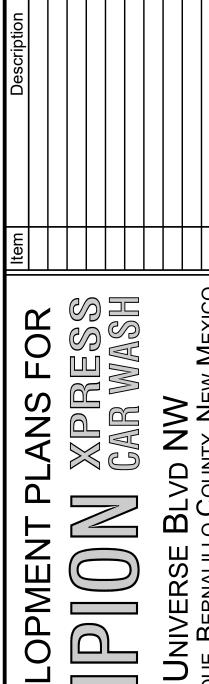




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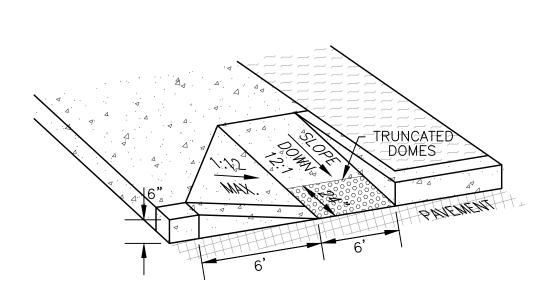
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SITE DETAILS


C-5.0





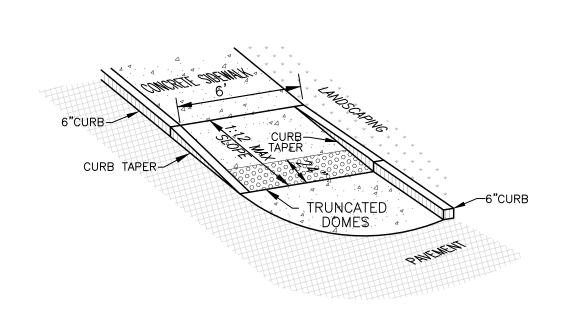


ADA ACCESSIBLE RAMP DETAILS NOT TO SCALE

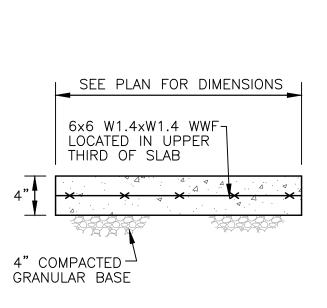

1. SIDEWALK TO BE CONSTRUCTED USING 3500 PSI CONCRETE. 2. SIDEWALK TO HAVE TOOLED CONTROL JOINTS NOT EXCEEDING 5 FT. SPACING IN ANY DIRECTION.

> **CONCRETE SIDEWALK** PAVEMENT SECTION NOT TO SCALE

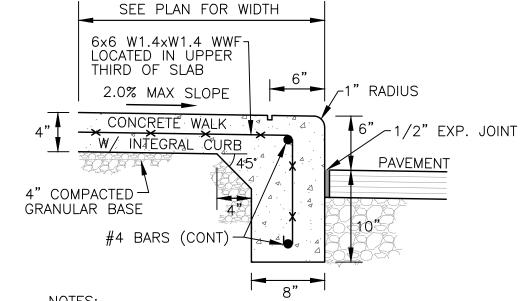

1. SIDEWALK WITH INTEGRAL CURB TO BE CONSTRUCTED OF 3500 PSI CONCRETE (MIN.). 2. SIDEWALK TO HAVE JOINTS NOT EXCEEDING 5 FT. SPACING IN ANY DIRECTION.

> CONCRETE SIDEWALK WITH INTEGRAL CURB NOT TO SCALE