CITY OF ALBUQUERQUE

Planning Department Suzanne Lubar, Director



Mayor Richard J. Berry

January 30, 2017

David Soule, P.E. Rio Grande Engineering PO Box 93924 Albuquerque, New Mexico 87199

RE: Paradise Universal Apartments Buglo Rd NW Grading and Drainage Plan Engineers Stamp Date 1/26/17 (B11D010)

Dear Mr. Soule,

Based upon the information provided in your submittal received 1/27/17, this plan is approved for Site plan for Building Permit. Do to the slope of this parcel a Erosion and Sediment Control Plan (ESC) will be required. A Grading Permit or Building permit will not be awarded until the ESC plan has been accepted by Curtis Cherne.

Albuquerque Please inform the owner/contractor to attach a copy of this approved plan dated 1/26/17 to the construction sets in the permitting process prior to sign-off by Hydrology. Also inform the owner/contactor that a separate permit will be required for any future wall/fence, etc.

New Mexico 87103 Prior to Certificate of Occupancy release, Engineer Certification per the DPM checklist will be required.

www.cabq.gov

If you have any questions, please contact me at 924-3999 or Rudy Rael at 924-3977.

Sincerely,

Shahab Biazar, P.E. City Engineer, Albuquerque Planning Department

RR/SB C: File



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City of Albuquerque

Planning Department Development & Building Services Division DRAINAGE AND TRANSPORTATION INFORMATION SHEET (REV 11/2016)

Project Title:	Building Permit #:		Hydrology File #:		
DRB#:	EPC#:		Work Order#:		
Legal Description:					
City Address:					
Applicant: RIO GRANDE ENG	INEERING		Contact: DAVID SOULE		
Address: PO BOX 93924 A		87199			
Phone#: 505.321.9099			E-mail:		
Other Contact:			Contact:		
Address:					
Phone#:			E-mail:		
Check all that Apply:					
		TYPE OF APP	ROVAL/ACCEPTANCE SOUGHT:		
DEPARTMENT:		BUILDING PERMIT APPROVAL			
HYDROLOGY/ DRAINAGE TRAFFIC/ TRANSPORTATION		CERTIFIC	ATE OF OCCUPANCY		
TYPE OF SUBMITTAL:		PRELIMIN	JARY PLAT APPROVAL		
ENGINEER/ARCHITECT CERTIF	ICATION		SITE PLAN FOR SUB'D APPROVAL		
			N FOR BLDG. PERMIT APPROVAL		
CONCEPTUAL G & D PLAN		FINAL PLAT APPROVAL			
GRADING PLAN					
DRAINAGE MASTER PLAN		SIA/ RELE	EASE OF FINANCIAL GUARANTEE		
DRAINAGE REPORT		FOUNDATION PERMIT APPROVAL			
CLOMR/LOMR		GRADING PERMIT APPROVAL			
		SO-19 API			
TRAFFIC CIRCULATION LAYOU	T (TCI)		NG PERMIT APPROVAL		
TRAFFIC IMPACT STUDY (TIS)	1 (102)	GRADING/ PAD CERTIFICATION			
			DER APPROVAL		
OTHER (SPECIFY)		CLOMR/L			
PRE-DESIGN MEETING?					
IS THIS A RESUBMITTAL?: Yes	No	OTHER (S	SPECIFY)		
DATE SUBMITTED:	•				
COA STAFF:	ELECTRONIC	ELECTRONIC SUBMITTAL RECEIVED:			
	FEE PAID:				

Mr. Rael,

Engineer Assistant, Planning Department 600 2nd St. NW Suite 201 Albuquerque NM 87102 Pleae find the attached plan


Pleae find the attached plan. We have revised the plan to address your comments listed below. The manner in which we address are underlined :

- Provide erosion protection at the pipe opening in the pond. <u>We have added</u>
- Provide labels for contour lines.
 We have labeled
- Recommend that a turn block 3" above grade in the garden walls is placed for emergency overflow out of rear yards.
 We have added to the notes
- Provide a sketch of the retaining wall or a statement stating the retaining walls are built by others.
- This is shown on note #3
 Provide a note stating the walls require a separate permit. We have added to notes
- Provide a 1' wide sidewalk culvert extending 1' passed the property line in lieu of the 2" pipe penetration in the curb.
 We have added the culvert and note
- Provide SO-19 notes for the sidewalk culvert.
 We have added the so19 notes
- Provide a note stating the owner is responsible for the maintenance and up keep of the pond and sump pump.
 We have added the note
- What is the 3:1 slope tie referring to? We have added a note showing the 3:1 is slope tie from building to property line

David Soule Rio Grande Engineering

CAUTION:

EXISTING UTILITIES ARE NOT SHOWN. IT SHALL BE THE SOLE RESPONSIBILITY OF THE CONTRACTOR TO CONDUCT ALL NECESSARY FIELD INVESTIGATIONS PRIOR TO ANY EXCAVATION TO DETERMINE THE ACTUAL LOCATION OF UTILITIES & OTHER IMPROVEMENTS.

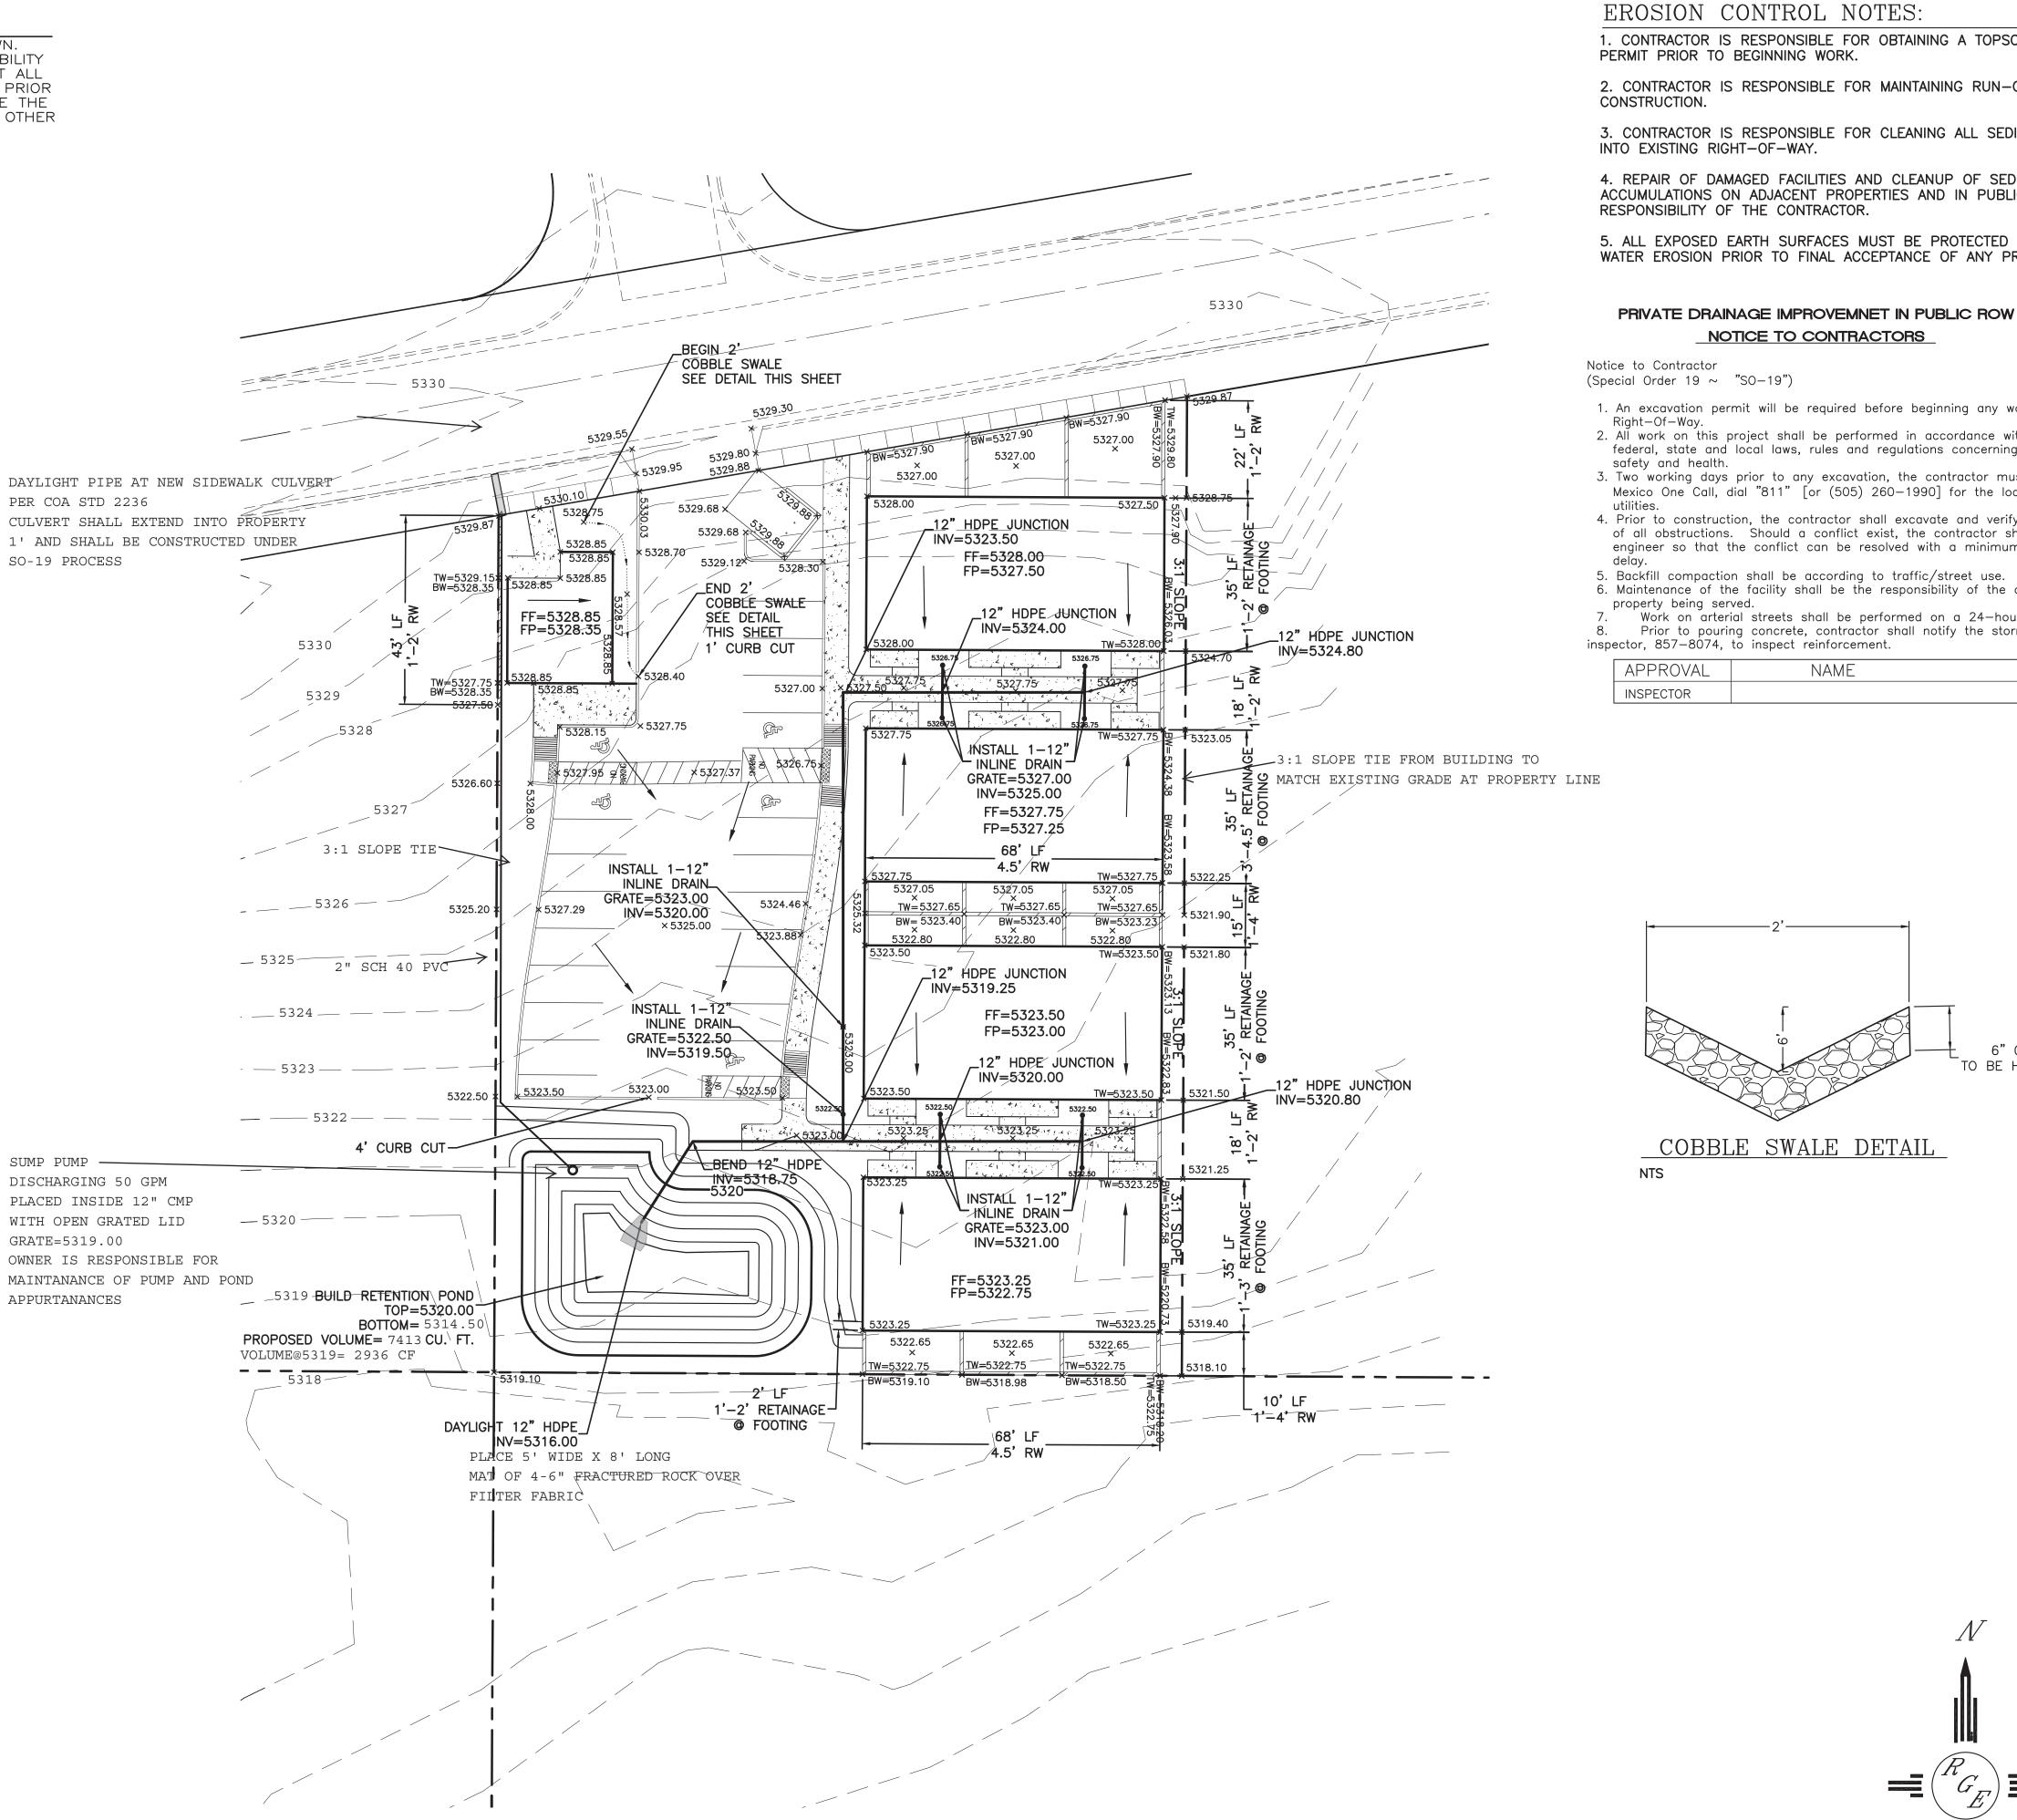

COBBLE SWALE DETAIL

1. CONTRACTOR IS RESPONSIBLE FOR OBTAINING A TOPSOIL DISTURBANCE

2. CONTRACTOR IS RESPONSIBLE FOR MAINTAINING RUN-OFF ON SITE DURING

3. CONTRACTOR IS RESPONSIBLE FOR CLEANING ALL SEDIMENT THAT GETS

4. REPAIR OF DAMAGED FACILITIES AND CLEANUP OF SEDIMENT ACCUMULATIONS ON ADJACENT PROPERTIES AND IN PUBLIC FACILITIES IS THE

5. ALL EXPOSED EARTH SURFACES MUST BE PROTECTED FROM WIND AND WATER EROSION PRIOR TO FINAL ACCEPTANCE OF ANY PROJECT.

1. An excavation permit will be required before beginning any work within City 2. All work on this project shall be performed in accordance with applicable federal, state and local laws, rules and regulations concerning construction


3. Two working days prior to any excavation, the contractor must contact New Mexico One Call, dial "811" [or (505) 260-1990] for the location of existing

4. Prior to construction, the contractor shall excavate and verify the locations of all obstructions. Should a conflict exist, the contractor shall notify the engineer so that the conflict can be resolved with a minimum amount of


6. Maintenance of the facility shall be the responsibility of the owner of the Work on arterial streets shall be performed on a 24-hour basis.

Prior to pouring concrete, contractor shall notify the storm drain NAME

DATE

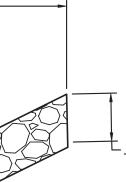

6" COBBLES TO BE HAND PLACED

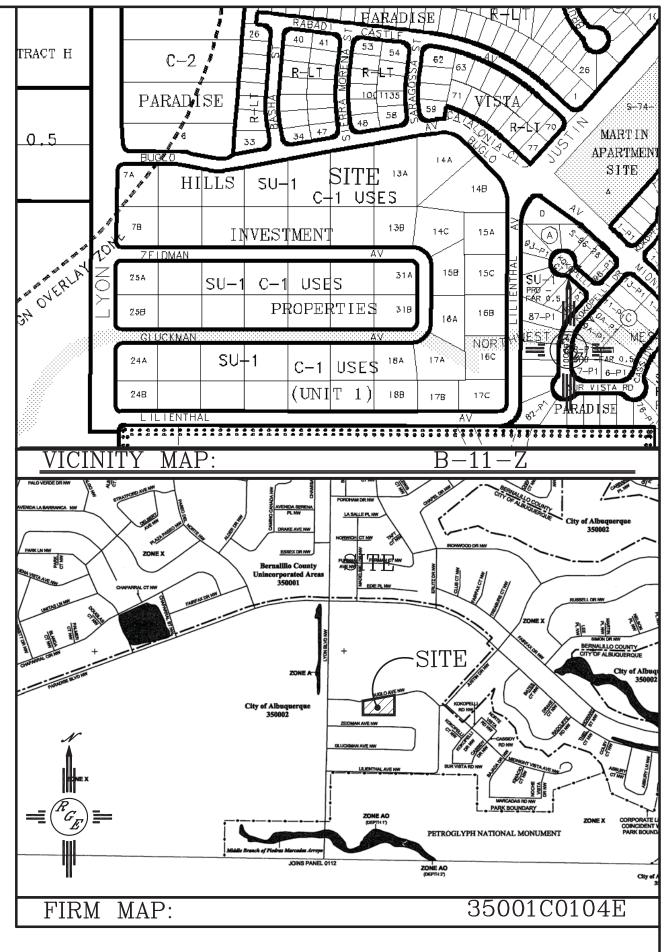

LEGAL DESCRIPTION: TRACT 12A PARADISE HILLS INVESTMENT

NOTES:

1. ALL SPOT ELEVATIONS REPRESENT FLOWLINE ELEVATION UNLESS OTHERWISE NOTED.

2. ALL CURB TO BE 6" HEADER UNLESS OTHERWISE NOTED,

3. ALL RETAINING WALL DESIGN SHALL BE BY OTHERS.

4. ALL SD PIPE TO BE 12" HDPE.

5. SEE ARCH PLANS FOR EXTENDED FOOTING INFORMATION.

6. TURN 1 BLOCK 4" BELOW FINISHED FLOOR AT ALL INTERMEDIARY WALLS.

7. TURN BLOCKS 3" ABOVE FINISHED GRADE AT PERIMETER

8. ALL WALLS SHALL BE PERMITTED UNDER SEPARATE PERMIT

	_LEGE1	ND		
			 EXISTING CONTOUR EXISTING INDEX CONTOUR PROPOSED CONTOUR PROPOSED INDEX CONTOUR SLOPE TIE EXISTING SPOT ELEVATION PROPOSED SPOT ELEVATION BOUNDARY CENTERLINE 	
			RIGHT-OF-WAY PROPOSED CURB AND GUTT EXISTING CURB AND GUTTER PROPOSED SIDEWALK PROPOSED SETBACK PROPOSED LOT LINE PROPOSED SCREEN WALL PROPOSED RETAINING WALL DESIGN BY OTHERS	
$= \begin{pmatrix} R \\ G_E \end{pmatrix} =$	ENGINEER'S SEAL	PARADISE UNIVERSAL GRADING DRAINAGE	APARTMENTS	DRAWN BY _{WCWJ} DATE 11-21-16 21641-LAYOUT-11-21-16
GRAPHIC SCALE 20 10 0 10 20 SCALE: 1"=20'	1/26/17 DAVID SOULE P.E. #14522		Rio Grande Engineering 1606 central avenue suite 201 albuquerque, NM 87106 (505) 872-0999	SHEET # 4 JOB # 21641