

P.O. BOX 1293, Albuquerque, NM 87103

October 16, 1996

Martin J. Chávez, Mayor

Michele F. DeLilla Jeff Mortensen & Assoc 6010-B Midway Park Blvd NE Albuquerque, NM 87109

RE: ENGINEER' CERTIFICATION FOR NEW VISTAS UNIT 1 (B-13/D10)

RECEIVED OCTOBER 2, 1996 FOR FINANCIAL GUARANTY RELEASE

ENGINEER'S STAMP DATED 09-27-96

Dear Mr. DeLilla:

Based on the information included in the submittal referenced above, City Hydrology accepts the engineer's certification for financial guaranty release.

Contact Terri Martin to obtain the Financial Guaranty Release for City Project Number 5276.90.

Thank you for the soils data. Your project is one of the few with a 1h:1v slope that has not failed in some way. Any explanation you could provide would be appreciated.

If I can be of further assistance, You may contact me at 768-2727.

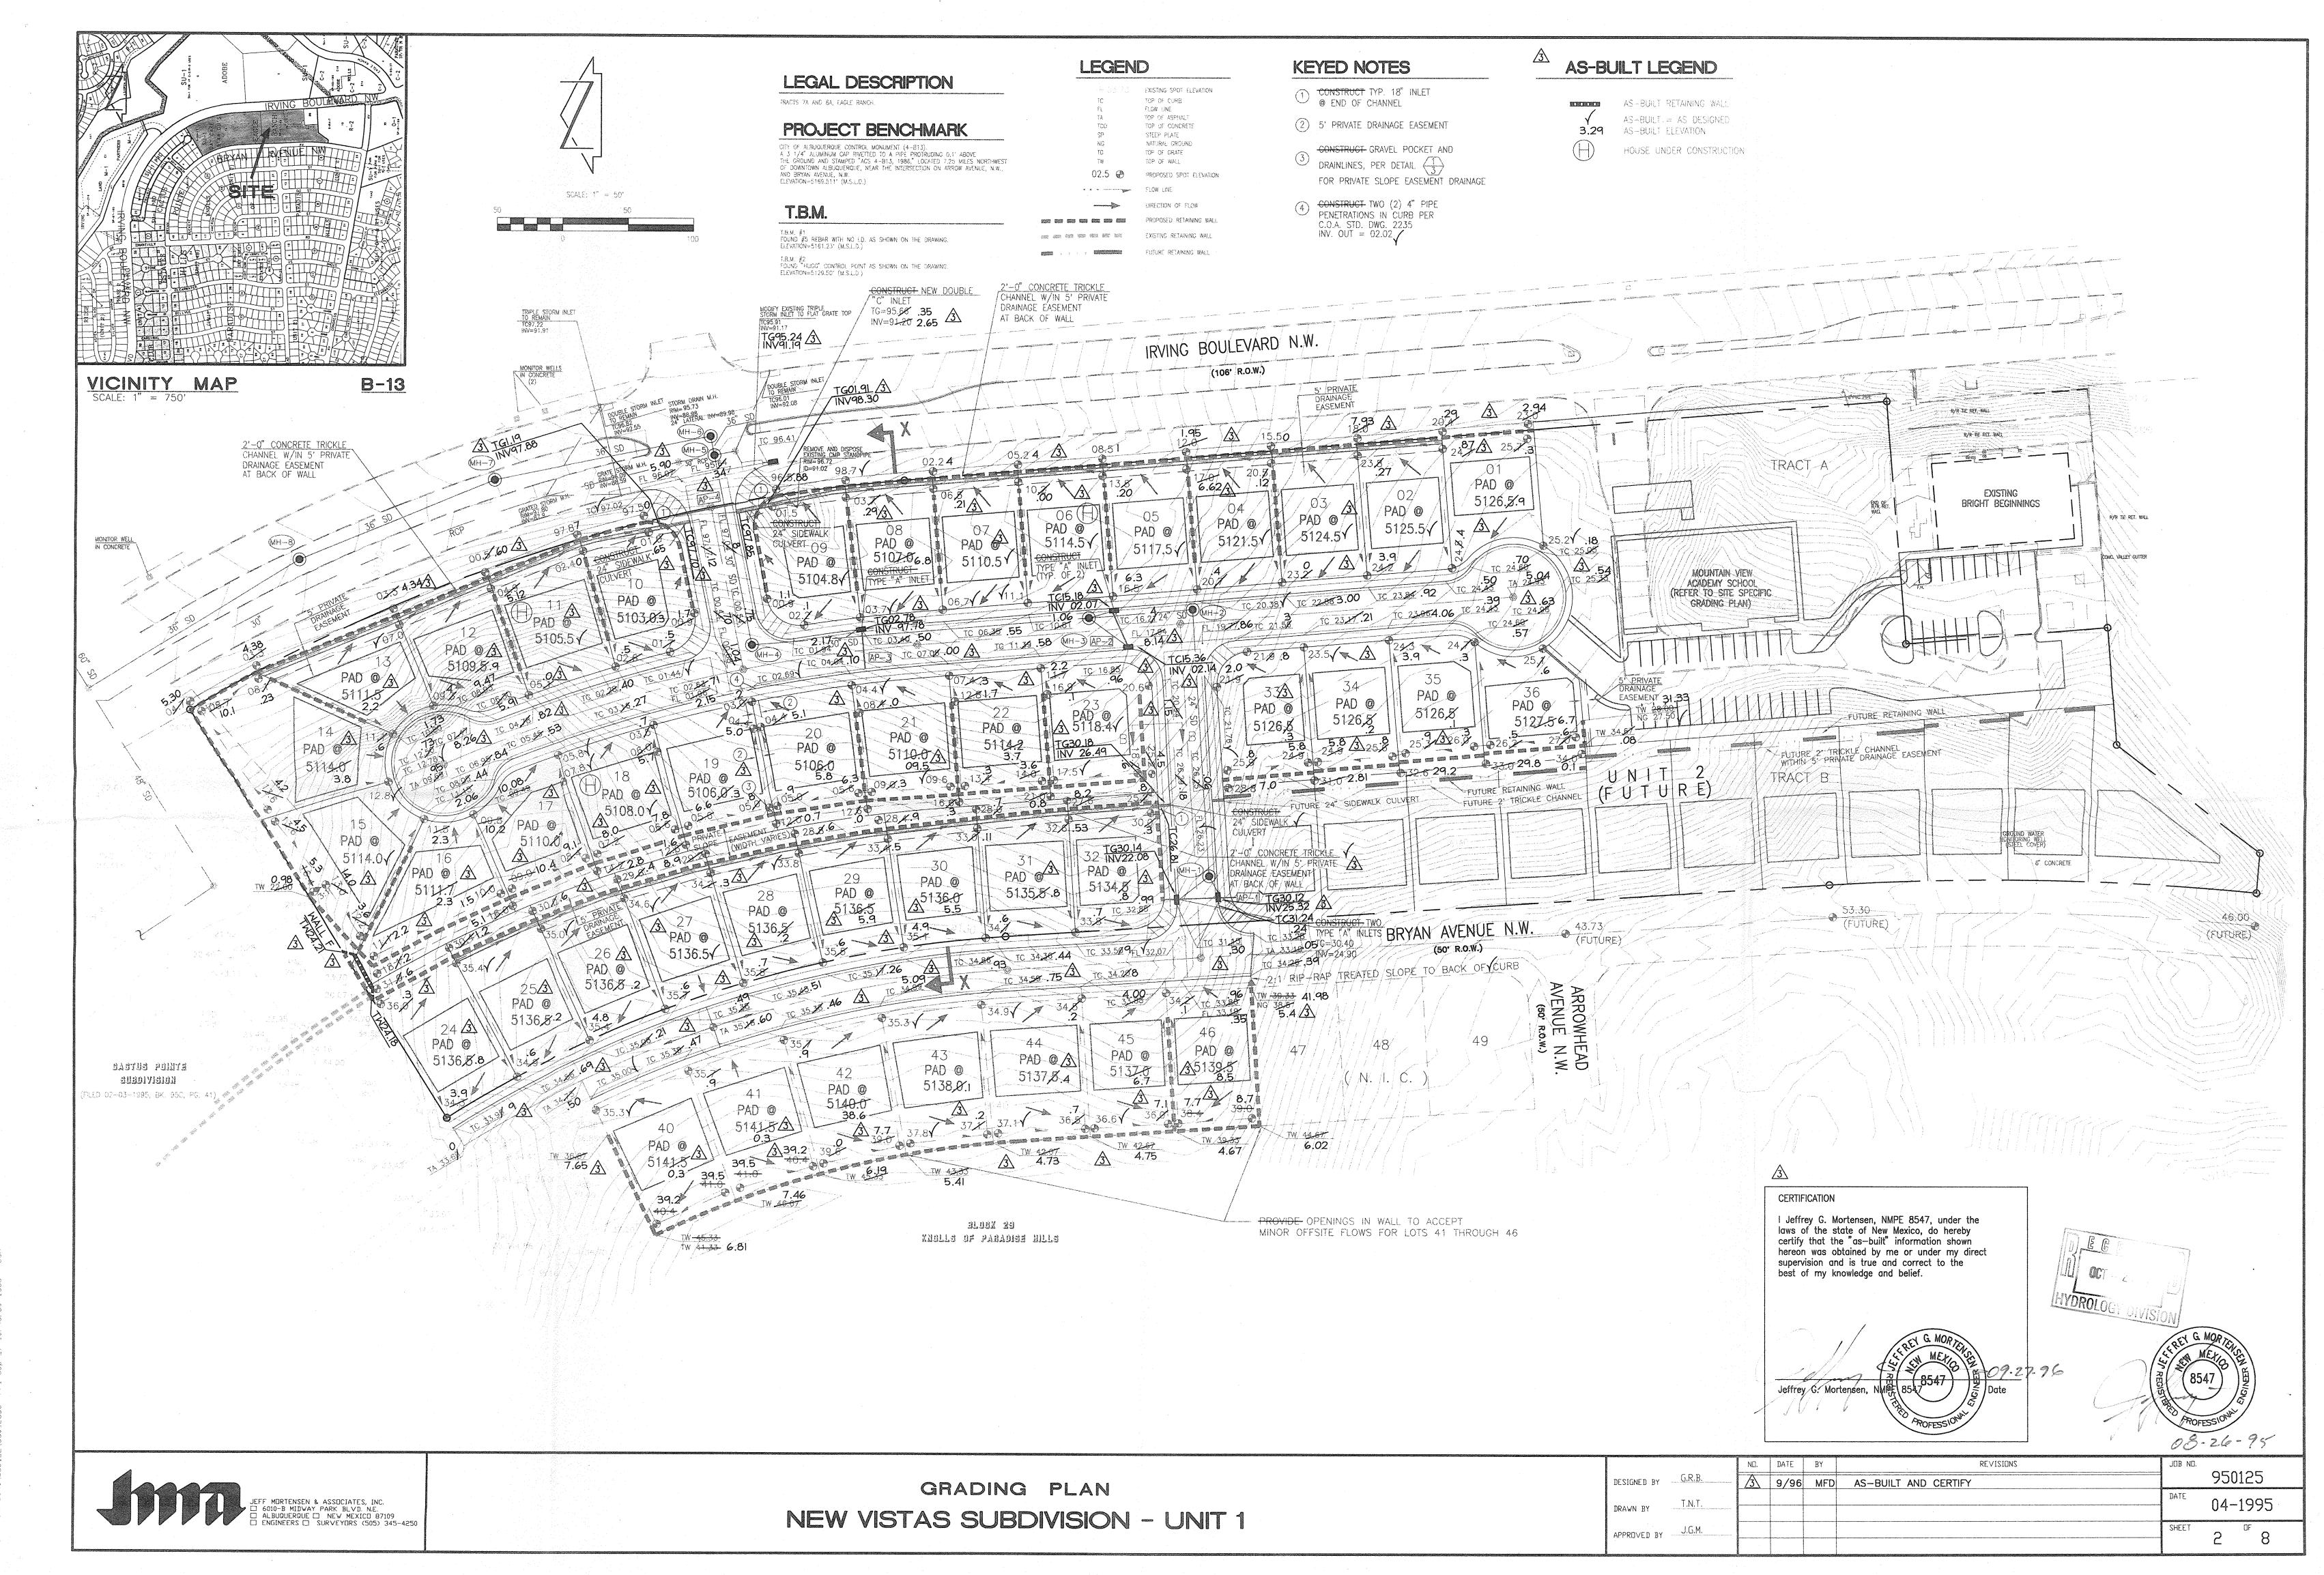
Sincerely

John P. Curtin, P.E.

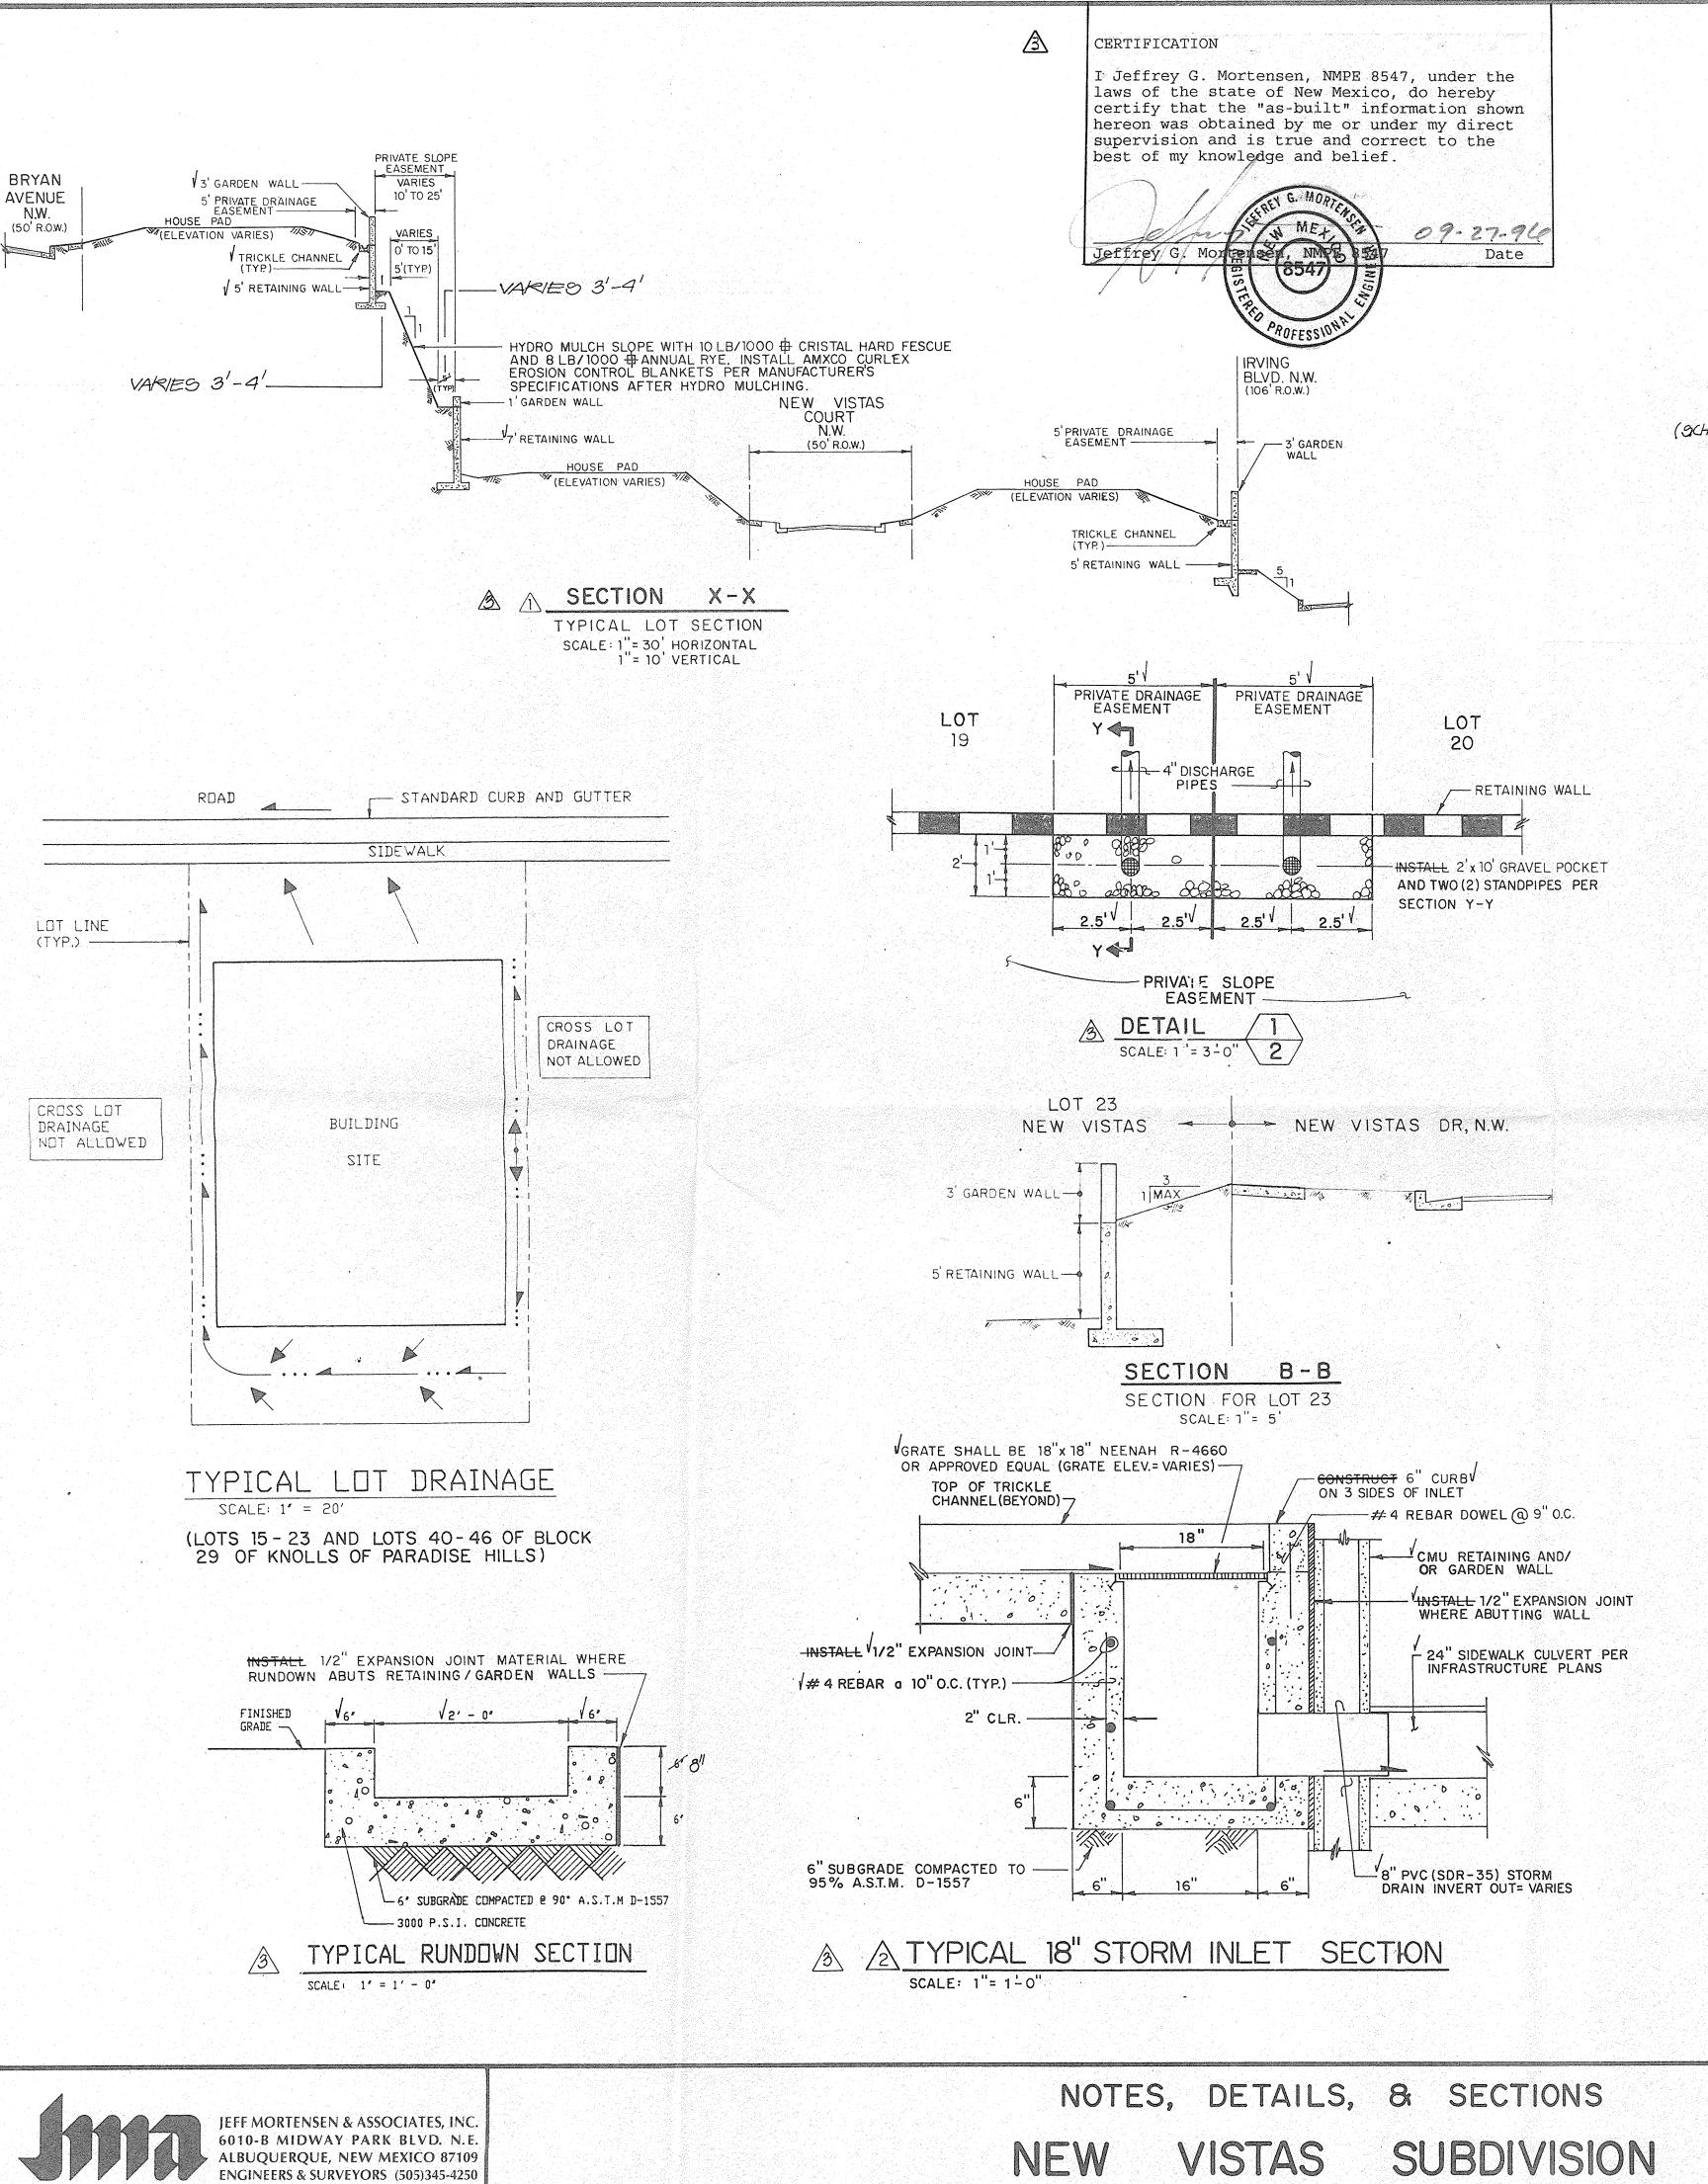
Civil Engineer/Hydrology

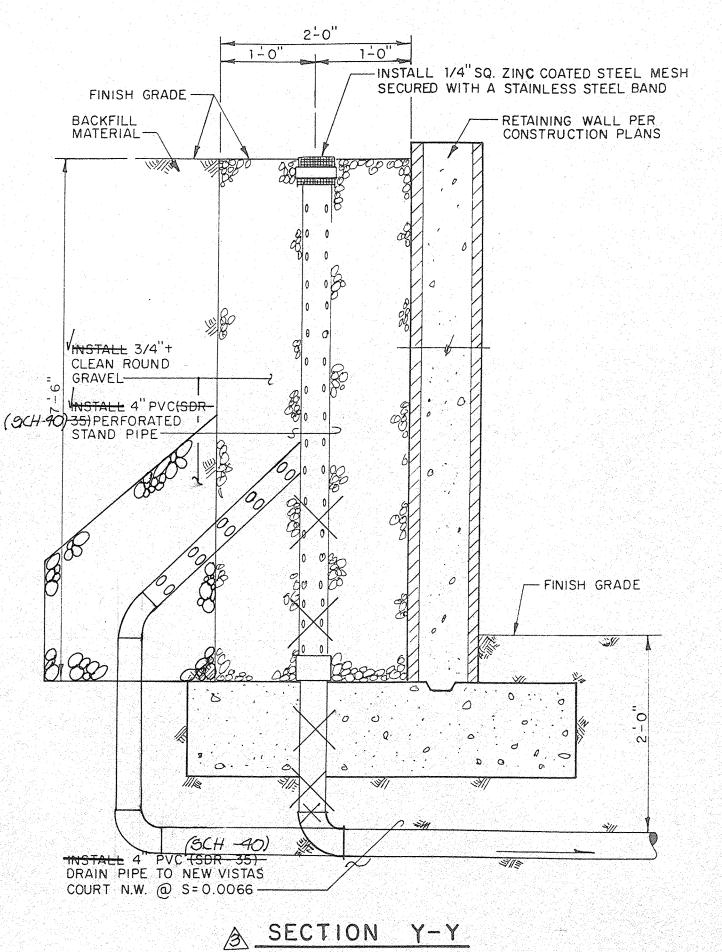
c: Andrew Garcia

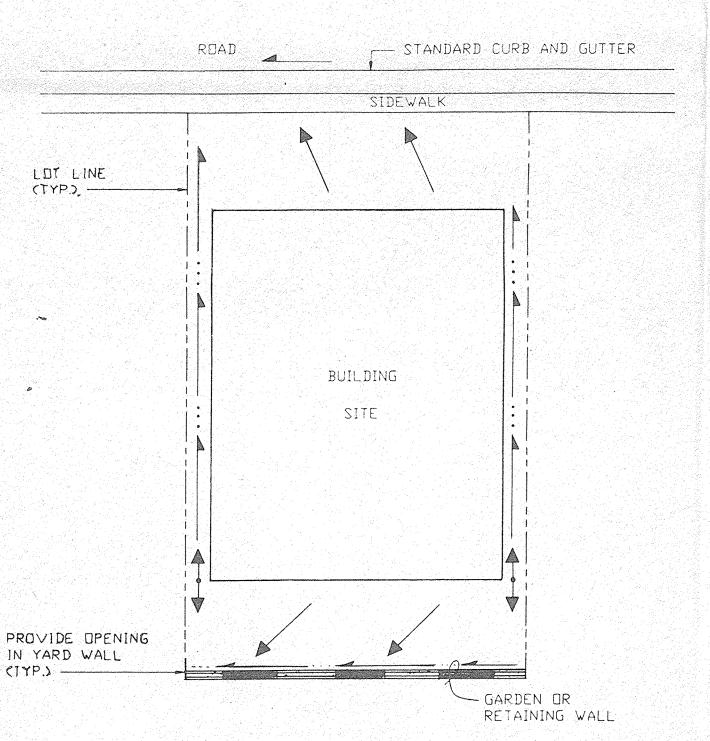
Terri Martin, CPN 5276.90



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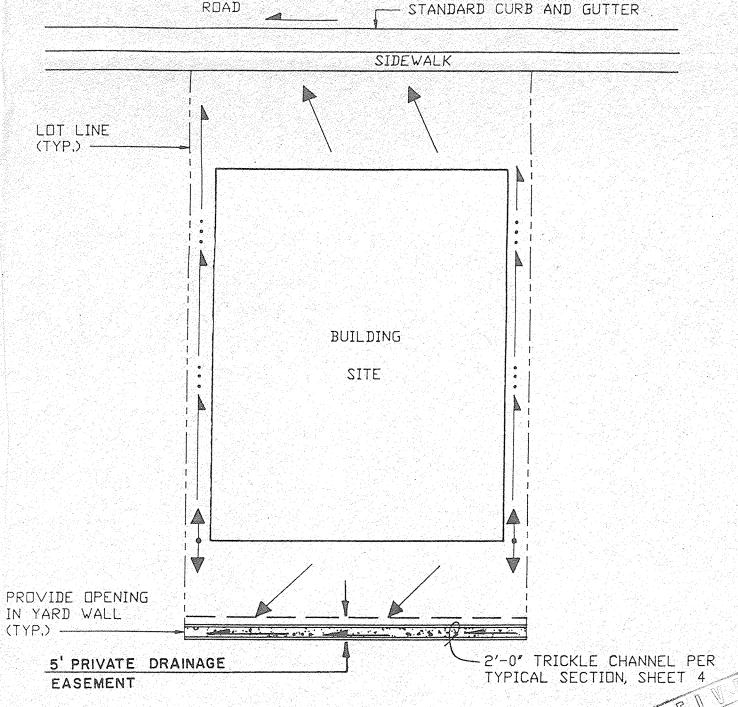


TYPICAL DOWNHILL LOT .DRAINAGE WITHOUT TRICKLE CHANNEL SCALE: 1" = 20'

(LOTS 1 AND 24)

GRADING NOTES/EROSION CONTROL MEASURES:

- 1. ALL FILL SHALL BE COMPACTED TO A MINIMUM OF 90% ASTM D-1557; HOUSE PADS SHALL BE COMPACTED AT 95% ASTM D-1557.
- 2. THE PAD ELEVATIONS SHOWN HEREON ARE FOR ROUGH GRADING PURPOSES.
- FINISHED FLOOR ELEVATIONS MAY VARY FROM THE PAD ELEVATIONS AND WILL BE DETERMINED AS A FUNCTION OF INDIVIDUAL HOUSE DESIGN
- 4. FINISHED FLOOR ELEVATIONS SHOULD BE ESTABLISHED AT A MINIMUM OF 6 INCHES ABOVE PAD ELEVATIONS; DEVIATIONS FROM THESE GUIDELINES MUST BE BASED ON THE RECOMMENDATIONS AND/OR DESIGN OF A COMPETENT DESIGN PROFESSIONAL.
- NO CROSS-LOT DRAINAGE WILL BE ALLOWED UNLESS PROVIDED FOR BY PRIVATE DRAINAGE EASEMENT.
- RETAINING WALLS SHALL BE CONSTRUCTED BY THE DEVELOPER.
- YARD (GARDEN) WALLS SHALL BE CONSTRUCTED BY THE LOT OWNER OR ITS BUILDER.
- THE FINISHED GRADING OF EACH LOT SHALL BE ACCOMPLISHED BY THE LOT OWNER OR ITS BUILDER. RUNOFF SHOULD BE DIRECTED TO THE STREETS OR DRAINAGE EASEMENT (IF AVAILABLE) .
- MAXIMUM UNPROTECTED SLOPES SHALL BE 3:1; MINIMUM SLOPES SHALL BE 1%.
- 10. TWO (2) WORKING DAYS PRIOR TO ANY EXCAVATION, CONTRACTOR MUST CONTACT NEW MEXICO ONE CALL SYSTEM, 260-1990, FOR LOCATION OF EXISTING UTILITIES.
- 11. IF ANY UTILITY LINES, PIPELINES, OR UNDERGROUND UTILITY LINES ARE SHOWN ON THESE DRAWINGS, THEY ARE SHOWN IN AN APPROXIMATE MANNER ONLY, AND SUCH LINES MAY EXIST WHERE NONE ARE SHOWN. IF ANY SUCH EXISTING LINES ARE SHOWN, THE LOCATION IS BASED UPON INFORMATION PROVIDED BY THE OWNER OF SAID UTILITY, AND THE INFORMATION MAY BE INCOMPLETE, OR MAY BE OBSOLETE BY THE TIME CONSTRUCTION COMMENCES. THE ENGINEER HAS CONDUCTED ONLY PRELIMINARY INVESTIGATION OF THE LOCATION, DEPTH, SIZE, OR TYPE OF EXISTING UTILITY LINES, PIPELINES, OR UNDERGROUND UTILITY LINES. THIS INVESTIGATION IS NOT CONCLUSIVE, AND MAY NOT BE COMPLETE, THEREFORE, MAKES NO REPRESENTATION PERTAINING THERETO, AND ASSUMES NO RESPONSIBILITY OR LIABILITY THEREFOR. THE CONTRACTOR SHALL INFORM ITSELF OF THE LOCATION OF ANY UTILITY LINE, PIPELINE, OR UNDERGROUND UTILITY LINE IN OR NEAR THE AREA OF THE WORK IN ADVANCE OF AND DURING EXCAVATION WORK. THE CONTRACTOR IS FULLY RESPONSIBLE FOR ANY AND ALL DAMAGE CAUSED BY ITS FAILURE TO LOCATE, IDENTIFY AND PRESERVE ANY AND ALL EXISTING UTILITIES, PIPELINES, AND UNDERGROUND UTILITY LINES. IN PLANNING AND CONDUCTING EXCAVATION, THE CONTRACTOR SHALL COMPLY WITH STATE STATUTES, MUNICIPAL AND LOCAL ORDINANCES, RULES AND REGULATIONS, IF ANY PERTAINING TO THE LOCATION OF THESE LINES AND FACILITIES.
- 12. THE CONTRACTOR SHALL ENSURE THAT NO SOIL ERODES FROM THE SITE INTO PUBLIC RIGHT-OF-WAY OR ONTO PRIVATE PROPERTY.
- 13. THE CONTRACTOR SHALL PROMPTLY CLEAN UP ANY MATERIAL EXCAVATED WITHIN THE PUBLIC RIGHT-OF-WAY SO THAT THE EXCAVATED MATERIAL IS NOT SUSCEPTIBLE TO BEING WASHED DOWN THE STREET.
- 14. THE CONTRACTOR SHALL SECURE "TOPSOIL DISTURBANCE PERMIT" PRIOR TO BEGINNING CONSTRUCTION. AN EXCAVATION PERMIT IS REQUIRED FOR ALL WORK WITHIN PUBLIC RIGHT-OF-WAY.
- 15. ANY AREAS OF EXCESS DISTURBANCE (TRAFFIC ACCESS, STORAGE YARD EXCAVATED MATERIAL ETC.) SHALL BE RE-SEEDED ACCORDING TO C.O.A. SPECIFICATION 1012 "NATIVE-GRASS SEEDING". THIS WILL BE CONSIDERED INCIDENTAL TO CONSTRUCTION, THEREFORE, NO SEPARATE PAYMENT WILL BE MADE.



TYPICAL LOT DRAINAGE WITH TRICKLE CHANNEL SCALE: 1" = 20"

(LOTS 2-14 AND 25-36)

VISTAS SUBDIVISION NEW

DESIGNED BY _____ G.R.B. DRAWN BY J.E.W. APPROVED BY J.G.M.

950125 04/95 G.R.B. DELETE SECTION A-A, ADD SECTION X-X 2 08/95 G.R.B. ADD TYPICAL 18" INLET SECTION, DETAIL (1), SECTION Y-Y

3 09/96 M.F.D. DRAINAGE CERT 03/95