CITY OF ALBUQUERQUE



November 24, 2015

Richard J. Berry, Mayor

Catherine Otis, P.E. Greenberg Farrow Engineering 19000 MacArthur Blvd Suite 250 Irvine, CA, 92612

RE: Texas Roadhouse

10030 Coors Bypass Blvd NW Grading and Drainage Plan

Engineer's Stamp Date 11-23-15 (File: B13D014)

Dear Ms. Otis:

Based upon the information provided in your submittal received 10-24-15, the above-referenced plan is approved for Building Permit.

PO Box 1293

Please attach a copy of this approved plan in the construction sets when submitting for a building permit. Prior to Certificate of Occupancy release, Engineer Certification per the DPM checklist will be required.

Albuquerque

If you have any questions, you can contact me at 924-3986.

New Mexico 87103

Sincerely,

www.cabq.gov

Abiel Carrillo, P.E.

Principal Engineer, Planning Dept. Development Review Services

Orig:

Drainage file



City of Albuquerque


Planning Department

Development & Building Services Division

DRAINAGE AND TRANSPORTATION INFORMATION SHEET (REV 09/2015)

Project Title:	Building Permit #: City Drainage #:
DRB#: EPC#:	Work Order#:
Legal Description:	
City Address:	
Engineering Firm:	Contact:
Address:	
Phone#: Fax#:	E-mail:
Owner:	Contact:
Address:	
	E-mail:
Architect:	Contact:
Address:	
	E-mail:
Other Contact:	Contact:
Address:	
Phone#: Fax#:	E-mail:
HYDROLOGY/ DRAINAGETRAFFIC/ TRANSPORTATIONMS4/ EROSION & SEDIMENT CONTROL	CHECK TYPE OF APPROVAL/ACCEPTANCE SOUGHT: BUILDING PERMIT APPROVAL CERTIFICATE OF OCCUPANCY
	CERTIFICATE OF OCCUPANCY
TYPE OF SUBMITTAL:	PRELIMINARY PLAT APPROVAL
ENGINEER/ ARCHITECT CERTIFICATION	SITE PLAN FOR SUB'D APPROVAL
	SITE PLAN FOR BLDG. PERMIT APPROVAL
CONCEPTUAL G & D PLAN	FINAL PLAT APPROVAL
GRADING PLAN	SIA/ RELEASE OF FINANCIAL GUARANTEE
DRAINAGE MASTER PLAN DRAINAGE REPORT	FOUNDATION PERMIT APPROVAL
CLOMR/LOMR	GRADING PERMIT APPROVAL
CEOWIN EOWIN	SO-19 APPROVAL
TRAFFIC CIRCULATION LAYOUT (TCL)	PAVING PERMIT APPROVAL GRADING/ PAD CERTIFICATION
TRAFFIC IMPACT STUDY (TIS)	WORK ORDER APPROVAL
EROSION & SEDIMENT CONTROL PLAN (ESC)	CLOMR/LOMR
OTHER (SPECIFY)	PRE-DESIGN MEETING
	OTHER (SPECIFY)
IS THIS A RESUBMITTAL?: Yes No	
DATE SUBMITTED:By:	
-	

COA STAFF: ELECTRONIC SUBMITTAL RECEIVED: ____

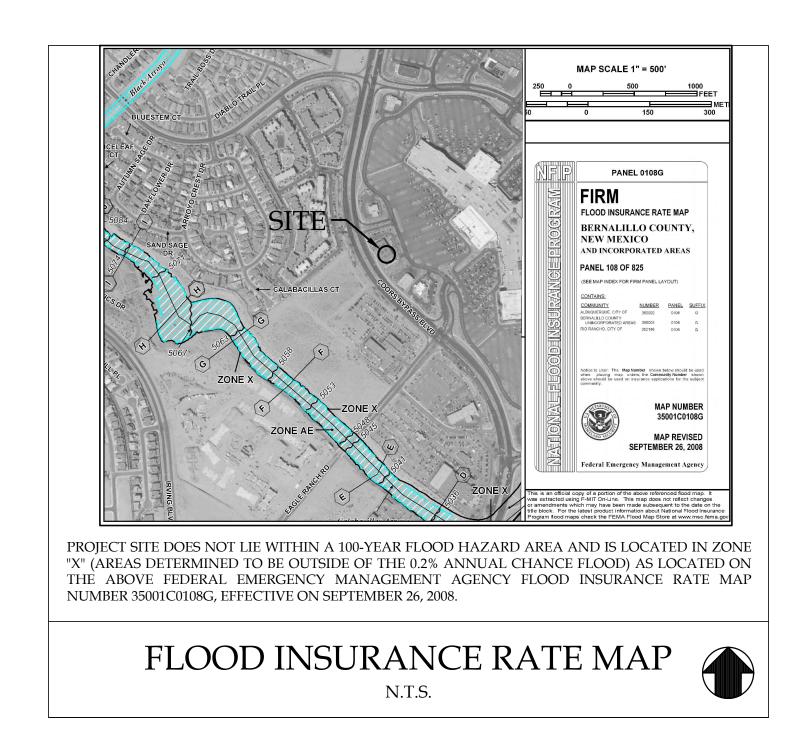

SHEET INDEX:

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C4.0 GRADING AND DRAINAGE PLAN

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C7.2 CONSTRUCTION DETAILS

ATTACHMENTS

ALTA/ACSM LAND TITLE SURVEY

PH1.0 PHOTOMETRIC PLAN

L1.0 IRRIGATION PLAN

L2.0 IRRIGATION NOTES & DETAILS

L3.0 PLANTING PLAN

L4.0 PLANTING NOTES & DETAILS

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L6.0 SPECIFICATIONS



10030 COORS BOULEVARD NW

(TR C-7A OF TRS C-6A + C-7A COTTONWOOD MALL)

ALBUQUERQUE, NEW MEXICO

ZONING: SU-1 SPECIAL USE DISTRICT

RC SU FOR A REGIONAL SHOPPING CENTER

DEVELOPER:

TEXAS ROADHOUSE
CONTACT: DUANE BANET
TEXAS ROADHOUSE HOLDINGS, LLC
6040 DUTCHMANS LANE, SUITE 400
LOUISVILLE, KENTUCKY 40205
EMAIL: DUANE.BANET@TEXASROADHOUSE.COM


ENGINEER:

GreenbergFarrow

CONTACT: MIKE HOLMES 19000 MACARTHUR BLVD, SUITE 250 IRVINE, CA 92612

TEL: (479) 250-0346 EMAIL: MHOLMES@GREENBERGFARROW.COM



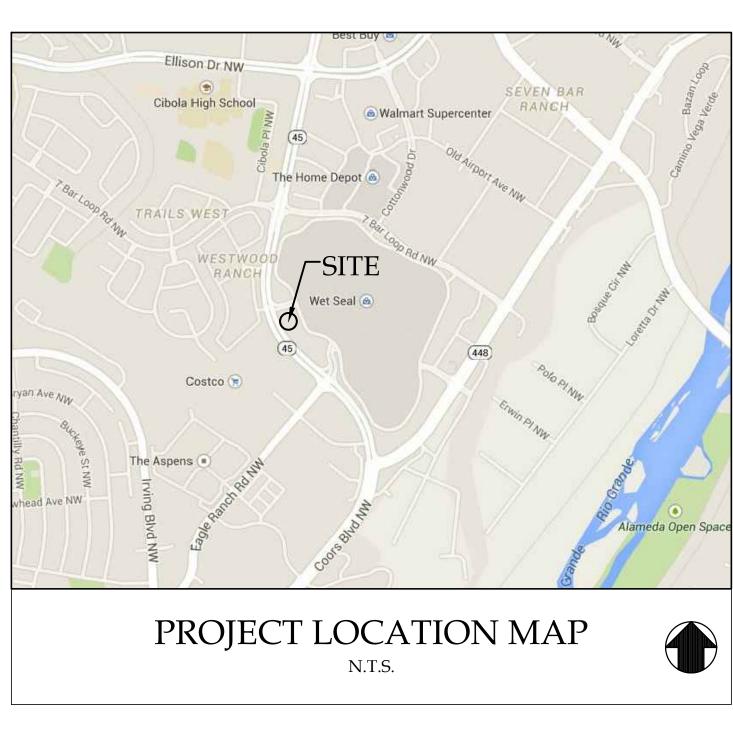

CONTACTS:

PLANNING:

PLANNING DEPARTMENT 600 SECOND STREET N.W. ALBUQUERQUE, NEW MEXICO 87102 CONTACT: N/A TEL: (505) 924-3987

FIRE DEPT:

600 2ND STREET NW
ALBUQUERQUE, NM 87102
TEL: (505) 924-3611
CONTACT: N/A
EMAIL: N/A

GAS:

NEW MEXICO GAS COMPANY P.O. BOX 97500 ALBUQUERQUE, NM TEL: (505) 697-3335 WATER:

UTILITY AUTHORITY

ONE CIVIC PLAZA NW

SEWER:

UTILITY DEVELOPMENT SECTION

ALBUQUERQUE, NEW MEXICO 87102

600 SECOND STREET N.W.

ALBUQUERQUE-BERNALILLO COUNTY WATER

ALBUQUERQUE, NEW MEXICO 87102

DEVELOPMENT AND BUILDING SERVICES 600 SECOND STREET N.W. ALBUQUERQUE, NEW MEXICO 87102 CONTACT: N/A TEL: (505) 924-3987 FMAIL: N/A

ENGINEERING:

ELECTRIC:

PNM
CONTACT: N/A
4201 EDITH BOULEVARD NE
ALBUQUERQUE, NM 88310
TEL: (505) 241–3425
EMAIL: N/A

TELEPHONE: CABLE:

CENTURY LINK 201 3RD STREET, NW ALBUQUERQUE, NM 87102 TEL: (505) 245-7500 EMAIL: N/A

TEL: (505) 924-3987

CONTACT: N/A

CENTURY LINK 201 3RD STREET, NW ALBUQUERQUE, NM 87102

SURVEYOR:

YOUNG, HOBBS AND ASSOCIATES
CONTACT: DAVE HOBBS
101 SOUTH FIFTH STREET SUITE 1400
LOUISVILLE, KENTUCKY 40202
TEL: (502) 627-8900

GEOTECHNICAL ENGINEER:

TERRACON CONSULTANTS, INC.
CONTACT: MEAGAN J. DUNEMAN, P.E.
4905 HAWKINS NE
ALBUQUERQUE, NEW MEXICO 87109
TEL: (505) 797-4287
PROJECT NO. 66145081



JOB NO. 20130487.0

37.0 DATE: 11-23-2015

PROJECT BENCHMARKS:

ELEVATIONS SHOWN HEREON ARE BASED ON A CITY OF ALBUQUERQUE BENCHMARK, ID "9_B13", ELEVATION 5072.491 (NAVD88).

GENERAL NOTES:

AGENCY CODES, STANDARDS AND SPECIFICATIONS.

- 1. CONTRACTOR SHALL BE RESPONSIBLE FOR SITE SAFETY AND ALL WAYS, MEANS AND METHODS OF CONSTRUCTION.
- 2. CONTRACTOR SHALL COMPLY WITH ALL APPLICABLE FEDERAL, STATE AND LOCAL
- 3. CONTRACTOR SHALL OBTAIN ALL NECESSARY SITE PERMITS AND LICENSES FROM THE APPLICABLE GOVERNING AUTHORITIES.
- 4. ALL CONSTRUCTION MATERIALS AND WORKMANSHIP SHALL BE IN ACCORDANCE WITH THE LATEST STATE AND LOCAL GOVERNMENT CONSTRUCTION STANDARDS AND SPECIFICATIONS.
- 5. UNLESS OTHERWISE NOTED ON THE PLANS, CONTRACTOR SHALL NOTIFY THE LOCAL ENGINEERING OR PUBLIC WORKS DEPARTMENT AND/OR OTHER PROJECT GOVERNING AUTHORITY(S) A MINIMUM OF FORTY-EIGHT (48) HOURS PRIOR TO COMMENCING CONSTRUCTION OPERATIONS AND TO SCHEDULE ANY REQUIRED SITE INSPECTIONS.
- 6. CONTRACTOR SHALL SCHEDULE A UTILITY LOCATING SERVICE AND/OR NOTIFY ALL UTILITY COMPANIES (GAS, ELECTRIC, TELEPHONE, CABLE, ETC.) AND THE LOCAL MUNICIPALITY TO DETERMINE THE LOCATION OF UNDERGROUND UTILITIES PRIOR TO THE COMMENCEMENT OF CONSTRUCTION IN ORDER TO AVOID POTENTIAL CONFLICTS. IT IS ULTIMATELY THE RESPONSIBILITY OF THE CONTRACTOR TO LOCATE ALL EXISTING UTILITIES WHETHER INDICATED ON THE PLANS OR NOT AND TO HAVE THESE UTILITIES STAKED PRIOR TO CONSTRUCTION. ANY NECESSARY RELOCATIONS OR REMOVALS OF EXISTING UTILITY LINES SHALL BE PERFORMED BY THE CONTRACTOR AT NO ADDITIONAL COST TO THE OWNER.
- 7. CONTRACTOR SHALL BE RESPONSIBLE FOR THE PROTECTION OF ALL PRIVATE AND PUBLIC UTILITIES EVEN THOUGH THEY MAY NOT BE SHOWN ON THE PLANS. ANY UTILITY THAT IS DAMAGED DURING CONSTRUCTION SHALL BE REPAIRED OR REPLACED BY THE CONTRACTOR AT HIS EXPENSE AND TO THE SATISFACTION OF THE UTILITY OWNER.
- 8. ALL EASEMENTS FOR EXISTING UTILITIES, BOTH PUBLIC AND PRIVATE, AND UTILITIES WITHIN PUBLIC RIGHTS—OF—WAY ARE SHOWN ON THE PLANS PREPARED BY THE SURVEYOR ACCORDING TO INFORMATION AVAILABLE FROM PUBLIC RECORDS OR VISIBLE FIELD MARKINGS. THE CONTRACTOR SHALL BE ULTIMATELY RESPONSIBLE FOR DETERMINING THE EXACT LOCATION IN THE FIELD OF THESE UTILITY LINES AND FOR THEIR PROTECTION FROM DAMAGE DUE TO CONSTRUCTION OPERATIONS. IF EXISTING UTILITY LINES OF ANY NATURE ARE ENCOUNTERED WHICH CONFLICT IN LOCATION WITH THE PROPOSED CONSTRUCTION, THE CONTRACTOR SHALL IMMEDIATELY NOTIFY THE ENGINEER SO THE CONFLICT MAY BE RESOLVED.
- 9. ALL UTILITY CONNECTIONS TO EXISTING LINES SHALL BE CONSTRUCTED IN ACCORDANCE WITH THE RULES AND REGULATIONS AND TO THE SATISFACTION OF THE APPLICABLE UTILITY OWNER(S).
- 10. CONTRACTOR SHALL FIELD VERIFY ALL DIMENSIONS, COORDINATES AND ELEVATIONS PRIOR TO THE COMMENCEMENT OF CONSTRUCTION AND SHALL IMMEDIATELY NOTIFY THE ENGINEER OF ANY DISCREPANCIES SO THE CONFLICT MAY BE RESOLVED.
- 11. ALL PROPERTY MARKERS AND SURVEY REFERENCE MARKERS SHALL BE CAREFULLY PRESERVED DURING CONSTRUCTION UNTIL THEIR LOCATION HAS BEEN WITNESSED OR OTHERWISE TIED IN BY AN AUTHORIZED AGENT OR PROFESSIONALLY LICENSED SURVEYOR.
- 12. THE SAFE AND ORDERLY PASSAGE OF TRAFFIC AND PEDESTRIANS SHALL BE PROVIDED WHERE CONSTRUCTION OPERATIONS ABUT PUBLIC THROUGH—FARES AND ADJACENT PROPERTY.
- 13. ALL AREAS DISTURBED BY THE GENERAL CONTRACTOR OR SUB-CONTRACTORS SHALL BE RETURNED TO THE ORIGINAL CONDITION OR BETTER, EXCEPT WHERE PROPOSED CONSTRUCTION IS INDICATED ON THE PLANS.
- 14. PRIOR TO INITIAL ACCEPTANCE BY THE OWNER(S) AND/OR GOVERNING AUTHORITY, ALL WORK SHALL BE INSPECTED AND APPROVED BY THE OWNER AND MUNICIPALITY ENGINEER OR HIS REPRESENTATIVE(S). THE CONTRACTOR SHALL GUARANTEE HIS WORK FOR A PERIOD OF 12 (TWELVE) MONTHS FROM THE DATE OF SUBSTANTIAL COMPLETION AND SHALL BE HELD RESPONSIBLE FOR ANY DEFECTS IN MATERIAL OR WORKMANSHIP OF THIS WORK DURING THAT PERIOD AND UNTIL FINAL ACCEPTANCE IS MADE.
- 15. CONTRACTOR SHALL BE RESPONSIBLE FOR PROVIDING SAFE AND ADEQUATE WORKING CONDITIONS THROUGHOUT THE DURATION OF CONSTRUCTION OF THE PROPOSED IMPROVEMENTS.
- 16. CONTRACTOR SHALL KEEP THE PUBLIC STREET PAVEMENTS CLEAN OF DIRT AND DEBRIS AND, WHEN NECESSARY, CLEAN PAVEMENTS AT THE END OF EACH WORKING DAY.
- 17. ALL CONSTRUCTION STAKING, SCHEDULING AND PAYMENT IS THE RESPONSIBILITY OF
- 18. AFTER COMPLETION OF THE PROPOSED IMPROVEMENTS AND WHEN REQUIRED BY THE GOVERNING AUTHORITY(S), CONTRACTOR SHALL PROVIDE THE OWNER AND ENGINEER WITH AS-BUILT AND/OR RECORD DRAWINGS, SIGNED AND SEALED BY A PROFESSIONALLY LICENSED ENGINEER OR SURVEYOR AND SHALL INCLUDE AT A MINIMUM (WHERE APPLICABLE TO THE SCOPE OF WORK) THE FOLLOWING ITEMS:
- 18.1. TOPOGRAPHY AND SPOT GRADE ELEVATIONS OF ALL PROPOSED PERMANENT SITE FEATURES INCLUDING ANY STORM WATER FACILITIES OR MODIFICATIONS TO EXISTING STORM WATER FACILITIES.
- 18.2. HORIZONTAL AND VERTICAL LOCATION AND ALIGNMENT OF ALL PROPOSED ROADWAYS, PARKING LOTS, UTILITIES, BUILDINGS OR OTHER PERMANENT SITE FEATURES.
- 18.3. RIM AND INVERT AND/OR TOP OF PIPE ELEVATIONS FOR ALL PROPOSED UTILITIES.
- 18.4. AS-BUILT AND/OR RECORD DRAWING INFORMATION SHALL BE SHOWN ON THE APPROVED ENGINEERING PLANS ISSUED FOR CONSTRUCTION. ANY AND ALL DEVIATIONS FROM THESE APPROVED PLANS SHALL BE SHOWN BY MEANS OF STRIKING THROUGH THE PROPOSED INFORMATION AND CLEARLY INDICATING THE AS-BUILT LOCATIONS AND ELEVATIONS ON THE APPLICABLE PLAN SHEET.

SITE GRADING AND PAVING NOTES:

- 1. ALL SITE WORK, GRADING, AND PAVING OPERATIONS WITHIN THE LIMITS OF THE PROJECT SHALL BE PERFORMED IN ACCORDANCE WITH THE NOTES ON THE PLANS AND THE STANDARDS, SPECIFICATIONS, CODES AND ORDINANCES OF THE LOCAL GOVERNING AUTHORITIES. IN CASE OF CONFLICT, THE MORE STRINGENT CODE SHALL TAKE PRECEDENCE.
- 2. EARTH EXCAVATION SHALL INCLUDE CLEARING, STRIPPING AND STOCKPILING TOPSOIL, REMOVING UNSUITABLE MATERIALS, CONSTRUCTION OF EMBANKMENTS, NON-STRUCTURAL FILLS, FINAL SHAPING AND TRIMMING TO THE LINES, GRADES AND CROSS SECTIONS SHOWN ON THE PLANS. ALL UNSUITABLE OR EXCESS MATERIAL SHALL BE DISPOSED OF LEGALLY OFFSITE OR AS DIRECTED BY THE PROJECT REPRESENTATIVE IN THE FIELD.
- 3. EXCAVATED TOPSOIL SHALL BE STOCKPILED ON THE SITE IN AREAS DESIGNATED BY THE PROJECT ENGINEER UNTIL SUCH TIME THAT THIS TOPSOIL CAN BE USED FOR FINAL GRADING. UNLESS OTHERWISE NOTED ON THE PLANS, A MINIMUM OF 6" TOPSOIL RE—SPREAD AND SEEDING FOR ALL DISTURBED AREAS IS REQUIRED.
- 4. THE GEOTECHNICAL INVESTIGATION REPORT FOR THE SITE AND ALL ADDENDA THERETO ARE SUPPORTING DOCUMENTS FOR THIS PROJECT. THE RECOMMENDATIONS AS STATED IN SAID REPORT ARE HEREBY INCORPORATED INTO THESE CONSTRUCTION NOTES BY REFERENCE AND SHALL BE FOLLOWED BY ALL CONTRACTORS. THE GRADING OPERATIONS ARE TO BE CLOSELY SUPERVISED AND INSPECTED, PARTICULARLY DURING THE REMOVAL OF UNSUITABLE MATERIAL AND THE CONSTRUCTION OF EMBANKMENTS OR BUILDING PADS, BY A SOILS ENGINEER OR HIS REPRESENTATIVE. FURTHER CONSTRUCTION OPERATIONS WILL NOT BE PERMITTED UNTIL THE SOILS ENGINEER ISSUES A WRITTEN STATEMENT THAT THE AREA IN QUESTION HAS BEEN SATISFACTORILY PREPARED AND IS READY FOR CONSTRUCTION.
- 5. ALL TESTING, INSPECTION AND SUPERVISION OF SOIL QUALITY, UNSUITABLE SOIL REMOVAL AND ITS REPLACEMENT AND OTHER SOILS RELATED OPERATIONS SHALL BE THE RESPONSIBILITY OF THE CONTRACTOR AND SHALL BE COORDINATED WITH AND PERFORMED AT THE DIRECTION OF THE OWNER'S GEOTECHNICAL ENGINEER.
- 6. THE CONTRACTOR SHALL USE CARE IN GRADING NEAR TREES, SHRUBS, AND BUSHES WHICH ARE NOT NOTED TO BE REMOVED SO AS NOT TO CAUSE INJURY TO ROOTS OR TRUNKS.
- 7. THE CONTRACTOR SHALL USE CARE IN GRADING OR EXCAVATING NEAR ANY AND ALL EXISTING ITEMS WHICH ARE NOT INDICATED TO BE REMOVED. ANY DAMAGE DONE TO THESE EXISTING ITEMS BY THE CONTRACTOR'S OPERATIONS SHALL BE REPAIRED AT HIS OWN EXPENSE.
- 8. REMOVED PAVEMENTS, SIDEWALKS, CURBS, TREES AND STUMPS SHALL BE DISPOSED OF LEGALLY OFFSITE AT LOCATIONS DETERMINED BY THE CONTRACTOR.
- 9. ON AND OFFSITE PAVING AND CURBS TO REMAIN SHALL BE PROTECTED FROM DAMAGE, AND, IF DAMAGED, SHALL BE REPLACED PROMPTLY TO MEET STATE AND LOCAL STANDARD SPECIFICATIONS IN MATERIALS AND WORKMANSHIP.
- 10. PROPOSED ELEVATIONS INDICATE FINISHED GRADE CONDITIONS. FOR ROUGH GRADING ELEVATIONS ALLOW FOR THE THICKNESS OF THE PROPOSED PAVEMENT SECTION (ROADS, WALKS, DRIVE, ETC.) OR TOPSOIL AS INDICATED ON THE PLANS.
- 11. CONTRACTOR SHALL PROVIDE SMOOTH VERTICAL CURVES THROUGH THE HIGH AND LOW POINTS INDICATED BY SPOT ELEVATIONS ON THE PLANS. CONTRACTOR SHALL PROVIDE UNIFORM SLOPES BETWEEN NEW AND EXISTING GRADES AND AVOID ANY RIDGES AND/OR DEPRESSIONS.
- 12. ALL PROPOSED GRADING, PAVEMENT, APRONS, CURBS, WALKS, ETC. SHALL MATCH EXISTING GRADES FLUSH.
- 13. ALL EXISTING AND PROPOSED TOP OF FRAME ELEVATIONS FOR STORM, SANITARY, WATER AND OTHER UTILITY STRUCTURES SHALL BE ADJUSTED TO MEET FINISHED GRADE WITHIN THE PROJECT LIMITS.
- 14. SITE GRADING AND CONSTRUCTION OF THE PROPOSED SITE IMPROVEMENTS SHALL NOT CAUSE PONDING OF STORM WATER. ALL AREAS ADJACENT TO THESE IMPROVEMENTS SHALL BE GRADED TO ALLOW POSITIVE DRAINAGE AND MATCH EXISTING GRADES FLUSH.
- 15. CONTRACTOR SHALL ENSURE POSITIVE SITE DRAINAGE AT THE END OF EACH WORKING DAY DURING CONSTRUCTION OPERATIONS. FAILURE TO PROVIDE ADEQUATE DRAINAGE WILL PRECLUDE THE CONTRACTOR FROM ANY POSSIBLE COMPENSATION REQUESTED DUE TO DELAYS OR UNSUITABLE MATERIALS CREATED AS A RESULT.
- 16. DRIVEWAYS SHALL BE CONSTRUCTED SO AS NOT TO IMPEDE THE SURFACE DRAINAGE SYSTEM.
- 17. TRAFFIC CONTROL DEVICES SHALL BE IN CONFORMANCE WITH THE APPLICABLE STATE DEPARTMENT OF TRANSPORTATION STANDARDS AND SHALL BE FURNISHED AND INSTALLED WHENEVER CONSTRUCTION FOR UTILITIES ARE WITHIN STREET AREAS. APPLICABLE ORDINANCES OF THE MUNICIPALITY, COUNTY OR STATE SHALL ALSO GOVERN THE TRAFFIC CONTROL REQUIREMENTS.

STORM SEWER NOTES:

- 1. ALL STORM SEWER CONSTRUCTION SHALL BE PERFORMED IN ACCORDANCE WITH THE NOTES ON THE PLANS AND THE STANDARDS, SPECIFICATIONS, CODES AND ORDINANCES OF THE LOCAL GOVERNING AUTHORITIES. IN CASE OF CONFLICT, THE MORE STRINGENT CODE SHALL TAKE PRECEDENCE.
- 2. STORM SEWER PIPE AND STRUCTURES SHALL BE FURNISHED AND INSTALLED IN ACCORDANCE WITH LOCAL REQUIREMENTS AND SPECIFICATIONS.
- 3. RCP STORM SEWER PIPE 12" IN DIAMETER AND LARGER SHALL BE REINFORCED CONCRETE PIPE, CLASS IV, PER ASTM C76 WITH FLEXIBLE (O-RING) GASKET JOINTS IN CONFORMANCE WITH ASTM C443.
- 4. HDPE STORM SEWER PIPE SHALL BE HIGH DENSITY POLYETHYLENE PIPE PER ASTM F2306 WITH WATERTIGHT JOINTS CONFORMING TO ASTM D3212.
- 5. PVC STORM SEWER PIPE SHALL BE POLYVINYL CHLORIDE SDR 26 PIPE PER ASTM D3034 WITH WATERTIGHT JOINTS CONFORMING TO ASTM D3212, UNLESS OTHERWISE
- 6. STORM SEWER TRENCH EXCAVATIONS AND PIPE FOUNDATION, BEDDING AND HAUNCHING SHALL BE CONSTRUCTED IN ACCORDANCE WITH LOCAL REQUIREMENTS AND SPECIFICATIONS.
- 6.1. STORM SEWERS MUST BE PLACED ON PROPERLY COMPACTED STONE BEDDING. PIPE BEDDING MATERIAL SHALL BE A MINIMUM OF FOUR (4) INCHES THICK UNDER THE BARREL OF THE PIPE AND FOR PVC PIPE, MATERIAL SHALL BE EXTENDED A MINIMUM OF 12" OVER THE TOP OF THE PIPE PER ASTM D2321. PIPE BEDDING MATERIAL SHALL BE CRUSHED GRAVEL OR STONE MEETING LOCAL STANDARD GRADATIONS.
- 6.2. GRANULAR TRENCH BACKFILL MATERIAL SHALL BE PLACED AND COMPACTED TO A MINIMUM OF 95% MODIFIED PROCTOR DENSITY, PER ASTM D1557, OVER ALL STORM SEWERS WHICH ARE CONSTRUCTED UNDER, OR WITHIN TWO (2) FEET OF, ANY PROPOSED OR EXISTING PAVEMENT, PARKING LOTS OR SIDEWALKS.
- 7. REQUIRED STORM STRUCTURE RIM ADJUSTMENTS SHALL BE MADE WITH PRECAST CONCRETE ADJUSTING RINGS NOT TO EXCEED A MAXIMUM OF EIGHT (8) INCHES IN OVERALL HEIGHT. A MAXIMUM OF TWO (2) ADJUSTING RINGS ARE ALLOWED. BUTYLROPE JOINT SEALANT SHALL BE USED ON ALL JOINTS BETWEEN THE PRECAST ELEMENTS.
- 8. FIELD TILE ENCOUNTERED DURING CONSTRUCTION OPERATIONS SHALL BE CONNECTED TO THE PROPOSED STORM SEWER SYSTEM OR EXTENDED TO OUTLET INTO A PROPOSED DRAINAGE WAY. IF THIS CANNOT BE ACCOMPLISHED, THEN IT SHALL BE REPAIRED WITH NEW PIPE OF SIMILAR SIZE AND MATERIAL TO THE ORIGINAL LINE AND PUT IN ACCEPTABLE OPERATING CONDITION. A RECORD OF THE LOCATION OF ALL FIELD TILE OR DRAIN PIPE ENCOUNTERED SHALL BE KEPT BY THE CONTRACTOR AND TURNED OVER TO THE OWNER AND/OR ENGINEER UPON COMPLETION OF THE PROJECT AND ACCURATELY SHOWN ON THE RECORD DRAWINGS.

SANITARY SEWER NOTES:

- 1. ALL SANITARY SEWER CONSTRUCTION SHALL BE PERFORMED IN ACCORDANCE WITH THE NOTES ON THE PLANS AND THE STANDARDS, SPECIFICATIONS, CODES AND ORDINANCES OF THE LOCAL GOVERNING AUTHORITIES. IN CASE OF CONFLICT, THE MORE STRINGENT CODE SHALL TAKE PRECEDENCE.
- 2. SANITARY SEWER PIPE AND STRUCTURES SHALL BE FURNISHED AND INSTALLED IN ACCORDANCE WITH LOCAL REQUIREMENTS AND SPECIFICATIONS.
- SANITARY SEWER PIPE SHALL BE POLYVINYL CHLORIDE (PVC) SDR 35 PIPE PER ASTM D3034 WITH WATERTIGHT JOINTS CONFORMING TO ASTM D3212, UNLESS OTHERWISE NOTED.
- 3.1. WHERE SANITARY SEWER PIPE IS NOTED AS PVC C900, THE PIPE SHALL BE IN ACCORDANCE WITH AMERICAN WATER WORKS ASSOCIATION (AWWA) C900 WITH WATERTIGHT, PRESSURE RATED JOINTS CONFORMING TO ASTM D3139.
- 4. SANITARY SEWER CONSTRUCTION SHALL COMMENCE AT THE EXISTING MANHOLE(S) AND/OR CONNECTION POINT(S) INDICATED ON THE PLANS.
- 4.1. A WATERTIGHT PLUG SHALL BE INSTALLED AND LEFT IN PLACE AT THE POINT OF COMMENCEMENT UNTIL THE REMAINDER OF THE PROPOSED SEWERS HAVE BEEN CONSTRUCTED, PROPERLY TESTED AND DEEMED READY FOR FINAL ACCEPTANCE.
- 5. SANITARY SEWER TRENCH EXCAVATIONS AND PIPE FOUNDATION, BEDDING AND HAUNCHING SHALL BE CONSTRUCTED IN ACCORDANCE WITH LOCAL REQUIREMENTS AND SPECIFICATIONS.
- 5.1. SANITARY SEWERS MUST BE PLACED ON PROPERLY COMPACTED STONE BEDDING. PIPE BEDDING MATERIAL SHALL BE A MINIMUM OF FOUR (4) INCHES THICK UNDER THE BARREL OF THE PIPE AND FOR PVC PIPE, MATERIAL SHALL BE EXTENDED A MINIMUM OF 12" OVER THE TOP OF THE PIPE PER ASTM D-2321. PIPE BEDDING MATERIAL SHALL BE CRUSHED GRAVEL OR STONE MEETING LOCAL STANDARD GRADATIONS.
- 5.2. GRANULAR TRENCH BACKFILL MATERIAL SHALL BE PLACED AND COMPACTED TO A MINIMUM OF 95% MODIFIED PROCTOR DENSITY, PER ASTM D1557, OVER ALL SANITARY SEWERS WHICH ARE CONSTRUCTED UNDER, OR WITHIN TWO (2) FEET OF, ANY PROPOSED OR EXISTING PAVEMENT, PARKING LOTS OR SIDEWALKS.
- 6. THE CONTRACTOR IS REQUIRED TO RECORD THE LOCATION OF ALL SEWERS AND FURNISH THE INFORMATION TO THE PROJECT ENGINEER AND/OR OWNER'S REPRESENTATIVE. THE CONTRACTOR SHALL LOCATE ALL SEWERS BY MEASUREMENTS TO LOT CORNERS OR OTHER PERMANENT SITE FEATURE AND SHALL FURNISH A COPY OF SUCH LOCATIONS TO THE PROJECT ENGINEER AND/OR OWNER'S REPRESENTATIVE UPON PROJECT COMPLETION. THIS INFORMATION SHALL ALSO INCLUDE THE DEPTH OF EACH SEWER. IF THE CONTRACTOR FAILS TO PROPERLY LOCATE ANY SEWER, HE SHALL BE RESPONSIBLE FOR ALL COSTS WHICH ARE INCURRED AS A RESULT OF THE IMPROPERLY LOCATED UTILITIES.
- SANITARY SEWER MANHOLES SHALL BE PRECAST CONCRETE AND SHALL BE FURNISHED AND INSTALLED IN ACCORDANCE WITH THE DETAILS SHOWN ON THE PLANS
- 7.1. A FLEXIBLE TYPE JOINT SHALL BE FURNISHED AT POINTS OF ENTRY INTO AND EXITING FROM MANHOLE STRUCTURES AND SHALL BE OF A DESIGN APPROVED BY THE ENGINEER PRIOR TO INSTALLATION. THIS FLEXIBLE JOINT MAY CONSIST OF A SLEEVE OF HIGH QUALITY SYNTHETIC RUBBER WITH A SUBSTANTIAL SERRATED FLANGE WHICH IS CAST DIRECTLY INTO THE WALL OF THE MANHOLE BASE TO FORM A WATERTIGHT SEAL AND PROTRUDES OUTSIDE OF THE MANHOLE WALL TO CONNECT WITH THE PIPE ENTERING/EXITING THE MANHOLE. WHEN THIS TYPE OF FLEXIBLE JOINT IS USED, THE SLEEVE SHALL SLIP OVER THE END OF THE PIPE ADJACENT TO THE MANHOLE BASE AND SHALL BE SECURED BY MEANS OF A STAINLESS STEEL STRAP CLAMP EQUIPPED WITH A DRAW BOLT AND NUT.
- 8. REQUIRED MANHOLE RIM ADJUSTMENTS SHALL BE MADE WITH PRECAST CONCRETE ADJUSTING RINGS NOT TO EXCEED A MAXIMUM OF EIGHT (8) INCHES IN OVERALL HEIGHT. A MAXIMUM OF TWO (2) ADJUSTING RINGS ARE ALLOWED. BUTYLROPE JOINT SEALANT SHALL BE USED ON ALL JOINTS BETWEEN THE PRECAST ELEMENTS.

SANITARY SEWER NOTES (continued):

- 9. AFTER FINAL ADJUSTMENTS HAVE BEEN MADE, ALL JOINTS IN PRECAST STRUCTURES SHALL BE MORTARED. THE MORTAR SHALL BE COMPOSED OF ONE (1) PART CEMENT TO THREE (3) PARTS SAND, BY VOLUME, BASED ON DRY MATERIALS, AND SHALL BE THOROUGHLY WETTED BEFORE LAYING.
- 10. WHEN CONNECTING TO AN EXISTING SEWER MAIN BY MEANS OTHER THAN AN EXISTING WYE, TEE, OR MANHOLE, THE FOLLOWING METHOD SHALL BE USED:
- 10.1. CIRCULAR SAW—CUT OF SEWER MAIN BY PROPER TOOLS ('SEWER—TAP' MACHINE OR SIMILAR) AND PROPER INSTALLATION OF HUB—WYE SADDLE OR HUB—TEE SADDLE.
- 11. UPON COMPLETION OF THE SANITARY SEWER CONSTRUCTION, INCLUDING THE SERVICE LINES, ALL SEWERS SHALL BE TESTED IN ACCORDANCE WITH LOCAL REQUIREMENTS AND SPECIFICATIONS AND SHALL BE WITNESSED BY THE LOCAL GOVERNING AUTHORITY OR AUTHORIZED REPRESENTATIVE.

WATER MAIN AND WATER SERVICE NOTES:

- 1. ALL WATER MAIN CONSTRUCTION SHALL BE PERFORMED IN ACCORDANCE WITH THE NOTES ON THE PLANS AND THE STANDARDS, SPECIFICATIONS, CODES AND ORDINANCES OF THE LOCAL GOVERNING AUTHORITIES. IN CASE OF CONFLICT, THE MORE STRINGENT CODE SHALL TAKE PRECEDENCE.
- . WATER MAIN PIPE AND STRUCTURES SHALL BE FURNISHED AND INSTALLED IN ACCORDANCE WITH LOCAL REQUIREMENTS AND SPECIFICATIONS.
- 3. WATER MAIN SHALL BE POLYVINYL CHLORIDE (PVC) C900 DR18 PIPE IN ACCORDANCE WITH AMERICAN WATER WORKS ASSOCIATION (AWWA) STANDARD C900 WITH PRESSURE RATED FLEXIBLE (O-RING) SLIP ON JOINTS CONFORMING TO ASTM D3139, UNLESS OTHERWISE NOTED.
- 4. UNLESS OTHERWISE NOTED ON THE PLANS, ALL WATER MAIN PIPE SHALL BE LAID WITH A MINIMUM COVER OF FIVE (5) FEET FROM THE PROPOSED FINISH GRADE INDICATED ON THE PLANS OR TO THE SPECIFIC TOP OF PIPE ELEVATION INDICATED ON THE PLANS FOR THE WATER MAIN. NO BERMS ARE ALLOWED OVER WATER MAINS EXCLUSIVELY FOR THE PURPOSE OF OBTAINING ADEQUATE GROUND COVER.
- 5. DUCTILE IRON WATER MAIN PIPE SHALL BE CONSTRUCTED WITH A MINIMUM OF 8-MIL POLYETHYLENE ENCASEMENT TO PREVENT CORROSION.
- 6. WATER MAIN TRENCH EXCAVATIONS AND PIPE FOUNDATION, BEDDING AND HAUNCHING SHALL BE CONSTRUCTED IN ACCORDANCE WITH LOCAL REQUIREMENTS AND SPECIFICATIONS.
- 6.1. WATER MAINS MUST BE PLACED ON PROPERLY COMPACTED STONE BEDDING.
 PIPE BEDDING MATERIAL SHALL BE A MINIMUM OF FOUR (4) INCHES THICK
 UNDER THE BARREL OF THE PIPE. PIPE BEDDING MATERIAL SHALL BE
 CRUSHED GRAVEL OR STONE MEETING LOCAL STANDARD GRADATIONS.
- 6.2. GRANULAR TRENCH BACKFILL MATERIAL SHALL BE PLACED AND COMPACTED TO A MINIMUM OF 95% MODIFIED PROCTOR DENSITY, PER ASTM D1557, OVER ALL WATER MAINS WHICH ARE CONSTRUCTED UNDER, OR WITHIN TWO (2) FEET OF, ANY PROPOSED OR EXISTING PAVEMENT, PARKING LOTS OR SIDEWALKS.
- 7. A WATERTIGHT PLUG SHALL BE PLACED IN THE END OF THE WATER MAIN PIPE AT THE END OF EACH CONSTRUCTION DAY.
- 8. UPON COMPLETION OF THE WATER MAIN CONSTRUCTION, ALL WATER MAIN SHALL BE TESTED IN ACCORDANCE WITH THE FOLLOWING MINIMUM STANDARDS:
- REQUIREMENTS AND SPECIFICATIONS AND SHALL BE WITNESSED BY THE LOCAL GOVERNING AUTHORITY.

 8.2. DISINFECTION IN ACCORDANCE WITH LOCAL REQUIREMENTS AND THE METHODS

8.1. HYDROSTATIC PRESSURE AND LEAKAGE TESTS IN ACCORDANCE WITH LOCAL

- STATED IN AWWA STANDARD C651 AND WITNESSED BY THE LOCAL GOVERNING AUTHORITY.
- 9. WATER SERVICE PIPING AND STRUCTURES SHALL BE FURNISHED AND INSTALLED IN ACCORDANCE WITH LOCAL REQUIREMENTS AND SPECIFICATIONS.
- 10. WATER SERVICE LINES 2" IN DIAMETER OR SMALLER SHALL BE TYPE 'K' COPPER TUBING CONFORMING TO ASTM B88-58. NO COUPLINGS SHALL BE PERMITTED BETWEEN THE CORPORATION AND CURB STOPS OR BETWEEN THE CURB STOP AND THE BUILDING.
- 11. WATER SERVICE FITTINGS INCLUDING CORPORATION STOPS, SERVICE BOXES AND BUFFALO BOXES SHALL BE FURNISHED IN ACCORDANCE WITH LOCAL REQUIREMENTS AND SPECIFICATIONS.
- 12. SERVICE BOXES SHALL BE OF SUFFICIENT LENGTH TO PERMIT THE TOP TO BE INSTALLED FLUSH WITH THE FINISHED GRADE. EACH SERVICE BOX SHALL BE PROVIDED WITH A CAP WITH THE WORD "WATER" CAST IN THE TOP.
- 13. VALVES, VALVE BOXES OR VAULTS SHALL BE FURNISHED AND INSTALLED IN ACCORDANCE WITH LOCAL REQUIREMENTS.
- 14. PRESSURE CONNECTIONS TO THE EXISTING WATER MAIN SHALL BE CONSTRUCTED IN ACCORDANCE WITH LOCAL REQUIREMENTS AND SPECIFICATIONS AND SHALL INCLUDE THE INSTALLATION OF A FULL STAINLESS STEEL TAPPING SADDLE.
- 15. VALVE VAULTS SHALL HAVE A MINIMUM DIAMETER OF FIVE (5) FEET BELOW THE PRECAST CONCRETE CONE SECTION. THE VAULTS SHALL BE CONSTRUCTED OF PRECAST CONCRETE SECTIONS AND SHALL CONFORM TO THE DETAILS SPECIFIED ON THE PLANS. ALL VALVE VAULTS SHALL BE LEAK PROOF.
- 16. TEMPORARY CONNECTIONS FOR CONSTRUCTION PURPOSES TO NEWLY INSTALLED OR EXISTING WATER MAINS SHALL BE MADE AND METERED IN ACCORDANCE WITH LOCAL REQUIREMENTS.
- RINGS NOT TO EXCEED A MAXIMUM OF EIGHT (8) INCHES IN OVERALL HEIGHT. A MAXIMUM OF TWO (2) ADJUSTING RINGS ARE ALLOWED. BUTYLROPE JOINT SEALANT SHALL BE USED ON ALL JOINTS BETWEEN THE PRECAST ELEMENTS.

17. REQUIRED RIM ADJUSTMENTS SHALL BE MADE WITH PRECAST CONCRETE ADJUSTING

WATER AND SEWER SEPARATION NOTES:

1. WATER MAINS SHALL BE LOCATED AT LEAST TEN (10) FEET HORIZONTALLY FROM

2. WATER MAINS MAY BE LOCATED CLOSER THAN TEN (10) FEET TO A SEWER LINE

2.1. LOCAL CONDITIONS PREVENT A LATERAL SEPARATION OF TEN (10) FEET; AND

2.2. THE WATER MAIN INVERT IS AT LEAST EIGHTEEN (18) INCHES ABOVE THE

2.3. THE WATER MAIN IS EITHER IN A SEPARATE TRENCH OR IN THE SAME TRENCH

3. WHEN IT IS IMPOSSIBLE TO MEET 1) OR 2) ABOVE, BOTH THE WATER MAIN AND

ON AN UNDISTURBED EARTH SHELF LOCATED TO ONE SIDE OF THE SEWER.

DRAIN OR SEWER SHALL BE CONSTRUCTED OF SLIP-ON OR MECHANICAL JOINT

CAST OR DUCTILE IRON PIPE, PRE-STRESSED CONCRETE PIPE, OR PVC PIPE

EQUIVALENT TO WATER MAIN STANDARDS OF CONSTRUCTION. THE DRAIN OR SEWER

SHALL BE PRESSURE TESTED FOR THE MAXIMUM EXPECTED SURCHARGE HEAD

MINIMUM OF EIGHTEEN (18) INCHES ABOVE THE CROWN OF THE DRAIN OR SEWER

WHENEVER WATER MAINS CROSS STORM SEWERS, SANITARY SEWERS, OR SEWER

SERVICE CONNECTIONS. THE VERTICAL SEPARATION SHALL BE MAINTAINED FOR THAT

PORTION OF THE WATER MAIN LOCATED WITHIN TEN (10) FEET HORIZONTALLY OF

ANY SEWER OR DRAIN CROSSED. A LENGTH OF WATER MAIN PIPE SHALL BE

CENTERED OVER THE SEWER TO BE CROSSED WITH JOINTS EQUIDISTANT FROM THE

BOTH THE WATER MAIN AND SEWER SHALL BE CONSTRUCTED OF SLIP-ON OR

MECHANICAL JOINT CAST OR DUCTILE IRON PIPE, PRE-STRESSED CONCRETE PIPE,

DESCRIBED IN 4) ABOVE: OR THE WATER MAIN PASSES UNDER A SEWER OR

OR PVC PIPE EQUIVALENT TO WATER MAIN STANDARDS OF CONSTRUCTION WHEN:

5.1. IT IS IMPOSSIBLE TO OBTAIN THE PROPER VERTICAL SEPARATION AS

6. A VERTICAL SEPARATION OF EIGHTEEN (18) INCHES BETWEEN THE INVERT OF THE

7. CONSTRUCTION SHALL EXTEND ON EACH SIDE OF THE CROSSING UNTIL THE

1. CONTRACTOR SHALL OBTAIN ALL NECESSARY PERMITS PRIOR TO

2. CONTRACTOR SHALL BE RESPONSIBLE FOR PROVIDING SAFE AND ADEQUATE

WORKING CONDITIONS THROUGHOUT THE DURATION OF CONSTRUCTION OF THE

CONTRACTOR SHALL BE RESPONSIBLE FOR VERIFICATION OF ALL SITE

4. ALL CONSTRUCTION MATERIALS AND WORKMANSHIP SHALL BE IN ACCORDANCE

5. ALL HANDICAP ACCESSIBLE SITE IMPROVEMENTS SHALL BE CONSTRUCTED IN

6. IF DURING THE COURSE OF CONSTRUCTION THE CONTRACTOR FINDS ANY

SETBACKS, EASEMENTS AND DIMENSIONS PRIOR TO COMMENCEMENT OF

WITH THE LATEST STATE AND LOCAL GOVERNMENT CONSTRUCTION STANDARDS

ACCORDANCE WITH ALL FEDERAL, STATE AND LOCAL CODES AND

DISCREPANCIES OR CONFLICTS BETWEEN THE PROPOSED SITE IMPROVEMENTS

INDICATED ON THE PLANS AND THE PHYSICAL CONDITIONS OF THE SITE, OR

ANY ERRORS OR OMISSIONS WITHIN THE PLANS OR IN THE SITE LAYOUT AS

PROVIDED BY THE ENGINEER, IT SHALL BE THE RESPONSIBILITY OF THE

CONTRACTOR TO IMMEDIATELY NOTIFY THE ENGINEER. UNTIL AUTHORIZED TO

PROCEED, ANY WORK PERFORMED BY THE CONTRACTOR AFTER SUCH A

NEW PLANTINGS AND TURF AREA RESTORATION REQUIREMENTS, WITH

CURB OR EDGE OF PAVEMENT TO EDGE OF PAVEMENT UNLESS OTHERWISE

DISCOVERY WILL BE AT THE CONTRACTOR'S SOLE RISK AND EXPENSE.

7. CONTRACTOR SHALL COORDINATE ALL SITE IMPROVEMENTS WITH ARCHITECTURAL

8. CONTRACTOR SHALL COORDINATE ALL LANDSCAPE IMPROVEMENTS, INCLUDING

9. CONSTRUCTION SURVEY AND STAKEOUT SHALL BE THE RESPONSIBILITY OF THE

10. ALL DIMENSIONS SHOWN ARE MEASURED FROM FACE OF CURB TO FACE OF

11. ALL CURB RADII ARE MEASURED AT THE FACE OF CURB UNLESS OTHERWISE

12. ALL NEW ASPHALT AND/OR CONCRETE PAVING SHALL MATCH EXISTING

13. CONTRACTOR SHALL RESTORE ALL DISTURBED AREAS OUTSIDE OF

14. CONTRACTOR SHALL REPAIR AT HIS EXPENSE ANY DAMAGE TO EXISTING

15. ALL FIRE ACCESS LANES WITHIN THE PROJECT AREA SHALL REMAIN IN SERVICE.

16. ALL DETECTIBLE WARNING PLATES SHALL BE PREFORMED PLASTIC INSERTS

CLEAN OF DEBRIS, AND ACCESSIBLE FOR USE BY EMERGENCY VEHICLES.

17. SEE GENERAL NOTES SHEET FOR ADDITIONAL INFORMATION AND REQUIREMENTS.

ASPHALT, CONCRETE, CURBS, SIDEWALKS, ETC. RESULTING FROM CONSTRUCTION

TRAFFIC AND/OR OPERATIONS. REPAIRS SHALL BE MADE TO THE SATISFACTION

CONSTRUCTION LIMITS TO ORIGINAL CONDITION OR BETTER.

PLANS. ARCHITECTURAL PLANS SHALL BE USED FOR BUILDING STAKEOUT.

AS SHOWN ON THE PLANS OR AS APPROVED BY THE ENGINEER.

SEWER OR DRAIN AND THE CROWN OF THE WATER MAIN SHALL BE MAINTAINED

WHERE A WATER MAIN CROSSES UNDER A SEWER. THE SEWER OR DRAIN LINES

SHALL BE SUPPORTED TO PREVENT SETTLING AND BREAKING OF THE WATER MAIN.

PERPENDICULAR DISTANCE FROM THE WATER MAIN TO THE SEWER OR DRAIN LINE

4. WATER MAINS SHALL BE SEPARATED FROM A SEWER SO THAT ITS INVERT IS A

SEWER. OR SEWER SERVICE CONNECTION.

CROWN OF THE SEWER; AND

PRIOR TO BACKFILLING.

SEWER OR DRAIN.

IS AT LEAST TEN (10) FEET.

GENERAL SITE NOTES:

COMMENCEMENT OF CONSTRUCTION.

PROPOSED SITE IMPROVEMENTS.

CONSTRUCTION.

REQUIREMENTS.

LANDSCAPE PLANS.

PAVEMENTS FLUSH.

OF THE OWNER AND/OR ENGINEER.

UNLESS OTHERWISE NOTED.

CONTRACTOR.

NOTED.

WHEN:

ANY EXISTING OR PROPOSED DRAIN, STORM SEWER, SANITARY SEWER, COMBINED

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07/28/15 BID SET

09/14/15 PERMIT RESPONSE

2 10/19/15 CONSTRUCTION SET

11/02/15 PERMIT RESPONSE 11/23/15 PERMIT RESPONSE

PROFESSIONAL SEAL



PROFESSIONAL IN CHARGE FARMAN SHIR, P.E.

PROFESSIONAL ENGINEER
LICENSE NO. 21307
PROJECT MANAGER
MIKE HOLMES

QUALITY CONTROL
LARRY DIEHL
DRAWN BY

MIKE HOLMES
PROJECT NAME

TEXAS ROADHOUSE


ALBUQUERQUE NEW MEXICO

10030 COORS BOULEVARD BYPASS NW



PROJECT NUMBER 20130487.0

SHEET TITLE
GENERAL
NOTES

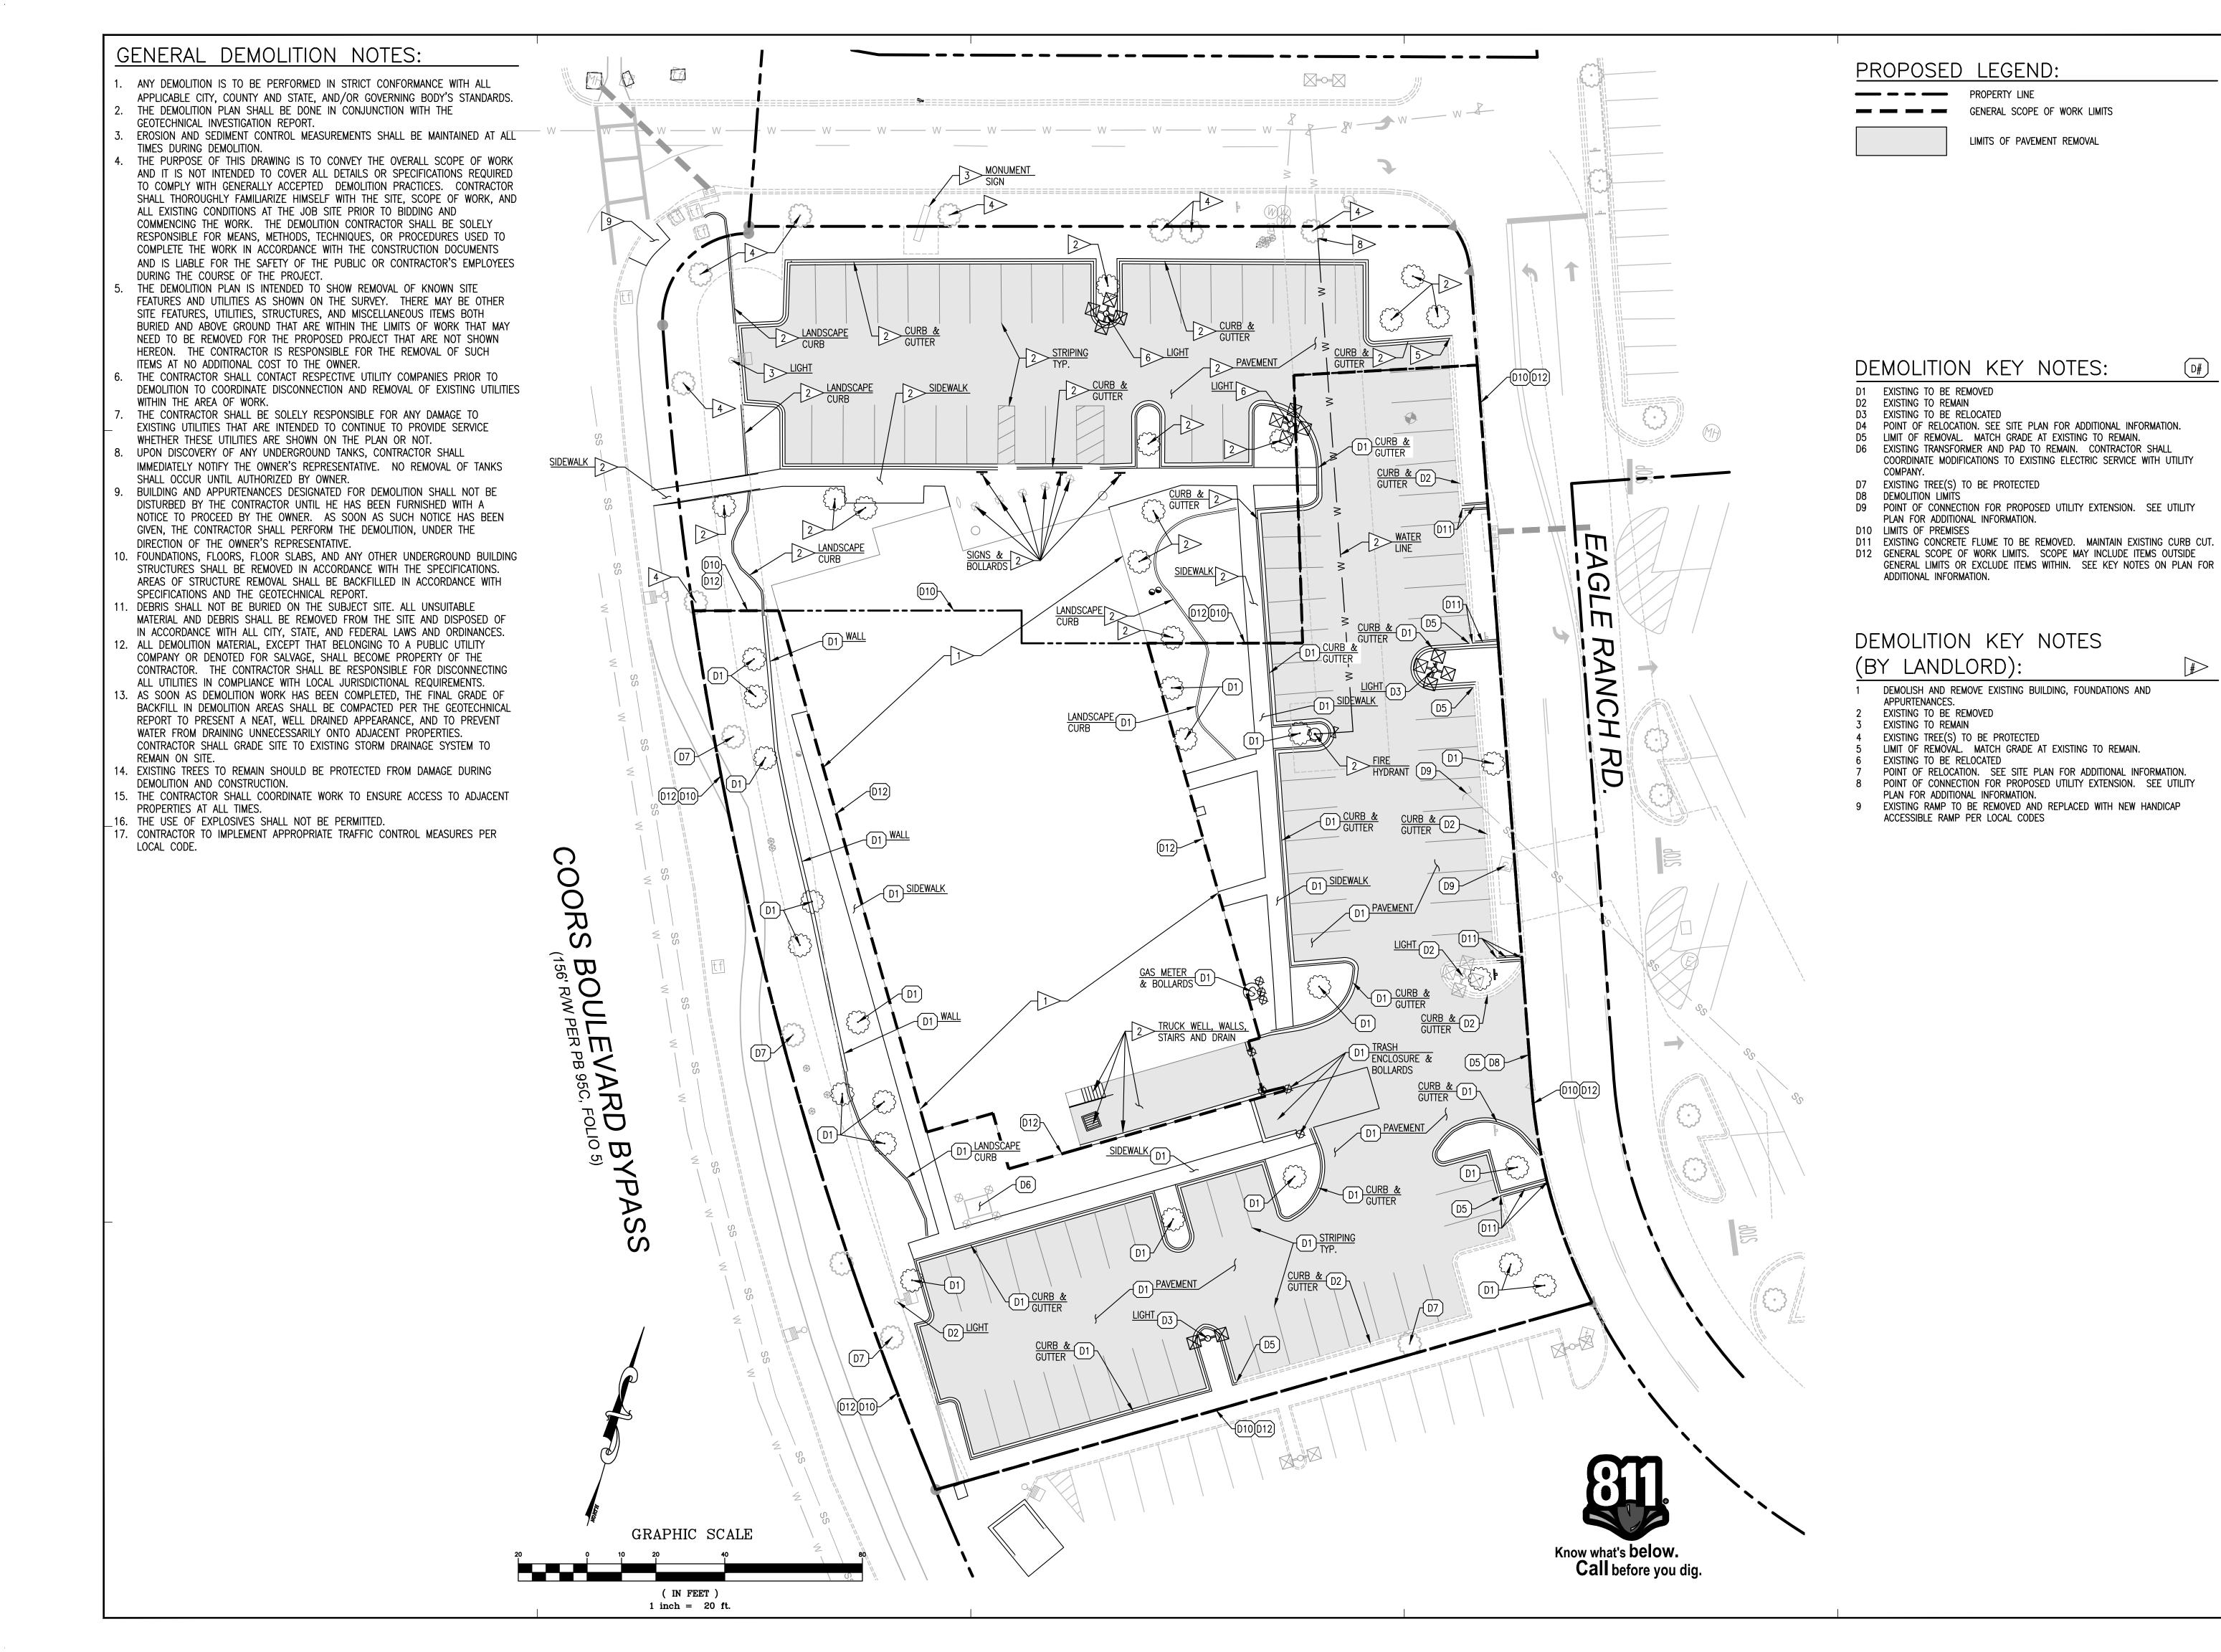

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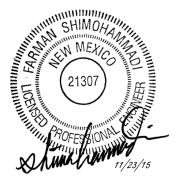
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PROFESSIONAL SEAL



PROFESSIONAL IN CHARGE FARMAN SHIR, P.E.
PROFESSIONAL ENGINEER

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LICENSE NO. 21307
PROJECT MANAGER

MIKE HOLMES

QUALITY CONTROL

LARRY DIEHL

MIKE HOLMES
PROJECT NAME

TEXAS ROADHOUSE


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PROJECT NUMBER 20130487.0

SHEET TITLE
DEMOLITION
PLAN



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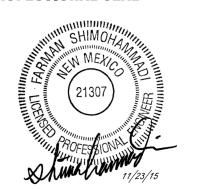
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PROFESSIONAL SEAL

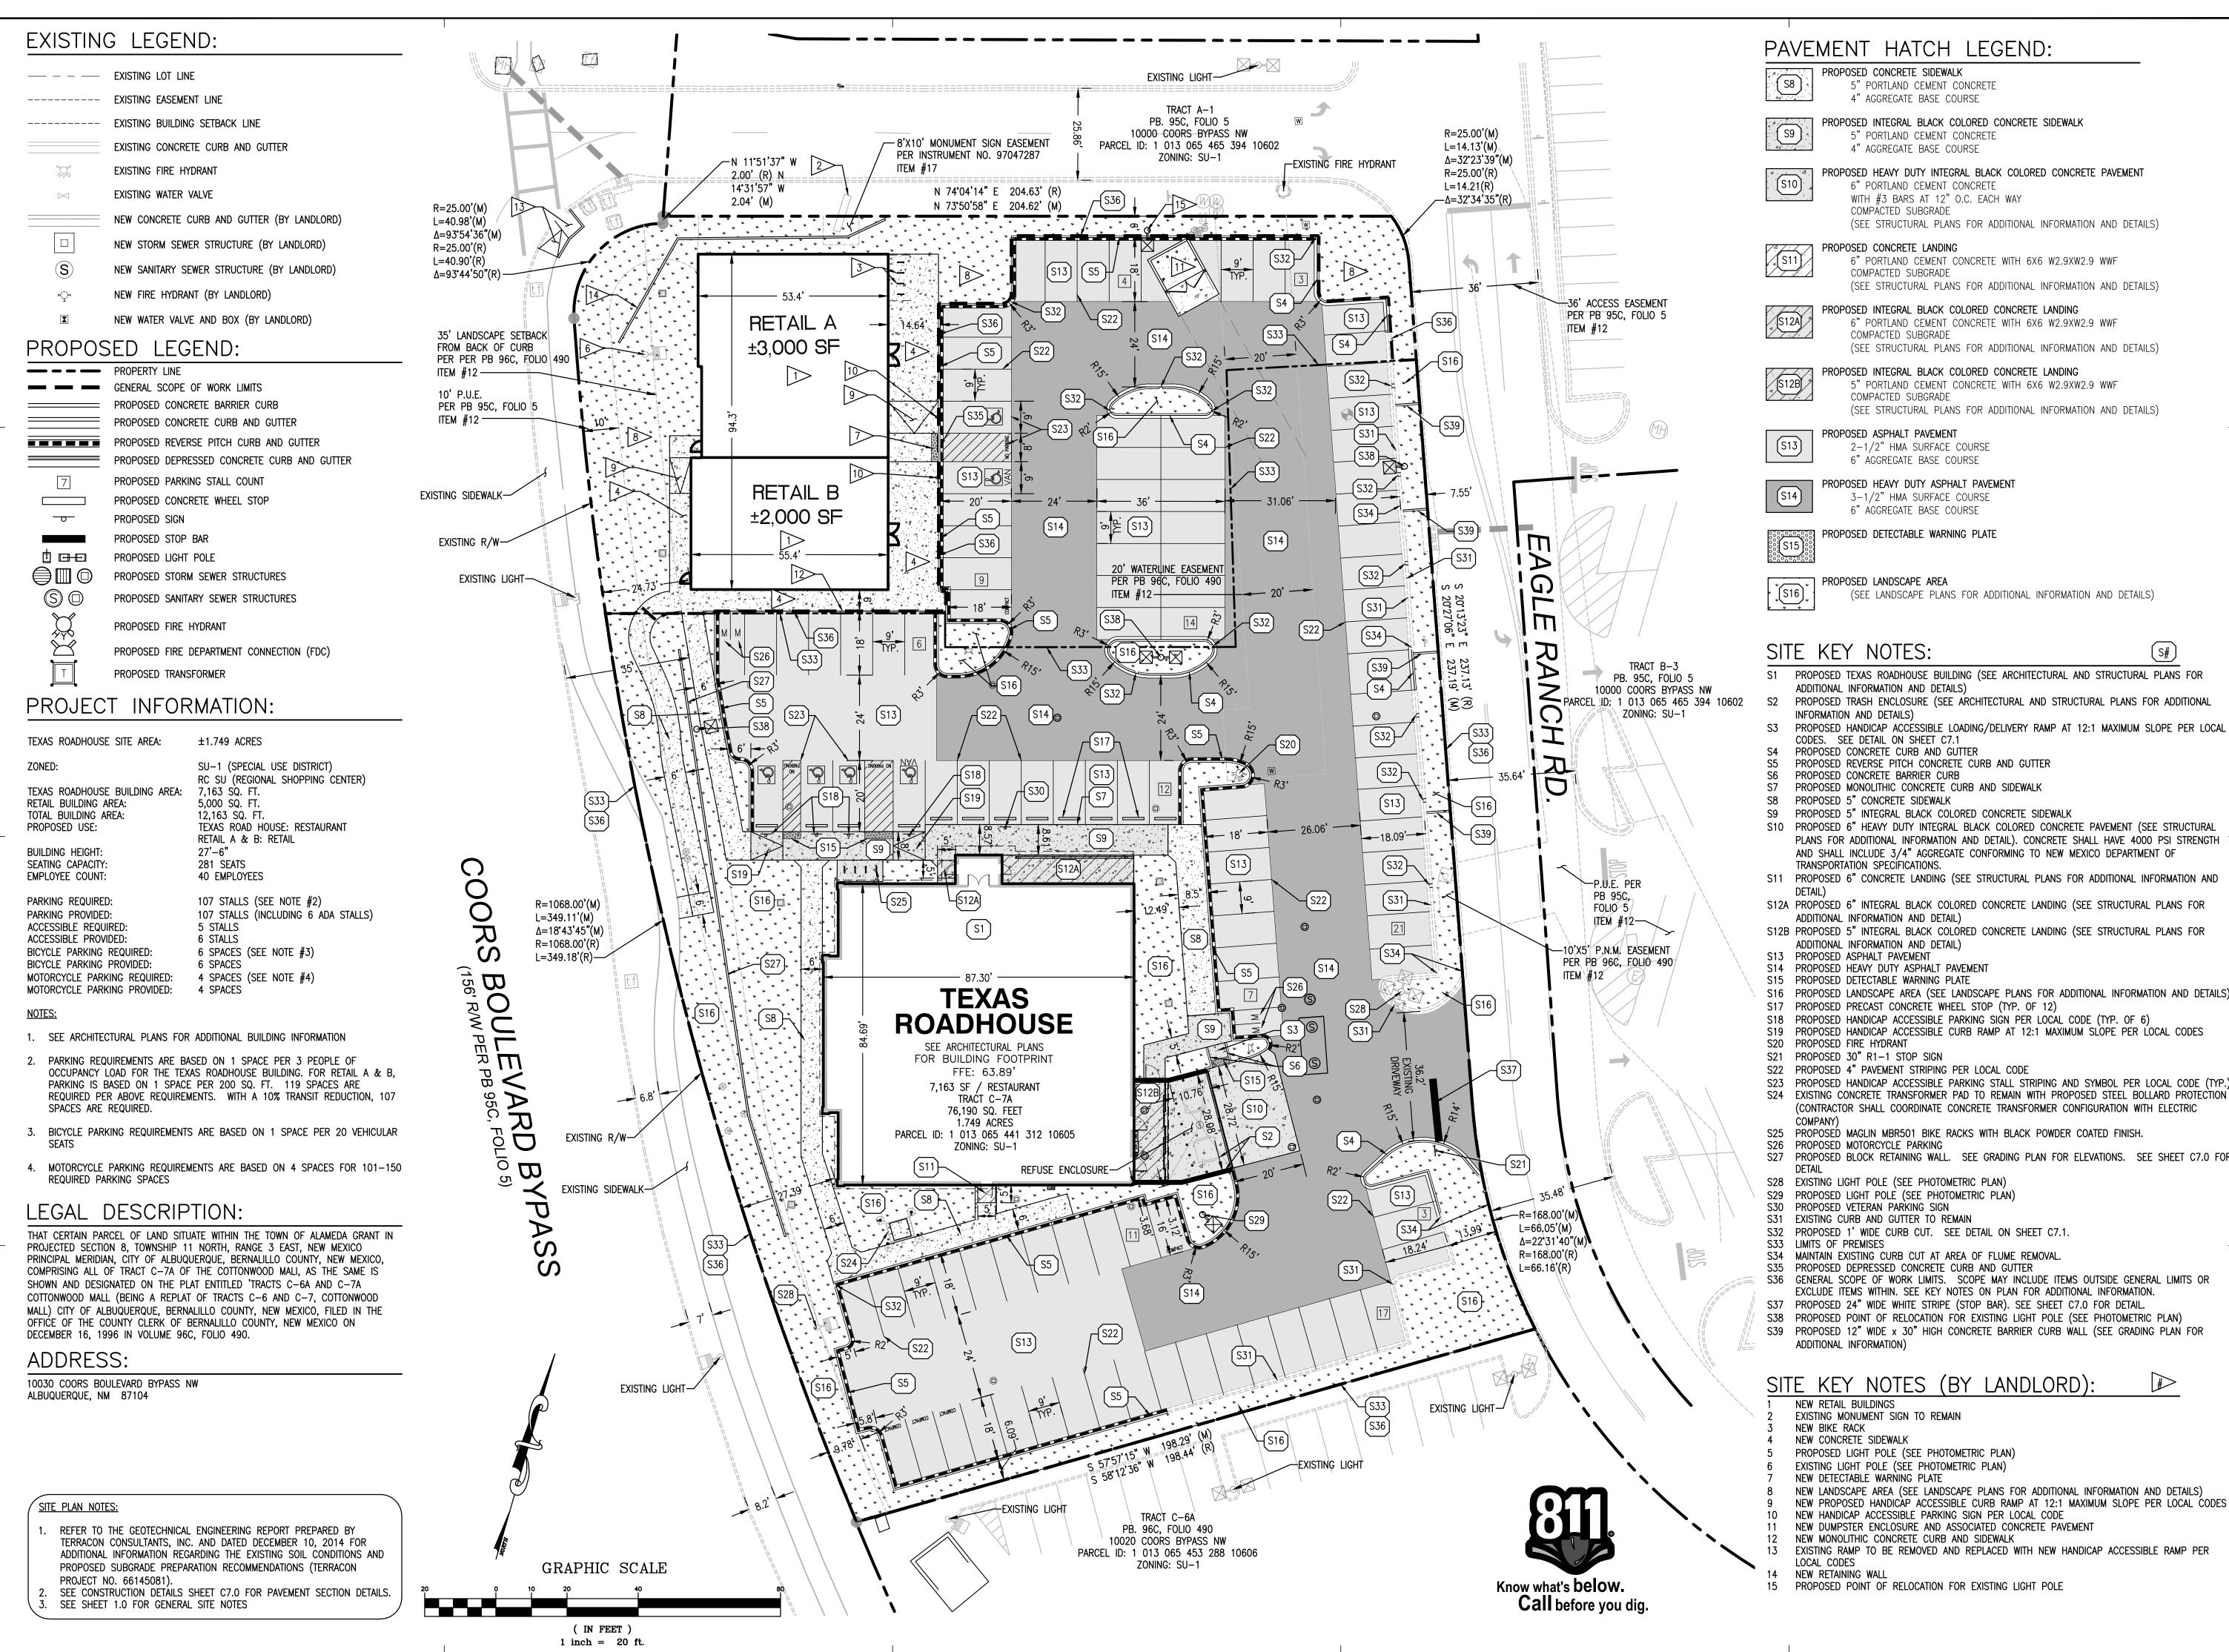

PROFESSIONAL IN CHARGE FARMAN SHIR, P.E.

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MIKE HOLMES

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QUALITY CONTROL

LARRY DIEHL

MIKE HOLMES
PROJECT NAME

TEXAS ROADHOUSE

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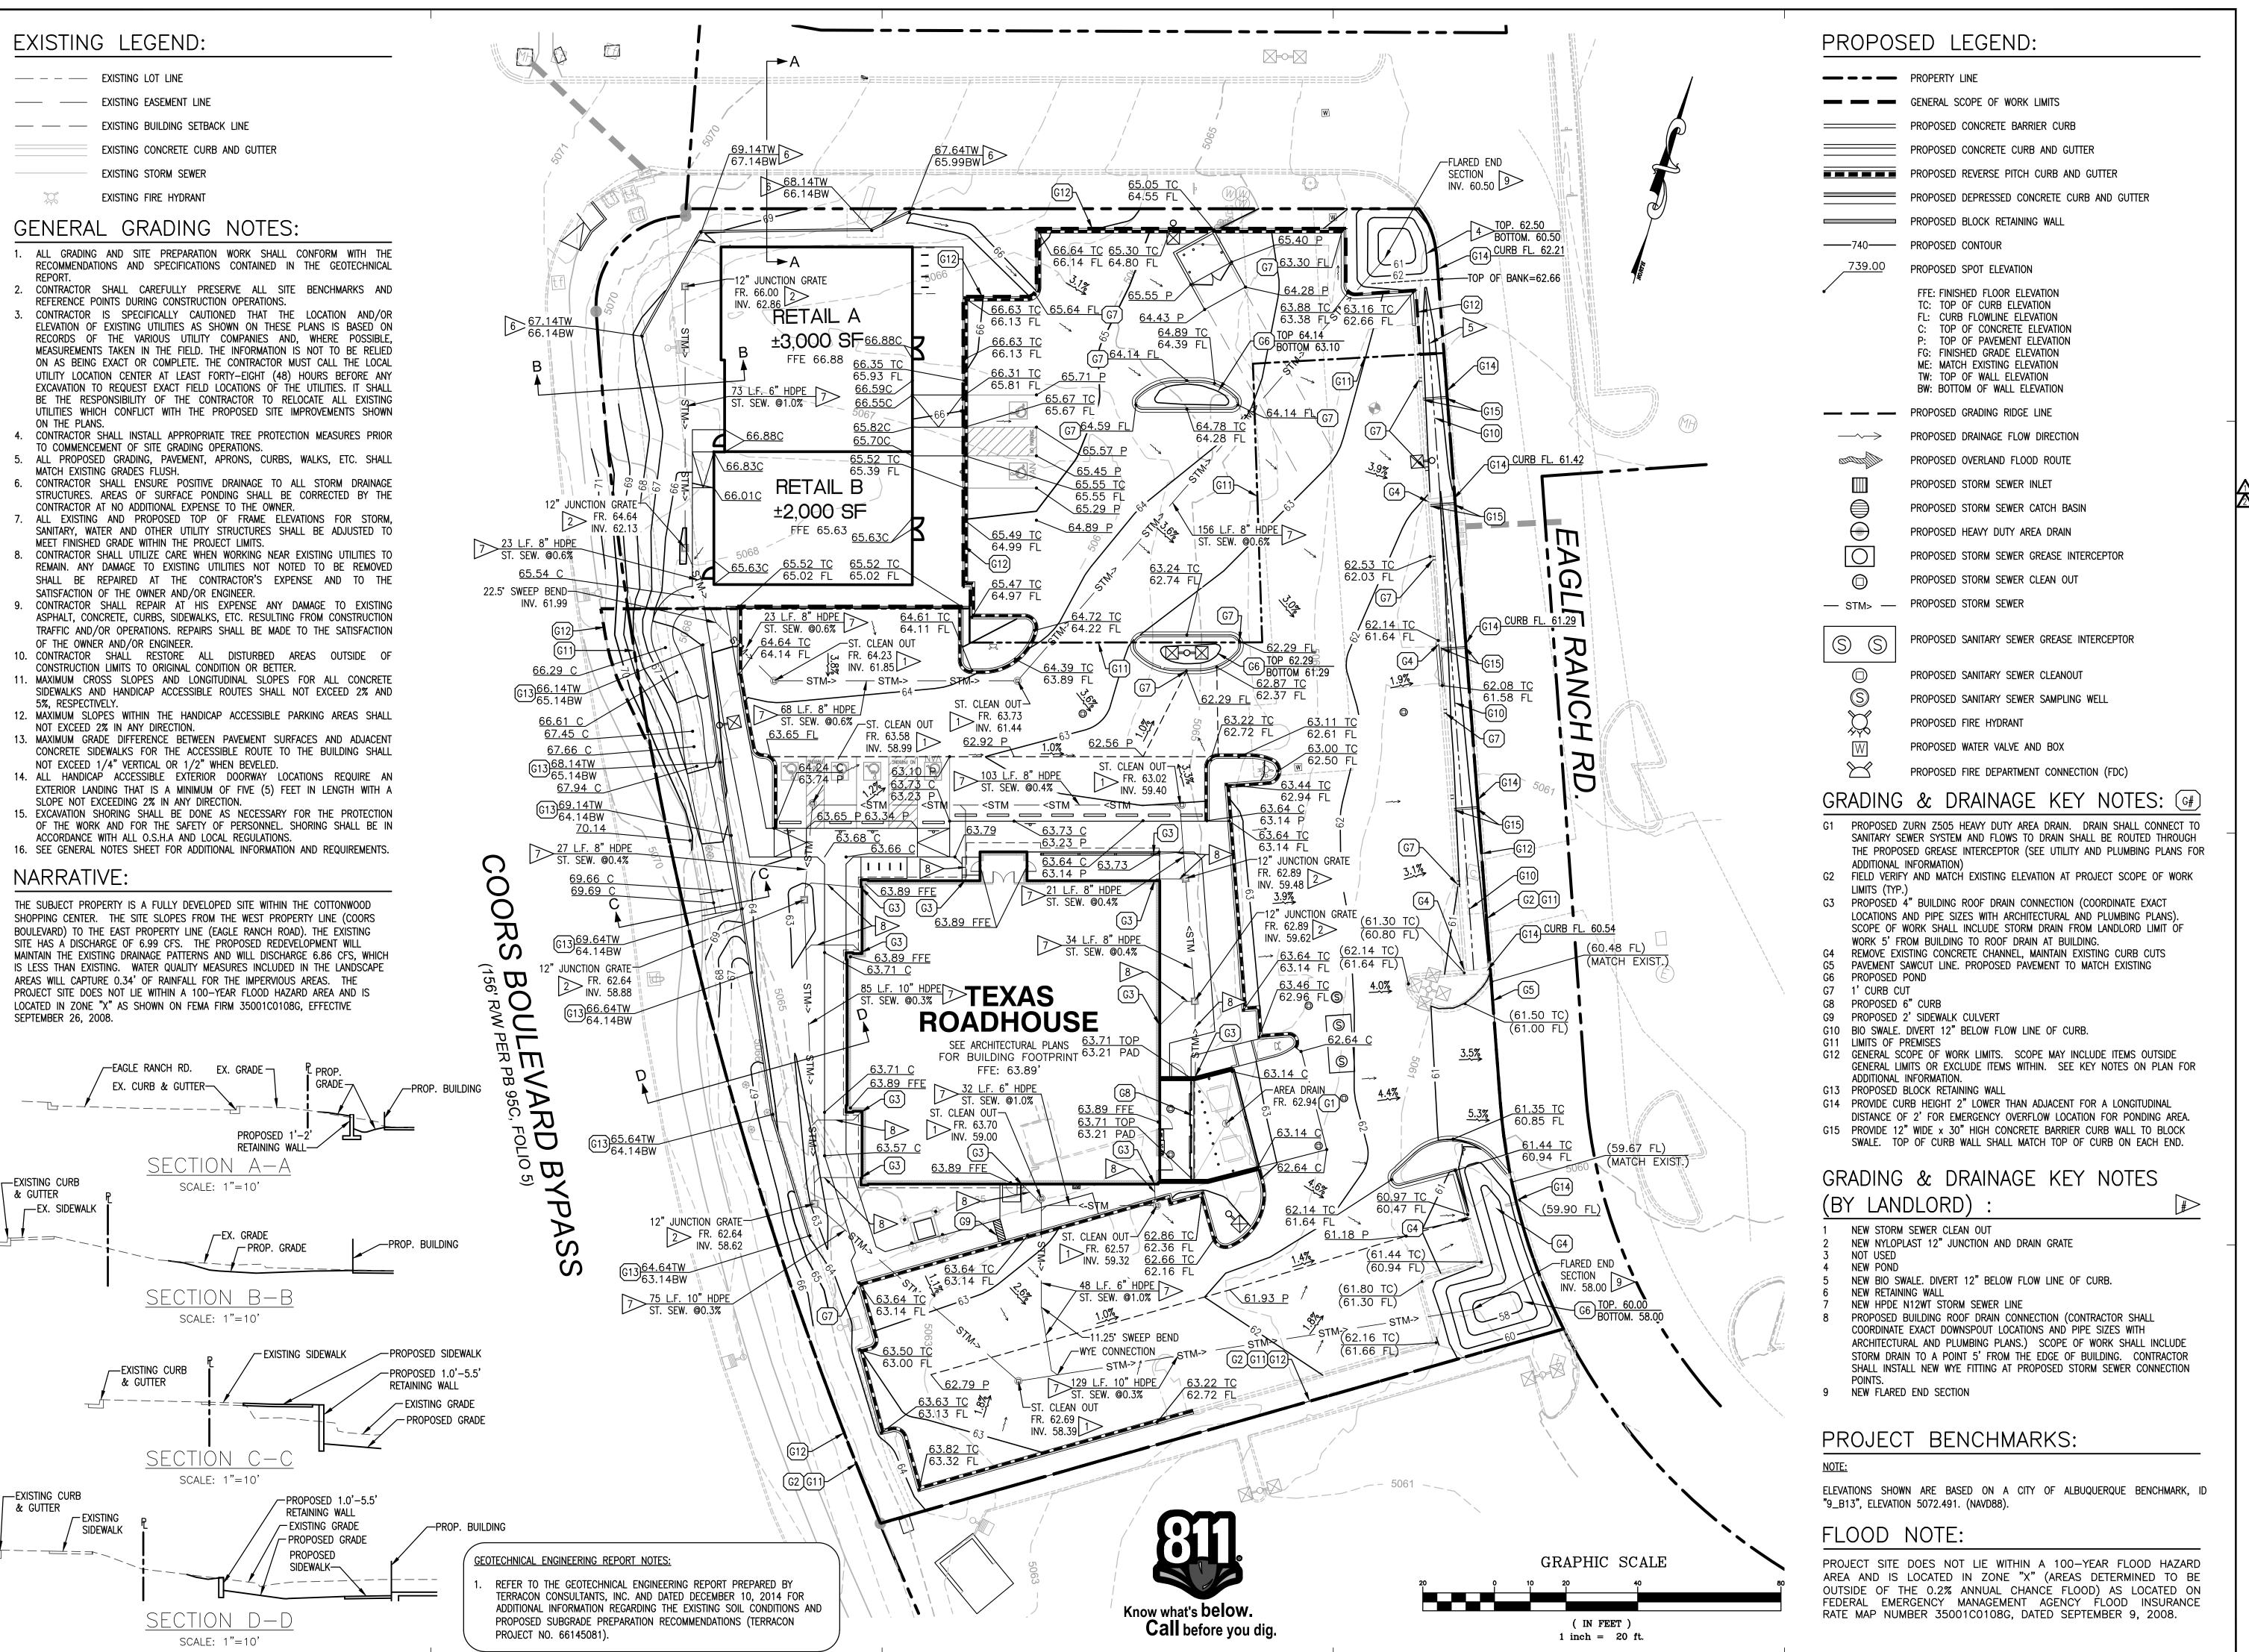


PROJECT NUMBER 20130487.0

SHEET TITLE

PLAN

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PROFESSIONAL SEAL



PROFESSIONAL IN CHARGE

FARMAN SHIR, P.E. PROFESSIONAL ENGINEER LICENSE NO. 21307 PROJECT MANAGER

MIKE HOLMES **QUALITY CONTROL** LARRY DIEHL DRAWN BY

MIKE HOLMES **PROJECT NAME**

TEXAS ROADHOUSE


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PROJECT NUMBER 20130487.0

SHEET TITLE GRADING AND DRAINAGE PLAN



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PROFESSIONAL SEAL

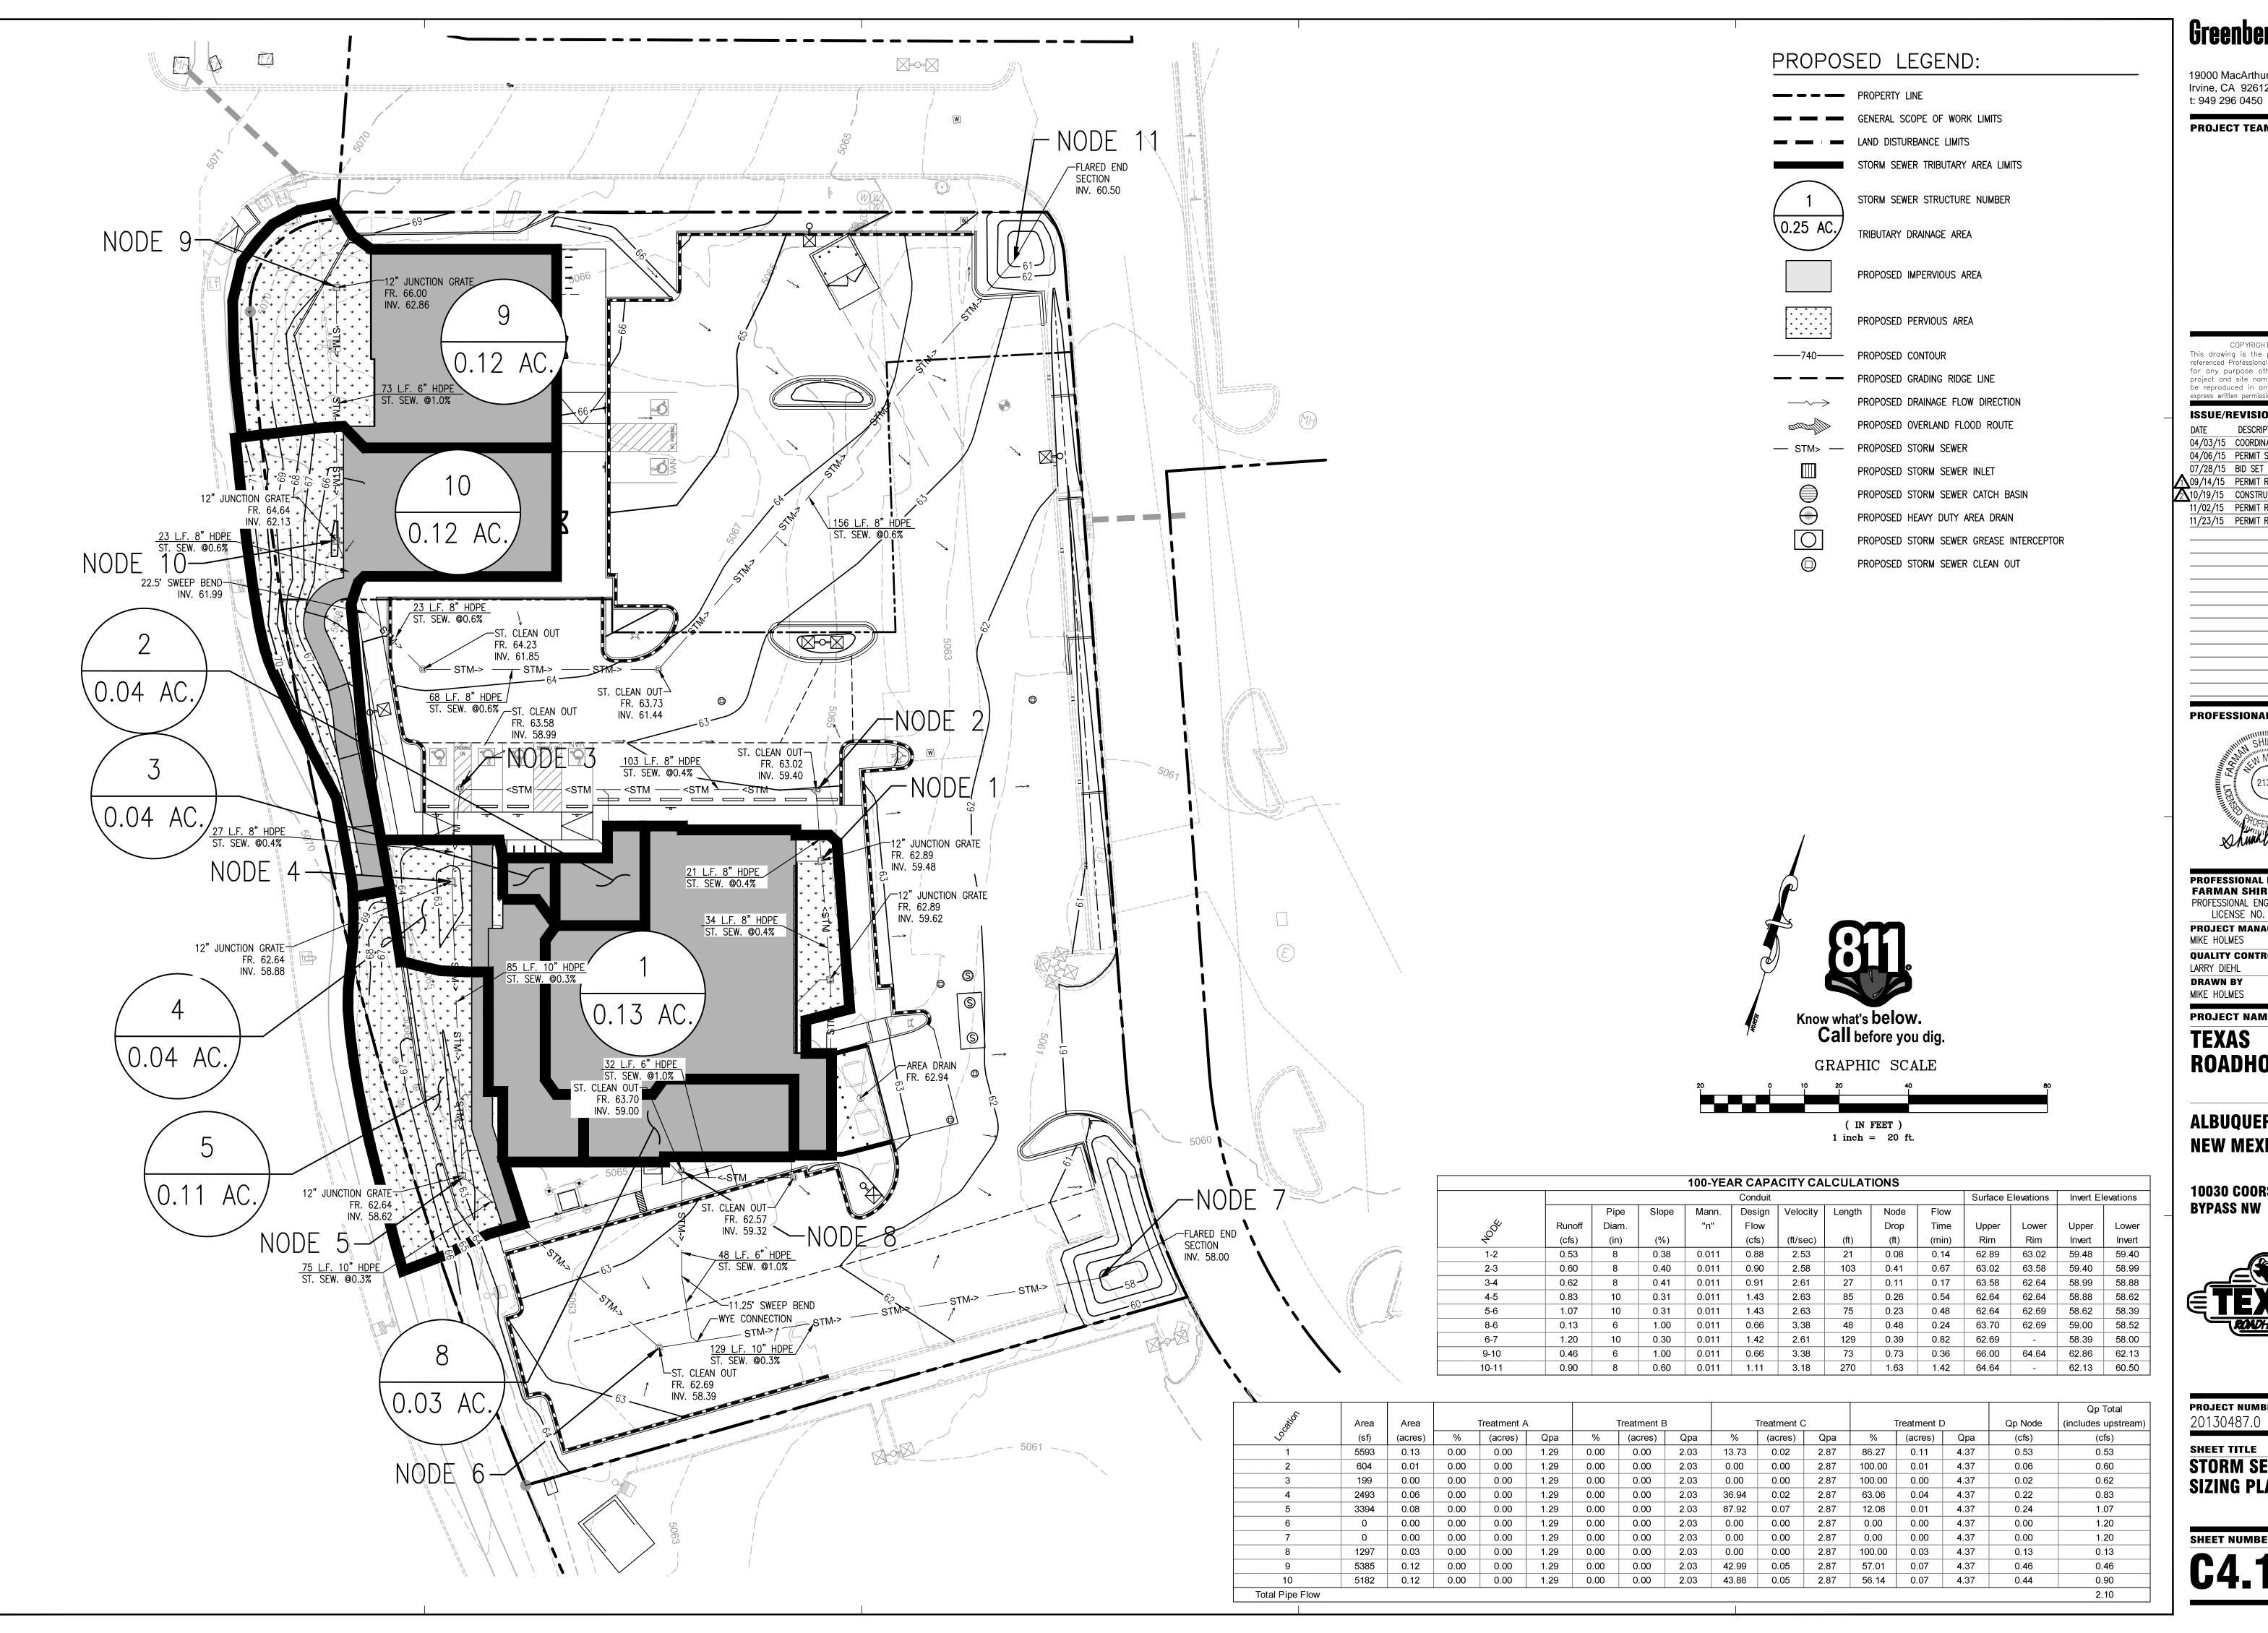

PROFESSIONAL IN CHARGE FARMAN SHIR, P.E.

PROFESSIONAL ENGINEER LICENSE NO. 21307 PROJECT MANAGER MIKE HOLMES

QUALITY CONTROL LARRY DIEHL **DRAWN BY** MIKE HOLMES

PROJECT NAME

TEXAS ROADHOUSE


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SHEET TITLE STORM SEWER **SIZING PLAN**



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PROFESSIONAL SEAL



PROFESSIONAL IN CHARGE FARMAN SHIR, P.E. PROFESSIONAL ENGINEER

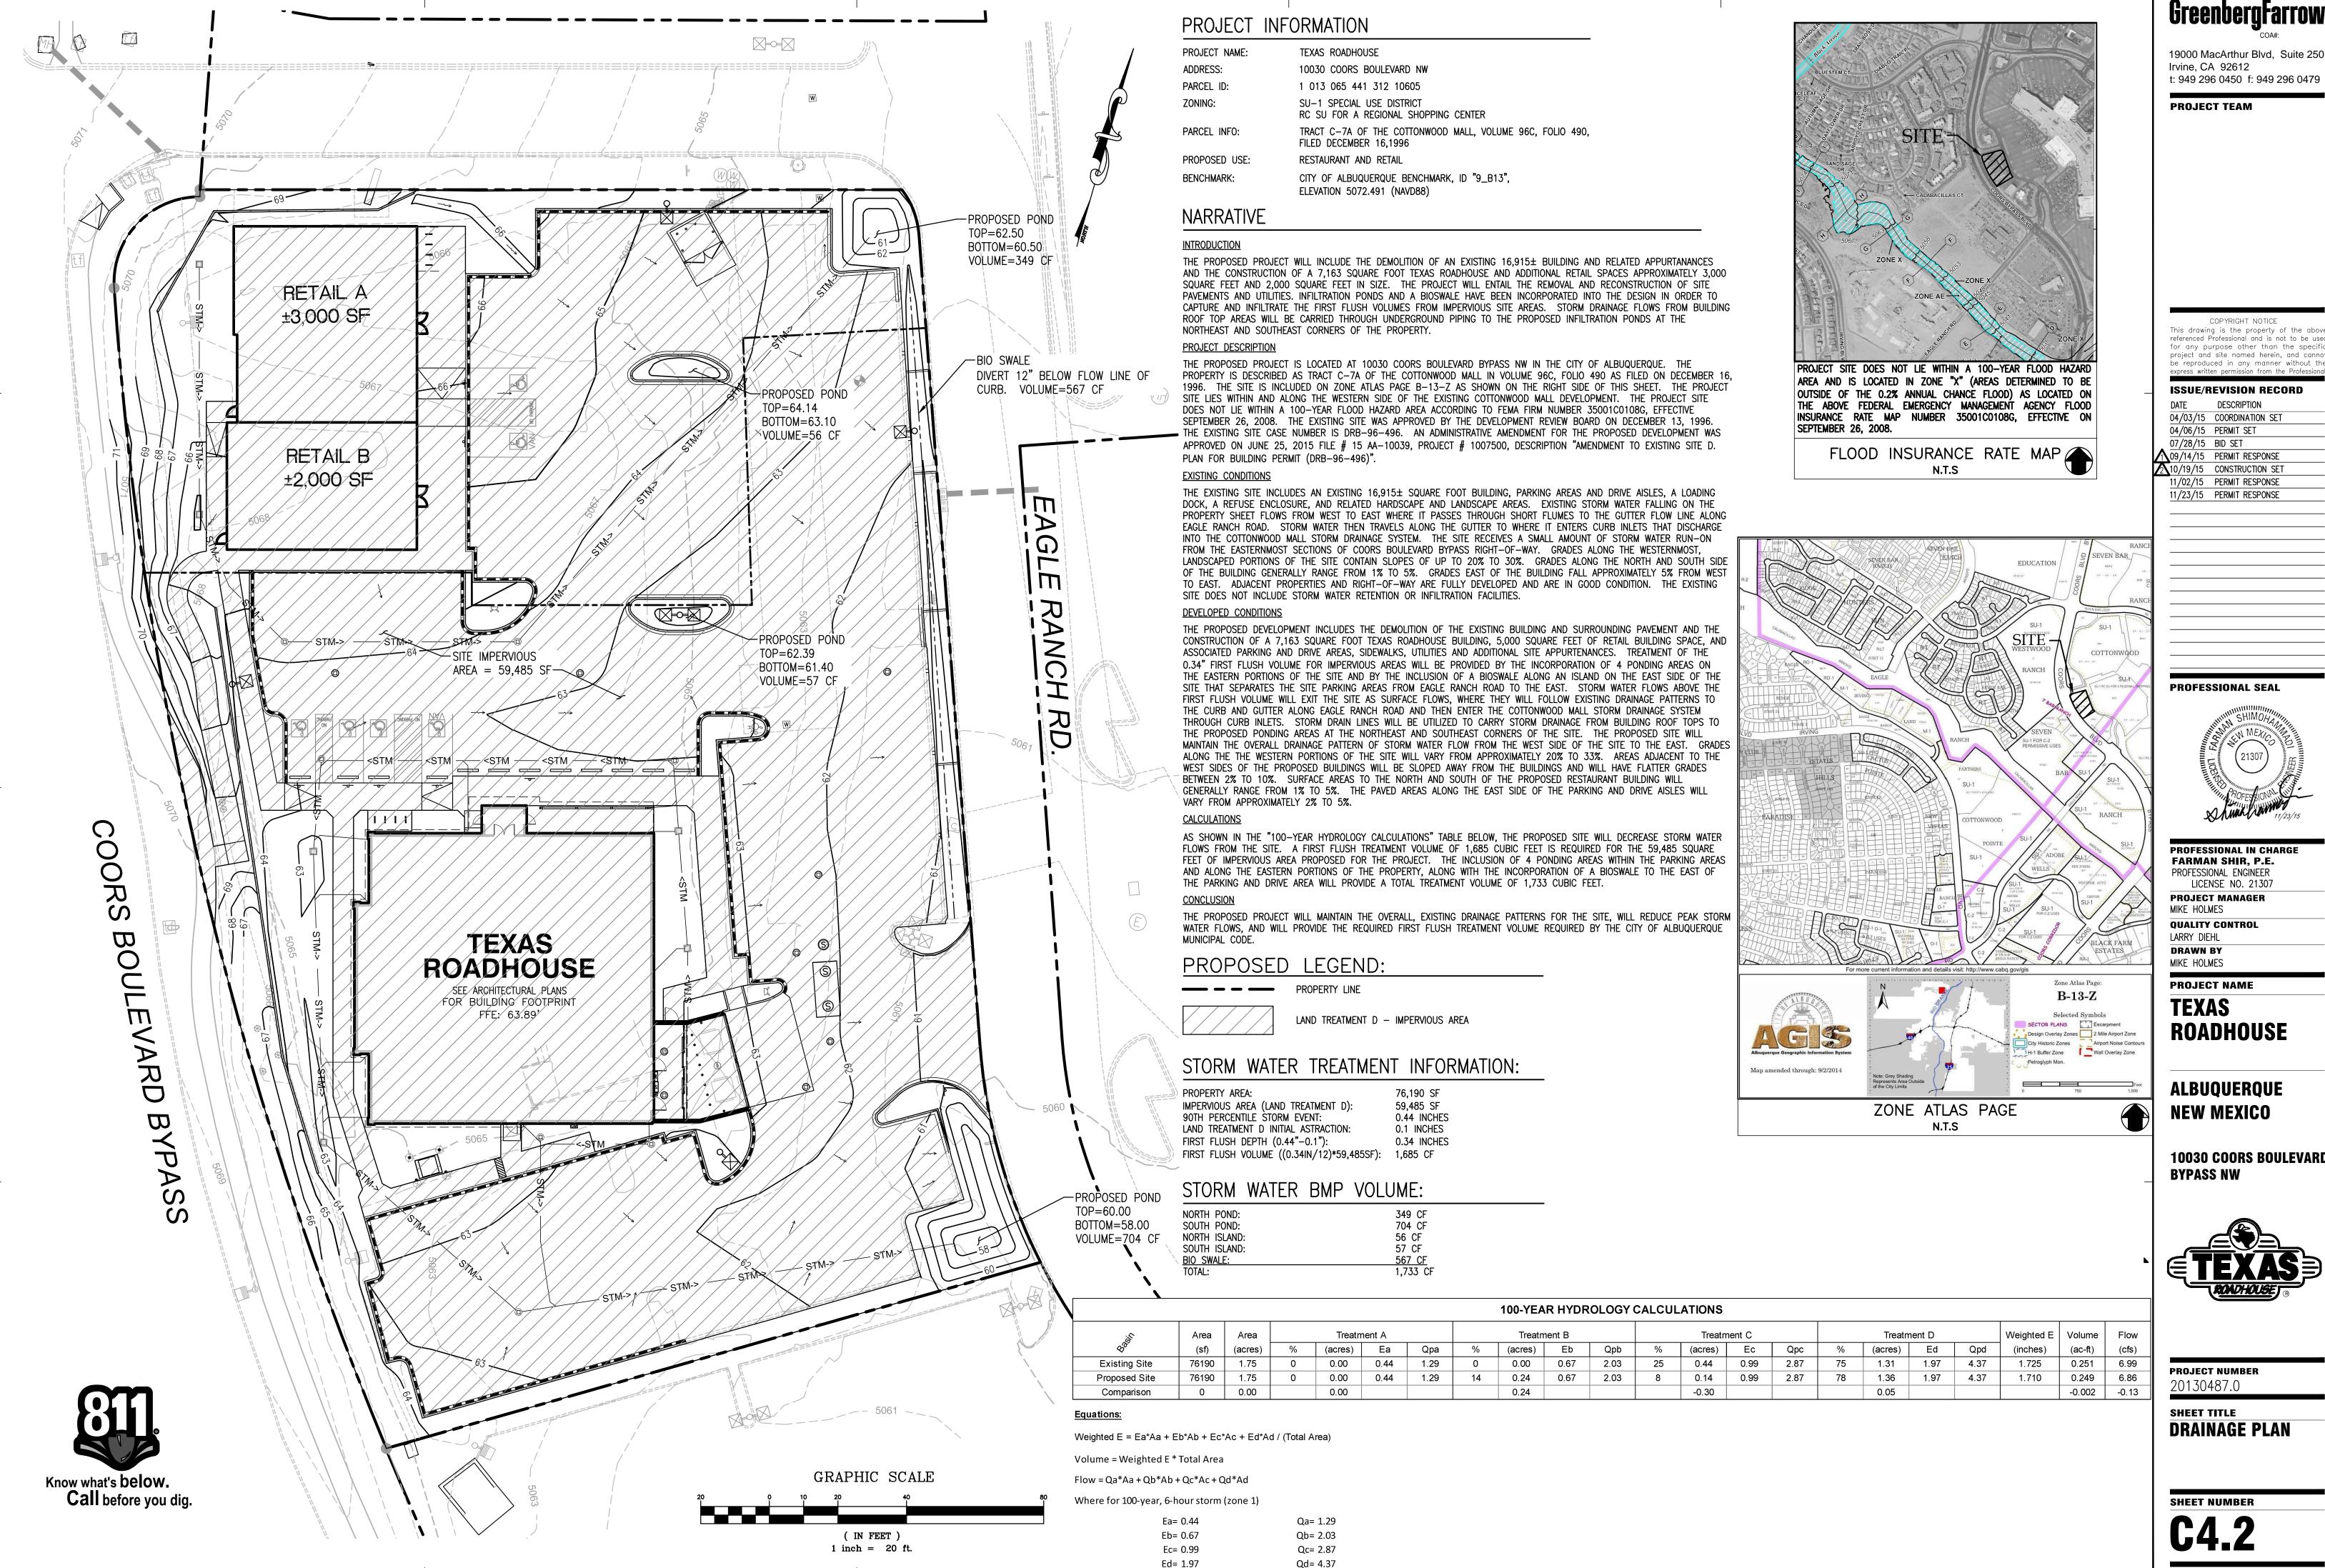LICENSE NO. 21307 PROJECT MANAGER MIKE HOLMES **QUALITY CONTROL** LARRY DIEHL

DRAWN BY MIKE HOLMES **PROJECT NAME**

TEXAS ROADHOUSE


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SHEET TITLE DRAINAGE PLAN



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PROFESSIONAL SEAL



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PROFESSIONAL ENGINEER
LICENSE NO. 21307
PROJECT MANAGER

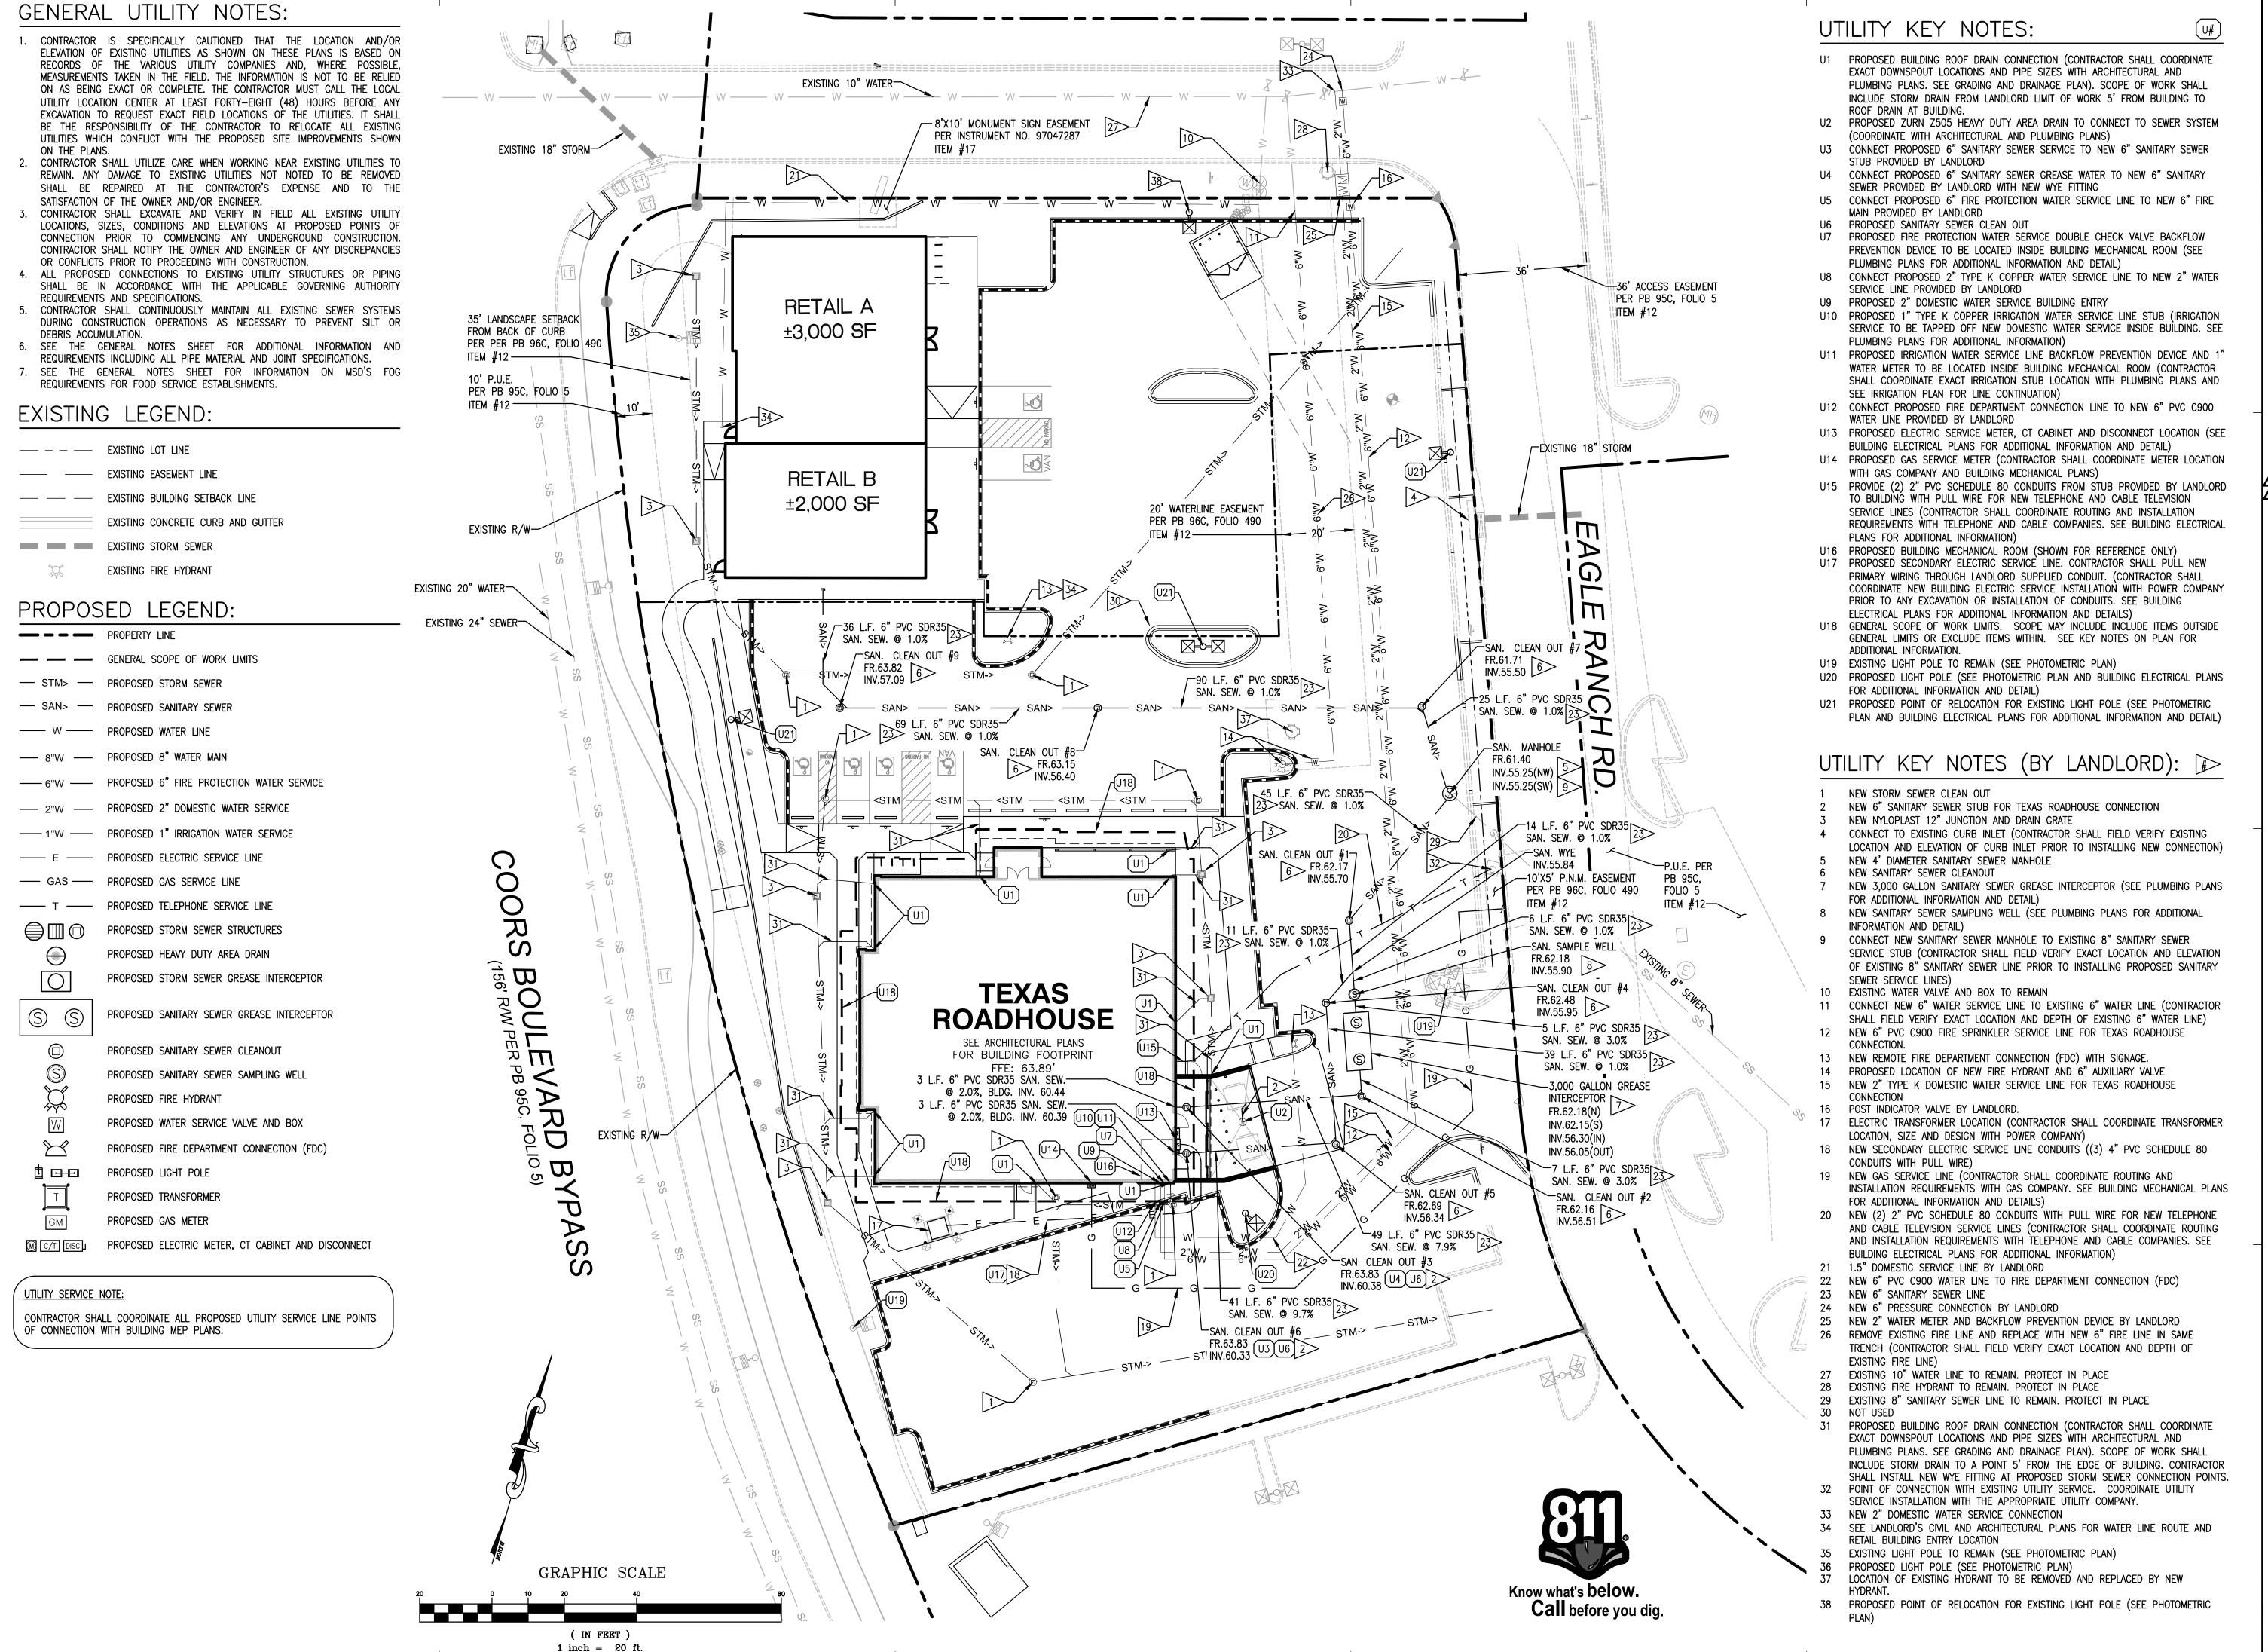MIKE HOLMES

QUALITY CONTROL

LARRY DIEHL

DRAWN BY MIKE HOLMES

PROJECT NAME
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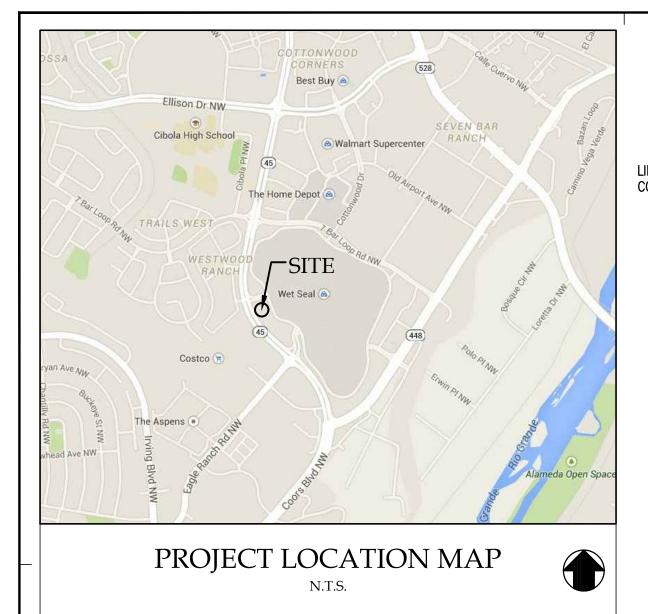
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SHEET TITLE UTILITY

PLAN



GENERAL SWPPP NOTES:

COPIES OF THE APPROVED STORM WATER POLLUTION PREVENTION PLANS SHALL BE MAINTAINED ON THE SITE AT ALL TIMES ALONG WITH ANY NECESSARY PERMITS AND INSPECTION FORMS. ALL CONSTRUCTION ACTIVITIES SHALL BE IN COMPLIANCE WITH THE PROJECT SWPPP

ALL EROSION AND SEDIMENTATION CONTROL MEASURES AND DEVICES SHALL BE INSTALLED AND FUNCTIONAL BEFORE THE SITE IS OTHERWISE DISTURBED. THEY SHALL BE KEPT OPERATIONAL AND MAINTAINED CONTINUOUSLY THROUGHOUT THE PERIOD OF LAND DISTURBANCE UNTIL PERMANENT SITE STABILIZATION HAS BEEN ACHIEVED

CONTRACTOR SHALL IMPLEMENT SITE SPECIFIC BEST MANAGEMENT PRACTICES (BMPS) AS SHOWN AND REQUIRED BY THE SWPPP. ADDITIONAL BEST MANAGEMENT PRACTICES SHALL BE IMPLEMENTED BY THE CONTRACTOR AS DICTATED BY SITE CONDITIONS OR THE PROJECT GOVERNING AUTHORITIES AT NO ADDITIONAL COST TO THE OWNER THROUGHOUT ALL PHASES OF CONSTRUCTION.

4. ALL BEST MANAGEMENT PRACTICES AND CONTROLS SHALL CONFORM TO THE APPLICABLE FEDERAL, STATE, OR LOCAL REQUIREMENTS, STANDARDS, AND SPECIFICATIONS OR MANUAL OF

IF AFTER REPEATED FAILURE ON THE PART OF THE CONTRACTOR TO PROPERLY CONTROL SOIL EROSION, SEDIMENT AND/OR POLLUTION FROM THE PROJECT SITE, THE GOVERNING AUTHORITIES RESERVE THE RIGHT TO EFFECT NECESSARY CORRECTIVE MEASURES AND CHARGE ANY COSTS TO

INLET PROTECTION SHALL BE INSTALLED AROUND EACH INLET OR CATCH BASIN WITHIN THE VICINITY OF THE DISTURBED AREA LIMITS AS SHOWN ON THE PLANS. THESE SHALL BE MAINTAINED UNTIL THE TRIBUTARY DRAINAGE AREAS HAVE ADEQUATE GRASS COVER AND/OR APPROPRIATE GROUND STABILIZATION.

ALL STREETS ADJACENT TO THE PROJECT SITE SHALL BE KEPT FREE OF DIRT, MUD AND DEBRIS. CONTRACTOR SHALL CLEAN ADJACENT PAVEMENTS AT THE END OF EACH WORKING DAY WHEN NECESSARY. ANY FUGITIVE DIRT/DEBRIS ON ADJACENT PAVEMENTS SHALL BE REMOVED AT THE

CONTRACTORS SHALL MINIMIZE BARE EARTH SURFACES DURING CONSTRUCTION TO THE EXTENT

ALL DISTURBED AREAS SHALL BE SEEDED OR SODDED AS SOON AS IS PRACTICABLE 10. IF DURING CONSTRUCTION OPERATIONS ANY LOOSE MATERIALS ARE DEPOSITED IN THE FLOW LINE OF GUTTERS, DRAINAGE STRUCTURES, OR DITCHES SUCH THAT THE NATURAL FLOW LINE OF

WATER IS OBSTRUCTED. THIS LOOSE MATERIAL SHALL BE REMOVED. 11. ALL SEDIMENT SHALL BE PREVENTED FROM ENTERING ANY EXISTING STORM DRAINAGE SYSTEMS BY THE USE OF INLET PROTECTION OR OTHER APPROVED FUNCTIONAL METHODS. THE CONTRACTOR SHALL BE RESPONSIBLE FOR REMOVING SEDIMENT RESULTING FROM CONSTRUCTION

ACTIVITIES ASSOCIATED WITH THIS PROJECT. 12. CONSTRUCTION ACCESS POINTS TO THE SITE SHALL BE PROTECTED IN SUCH A WAY AS TO PREVENT TRACKING OF MUD OR SOIL ONTO PUBLIC THOROUGHFARES. ALL SEDIMENT SPILLED. DROPPED. WASHED OR TRACKED ONTO PUBLIC RIGHTS-OF-WAY MUST BE REMOVED IMMEDIATELY BY THE CONTRACTOR

13. SUFFICIENT OIL AND GREASE ABSORBING MATERIALS AND FLOTATION BOOMS SHALL BE MAINTAINED ON SITE OR READILY AVAILABLE TO CONTAIN AND CLEAN-UP FUEL OR CHEMICAL SPILLS AND

14. DUST SHALL BE ADEQUATELY CONTROLLED ON THE PROJECT SITE AT ALL TIMES DURING CONSTRUCTION.

15. RUBBISH, TRASH, GARBAGE, LITTER, OR OTHER SUCH MATERIALS SHALL BE DEPOSITED INTO SEALED TRASH CONTAINERS. MATERIALS SHALL BE PREVENTED FROM LEAVING THE PREMISES THROUGH THE ACTION OF WIND OR STORMWATER DISCHARGE INTO DRAINAGE DITCHES OR WATERS OF THE STATE.

16. DURING DEWATERING OPERATIONS, WATER SHALL BE PUMPED OR OTHERWISE DISCHARGED FROM THE SITE INTO SEDIMENT BASINS, SILT TRAPS, DEWATERING BAGS OR POLYMER MIXING SWALES. DEWATERING DIRECTLY INTO FIELD TILES OR STORMWATER SYSTEMS IS PROHIBITED.

17. ALL DISTURBED AREAS SHALL BE SEEDED OR SODDED WITHIN THREE (3) DAYS OF FINAL DISTURBANCE.

18. ALL SOIL STOCKPILES SHALL BE STABILIZED WITHIN THREE (3) DAYS OF FORMING THE STOCKPILE. 19. STABILIZATION MEASURES SHALL BE INITIATED AS SOON AS PRACTICABLE IN PORTIONS OF THE SITE WHERE CONSTRUCTION ACTIVITIES HAVE TEMPORARILY OR PERMANENTLY CEASED, BUT IN NO CASE MORE THAN SEVEN (7) DAYS AFTER THE CONSTRUCTION ACTIVITY IN THAT PORTION OF THE SITE HAS TEMPORARILY OR PERMANENTLY CEASED AS FOLLOWS:

19.1. WHEN THE INITIATION OF STABILIZATION MEASURES BY THE 7TH DAY AFTER CONSTRUCTION ACTIVITY TEMPORARILY OR PERMANENTLY CEASES IS PRECLUDED BY SNOW COVER, STABILIZATION MEASURES SHALL BE INITIATED AS SOON AS PRACTICABLE.

19.2. WHEN CONSTRUCTION ACTIVITY WILL RESUME ON A PORTION OF THE SITE WITHIN 14 DAYS FROM WHEN ACTIVITIES CEASED (I..E. THE TOTAL TIME PERIOD THAT CONSTRUCTION ACTIVITY IS TEMPORARILY CEASED IS LESS THAN 14 DAYS). THEN STABILIZATION MEASURES DO NOT HAVE TO BE INITIATED ON THAT PORTION OF THE SITE BY THE 7TH DAY AFTER CONSTRUCTION ACTIVITY TEMPORARILY CEASES.

20. PRE-QUALIFIED PERSONNEL (PROVIDED BY THE CONTRACTOR) SHALL INSPECT DISTURBED AREAS OF THE CONSTRUCTION SITE THAT HAVE NOT BEEN FINALLY STABILIZED, STRUCTURAL CONTROL MEASURES, AND LOCATIONS WHERE VEHICLES ENTER OR EXIT THE SITE AT LEAST ONCE EVERY SEVEN (7) CALENDAR DAYS AND WITHIN TWENTY-FOUR (24) HOURS OF THE END OF A RAINFALL EVENT THAT IS 0.5 INCH OR GREATER (OR EQUIVALENT SNOWFALL). REQUIRED REPAIRS SHOULD BE COMPLETED WITHIN FORTY-EIGHT (48) HOURS OF THE INSPECTION.


21. EROSION CONTROL BLANKETS SHALL BE USED IN AREAS OF 4:1 SLOPE OR STEEPER. 22. ALL TEMPORARY EROSION CONTROL AND SEDIMENT CONTROL MEASURES SHALL BE REMOVED THIRTY (30) DAYS AFTER FINAL SITE STABILIZATION IS ACHIEVED OR AFTER THE TEMPORARY MEASURES ARE NO LONGER NEEDED. TRAPPED SEDIMENT SHALL BE PROPERLY STABILIZED OR

DISPOSED OF OFF SITE BY THE CONTRACTOR. 23. PRIOR TO COMMENCING LAND DISTURBING ACTIVITIES IN AREAS OTHER THAN THOSE INDICATED ON THESE PLANS (INCLUDING BUT NOT LIMITED TO ADDITIONAL PHASES OF DEVELOPMENT AND OFF-SITE BORROW OR WASTE AREAS) A SUPPLEMENTARY STORM WATER POLLUTION PREVENTION

PLAN SHALL BE SUBMITTED TO THE OWNER AND ENGINEER FOR REVIEW. 24. ALL DIRT AND DEBRIS ORIGINATING FROM CONSTRUCTION ACTIVITIES SHALL REMAIN WITHIN THE LIMITS OF DISTURBANCE AS SHOWN ON THIS PLAN. DIRT AND DEBRIS DESIGNATED FOR EXPORT SHALL BE REMAIN WITHIN THE LIMITS OF DISTURBANCE EXCEPT FOR MATERIALS THAT ARE ACTIVELY BEING EXPORTED.

25. ALL GOOD HOUSEKEEPING MEASURES LISTED IN THE PROJECT SWPPP SHALL BE MAINTAINED THROUGHOUT CONSTRUCTION ACTIVITIES AND UNTIL FINAL STABILIZATION OF THE SITE HAS

26. REFER TO THE PROJECT LANDSCAPE PLANS FOR IMPERVIOUS AREA SURFACE TREATMENT FOR FINAL SITE STABILIZATION. REMOVAL OF TEMPORARY SITE EROSION AND SEDIMENT CONTROL MEASURES SHALL NOT OCCUR UNTIL FINAL SITE STABILIZATION

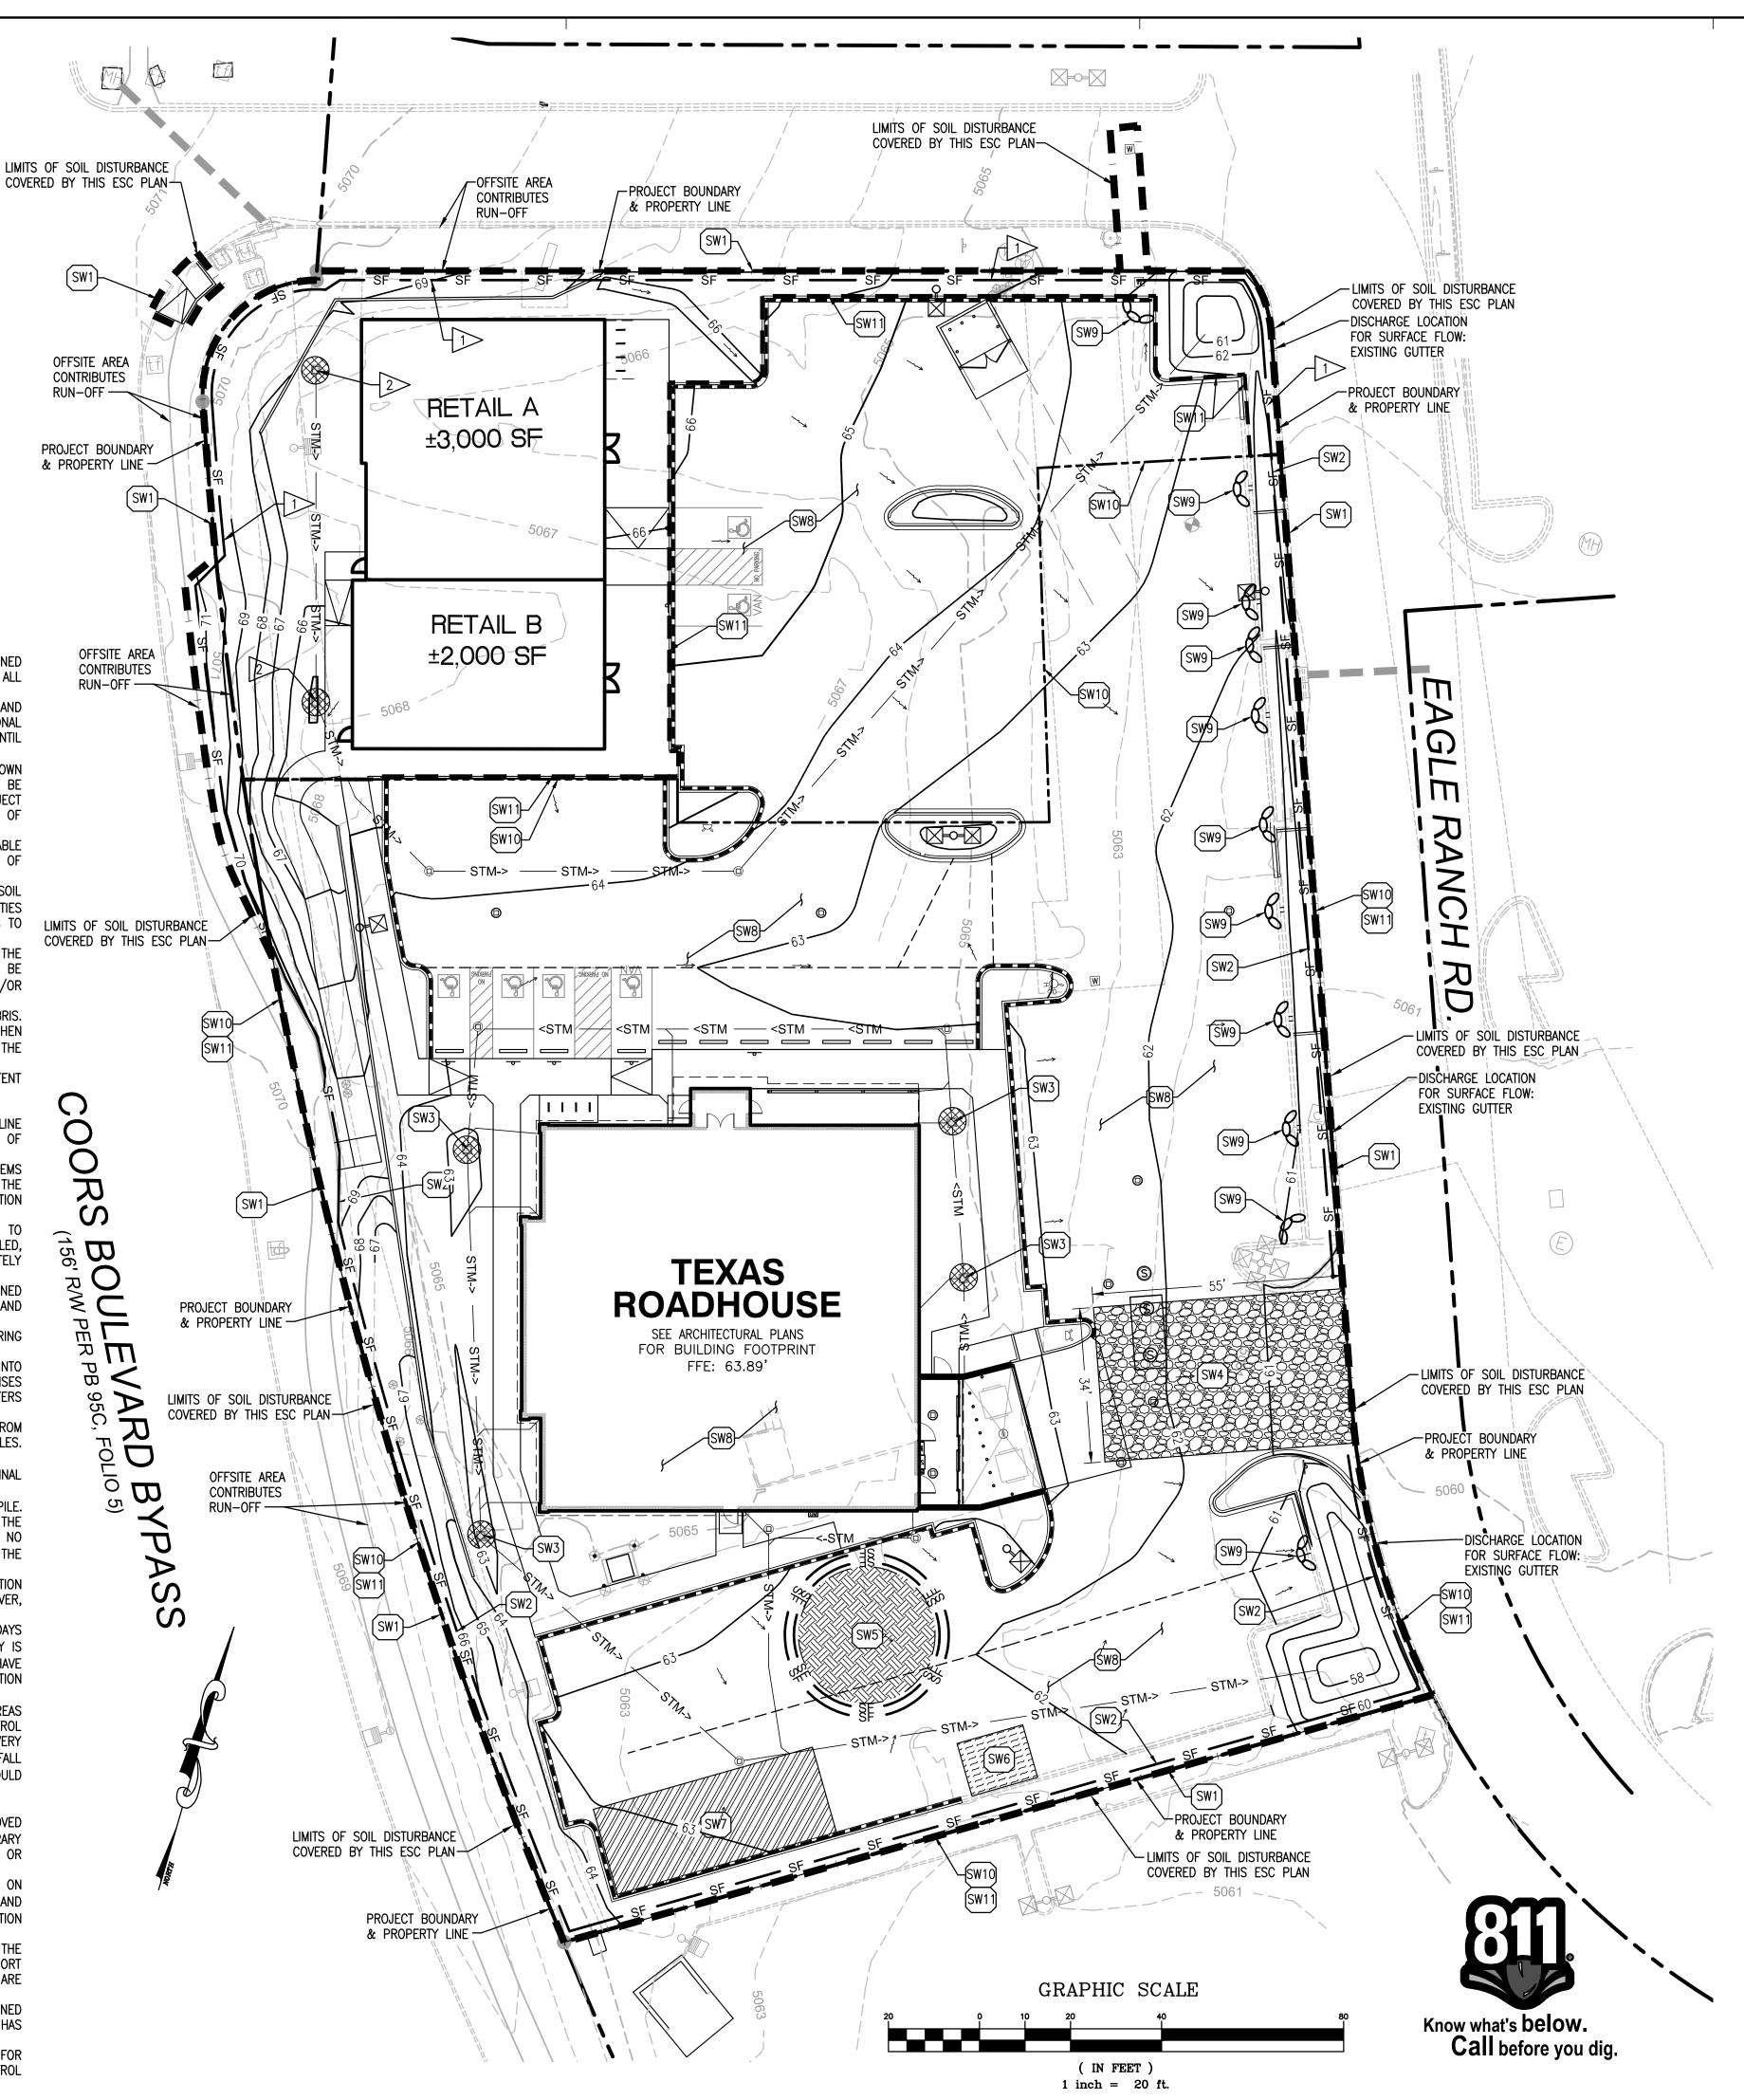

EXISTING LEGEND:

---- Existing Lot line

EXISTING STORM SEWER

PROPOSED LEGEND:

SW4

ESW6

— PROPOSED CONTOUR

EXISTING EASEMENT LINE

EXISTING FIRE HYDRANT

PROPOSED SILT FENCE

EXISTING BUILDING SETBACK LINE

GENERAL SCOPE OF WORK LIMITS

PROPOSED GRAVEL BAG BARRIER

PROPOSED GRADING RIDGE LINE

PROPOSED DRAINAGE FLOW DIRECTION

PROPOSED OVERLAND FLOOD ROUTE

PROPOSED SANITARY SEWER STRUCTURES

SW5 PROPOSED TEMPORARY TOPSOIL STOCKPILE WITH DOUBLE SILT FENCE

SW7 PROPOSED CONTRACTOR STAGING AREA INCLUDING BUILDING MATERIALS

SW11 GENERAL SCOPE OF WORK LIMITS. SCOPE MAY INCLUDE ITEMS OUTSIDE

SW6 PROPOSED CONCRETE WASHOUT WITH MINIMUM 30-MIL POLYETHYLENE LINING

STORAGE, COVERED TRASH DUMPSTER, AND PORTABLE TOILET FACILITIES

GENERAL LIMITS OR EXCLUDE ITEMS WITHIN. SEE KEY NOTES ON PLAN FOR

SOIL TYPE: (BCC) BLUEPOINT LOAMY FINE SAND, 1 TO 9 PERCENT SLOPES

SWPPP MAINTENANCE & SCHEDULE:

OBTAIN ALL APPLICABLE SITE PERMITS AND THOROUGHLY REVIEW PROJECT'S

STORMWATER POLLUTION PREVENTION PLAN (SWPPP) PRIOR TO COMMENCEMENT

OF CONSTRUCTION OPERATIONS. CONTRACTOR SHALL BE RESPONSIBLE FOR

MAINTAINING AND UPDATING THE SWPPP THROUGHOUT THE DURATION OF

INSTALL PERIMETER SEDIMENT CONTROL MEASURES (I.E. SILT FENCE AND

INSTALL INLET PROTECTION DEVICES FOR EXISTING STORM SEWER INLETS AND

PERFORM STORMWATER POLLUTION PREVENTION SITE INSPECTIONS ON A

WEEKLY BASIS AND WITHIN TWENTY-FOUR (24) HOURS OF THE END OF A

RAINFALL EVENT THAT IS 0.5 INCH OR GREATER (OR EQUIVALENT SNOWFALL).

AT A MINIMUM, THE INSPECTIONS SHALL INCLUDE THE DISTURBED AREAS OF

THE CONSTRUCTION SITE THAT HAVE NOT BEEN FINALLY STABILIZED, ALL

STRUCTURAL CONTROL MEASURES, LOCATIONS WHERE VEHICLES ENTER OR EXIT

THE SITE, AND ANY ADDITIONAL BEST MANAGEMENT PRACTICES IDENTIFIED IN

MANAGEMENT PRACTICES SHALL BE THE RESPONSIBILITY OF THE GENERAL

CONTRACTOR AND SHALL BE CONTINUOUSLY MAINTAINED THROUGHOUT THE

DURATION OF CONSTRUCTION. CONTRACTOR SHALL MAKE AND COMPLETE

THE REQUIRED REPAIRS WITHIN FORTY-EIGHT (48) HOURS OF THE

CONTRACTOR IS RESPONSIBLE FOR INSTALLATION OF ANY ADDITIONAL

STRUCTURAL CONTROL MEASURES NECESSARY TO PREVENT EROSION AND

4.1. ALL SITE EROSION AND SEDIMENT CONTROL MEASURES AND BEST

SEDIMENTATION AS DETERMINED BY THE SITE INSPECTIONS.

5. INSTALL NEW STORM SEWERS AND OTHER SITE UTILITIES AS INDICATED ON THE

6. PROVIDE TEMPORARY SEEDING AND/OR MULCHING FOR ALL DISTURBED SITE

8. INSTALL CURBS AND BEGIN SITE PAVING OPERATIONS (I.E. DRIVEWAYS,

10. INSTALL BUILDING FOUNDATION AND COMPLETE BUILDING CONSTRUCTION AND

11. REMOVE ALL TEMPORARY SITE EROSION AND SEDIMENT CONTROL MEASURES

PRACTICES AS NEEDED FOR AREAS ADJACENT TO THE PROJECT SITE.

WITHIN THIRTY (30) DAYS OF FINAL SITE STABILIZATION.

AREAS THAT WILL NOT BE WORKED ON FOR MORE THAN FOURTEEN (14) DAYS.

INSTALL TEMPORARY CONCRETE WASHOUT FACILITY PRIOR TO COMMENCEMENT

PERFORM STREET CLEANING OPERATIONS AND OTHER BEST MANAGEMENT

CONSTRUCTION AS NECESSARY UNTIL FINAL SITE STABILIZATION IS ACHIEVED.

77.056 SQ. FT. / 1.77 ACRES

76,190 SQ. FT. / 1.75 ACRES

SW8 SOIL TYPE: (BCC) BLUEPOINT LOAMY FINE SAND, 1 TO 9 PERCENT SLOPES

PROPOSED SANITARY SEWER GREASE INTERCEPTOR

— PROPOSED STORM SEWER

PROPOSED STORM SEWER STRUCTURES

SWPPP KEY NOTES:

SW2 PROPOSED SILT FENCE

MLRA 42

SW9 GRAVEL BAG BARRIEF

SW10 LIMITS OF PREMISES

SW3 PROPOSED INLET PROTECTION

AND LOCATION SIGNAGE

ADDITIONAL INFORMATION.

(BY LANDLORD):

PROPOSED SILT FENCE

TOTAL DISTURBED AREA:

TOTAL SITE AREA:

PROPOSED INLET PROTECTION

PROJECT INFORMATION:

STABILIZED CONSTRUCTION ENTRANCE).

DRAINAGE STRUCTURES.

THE SWPPP.

INSPECTION.

SIDEWALKS, ETC.)

OF ANY CONCRETE WORK ON SITE.

REMAINING SITE IMPROVEMENTS.

SWPPP KEY NOTES

SW1 PROPOSED PROJECT LAND DISTURBANCE LIMITS

SW4 PROPOSED STABILIZED CONSTRUCTION ENTRANCE

PROPOSED STONE BAG INLET PROTECTION

PROPOSED STABILIZED CONSTRUCTION ENTRANCE

PROPOSED CONCRETE WASHOUT (SUGGESTED LOCATION)

LAND DISTURBANCE LIMITS (SEE DISTURBED SITE AREA TABLE)

PROPOSED TEMPORARY TOPSOIL STOCKPILE (SUGGESTED LOCATION)

PROPOSED CONTRACTOR STAGING AREA (SUGGESTED LOCATION)

EXISTING CONCRETE CURB AND GUTTER

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PROJECT TEAM

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ISSUE/REVISION RECORI

DESCRIPTION 04/03/15 COORDINATION SET 04/06/15 PERMIT SET

07/28/15 BID SET 1 09/14/15 PERMIT RESPONSE 10/19/15 CONSTRUCTION SET

11/02/15 PERMIT RESPONSE 11/23/15 PERMIT RESPONS

SW#



PROFESSIONAL IN CHARGE FARMAN SHIR, P.E.

PROFESSIONAL ENGINEER LICENSE NO. 21307

PROJECT MANAGER MIKE HOLMES **QUALITY CONTROL**

LARRY DIEHL **DRAWN BY** MIKE HOLMES

PROJECT NAME

TEXAS ROADHOUSE


ALBUQUERQUE NEW MEXICO


10030 COORS BOULEVARD BYPASS NW



PROJECT NUMBER 20130487.0

SHEET TITLE **STORMWATER POLLUTION** PREVENTION PLAN

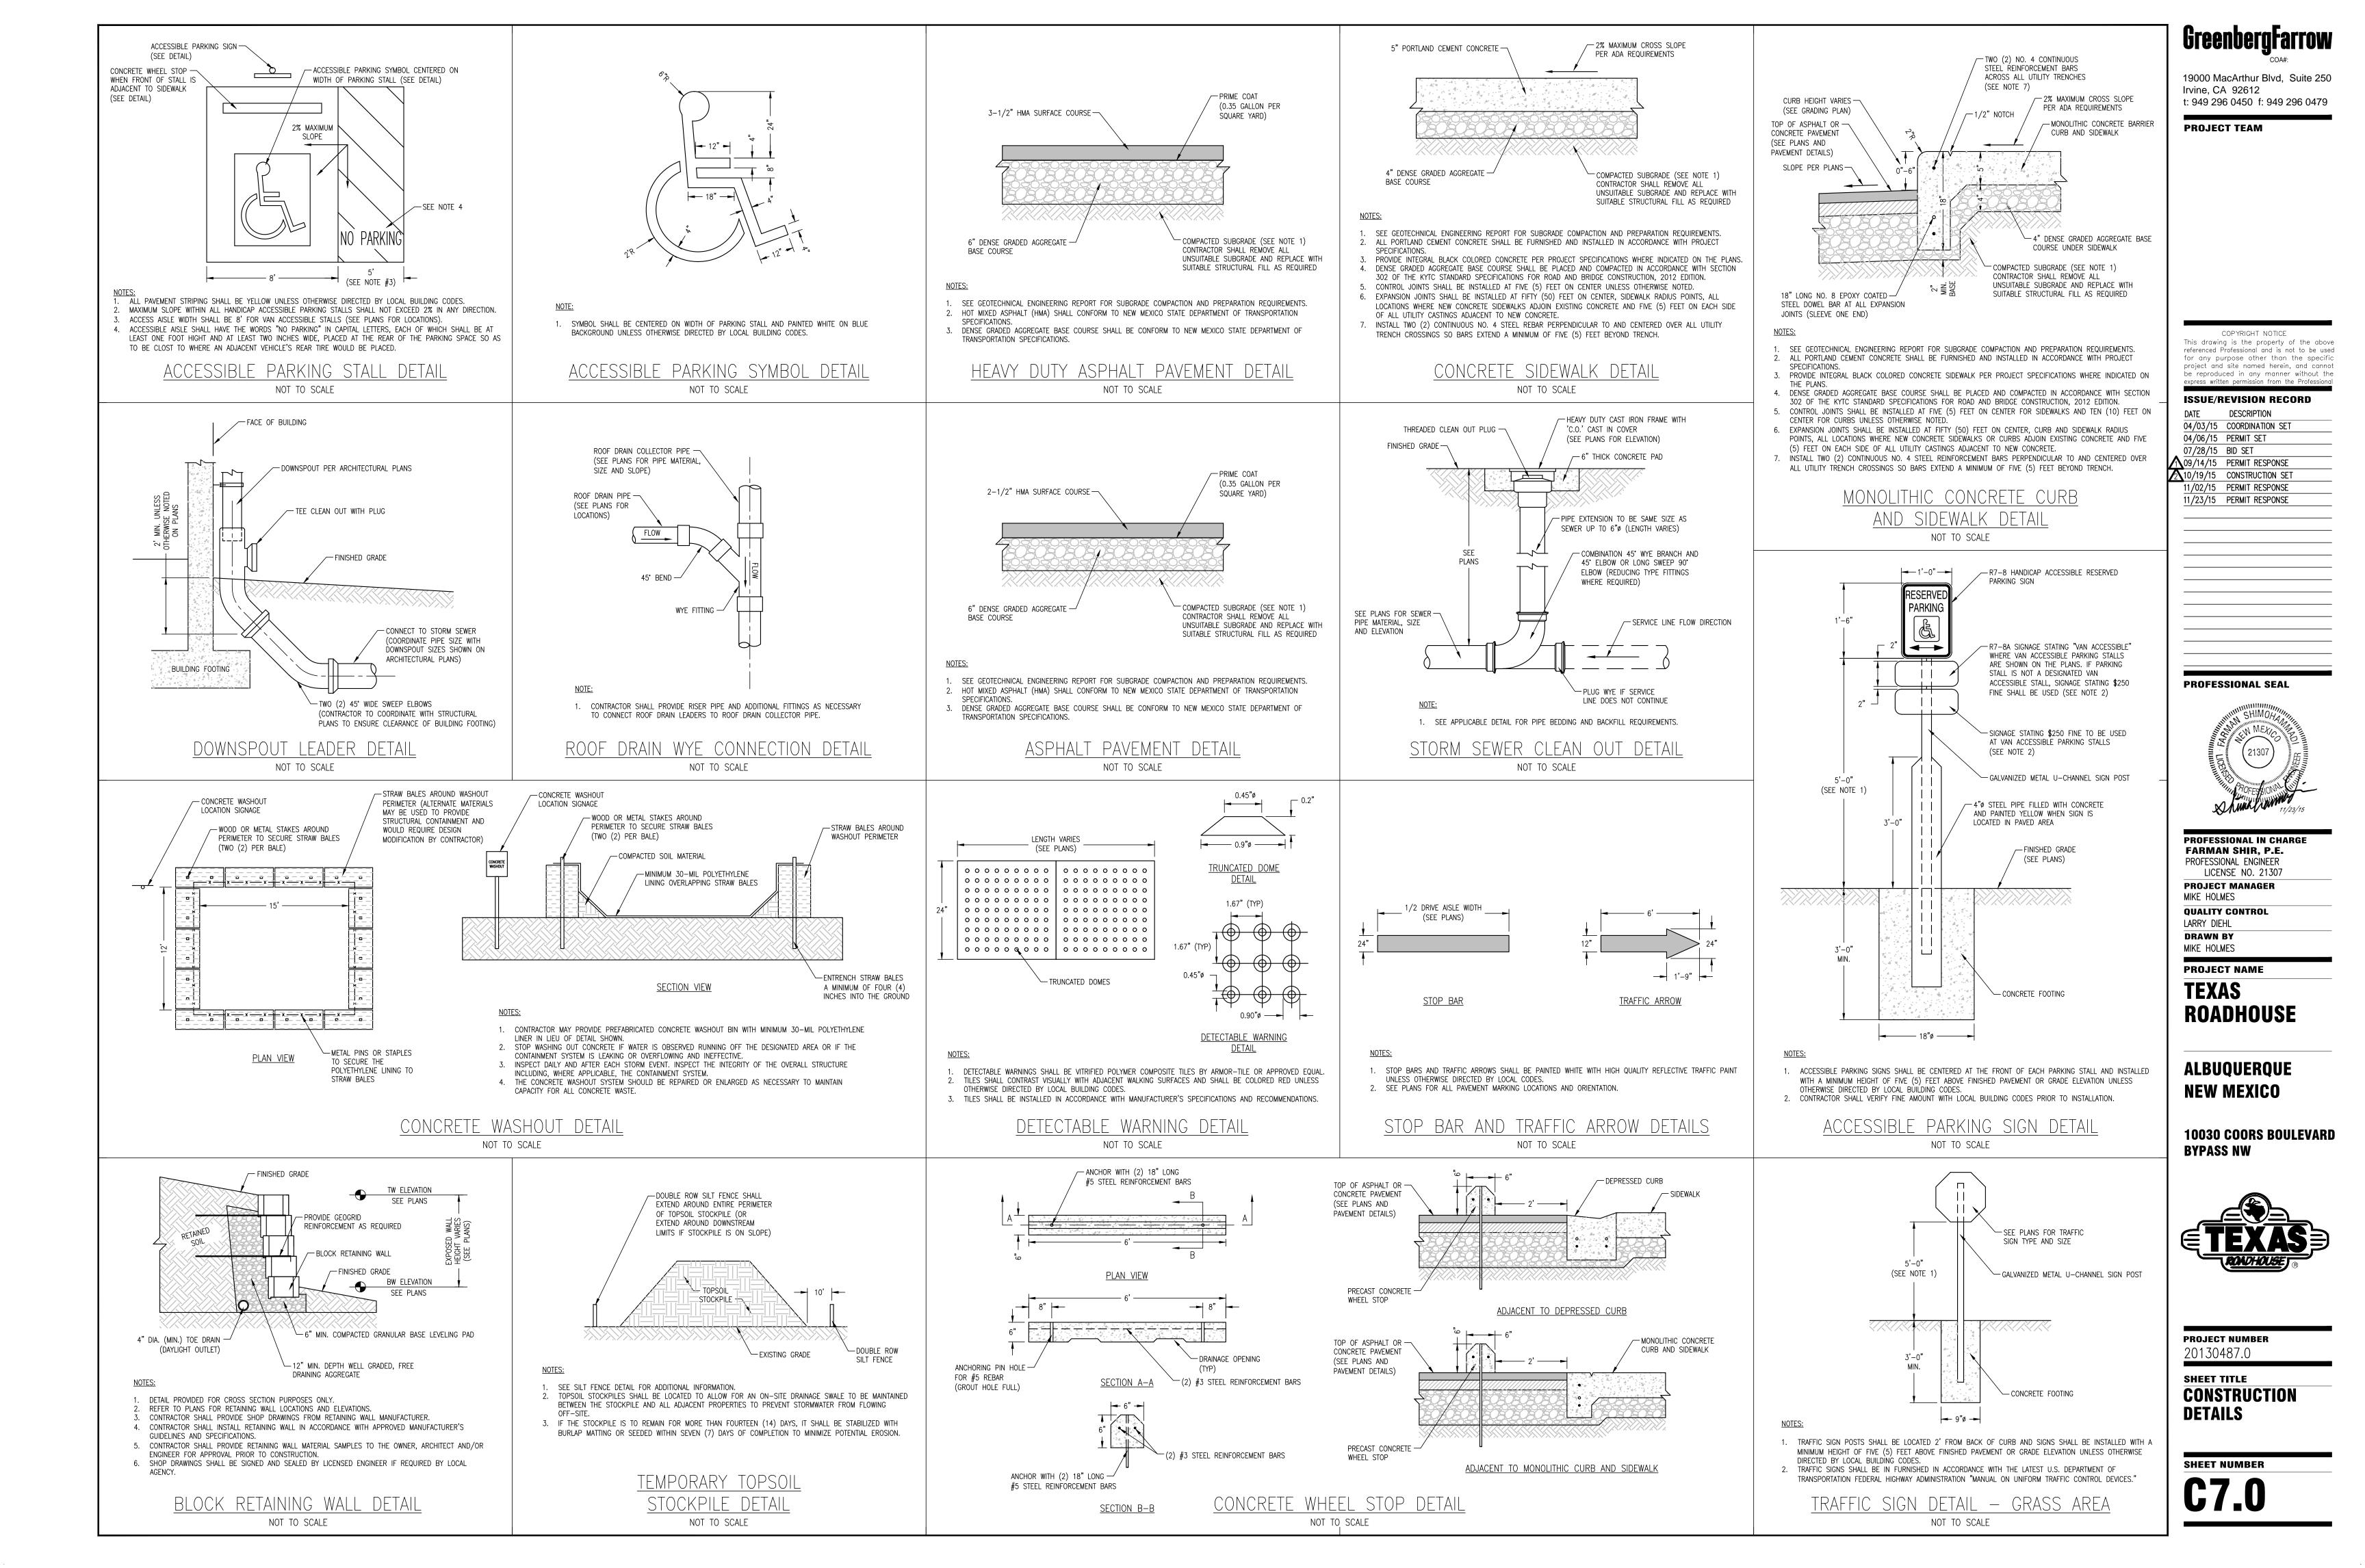

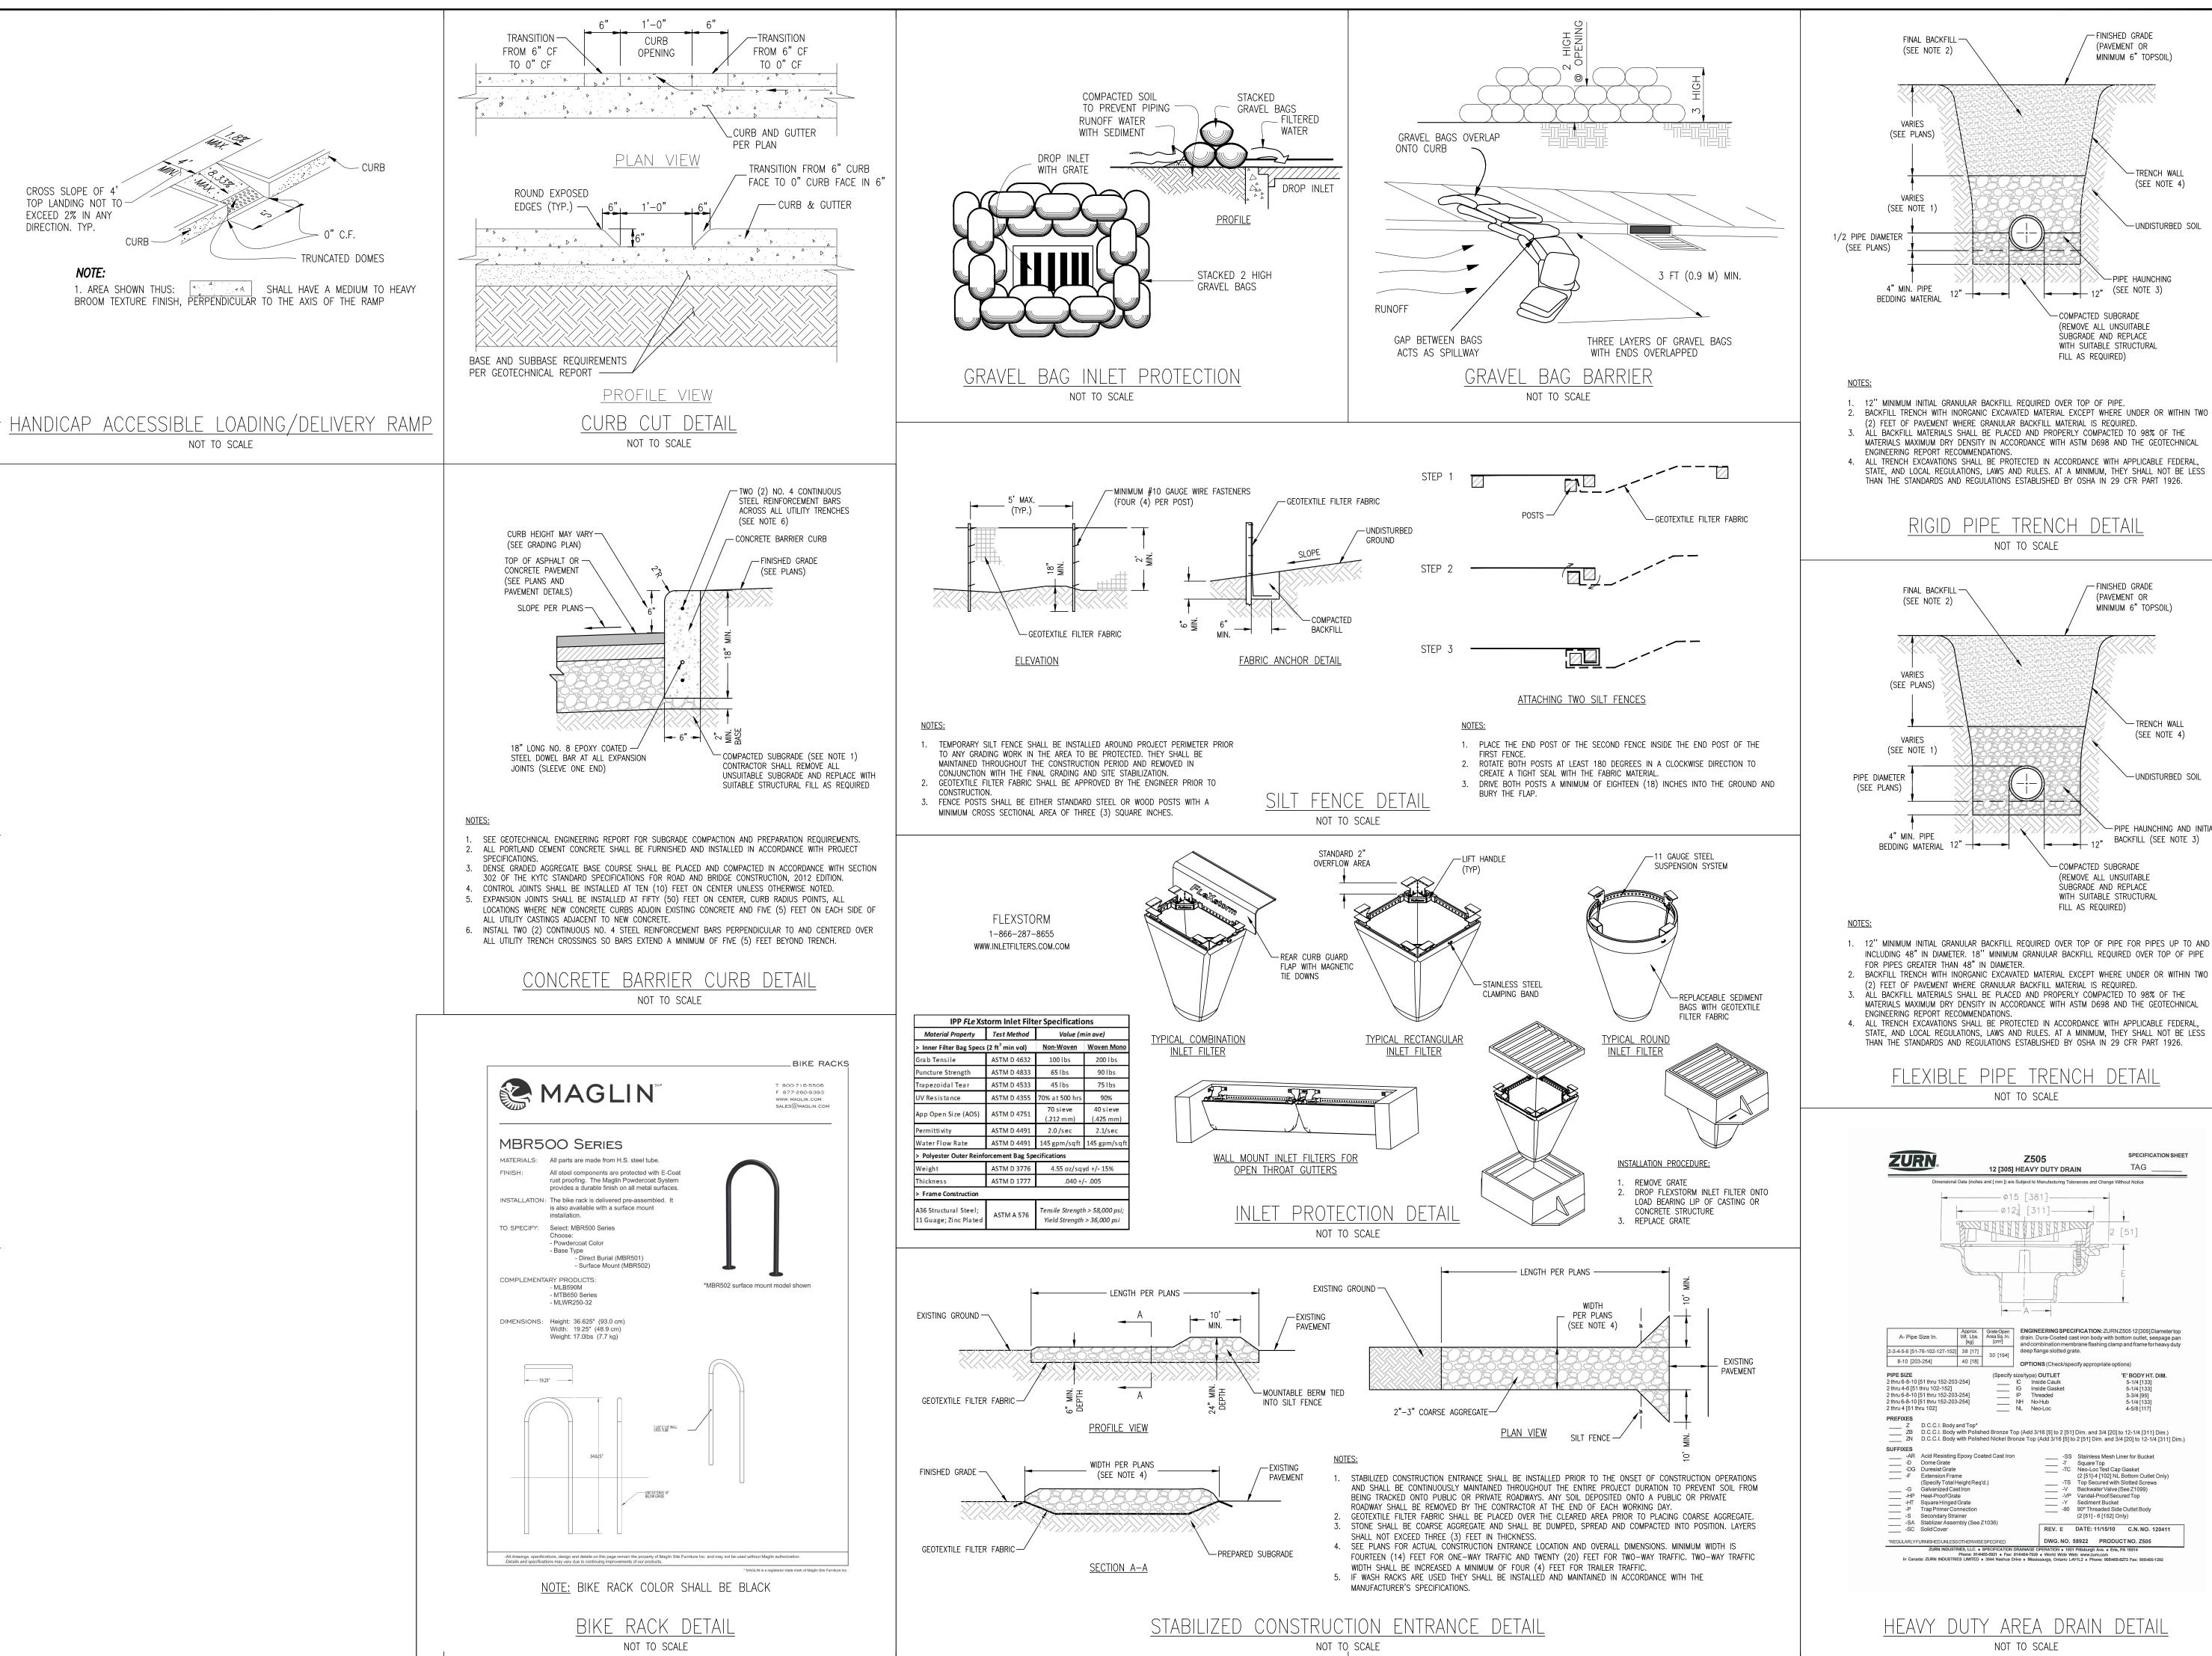

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PROJECT TEAM

— FINISHED GRADE

(PAVEMENT OR

MINIMUM 6" TOPSOIL)

-TRENCH WALL

(SEE NOTE 4)

-UNDISTURBED SOIL

—PIPE HAUNCHING

12" (SEE NOTE 3)

-COMPACTED SUBGRADE (REMOVE ALL UNSUITABLE SUBGRADE AND REPLACE

FILL AS REQUIRED)

WITH SUITABLE STRUCTURAL

-FINISHED GRADE

(PAVEMENT OR

MINIMUM 6" TOPSOIL)

-TRENCH WALL

(SEE NOTE 4)

-UNDISTURBED SOIL

— PIPE HAUNCHING AND INITIAL

BACKFILL (SEE NOTE 3)

-COMPACTED SUBGRADE

FILL AS REQUIRED)

(REMOVE ALL UNSUITABLE SUBGRADE AND REPLACE

WITH SUITABLE STRUCTURAL

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ISSUE/REVISION RECORD DESCRIPTION 04/03/15 COORDINATION SET 04/06/15 PERMIT SET

↑ 09/14/15 PERMIT RESPONSE 2 10/19/15 CONSTRUCTION SET 11/02/15 PERMIT RESPONSE 11/23/15 PERMIT RESPONSE

07/28/15 BID SET

PROFESSIONAL SEAL



PROFESSIONAL IN CHARGE FARMAN SHIR, P.E. PROFESSIONAL ENGINEER

LICENSE NO. 21307 PROJECT MANAGER MIKE HOLMES **QUALITY CONTROL** LARRY DIEHL

DRAWN BY

MIKE HOLMES

TEXAS


PROJECT NAME

ROADHOUSE

ALBUQUERQUE

MATERIALS MAXIMUM DRY DENSITY IN ACCORDANCE WITH ASTM D698 AND THE GEOTECHNICAL 4. ALL TRENCH EXCAVATIONS SHALL BE PROTECTED IN ACCORDANCE WITH APPLICABLE FEDERAL STATE, AND LOCAL REGULATIONS, LAWS AND RULES. AT A MINIMUM, THEY SHALL NOT BE LESS

FLEXIBLE PIPE TRENCH DETAIL NOT TO SCALE

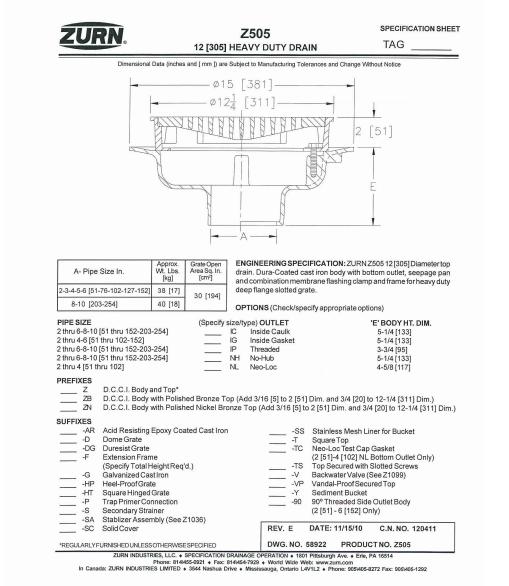

HEAVY DUTY AREA DRAIN DETAIL NOT TO SCALE


NEW MEXICO 10030 COORS BOULEVARD

BYPASS NW



PROJECT NUMBER 20130487.0

SHEET TITLE CONSTRUCTION **DETAILS**

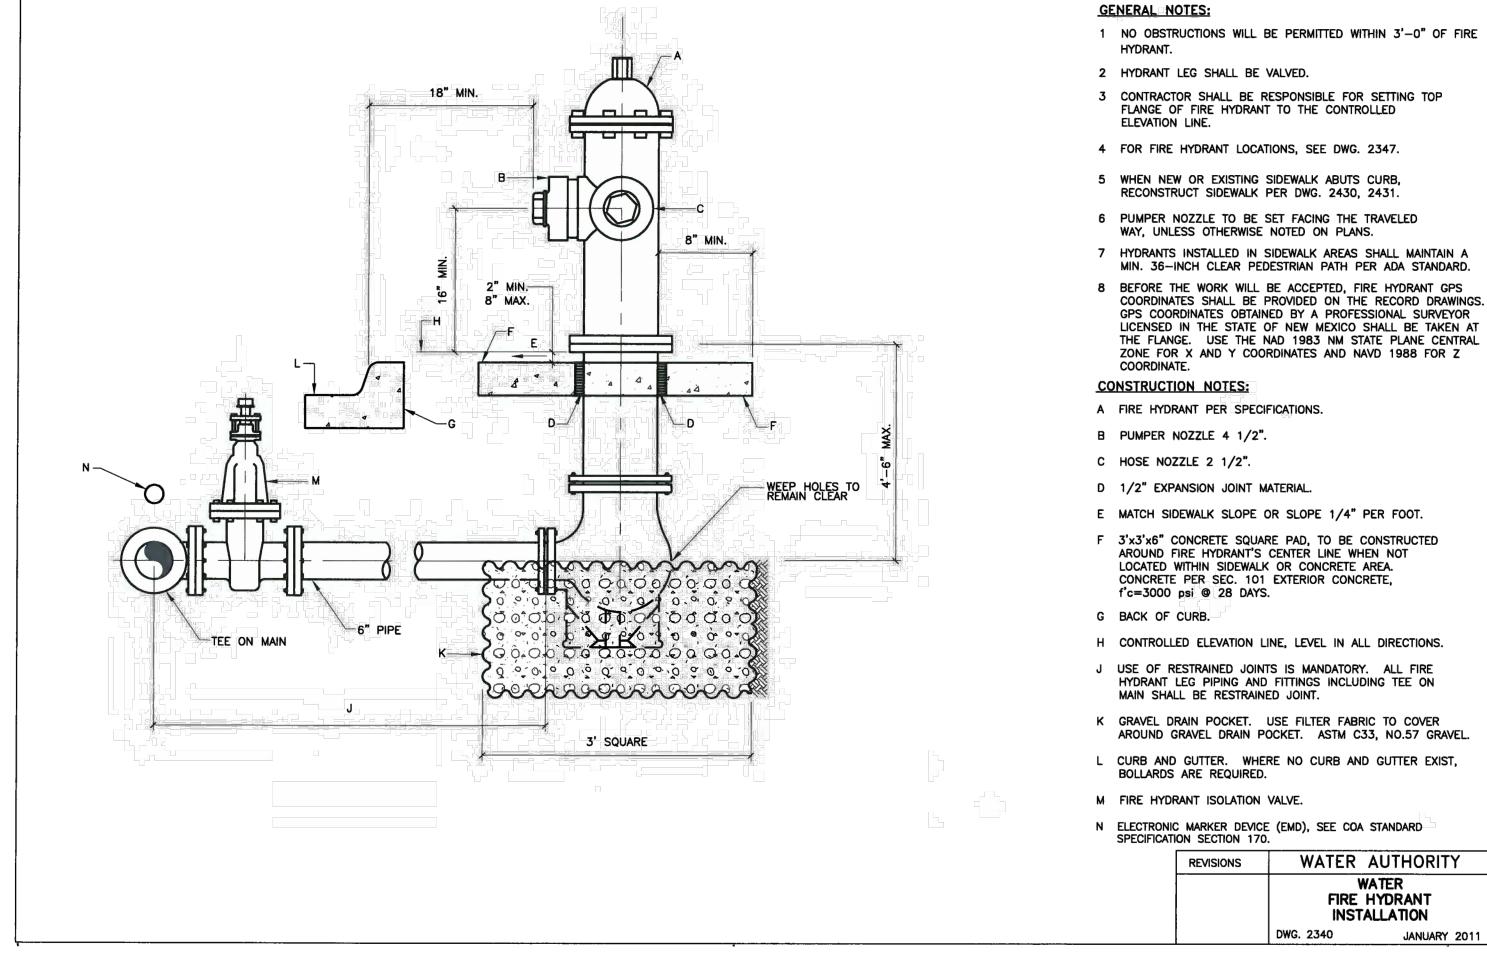


- 1 NO OBSTRUCTIONS WILL BE PERMITTED WITHIN 3'-0" OF FIRE
- 2 HYDRANT LEG SHALL BE VALVED.
- 3 CONTRACTOR SHALL BE RESPONSIBLE FOR SETTING TOP FLANGE OF FIRE HYDRANT TO THE CONTROLLED
- 4 FOR FIRE HYDRANT LOCATIONS, SEE DWG. 2347.
- 5 WHEN NEW OR EXISTING SIDEWALK ABUTS CURB, RECONSTRUCT SIDEWALK PER DWG. 2430, 2431.
- 6 PUMPER NOZZLE TO BE SET FACING THE TRAVELED
- WAY, UNLESS OTHERWISE NOTED ON PLANS.
- 8 BEFORE THE WORK WILL BE ACCEPTED, FIRE HYDRANT GPS COORDINATES SHALL BE PROVIDED ON THE RECORD DRAWINGS. GPS COORDINATES OBTAINED BY A PROFESSIONAL SURVEYOR LICENSED IN THE STATE OF NEW MEXICO SHALL BE TAKEN AT

- A FIRE HYDRANT PER SPECIFICATIONS.
- B PUMPER NOZZLE 4 1/2".
- D 1/2" EXPANSION JOINT MATERIAL.
- E MATCH SIDEWALK SLOPE OR SLOPE 1/4" PER FOOT.
- F 3'x3'x6" CONCRETE SQUARE PAD, TO BE CONSTRUCTED AROUND FIRE HYDRANT'S CENTER LINE WHEN NOT LOCATED WITHIN SIDEWALK OR CONCRETE AREA. CONCRETE PER SEC. 101 EXTERIOR CONCRETE, f'c=3000 psi @ 28 DAYS.
- H CONTROLLED ELEVATION LINE, LEVEL IN ALL DIRECTIONS.
- J USE OF RESTRAINED JOINTS IS MANDATORY. ALL FIRE HYDRANT LEG PIPING AND FITTINGS INCLUDING TEE ON MAIN SHALL BE RESTRAINED JOINT.
- K GRAVEL DRAIN POCKET. USE FILTER FABRIC TO COVER AROUND GRAVEL DRAIN POCKET. ASTM C33, NO.57 GRAVEL.
- L CURB AND GUTTER. WHERE NO CURB AND GUTTER EXIST,
- M FIRE HYDRANT ISOLATION VALVE.
- N ELECTRONIC MARKER DEVICE (EMD), SEE COA STANDARD


REVISIONS	WATER	AUTHORITY
	FIRE	/ATER HYDRANT ALLATION
	DWG. 2340	JANUARY 201

TYPE I TYPE II NED CURB TYP


MEDIAN PAVEMENT

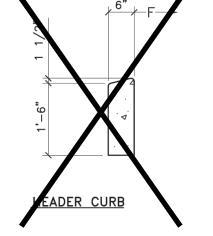


PINNED CURB

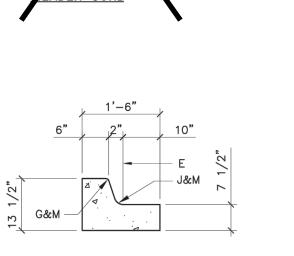


MEDIAN C & G

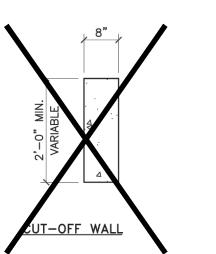


PINNED CURB

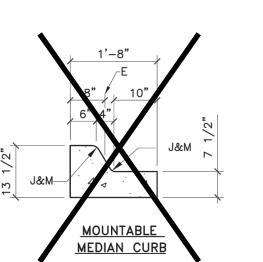

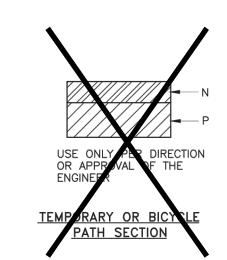

OUTSIDE PAVEMENT

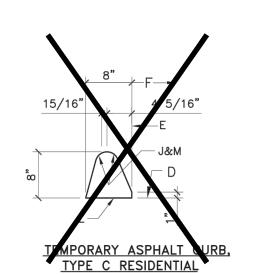

CONSTRUCTION NOTES

- A. REQ. CONC. CHANNEL LINING, OR CUT-OFF WALL, PROVIDE 1/4" EXP JOINT BETWEEN BACK OF CURB & CHANNEL LINING AND/OR WALL.
- B. VARIABLE, DEPRESS AS NEEDED.
- C. DRIVE NO. 4 PINS 18" DEEP IN HOLES DRILLED @ 2" O.C. IN EXISTING PAVEMENT, SEAL WITH
- D. EXISTING ASPHALT CONCRETE (AC) OR PORTLAND CEMENT CONCRETE (PCC) PAVEMENT.
- E. THEORETICAL FACE OF CURB OR FLOWLINE.
- F. TRAFFIC SIDE.
- G. 3/4" RADIUS.
- H. 1-1/2" RADIUS. J. 2" RADIUS.
- K. 24" RADIUS.
- L. TACK COAT. M. DIMENSIONS AT ROUNDED CORNERS MEASURED
- TO INTERSECTION OF STRAIGHT LINES. N. 4" AC: MAJOR LOCAL OR BETTER (SP-III) 3" AC: LOCAL RESIDENTIAL STREET (TYPE C)
- 2" AC: BICYCLE PATH (TYPE B, RESIDENTIAL) P. 8" SCARIFIED AND COMPACTED SUBGRADE. 95%
- MINIMUM COMPACTION PER SECTION 301. Q. AC PAVEMENT.
- R. #4 CONT. BETWEEN JOINTS 3" COVER AT
- S. #3 PINS @ 3'-0" O.C. W/STD. HOOK.

GENERAL NOTES SEE COA DRAWING 2415A

CITY OF ALBUQUERQUE REVISIONS 9/91 11/14/91 12/15/92 3/30/94 PAVING CURB AND GUTTER & TEMPORARY PAVING SECTION

DWG. 2415B JANUARY 2003

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PROJECT TEAM

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ISSUE/REVISION RECORD

DATE DESCRIPTION 04/03/15 COORDINATION SET

04/06/15 PERMIT SET 07/28/15 BID SET

09/14/15 PERMIT RESPONSE 2 10/19/15 CONSTRUCTION SET 11/02/15 PERMIT RESPONSE 11/23/15 PERMIT RESPONSE



PROFESSIONAL IN CHARGE FARMAN SHIR, P.E. PROFESSIONAL ENGINEER

LICENSE NO. 21307 PROJECT MANAGER MIKE HOLMES

QUALITY CONTROL LARRY DIEHL **DRAWN BY**

PROJECT NAME **TEXAS**

MIKE HOLMES

ROADHOUSE


ALBUQUERQUE NEW MEXICO

10030 COORS BOULEVARD **BYPASS NW**



PROJECT NUMBER 20130487.0

SHEET TITLE CONSTRUCTION **DETAILS**

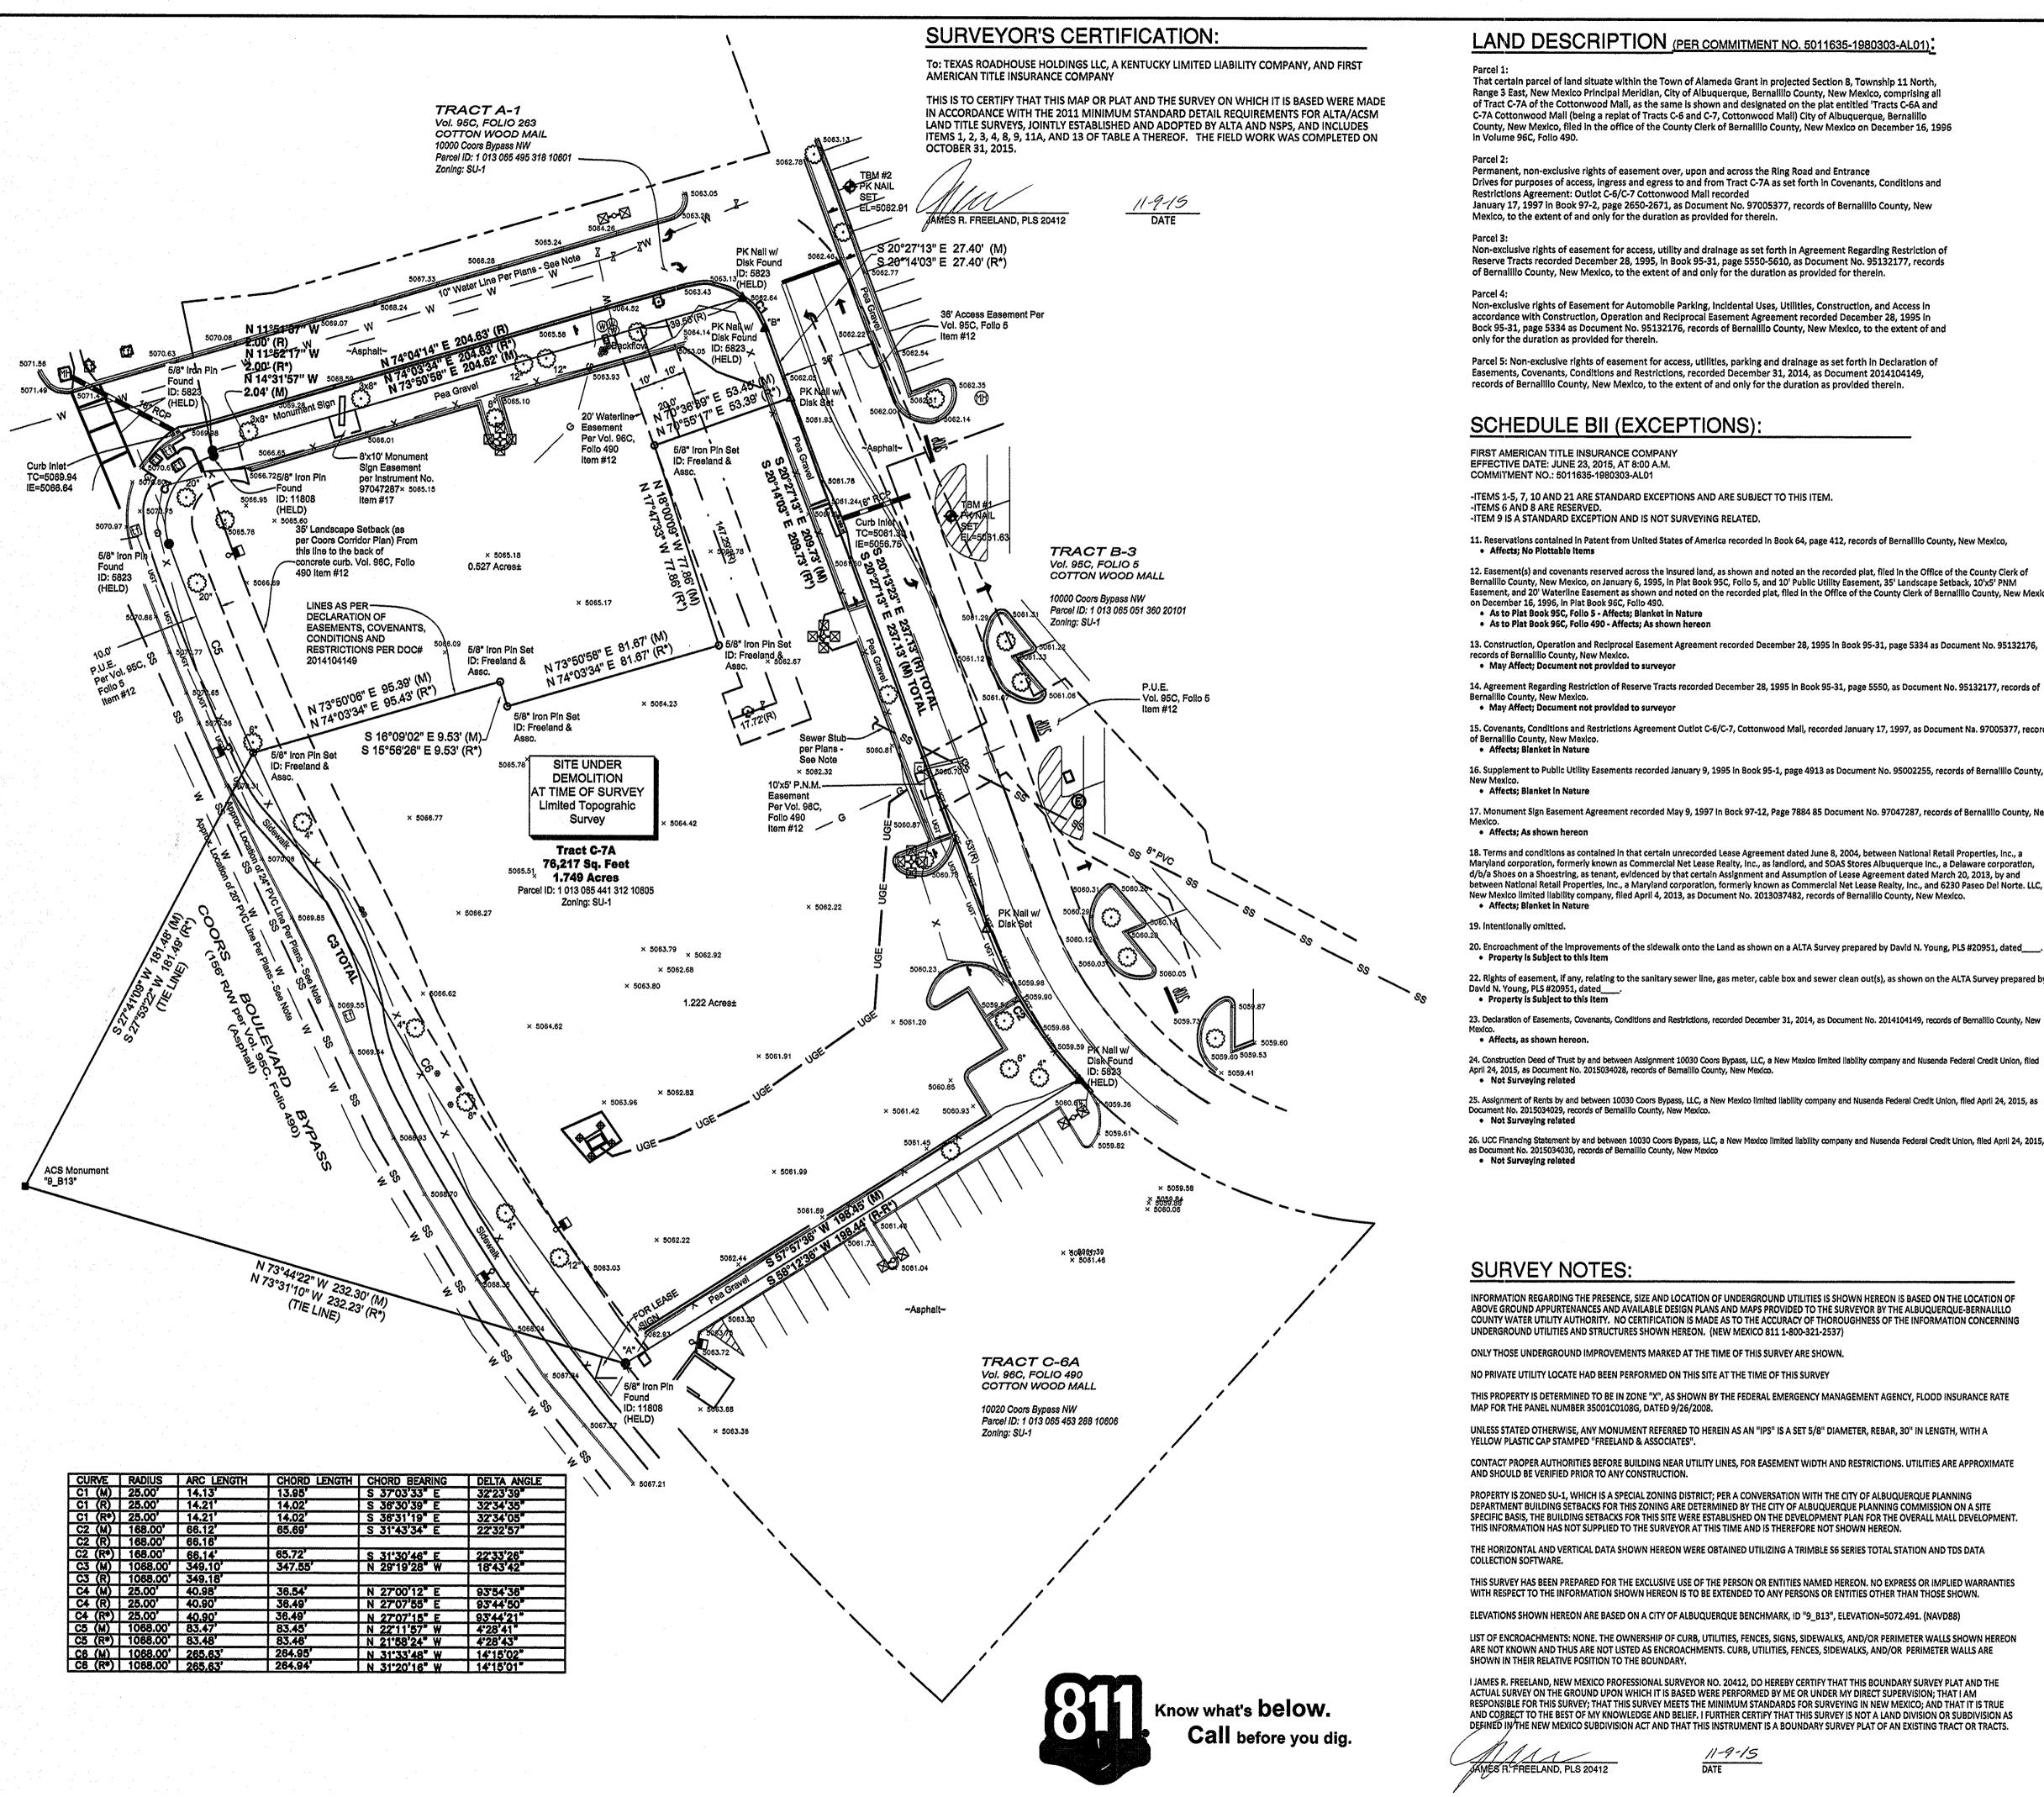

LAND DESCRIPTION (PER COMMITMENT NO. 5011635-1980303-AL01):

Parcel 1:

That certain parcel of land situate within the Town of Alameda Grant in projected Section 8, Township 11 North, Range 3 East, New Mexico Principal Meridian, City of Albuquerque, Bernalillo County, New Mexico, comprising all of Tract C-7A of the Cottonwood Mali, as the same is shown and designated on the plat entitled 'Tracts C-6A and C-7A Cottonwood Mall (being a replat of Tracts C-6 and C-7, Cottonwood Mall) City of Albuquerque, Bernalillo County, New Mexico, filed in the office of the County Clerk of Bernalillo County, New Mexico on December 16, 1996

Permanent, non-exclusive rights of easement over, upon and across the Ring Road and Entrance Drives for purposes of access, ingress and egress to and from Tract C-7A as set forth in Covenants, Conditions and Restrictions Agreement: Outlot C-6/C-7 Cottonwood Mail recorded

January 17, 1997 in Book 97-2, page 2650-2671, as Document No. 97005377, records of Bernalillo County, New Mexico, to the extent of and only for the duration as provided for therein.

Non-exclusive rights of easement for access, utility and drainage as set forth in Agreement Regarding Restriction of Reserve Tracts recorded December 28, 1995, in Book 95-31, page 5550-5610, as Document No. 95132177, records of Bernalillo County, New Mexico, to the extent of and only for the duration as provided for therein.

Non-exclusive rights of Easement for Automobile Parking, Incidental Uses, Utilities, Construction, and Access in accordance with Construction, Operation and Reciprocal Easement Agreement recorded December 28, 1995 in Bock 95-31, page 5334 as Document No. 95132176, records of Bernalillo County, New Mexico, to the extent of and only for the duration as provided for therein.

Parcel 5: Non-exclusive rights of easement for access, utilities, parking and drainage as set forth in Declaration of Easements, Covenants, Conditions and Restrictions, recorded December 31, 2014, as Document 2014104149, records of Bernalillo County, New Mexico, to the extent of and only for the duration as provided therein.

SCHEDULE BII (EXCEPTIONS):

FIRST AMERICAN TITLE INSURANCE COMPANY EFFECTIVE DATE: JUNE 23, 2015, AT 8:00 A.M. COMMITMENT NO.: 5011635-1980303-AL01

-ITEMS 1-5, 7, 10 AND 21 ARE STANDARD EXCEPTIONS AND ARE SUBJECT TO THIS ITEM.

-ITEMS 6 AND 8 ARE RESERVED. -ITEM 9 IS A STANDARD EXCEPTION AND IS NOT SURVEYING RELATED.

11. Reservations contained in Patent from United States of America recorded in Book 64, page 412, records of Bernalillo County, New Mexico, Affects: No Plottable Items

12. Easement(s) and covenants reserved across the insured land, as shown and noted an the recorded plat, filed in the Office of the County Clerk of Bernalillo County, New Mexico, on January 6, 1995, in Plat Book 95C, Folio 5, and 10' Public Utility Easement, 35' Landscape Setback, 10'x5' PNM Easement, and 20' Waterline Easement as shown and noted on the recorded plat, filed in the Office of the County Clerk of Bernalillo County, New Mexico, on December 16, 1996, in Plat Book 96C, Folio 490.

• As to Plat Book 95C, Folio 5 - Affects; Blanket in Nature . As to Plat Book 96C, Folio 490 - Affects; As shown hereon

13. Construction, Operation and Reciprocal Easement Agreement recorded December 28, 1995 in Book 95-31, page 5334 as Document No. 95132176, records of Bernalillo County, New Mexico. May Affect; Document not provided to surveyor

14. Agreement Regarding Restriction of Reserve Tracts recorded December 28, 1995 in Book 95-31, page 5550, as Document No. 95132177, records of May Affect; Document not provided to surveyor

15. Covenants, Conditions and Restrictions Agreement Outlot C-6/C-7, Cottonwood Mall, recorded January 17, 1997, as Document Na. 97005377, records of Bernalilio County, New Mexico Affects: Blanket in Nature

16. Supplement to Public Utility Easements recorded January 9, 1995 in Book 95-1, page 4913 as Document No. 95002255, records of Bernalillo County,

. Affects; Blanket in Nature 17. Monument Sign Easement Agreement recorded May 9, 1997 in Bock 97-12, Page 7884 85 Document No. 97047287, records of Bernaillio County, New

 Affects; As shown hereon 18. Terms and conditions as contained in that certain unrecorded Lease Agreement dated June 8, 2004, between National Retail Properties, inc., a Maryland corporation, formerly known as Commercial Net Lease Realty, Inc., as landlord, and SOAS Stores Albuquerque Inc., a Delaware corporation, d/b/a Shoes on a Shoestring, as tenant, evidenced by that certain Assignment and Assumption of Lease Agreement dated March 20, 2013, by and between National Retail Properties, Inc., a Maryland corporation, formerly known as Commercial Net Lease Realty, Inc., and 6230 Paseo Del Norte. LLC, a

19. Intentionally omitted.

20. Encroachment of the Improvements of the sidewalk onto the Land as shown on a ALTA Survey prepared by David N. Young, PLS #20951, dated_____

22. Rights of easement, if any, relating to the sanitary sewer line, gas meter, cable box and sewer clean out(s), as shown on the ALTA Survey prepared by David N. Young, PLS #20951, dated____

23. Declaration of Easements, Covenants, Conditions and Restrictions, recorded December 31, 2014, as Document No. 2014104149, records of Bernalillo County, New . Affects, as shown hereon.

April 24, 2015, as Document No. 2015034028, records of Bernalillo County, New Mexico. 25. Assignment of Rents by and between 10030 Coors Bypass, LLC, a New Mexico limited liability company and Nusenda Federal Credit Union, filed April 24, 2015, as Document No. 2015034029, records of Bernalillo County, New Mexico.

26. UCC Financing Statement by and between 10030 Coors Bypass, LLC, a New Mexico limited liability company and Nusenda Federal Credit Union, filed April 24, 2015, as Document No. 2015034030, records of Bernalillo County, New Mexico Not Surveying related

SURVEY NOTES:

INFORMATION REGARDING THE PRESENCE, SIZE AND LOCATION OF UNDERGROUND UTILITIES IS SHOWN HEREON IS BASED ON THE LOCATION OF ABOVE GROUND APPURTENANCES AND AVAILABLE DESIGN PLANS AND MAPS PROVIDED TO THE SURVEYOR BY THE ALBUQUERQUE-BERNALILLO COUNTY WATER UTILITY AUTHORITY. NO CERTIFICATION IS MADE AS TO THE ACCURACY OF THOROUGHNESS OF THE INFORMATION CONCERNING UNDERGROUND UTILITIES AND STRUCTURES SHOWN HEREON. (NEW MEXICO 811 1-800-321-2537)

ONLY THOSE UNDERGROUND IMPROVEMENTS MARKED AT THE TIME OF THIS SURVEY ARE SHOWN.

NO PRIVATE UTILITY LOCATE HAD BEEN PERFORMED ON THIS SITE AT THE TIME OF THIS SURVEY

THIS PROPERTY IS DETERMINED TO BE IN ZONE "X", AS SHOWN BY THE FEDERAL EMERGENCY MANAGEMENT AGENCY, FLOOD INSURANCE RATE MAP FOR THE PANEL NUMBER 35001C0108G, DATED 9/26/2008.

UNLESS STATED OTHERWISE, ANY MONUMENT REFERRED TO HEREIN AS AN "IPS" IS A SET 5/8" DIAMETER, REBAR, 30" IN LENGTH, WITH A YELLOW PLASTIC CAP STAMPED "FREELAND & ASSOCIATES". CONTACT PROPER AUTHORITIES BEFORE BUILDING NEAR UTILITY LINES, FOR EASEMENT WIDTH AND RESTRICTIONS. UTILITIES ARE APPROXIMATE

PROPERTY IS ZONED SU-1. WHICH IS A SPECIAL ZONING DISTRICT: PER A CONVERSATION WITH THE CITY OF ALBUQUERQUE PLANNING DEPARTMENT BUILDING SETBACKS FOR THIS ZONING ARE DETERMINED BY THE CITY OF ALBUQUERQUE PLANNING COMMISSION ON A SITE SPECIFIC BASIS, THE BUILDING SETBACKS FOR THIS SITE WERE ESTABLISHED ON THE DEVELOPMENT PLAN FOR THE OVERALL MALL DEVELOPMENT. THIS INFORMATION HAS NOT SUPPLIED TO THE SURVEYOR AT THIS TIME AND IS THEREFORE NOT SHOWN HEREON.

THE HORIZONTAL AND VERTICAL DATA SHOWN HEREON WERE OBTAINED UTILIZING A TRIMBLE S6 SERIES TOTAL STATION AND TDS DATA COLLECTION SOFTWARE.


THIS SURVEY HAS BEEN PREPARED FOR THE EXCLUSIVE USE OF THE PERSON OR ENTITIES NAMED HEREON, NO EXPRESS OR IMPLIED WARRANTIES WITH RESPECT TO THE INFORMATION SHOWN HEREON IS TO BE EXTENDED TO ANY PERSONS OR ENTITIES OTHER THAN THOSE SHOWN.


ELEVATIONS SHOWN HEREON ARE BASED ON A CITY OF ALBUQUERQUE BENCHMARK, ID "9_B13", ELEVATION=5072,491, (NAVD88)


LIST OF ENCROACHMENTS: NONE. THE OWNERSHIP OF CURB, UTILITIES, FENCES, SIGNS, SIDEWALKS, AND/OR PERIMETER WALLS SHOWN HEREON ARE NOT KNOWN AND THUS ARE NOT LISTED AS ENCROACHMENTS. CURB, UTILITIES, FENCES, SIDEWALKS, AND/OR PERIMETER WALLS ARE SHOWN IN THEIR RELATIVE POSITION TO THE BOUNDARY.

I JAMES R. FREELAND, NEW MEXICO PROFESSIONAL SURVEYOR NO. 20412, DO HEREBY CERTIFY THAT THIS BOUNDARY SURVEY PLAT AND THE ACTUAL SURVEY ON THE GROUND UPON WHICH IT IS BASED WERE PERFORMED BY ME OR UNDER MY DIRECT SUPERVISION: THAT I AM RESPONSIBLE FOR THIS SURVEY: THAT THIS SURVEY MEETS THE MINIMUM STANDARDS FOR SURVEYING IN NEW MEXICO: AND THAT IT IS TRUE AND COBRECT TO THE BEST OF MY KNOWLEDGE AND BELIEF. I FURTHER CERTIFY THAT THIS SURVEY IS NOT A LAND DIVISION OR SUBDIVISION AS DEFINED IN/THE NEW MEXICO SUBDIVISION ACT AND THAT THIS INSTRUMENT IS A BOUNDARY SURVEY PLAT OF AN EXISTING TRACT OR TRACTS.



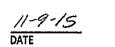

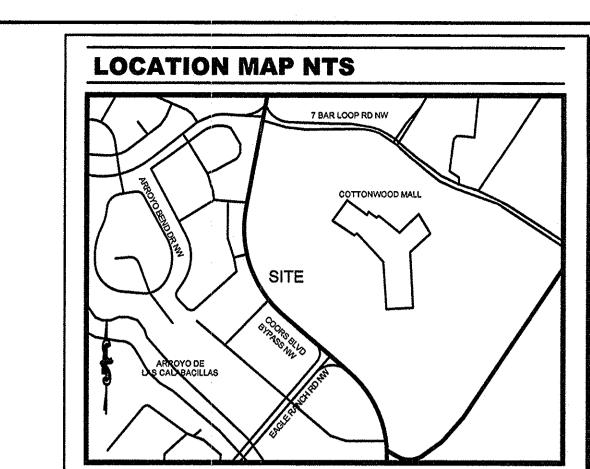

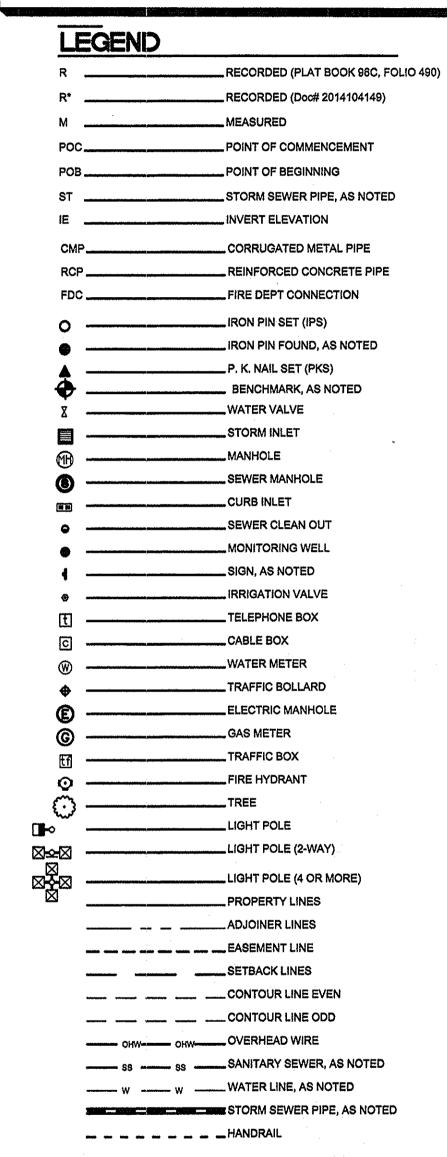


UTILITY PROVIDERS

WATER, SEWER & STORMWATER: Albuquerque-Bernalillo County Water Utility Authority One Civic Plaza NW Albuquerque, NM 87103 PH: 505-857-8250

TELEPHONE & CATV: Century Link 201 3rd Street, NW. Albuquerque, NM 87102 PH: 505-245-7500

Public Service Company of New Mexico (PNM) 414 Silver Avenue Southwest #4 Albuquerque, NM PH: 505-241-2700

New Mexico Gas Company P.O. Box 97500 PH: 505-697-3335

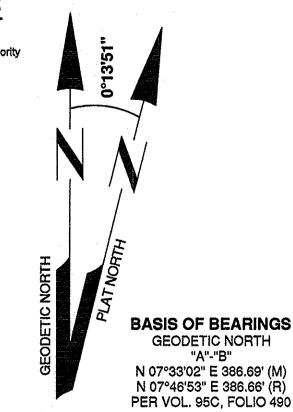

SCALE 1" = 30'


FREELAND FREELAND & ASSOCIATES, INC. 323 WEST STONE AVE. GREENVILLE S.C. 29809 EL. (884) 271-4924 FAX: (884) 233-0315 EMAIL: info@freeland-associates.com JAMES R. FREELAND, PLS 20412

YOUNG - HOBBS AND **ASSOCIATES**

> 1202 CROSSLAND AVE. CLARKSVILLE, TN 37040 PHONE 931-645-2524 FAX 931-645-2768

DAVID N. YOUNG, PLS 20951

NEW MEXICO

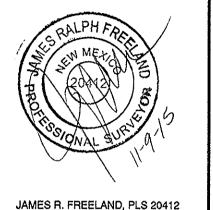

JAMES R. FREELAND, PLS 20412								
					Updated Survey	Client Comments	Revision	
					11/3/15	1/5/14	Date	1
					7	1	No.	
	-							Ĩ

Greenberg Farrow 19000 MacArthur Blvd Suite 250 Irvine, CA 92612

DRAWN BY: APPROVED BY: DATE: (FIELD) 10/30/2014 11/7/2014 DATE: (OFFICE)

0.0 0.0 0.0 0.0 0.0 0.0 0.1 0.1 0.2 0.3 0\7 \2.1 2.4 3.5 3.8 3.5 3.0 2/4 1.4 1.2 1,2 0.9 0.7 0.6 0.5 0.5 0.6 0.8 0.9 to 5.0 5.0 5.0 5.0 5.0 5.0 5.0 5.1 5.1 5\2 5.5 1\6 2.1\2.6 2.6 2.6 2.2 2.1 1.x 5.9 \1.0 5\8 5.7 5.5 \5.5 5\4 5.9 5 5.0 5.0 5.0 5.0 5.0 5.0 5.0 5.1 5.1 5.2 5.3 5.4 1.5 \$\\6 1.6 1.6 1.6 \dots 5.9 \\5.7 5.9 \\5.7 5.7 5.7 5.7 5.7 5.4 5.4 \\5.5 \\5.6 5.6 5.8 5.7 \\5.6 \\5.5 \\5.6 5.8 \\5.7 \\5.6 \\5.8 \\5.7 \\5.6 \\5.8 \\5.7 \\5.8 \\5.8 \\5.7 \\5.8 \\\$.8 \\5

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GRAPHIC SCALE

(IN FEET) 1 inch = 20 ft. **TEXAS** ROADHOUSE

PROJECT NAME

ALBUQUERQUE NEW MEXICO

10030 COORS BOULEVARD **BYPASS NW**

19000 MacArthur Blvd, Suite 250

t: 949 296 0450 f: 949 296 0479

This drawing is the property of the above

ISSUE/REVISION RECORD

DATE DESCRIPTION

07/28/15 BID SET

04/03/15 COORDINATION SET 04/06/15 PERMIT SET

1 09/14/15 PERMIT RESPONSE 10/19/15 CONSTRUCTION SET 11/02/15 PERMIT RESPONSE

11/23/15 PERMIT RESPONSE

PROFESSIONAL SEAL

PROFESSIONAL IN CHARGE FARMAN SHIR, P.E.

PROFESSIONAL ENGINEER LICENSE NO. 21307

PROJECT MANAGER

QUALITY CONTROL

MIKE HOLMES

LARRY DIEHL

DRAWN BY

MIKE HOLMES

Irvine, CA 92612

PROJECT TEAM



PROJECT NUMBER 20130487.0

SHEET TITLE **PHOTOMETRIC PLAN**

TEXAS ROADHOUSE 10030 COORS BLVD. BYPASS NW ALBUQUERQUE, NM PREPARED BY: JOHN BUJAKE ACCUSERV LIGHTING & EQUIPMENT 877-707-7378 502-961-0357 FAX jbujake@accu-serv.com NOVEMBER 9, 2015

Calculation Summary					
Label	Avg	Max	Min	Avg/Min	Max/Min
EXTENDED	0.87	7.4	0.0	N.A.	N.A.
RETAIL PARKING LOT SURFACE	1.73	6.1	0.4	4.33	15.25
TRH PARKING LOT SURFACE	1.82	6.5	0.4	4.55	16.25

LIGHT LEVELS ARE MAINTAINED FOOT-CANDLES

Luminaire Schedule							
Symbol	Qty	Label	Arrangement	Total Lamp Lumen:	5 LLF	Lum. Watts	Description
	1	A	SINGLE	32000	0.750	456	LITHONIA KAD-400M-R4-TB-SPD04-SCWA-LPI / SSS-25-4C-DM19-DDB
	3	EX	SINGLE	32000	0.700	458	EXISTING KAD 400M R4 (PROBE) / EXISTING 25' POLE
	3	EX-RELOC 1	SINGLE	32000	0.700	458	RELOCATED EXISTING KAD 400M R4 (PROBE) / RELOCATED EXISTING 25' POLE
	1	EX-RELOC 2	BACK-BACK	32000	0.700	458	RELOCATED EXISTING (2) KAD 400M R4 (PROBE) / RELOCATED EXISTING 25' POLE

FIXTURES ARE 400W METAL HALIDE W/ FLAT LENSES POLES ARE 25'-0" FOR AN OVERALL FIXTURE MOUNTING HEIGHT OF 27'-6" A.F.G.

