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# COORS BYPASS AND 7 BAR LOOP ROAD BERNALILLO COUNTY ALBUQUERQUE, NM 87114 ZONING: MIXED-USE-MODERATE INTENSITY ZONE DISTRICT (MX-M)


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JOB NO. 20182050.0 DATE: 07-24-2024

## **GENERAL NOTES:**

- 1. CONTRACTOR SHALL BE RESPONSIBLE FOR SITE SAFETY AND ALL WAYS, MEANS AND METHODS OF CONSTRUCTION.
- 2. CONTRACTOR SHALL COMPLY WITH ALL APPLICABLE FEDERAL, STATE AND LOCAL AGENCY CODES, STANDARDS AND SPECIFICATIONS.
- 3. CONTRACTOR SHALL OBTAIN ALL NECESSARY SITE PERMITS AND LICENSES FROM THE APPLICABLE GOVERNING AUTHORITIES.
- 4. ALL CONSTRUCTION MATERIALS AND WORKMANSHIP SHALL BE IN ACCORDANCE WITH THE LATEST STATE AND LOCAL GOVERNMENT CONSTRUCTION STANDARDS AND SPECIFICATIONS.
- 5. UNLESS OTHERWISE NOTED ON THE PLANS, CONTRACTOR SHALL NOTIFY THE LOCAL ENGINEERING OR PUBLIC WORKS DEPARTMENT AND/OR OTHER PROJECT GOVERNING AUTHORITY(S) A MINIMUM OF FORTY—EIGHT (48) HOURS PRIOR TO COMMENCING CONSTRUCTION OPERATIONS AND TO SCHEDULE ANY REQUIRED SITE INSPECTIONS.
- 6. CONTRACTOR SHALL SCHEDULE A UTILITY LOCATING SERVICE AND/OR NOTIFY ALL UTILITY COMPANIES (GAS, ELECTRIC, TELEPHONE, CABLE, ETC.) AND THE LOCAL MUNICIPALITY TO DETERMINE THE LOCATION OF UNDERGROUND UTILITIES PRIOR TO THE COMMENCEMENT OF CONSTRUCTION IN ORDER TO AVOID POTENTIAL CONFLICTS. IT IS ULTIMATELY THE RESPONSIBILITY OF THE CONTRACTOR TO LOCATE ALL EXISTING UTILITIES WHETHER INDICATED ON THE PLANS OR NOT AND TO HAVE THESE UTILITIES STAKED PRIOR TO CONSTRUCTION. ANY NECESSARY RELOCATIONS OR REMOVALS OF EXISTING UTILITY LINES SHALL BE PERFORMED BY THE CONTRACTOR AT NO ADDITIONAL COST TO THE OWNER.
- 7. CONTRACTOR SHALL BE RESPONSIBLE FOR THE PROTECTION OF ALL PRIVATE AND PUBLIC UTILITIES EVEN THOUGH THEY MAY NOT BE SHOWN ON THE PLANS. ANY UTILITY THAT IS DAMAGED DURING CONSTRUCTION SHALL BE REPAIRED OR REPLACED BY THE CONTRACTOR AT HIS EXPENSE AND TO THE SATISFACTION OF THE UTILITY OWNER.
- 8. ALL EASEMENTS FOR EXISTING UTILITIES, BOTH PUBLIC AND PRIVATE, AND UTILITIES WITHIN PUBLIC RIGHTS-OF-WAY ARE SHOWN ON THE PLANS PREPARED BY THE SURVEYOR ACCORDING TO INFORMATION AVAILABLE FROM PUBLIC RECORDS OR VISIBLE FIELD MARKINGS. THE CONTRACTOR SHALL BE ULTIMATELY RESPONSIBLE FOR DETERMINING THE EXACT LOCATION IN THE FIELD OF THESE UTILITY LINES AND FOR THEIR PROTECTION FROM DAMAGE DUE TO CONSTRUCTION OPERATIONS. IF EXISTING UTILITY LINES OF ANY NATURE ARE ENCOUNTERED WHICH CONFLICT IN LOCATION WITH THE PROPOSED CONSTRUCTION, THE CONTRACTOR SHALL IMMEDIATELY NOTIFY THE ENGINEER SO THE CONFLICT MAY BE RESOLVED.
- 9. ALL UTILITY CONNECTIONS TO EXISTING LINES SHALL BE CONSTRUCTED IN ACCORDANCE WITH THE RULES AND REGULATIONS AND TO THE SATISFACTION OF THE APPLICABLE UTILITY OWNER(S).
- 10. CONTRACTOR SHALL FIELD VERIFY ALL DIMENSIONS, COORDINATES AND ELEVATIONS PRIOR TO THE COMMENCEMENT OF CONSTRUCTION AND SHALL IMMEDIATELY NOTIFY THE ENGINEER OF ANY DISCREPANCIES SO THE CONFLICT MAY BE RESOLVED.
- 11. ALL PROPERTY MARKERS AND SURVEY REFERENCE MARKERS SHALL BE CAREFULLY PRESERVED DURING CONSTRUCTION UNTIL THEIR LOCATION HAS BEEN WITNESSED OR OTHERWISE TIED IN BY AN AUTHORIZED AGENT OR PROFESSIONALLY LICENSED SURVEYOR.
- 12. THE SAFE AND ORDERLY PASSAGE OF TRAFFIC AND PEDESTRIANS SHALL BE PROVIDED WHERE CONSTRUCTION OPERATIONS ABUT PUBLIC THROUGH—FARES AND ADJACENT PROPERTY.
- 13. ALL AREAS DISTURBED BY THE GENERAL CONTRACTOR OR SUB-CONTRACTORS SHALL BE RETURNED TO THE ORIGINAL CONDITION OR BETTER, EXCEPT WHERE PROPOSED CONSTRUCTION IS INDICATED ON THE PLANS.
- 14. PRIOR TO INITIAL ACCEPTANCE BY THE OWNER(S) AND/OR GOVERNING AUTHORITY, ALL WORK SHALL BE INSPECTED AND APPROVED BY THE OWNER AND MUNICIPALITY ENGINEER OR HIS REPRESENTATIVE(S). THE CONTRACTOR SHALL GUARANTEE HIS WORK FOR A PERIOD OF 12 (TWELVE) MONTHS FROM THE DATE OF SUBSTANTIAL COMPLETION AND SHALL BE HELD RESPONSIBLE FOR ANY DEFECTS IN MATERIAL OR WORKMANSHIP OF THIS WORK DURING THAT PERIOD AND UNTIL FINAL ACCEPTANCE IS MADE.
- 15. CONTRACTOR SHALL BE RESPONSIBLE FOR PROVIDING SAFE AND ADEQUATE WORKING CONDITIONS THROUGHOUT THE DURATION OF CONSTRUCTION OF THE PROPOSED IMPROVEMENTS.
- 16. CONTRACTOR SHALL KEEP THE PUBLIC STREET PAVEMENTS CLEAN OF DIRT AND DEBRIS AND, WHEN NECESSARY, CLEAN PAVEMENTS AT THE END OF EACH WORKING DAY.
- 17. ALL CONSTRUCTION STAKING, SCHEDULING AND PAYMENT IS THE RESPONSIBILITY OF THE CONTRACTOR.
- 18. AFTER COMPLETION OF THE PROPOSED IMPROVEMENTS AND WHEN REQUIRED BY THE GOVERNING AUTHORITY(S), CONTRACTOR SHALL PROVIDE THE OWNER AND ENGINEER WITH AS-BUILT AND/OR RECORD DRAWINGS, SIGNED AND SEALED BY A PROFESSIONALLY LICENSED ENGINEER OR SURVEYOR AND SHALL INCLUDE AT A MINIMUM (WHERE APPLICABLE TO THE SCOPE OF WORK) THE FOLLOWING ITEMS:
- 18.1. TOPOGRAPHY AND SPOT GRADE ELEVATIONS OF ALL PROPOSED PERMANENT SITE FEATURES INCLUDING ANY STORM WATER FACILITIES OR MODIFICATIONS TO EXISTING STORM WATER FACILITIES.
- 18.2. HORIZONTAL AND VERTICAL LOCATION AND ALIGNMENT OF ALL PROPOSED ROADWAYS, PARKING LOTS, UTILITIES, BUILDINGS OR OTHER PERMANENT SITE FEATURES.
- 18.3. RIM AND INVERT AND/OR TOP OF PIPE ELEVATIONS FOR ALL PROPOSED UTILITIES.
- 18.4. AS-BUILT AND/OR RECORD DRAWING INFORMATION SHALL BE SHOWN ON THE APPROVED ENGINEERING PLANS ISSUED FOR CONSTRUCTION. ANY AND ALL DEVIATIONS FROM THESE APPROVED PLANS SHALL BE SHOWN BY MEANS OF STRIKING THROUGH THE PROPOSED INFORMATION AND CLEARLY INDICATING THE AS-BUILT LOCATIONS AND ELEVATIONS ON THE APPLICABLE PLAN SHEET.

## SITE GRADING AND PAVING NOTES:

- 1. ALL SITE WORK, GRADING, AND PAVING OPERATIONS WITHIN THE LIMITS OF THE PROJECT SHALL BE PERFORMED IN ACCORDANCE WITH THE NOTES IN THE PLANS AND THE STANDARDS, SPECIFICATIONS, CODES AND ORDINANCES OF THE LOCAL GOVERNING AUTHORITIES. IN CASE OF CONFLICT, THE MORE STRINGENT CODE SHALL TAKE PRECEDENCE.
- 2. EARTH EXCAVATION SHALL INCLUDE CLEARING, STRIPPING AND STOCKPILING TOPSOIL, REMOVING UNSUITABLE MATERIALS, CONSTRUCTION OF EMBANKMENTS, NON-STRUCTURAL FILLS, FINAL SHAPING AND TRIMMING TO THE LINES, GRADES AND CROSS SECTIONS SHOWN ON THE PLANS. ALL UNSUITABLE OR EXCESS MATERIAL SHALL BE DISPOSED OF LEGALLY OFFSITE OR AS DIRECTED BY THE PROJECT REPRESENTATIVE IN THE FIELD.
- 3. EXCAVATED TOPSOIL SHALL BE STOCKPILED ON THE SITE IN AREAS DESIGNATED BY THE PROJECT ENGINEER UNTIL SUCH TIME THAT THIS TOPSOIL CAN BE USED FOR FINAL GRADING. UNLESS OTHERWISE NOTED ON THE PLANS, A MINIMUM OF 6" TOPSOIL RE—SPREAD AND SEEDING FOR ALL DISTURBED AREAS IS REQUIRED.
- 4. THE GEOTECHNICAL INVESTIGATION REPORT FOR THE SITE AND ALL ADDENDA THERETO ARE SUPPORTING DOCUMENTS FOR THIS PROJECT. THE RECOMMENDATIONS AS STATED IN SAID REPORT ARE HEREBY INCORPORATED INTO THESE CONSTRUCTION NOTES BY REFERENCE AND SHALL BE FOLLOWED BY ALL CONTRACTORS. THE GRADING OPERATIONS ARE TO BE CLOSELY SUPERVISED AND INSPECTED, PARTICULARLY DURING THE REMOVAL OF UNSUITABLE MATERIAL AND THE CONSTRUCTION OF EMBANKMENTS OR BUILDING PADS, BY A SOILS ENGINEER OR HIS REPRESENTATIVE. FURTHER CONSTRUCTION OPERATIONS WILL NOT BE PERMITTED UNTIL THE SOILS ENGINEER ISSUES A WRITTEN STATEMENT THAT THE AREA IN QUESTION HAS BEEN SATISFACTORILY PREPARED AND IS READY FOR CONSTRUCTION.
- 5. ALL TESTING, INSPECTION AND SUPERVISION OF SOIL QUALITY, UNSUITABLE SOIL REMOVAL AND ITS REPLACEMENT AND OTHER SOILS RELATED OPERATIONS SHALL BE THE RESPONSIBILITY OF THE CONTRACTOR AND SHALL BE COORDINATED WITH AND PERFORMED AT THE DIRECTION OF THE OWNER'S GEOTECHNICAL ENGINEER.
- 6. THE CONTRACTOR SHALL USE CARE IN GRADING NEAR TREES, SHRUBS, AND BUSHES WHICH ARE NOT NOTED TO BE REMOVED SO AS NOT TO CAUSE INJURY TO ROOTS OR TRUNKS.
- 7. THE CONTRACTOR SHALL USE CARE IN GRADING OR EXCAVATING NEAR ANY AND ALL EXISTING ITEMS WHICH ARE NOT INDICATED TO BE REMOVED. ANY DAMAGE DONE TO THESE EXISTING ITEMS BY THE CONTRACTOR'S OPERATIONS SHALL BE REPAIRED AT HIS OWN EXPENSE.
- 8. REMOVED PAVEMENTS, SIDEWALKS, CURBS, TREES AND STUMPS SHALL BE DISPOSED OF LEGALLY OFFSITE AT LOCATIONS DETERMINED BY THE CONTRACTOR.
- 9. ON AND OFFSITE PAVING AND CURBS TO REMAIN SHALL BE PROTECTED FROM DAMAGE, AND, IF DAMAGED, SHALL BE REPLACED PROMPTLY TO MEET STATE AND LOCAL STANDARD SPECIFICATIONS IN MATERIALS AND WORKMANSHIP.
- 10. PROPOSED ELEVATIONS INDICATE FINISHED GRADE CONDITIONS. FOR ROUGH GRADING ELEVATIONS ALLOW FOR THE THICKNESS OF THE PROPOSED PAVEMENT SECTION (ROADS, WALKS, DRIVE, ETC.) OR TOPSOIL AS INDICATED ON THE PLANS.
- 11. CONTRACTOR SHALL PROVIDE SMOOTH VERTICAL CURVES THROUGH THE HIGH AND LOW POINTS INDICATED BY SPOT ELEVATIONS ON THE PLANS. CONTRACTOR SHALL PROVIDE UNIFORM SLOPES BETWEEN NEW AND EXISTING GRADES AND AVOID ANY RIDGES AND/OR DEPRESSIONS.
- 12. ALL PROPOSED GRADING, PAVEMENT, APRONS, CURBS, WALKS, ETC. SHALL MATCH EXISTING GRADES FLUSH.
- 13. ALL EXISTING AND PROPOSED TOP OF FRAME ELEVATIONS FOR STORM, SANITARY, WATER AND OTHER UTILITY STRUCTURES SHALL BE ADJUSTED TO MEET FINISHED GRADE WITHIN THE PROJECT LIMITS.
- 14. SITE GRADING AND CONSTRUCTION OF THE PROPOSED SITE IMPROVEMENTS SHALL NOT CAUSE PONDING OF STORM WATER. ALL AREAS ADJACENT TO THESE IMPROVEMENTS SHALL BE GRADED TO ALLOW POSITIVE DRAINAGE AND MATCH EXISTING GRADES FLUSH.
- 15. CONTRACTOR SHALL ENSURE POSITIVE SITE DRAINAGE AT THE END OF EACH WORKING DAY DURING CONSTRUCTION OPERATIONS. FAILURE TO PROVIDE ADEQUATE DRAINAGE WILL PRECLUDE THE CONTRACTOR FROM ANY POSSIBLE COMPENSATION REQUESTED DUE TO DELAYS OR UNSUITABLE MATERIALS CREATED AS A RESULT.
- 16. DRIVEWAYS SHALL BE CONSTRUCTED SO AS NOT TO IMPEDE THE SURFACE DRAINAGE SYSTEM.
- 17. TRAFFIC CONTROL DEVICES SHALL BE IN CONFORMANCE WITH THE APPLICABLE STATE DEPARTMENT OF TRANSPORTATION STANDARDS AND SHALL BE INSTALLED AND PROVIDED WHENEVER CONSTRUCTION FOR UTILITIES ARE WITHIN STREET AREAS. APPLICABLE ORDINANCES OF THE MUNICIPALITY, COUNTY OR STATE SHALL ALSO GOVERN THE TRAFFIC CONTROL REQUIREMENTS.
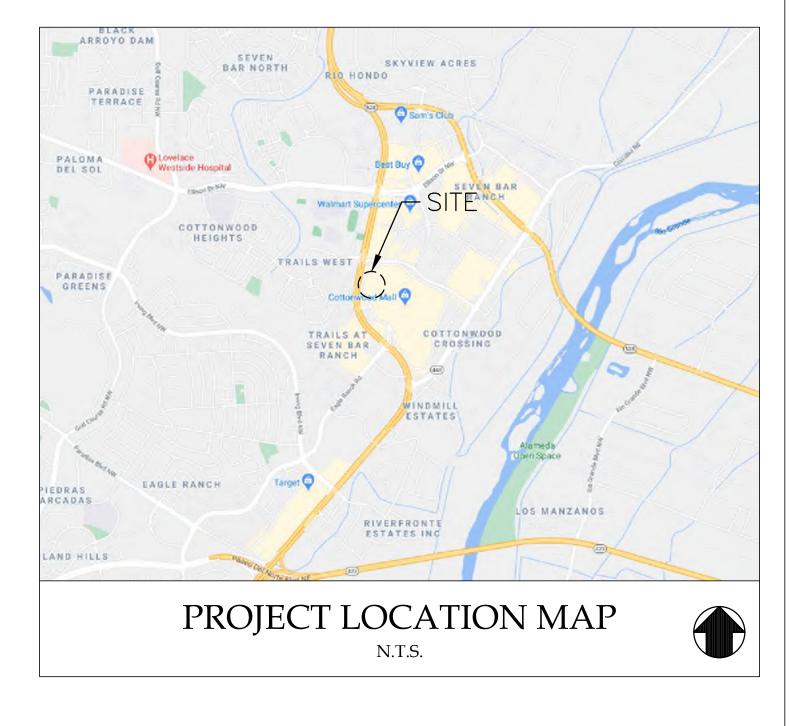
## STORM SEWER NOTES:

- 1. ALL STORM SEWER CONSTRUCTION SHALL BE PERFORMED IN ACCORDANCE WITH THE NOTES IN THE PLANS AND THE STANDARDS, SPECIFICATIONS, CODES AND ORDINANCES OF THE LOCAL GOVERNING AUTHORITIES. IN CASE OF CONFLICT, THE MORE STRINGENT CODE SHALL TAKE PRECEDENCE.
- 2. STORM SEWER PIPE AND STRUCTURES SHALL BE FURNISHED AND INSTALLED IN ACCORDANCE WITH LOCAL REQUIREMENTS AND SPECIFICATIONS.
- 3. HDPE STORM SEWER PIPE SHALL BE HIGH DENSITY POLYETHYLENE PIPE PER ASTM F2306 WITH WATERTIGHT JOINTS CONFORMING TO ASTM D3212.
- 4. STORM SEWER TRENCH EXCAVATIONS AND PIPE FOUNDATION, BEDDING AND HAUNCHING SHALL BE CONSTRUCTED IN ACCORDANCE WITH LOCAL REQUIREMENTS AND SPECIFICATIONS.
- 4.1. STORM SEWERS MUST BE PLACED ON PROPERLY COMPACTED STONE BEDDING. PIPE BEDDING MATERIAL SHALL BE A MINIMUM OF FOUR (4) INCHES THICK UNDER THE BARREL OF THE PIPE AND FOR PVC PIPE, MATERIAL SHALL BE EXTENDED A MINIMUM OF 12" OVER THE TOP OF THE PIPE PER ASTM D2321. PIPE BEDDING MATERIAL SHALL BE CRUSHED GRAVEL OR STONE MEETING LOCAL STANDARD GRADATIONS.
- 4.2. TRENCH BACKFILL MATERIAL SHALL BE PLACED AND COMPACTED TO A MINIMUM OF 98% STANDARD PROCTOR MAXIMUM DRY DENSITY, PER ASTM D698, OVER ALL STORM SEWERS WHICH ARE CONSTRUCTED UNDER, OR WITHIN TWO (2) FEET OF, ANY PROPOSED OR EXISTING PAVEMENT, PARKING LOTS OR SIDEWALKS.
- 5. REQUIRED STORM STRUCTURE RIM ADJUSTMENTS SHALL BE MADE WITH PRECAST CONCRETE ADJUSTING RINGS NOT TO EXCEED A MAXIMUM OF EIGHT (8) INCHES IN OVERALL HEIGHT. A MAXIMUM OF TWO (2) ADJUSTING RINGS ARE ALLOWED. BUTYLROPE JOINT SEALANT SHALL BE USED ON ALL JOINTS BETWEEN THE PRECAST ELEMENTS.
- 6. FIELD TILE ENCOUNTERED DURING CONSTRUCTION OPERATIONS SHALL BE CONNECTED TO THE PROPOSED STORM SEWER SYSTEM OR EXTENDED TO OUTLET INTO A PROPOSED DRAINAGE WAY. IF THIS CANNOT BE ACCOMPLISHED, THEN IT SHALL BE REPAIRED WITH NEW PIPE OF SIMILAR SIZE AND MATERIAL TO THE ORIGINAL LINE AND PUT IN ACCEPTABLE OPERATING CONDITION. A RECORD OF THE LOCATION OF ALL FIELD TILE OR DRAIN PIPE ENCOUNTERED SHALL BE KEPT BY THE CONTRACTOR AND TURNED OVER TO THE OWNER AND/OR ENGINEER UPON COMPLETION OF THE PROJECT AND ACCURATELY SHOWN ON THE RECORD

## SANITARY SEWER NOTES:

- 1. ALL SANITARY SEWER CONSTRUCTION SHALL BE PERFORMED IN ACCORDANCE WITH THE NOTES IN THE PLANS AND THE STANDARDS, SPECIFICATIONS, CODES AND ORDINANCES OF THE LOCAL GOVERNING AUTHORITIES. IN CASE OF CONFLICT, THE MORE STRINGENT CODE SHALL TAKE PRECEDENCE.
- 2. ALL SANITARY SEWER PIPE AND STRUCTURES SHALL BE FURNISHED AND INSTALLED IN ACCORDANCE WITH LOCAL REQUIREMENTS AND SPECIFICATIONS.
- 3. ALL SANITARY SEWER PIPE SHALL BE POLYVINYL CHLORIDE (PVC) SDR 35 PIPE PER ASTM D3034 WITH WATERTIGHT JOINTS CONFORMING TO ASTM D3212, UNLESS OTHERWISE NOTED.
- 3.1. WHERE SANITARY SEWER PIPE IS NOTED AS PVC C900, THE PIPE SHALL BE IN ACCORDANCE WITH AMERICAN WATER WORKS ASSOCIATION (AWWA) C900 WITH WATERTIGHT, PRESSURE RATED JOINTS CONFORMING TO ASTM D3139.
- 4. SANITARY SEWER CONSTRUCTION SHALL COMMENCE AT THE EXISTING MANHOLE(S) AND/OR CONNECTION POINT(S) INDICATED ON THE PLANS.
- 4.1. A WATERTIGHT PLUG SHALL BE INSTALLED AND LEFT IN PLACE AT THE POINT OF COMMENCEMENT UNTIL THE REMAINDER OF THE PROPOSED SEWERS HAVE BEEN CONSTRUCTED, PROPERLY TESTED AND DEEMED READY FOR FINAL ACCEPTANCE.
- 5. ALL SANITARY SEWER TRENCH EXCAVATIONS AND PIPE FOUNDATION, BEDDING AND HAUNCHING SHALL BE CONSTRUCTED IN ACCORDANCE WITH LOCAL REQUIREMENTS AND SPECIFICATIONS.
- 5.1. ALL SANITARY SEWERS MUST BE PLACED ON PROPERLY COMPACTED STONE BEDDING. PIPE BEDDING MATERIAL SHALL BE A MINIMUM OF FOUR (4) INCHES THICK UNDER THE BARREL OF THE PIPE AND FOR PVC PIPE, MATERIAL SHALL BE EXTENDED A MINIMUM OF 12" OVER THE TOP OF THE PIPE PER ASTM D2321. PIPE BEDDING MATERIAL SHALL BE CRUSHED GRAVEL OR STONE MEETING LOCAL STANDARD GRADATIONS.
- 5.2. TRENCH BACKFILL MATERIAL SHALL BE PLACED AND COMPACTED TO A MINIMUM OF 98% STANDARD PROCTOR MAXIMUM DRY DENSITY, PER ASTM D698, OVER ALL SANITARY SEWERS WHICH ARE CONSTRUCTED UNDER, OR WITHIN TWO (2) FEET OF, ANY PROPOSED OR EXISTING PAVEMENT, PARKING LOTS OR SIDEWALKS.
- 6. THE CONTRACTOR IS REQUIRED TO RECORD THE LOCATION OF ALL SEWERS AND FURNISH THE INFORMATION TO THE PROJECT ENGINEER AND/OR OWNER'S REPRESENTATIVE. THE CONTRACTOR SHALL LOCATE ALL SEWERS BY MEASUREMENTS TO LOT CORNERS OR OTHER PERMANENT SITE FEATURE AND SHALL FURNISH A COPY OF SUCH LOCATIONS TO THE PROJECT ENGINEER AND/OR OWNER'S REPRESENTATIVE UPON PROJECT COMPLETION. THIS INFORMATION SHALL ALSO INCLUDE THE DEPTH OF EACH SEWER. IF THE CONTRACTOR FAILS TO PROPERLY LOCATE ANY SEWER, HE SHALL BE RESPONSIBLE FOR ALL COSTS WHICH ARE INCURRED AS A RESULT OF THE IMPROPERLY LOCATED UTILITIES.
- 7. SANITARY SEWER MANHOLES SHALL BE PRECAST CONCRETE AND SHALL BE FURNISHED AND INSTALLED IN ACCORDANCE WITH THE DETAILS IN THE PLANS.
- 7.1. A FLEXIBLE TYPE JOINT SHALL BE FURNISHED AT POINTS OF ENTRY INTO AND EXITING FROM MANHOLE STRUCTURES AND SHALL BE OF A DESIGN APPROVED BY THE ENGINEER PRIOR TO INSTALLATION. THIS FLEXIBLE JOINT MAY CONSIST OF A SLEEVE OF HIGH QUALITY SYNTHETIC RUBBER WITH A SUBSTANTIAL SERRATED FLANGE WHICH IS CAST DIRECTLY INTO THE WALL OF THE MANHOLE BASE TO FORM A WATERTIGHT SEAL AND PROTRUDES OUTSIDE OF THE MANHOLE WALL TO CONNECT WITH THE PIPE ENTERING/EXITING THE MANHOLE. WHEN THIS TYPE OF FLEXIBLE JOINT IS USED, THE SLEEVE SHALL SLIP OVER THE END OF THE PIPE ADJACENT TO THE MANHOLE BASE AND SHALL BE SECURED BY MEANS OF A STAINLESS STEEL STRAP CLAMP EQUIPPED WITH A DRAW BOLT AND NUT.
- 8. REQUIRED MANHOLE RIM ADJUSTMENTS SHALL BE MADE WITH PRECAST CONCRETE ADJUSTING RINGS NOT TO EXCEED A MAXIMUM OF EIGHT (8) INCHES IN OVERALL HEIGHT. A MAXIMUM OF TWO (2) ADJUSTING RINGS ARE ALLOWED. BUTYLROPE JOINT SEALANT SHALL BE USED ON ALL JOINTS BETWEEN THE PRECAST ELEMENTS.

## SANITARY SEWER NOTES (continued):

- 9. AFTER FINAL ADJUSTMENTS HAVE BEEN MADE, ALL JOINTS IN PRECAST STRUCTURES SHALL BE MORTARED. THE MORTAR SHALL BE COMPOSED OF ONE (1) PART CEMENT TO THREE (3) PARTS SAND, BY VOLUME, BASED ON DRY MATERIALS, AND SHALL BE THOROUGHLY WETTED BEFORE LAYING.
- 10. WHEN CONNECTING TO AN EXISTING SEWER MAIN BY MEANS OTHER THAN AN EXISTING WYE, TEE, OR MANHOLE, THE FOLLOWING METHOD SHALL BE USED:
- 10.1. CIRCULAR SAW-CUT OF SEWER MAIN BY PROPER TOOLS ('SEWER-TAP' MACHINE OR SIMILAR) AND PROPER INSTALLATION OF HUB-WYE SADDLE OR HUB-TEE SADDLE.
- 11. UPON COMPLETION OF THE SANITARY SEWER CONSTRUCTION, INCLUDING THE SERVICE LINES, ALL SEWERS SHALL BE TESTED IN ACCORDANCE WITH SECTIONS LOCAL REQUIREMENTS AND SPECIFICATIONS AND SHALL BE WITNESSED BY THE LOCAL GOVERNING AUTHORITY OR AUTHORIZED REPRESENTATIVE.

## WATER MAIN AND WATER SERVICE NOTES:

- 1. ALL WATER MAIN CONSTRUCTION SHALL BE PERFORMED IN ACCORDANCE WITH THE NOTES IN THE PLANS AND THE STANDARDS, SPECIFICATIONS, CODES AND ORDINANCES OF THE LOCAL GOVERNING AUTHORITIES. IN CASE OF CONFLICT, THE MORE STRINGENT CODE SHALL TAKE PRECEDENCE.
- 2. WATER MAIN PIPE AND STRUCTURES SHALL BE FURNISHED AND INSTALLED IN ACCORDANCE WITH LOCAL REQUIREMENTS AND SPECIFICATIONS.
- 3. WATER MAIN SHALL BE DUCTILE IRON PIPE, CLASS 53 IN ACCORDANCE WITH AMERICAN WATER WORKS ASSOCIATION (AWWA) STANDARDS C151, C111 AND C104, UNLESS OTHERWISE NOTED.
- 4. UNLESS OTHERWISE NOTED ON THE PLANS, ALL WATER MAIN PIPE SHALL BE LAID WITH A MINIMUM COVER OF FIVE (5) FEET FROM THE PROPOSED FINISH GRADE INDICATED ON THE PLANS OR TO THE SPECIFIC TOP OF PIPE ELEVATION INDICATED ON THE PLANS FOR THE WATER MAIN. NO BERMS ARE ALLOWED OVER WATER MAINS EXCLUSIVELY FOR THE PURPOSE OF OBTAINING ADEQUATE GROUND COVER.
- 5. DUCTILE IRON WATER MAIN PIPE SHALL BE CONSTRUCTED WITH A MINIMUM OF 8-MIL POLYETHYLENE ENCASEMENT TO PREVENT CORROSION.
- 6. WATER MAIN TRENCH EXCAVATIONS AND PIPE FOUNDATION, BEDDING AND HAUNCHING SHALL BE CONSTRUCTED IN ACCORDANCE WITH LOCAL REQUIREMENTS AND SPECIFICATIONS.
- 6.1. WATER MAINS MUST BE PLACED ON PROPERLY COMPACTED STONE BEDDING. PIPE BEDDING MATERIAL SHALL BE A MINIMUM OF FOUR (4) INCHES THICK UNDER THE BARREL OF THE PIPE. PIPE BEDDING MATERIAL SHALL BE CRUSHED GRAVEL OR STONE MEETING LOCAL STANDARD GRADATIONS.
- 6.2. TRENCH BACKFILL MATERIAL SHALL BE PLACED AND COMPACTED TO A MINIMUM OF 98% STANDARD PROCTOR MAXIMUM DRY DENSITY, PER ASTM D698, OVER ALL WATER MAINS WHICH ARE CONSTRUCTED UNDER, OR WITHIN TWO (2) FEET OF, ANY PROPOSED OR EXISTING PAVEMENT, PARKING LOTS OR SIDEWALKS.
- 7. A WATERTIGHT PLUG SHALL BE PLACED IN THE END OF THE WATER MAIN PIPE AT THE END OF EACH CONSTRUCTION DAY.
- 8. UPON COMPLETION OF THE WATERMAIN CONSTRUCTION, ALL WATER MAIN SHALL BE TESTED IN ACCORDANCE WITH THE FOLLOWING MINIMUM STANDARDS:

HYDROSTATIC PRESSURE AND LEAKAGE TESTS IN ACCORDANCE WITH LOCAL

- REQUIREMENTS AND SPECIFICATIONS AND SHALL BE WITNESSED BY THE LOCAL GOVERNING AUTHORITY.

  8.2. DISINEECTION IN ACCORDANCE WITH LOCAL REQUIREMENTS AND THE METHODS.
- 8.2. DISINFECTION IN ACCORDANCE WITH LOCAL REQUIREMENTS AND THE METHODS STATED IN AWWA STANDARD C651 AND WITNESSED BY THE LOCAL GOVERNING ALTHORITY
- 9. WATER SERVICE PIPING AND STRUCTURES SHALL BE FURNISHED AND INSTALLED IN ACCORDANCE WITH LOCAL REQUIREMENTS AND SPECIFICATIONS.
- 10. WATER SERVICE LINES 2" IN DIAMETER OR SMALLER SHALL BE TYPE 'K' COPPER TUBING CONFORMING TO ASTM B88-14. NO COUPLINGS SHALL BE PERMITTED BETWEEN THE CORPORATION AND CURB STOPS OR BETWEEN THE CURB STOP AND THE BUILDING.
- 11. WATER SERVICE FITTINGS INCLUDING CORPORATION STOPS, SERVICE BOXES AND BUFFALO BOXES SHALL BE FURNISHED IN ACCORDANCE WITH LOCAL REQUIREMENTS AND SPECIFICATIONS.
- 12. SERVICE BOXES SHALL BE OF SUFFICIENT LENGTH TO PERMIT THE TOP TO BE INSTALLED FLUSH WITH THE FINISHED GRADE. EACH SERVICE BOX SHALL BE PROVIDED WITH A CAP WITH THE WORD "WATER" CAST IN THE TOP.
- 13. VALVES, VALVE BOXES OR VAULTS SHALL BE FURNISHED AND INSTALLED IN ACCORDANCE WITH LOCAL REQUIREMENTS.
- 14. PRESSURE CONNECTIONS TO THE EXISTING WATER MAIN SHALL BE CONSTRUCTED IN ACCORDANCE WITH LOCAL REQUIREMENTS AND SPECIFICATIONS AND SHALL INCLUDE THE INSTALLATION OF A FULL STAINLESS STEEL TAPPING SADDLE.
- 15. VALVE VAULTS SHALL HAVE A MINIMUM DIAMETER OF FIVE (5) FEET BELOW THE PRECAST CONCRETE CONE SECTION. THE VAULTS SHALL BE CONSTRUCTED OF PRECAST CONCRETE SECTIONS AND SHALL CONFORM TO THE DETAILS SPECIFIED ON THE PLANS. ALL VALVE VAULTS SHALL BE LEAK PROOF.
- 16. TEMPORARY CONNECTIONS FOR CONSTRUCTION PURPOSES TO NEWLY INSTALLED OR EXISTING WATER MAINS SHALL BE MADE AND METERED IN ACCORDANCE WITH LOCAL REQUIREMENTS.
- 17. REQUIRED RIM ADJUSTMENTS SHALL BE MADE WITH PRECAST CONCRETE ADJUSTING RINGS NOT TO EXCEED A MAXIMUM OF EIGHT (8) INCHES IN OVERALL HEIGHT. A MAXIMUM OF TWO (2) ADJUSTING RINGS ARE ALLOWED. BUTYLROPE JOINT SEALANT SHALL BE USED ON ALL JOINTS BETWEEN THE PRECAST ELEMENTS.
- 18. BENDS ON 4" AND GREATER WATER LINES SHALL BE PROVIDED WITH RESTRAINED JOINTS. (MEGALUG SERIES 2000 OR APPROVED EQUAL)

# GF

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PROJECT TEAM

ISSUE/REVISION RECORD

DATE DESCRIPTION

04/11/24 COORDINATION SET

05/22/24 PERMIT SET

06/14/24 BID SET

07/12/24 PERMIT RESPONSE

07/24/24 PERMIT RESPONSE

WATER AND SEWER SEPARATION NOTES:

SEWER, OR SEWER SERVICE CONNECTION.

CROWN OF THE SEWER; AND

PRIOR TO BACKFILLING.

SEWER OR DRAIN.

IS AT LEAST TEN (10) FEET.

1. WATER MAINS SHALL BE LOCATED AT LEAST TEN (10) FEET HORIZONTALLY FROM

2. WATER MAINS MAY BE LOCATED CLOSER THAN TEN (10) FEET TO A SEWER LINE

2.1. LOCAL CONDITIONS PREVENT A LATERAL SEPARATION OF TEN (10) FEET; AND

2.2. THE WATER MAIN INVERT IS AT LEAST EIGHTEEN (18) INCHES ABOVE THE

2.3. THE WATER MAIN IS EITHER IN A SEPARATE TRENCH OR IN THE SAME TRENCH

3. WHEN IT IS IMPOSSIBLE TO MEET 1) OR 2) ABOVE, BOTH THE WATER MAIN AND

4. WATER MAINS SHALL BE SEPARATED FROM A SEWER SO THAT ITS INVERT IS A

ON AN UNDISTURBED EARTH SHELF LOCATED TO ONE SIDE OF THE SEWER.

DRAIN OR SEWER SHALL BE CONSTRUCTED OF SLIP-ON OR MECHANICAL JOINT

CAST OR DUCTILE IRON PIPE, PRE-STRESSED CONCRETE PIPE, OR PVC PIPE

EQUIVALENT TO WATER MAIN STANDARDS OF CONSTRUCTION. THE DRAIN OR SEWER

SHALL BE PRESSURE TESTED FOR THE MAXIMUM EXPECTED SURCHARGE HEAD

MINIMUM OF EIGHTEEN (18) INCHES ABOVE THE CROWN OF THE DRAIN OR SEWER

WHENEVER WATER MAINS CROSS STORM SEWERS, SANITARY SEWERS, OR SEWER

SERVICE CONNECTIONS. THE VERTICAL SEPARATION SHALL BE MAINTAINED FOR THAT

PORTION OF THE WATER MAIN LOCATED WITHIN TEN (10) FEET HORIZONTALLY OF

ANY SEWER OR DRAIN CROSSED. A LENGTH OF WATER MAIN PIPE SHALL BE

CENTERED OVER THE SEWER TO BE CROSSED WITH JOINTS EQUIDISTANT FROM THE

MECHANICAL JOINT CAST OR DUCTILE IRON PIPE, PRE-STRESSED CONCRETE PIPE,

DESCRIBED IN 4) ABOVE; OR THE WATER MAIN PASSES UNDER A SEWER OR

OR PVC PIPE EQUIVALENT TO WATER MAIN STANDARDS OF CONSTRUCTION WHEN:

5.1. IT IS IMPOSSIBLE TO OBTAIN THE PROPER VERTICAL SEPARATION AS

6. A VERTICAL SEPARATION OF EIGHTEEN (18) INCHES BETWEEN THE INVERT OF THE

AS SHOWN ON THE PLANS OR AS APPROVED BY THE ENGINEER.

SEWER OR DRAIN AND THE CROWN OF THE WATER MAIN SHALL BE MAINTAINED

WHERE A WATER MAIN CROSSES UNDER A SEWER. THE SEWER OR DRAIN LINES

SHALL BE SUPPORTED TO PREVENT SETTLING AND BREAKING OF THE WATER MAIN.

CONSTRUCTION SHALL EXTEND ON EACH SIDE OF THE CROSSING UNTIL THE

PERPENDICULAR DISTANCE FROM THE WATER MAIN TO THE SEWER OR DRAIN LINE

5. BOTH THE WATER MAIN AND SEWER SHALL BE CONSTRUCTED OF SLIP-ON OR

ANY EXISTING OR PROPOSED DRAIN, STORM SEWER, SANITARY SEWER, COMBINED

PROFESSIONAL SEAL



PROFESSIONAL IN CHARGE ZACH MICHELS
PROFESSIONAL ENGINEER

LICENSE NO. 28488
PROJECT MANAGER
EDWARD GOSS
QUALITY CONTROL

**DRAWN BY** EC

PROJECT NAME

EDWARD GOSS

BUBBA'S 33

ALBUQUERQUE NEW MEXICO

10000 COORS BYPASS NW ALBUQUERQUE, NM 87114



**PROJECT NUMBER** 20182050 0

SHEET TITLE

NOTES

**GENERAL** 

SHEET NUMBER

C<sub>1.0</sub>

#### GENERAL DEMOLITION NOTES: CONTRACTOR SHALL CONTACT STATE ONE CALL SYSTEM (811) AND/OR PRIVATE LOCATING SERVICE TO LOCATE ALL UNDERGROUND UTILITY LINES PRIOR TO STARTING ANY DEMOLITION AND/OR EXCAVATION. EXACT LOCATIONS OF ANY EXISTING ELECTRIC, GAS, TELEPHONE, ETC. LINES ARE UNKNOWN. CONTRACTOR SHALL PERFORM ALL DEMOLITION WORK IN ACCORDANCE WITH ALL APPLICABLE FEDERAL, STATE, AND LOCAL REQUIREMENTS. CONTRACTOR SHALL OBTAIN ALL NECESSARY DEMOLITION PERMITS AND COORDINATE ALL DEMOLITION WORK WITH THE MUNICIPALITY AND OWNERS REPRESENTATIVE TO ENSURE PROTECTION AND MAINTENANCE OF EXISTING SITE FEATURES NOT NOTED ALL EROSION AND SEDIMENTATION CONTROL MEASURES AND DEVICES SHALL BE INSTALLED AND FUNCTIONAL BEFORE THE SITE IS OTHERWISE DISTURBED. THEY SHALL BE KEPT OPERATIONAL AND MAINTAINED CONTINUOUSLY THROUGHOUT THE PERIOD OF LAND DISTURBANCE UNTIL PERMANENT SITE STABILIZATION HAS BEEN ACHIEVED (SEE STORMWATER POLLUTION PREVENTION PLAN FOR ADDITIONAL INFORMATION AND DETAILS). THE PURPOSE OF THIS DRAWING IS TO CONVEY THE OVERALL SCOPE OF DEMOLITION WORK AND IT IS NOT INTENDED TO COVER ALL DETAILS OR SPECIFICATIONS REQUIRED TO COMPLY WITH GENERALLY ACCEPTED DEMOLITION PRACTICES. CONTRACTOR SHALL THOROUGHLY FAMILIARIZE HIMSELF WITH THE SITE SCOPE OF WORK, AND ALL EXISTING CONDITIONS AT THE JOB SITE PRIOR TO BIDDING AND COMMENCING THE WORK. THE DEMOLITION CONTRACTOR SHALL BE SOLELY RESPONSIBLE FOR MEANS, METHODS, TECHNIQUES, OR PROCEDURES USED TO COMPLETE THE WORK IN ACCORDANCE WITH THE CONSTRUCTION DOCUMENTS AND IS LIABLE FOR THE SAFETY OF THE PUBLIC AND CONTRACTOR'S EMPLOYEES DURING THE COURSE OF THE PROJECT. 5. THE DEMOLITION PLAN IS INTENDED TO SHOW REMOVAL OF KNOWN SITE FEATURES AND UTILITIES AS SHOWN ON THE SURVEY PROVIDED TO THE ENGINEER FOR DESIGN. THERE MAY BE OTHER SITE FEATURES, UTILITIES, STRUCTURES, AND MISCELLANEOUS ITEMS BOTH BURIED AND ABOVE GROUND THAT ARE WITHIN THE LIMITS OF WORK THAT MAY REQUIRE REMOVAL FOR THE PROPOSED SITE IMPROVEMENTS BUT THAT ARE NOT SHOWN HEREON. THE CONTRACTOR IS RESPONSIBLE FOR THE REMOVAL OF SUCH ITEMS AT NO ADDITIONAL COST TO THE CONTRACTOR SHALL CONTACT THE RESPECTIVE UTILITY COMPANIES PRIOR TO COMMENCING ANY SITE DEMOLITION OPERATIONS TO COORDINATE DISCONNECTION AND REMOVAL OF EXISTING UTILITIES WITHIN THE PROPOSED AREA OF WORK. CONTRACTOR SHALL ALSO CONTACT CAITLIN DAWSON WITH TEXAS ROADHOUSE (502-855-5556 OR CAITLIN.DAWSON@TEXASROADHOUSE.COM) TO COORDINATE DISCONNECTION OF THE EXISTING BUILDING TELEPHONE SERVICE . CONTRACTOR SHALL COORDINATE ANY SHUT DOWNS OF EXISTING ROADWAYS AND UTILITIES WITH THE NECESSARY GOVERNING AUTHORITIES. ). ALL EXISTING BUILDINGS, FOUNDATIONS, CONCRETE OR ASPHALT PAVEMENT OR WALKS, CURB AND GUTTER AND MISCELLANEOUS STRUCTURES (INCLUDING, BUT NOT LIMITED TO FENCES, POLES, YARD LIGHTS, ELECTRICAL PANELS, WHEEL STOPS AND MISCELLANEOUS DEBRIS) NOTED TO BE REMOVED SHALL BE DEMOLISHED, REMOVED FROM THE SITE AND LEGALLY DISPOSED OF BY THE CONTRACTOR. VOIDS LEFT BY ANY ITEM REMOVED UNDER ANY PROPOSED BUILDINGS, PAVEMENTS, OR WALKS OR WITHIN 24" THEREOF SHALL BE BACKFILLED IN ACCORDANCE WITH THE PROJECT SPECIFICATIONS AND GEOTECHNICAL REPORT. 11. AS SOON AS DEMOLITION WORK HAS BEEN COMPLETED, FINAL GRADE OF BACKFILL IN DEMOLITION AREAS SHALL BE COMPACTED PER THE GEOTECHNICAL REPORT TO PRESENT A NEAT, WELL DRAINED APPEARANCE, AND TO PREVENT WATER FROM DRAINING UNNECESSARILY ONTO ADJACENT PROPERTIES. CONTRACTOR SHALL PROVIDE TEMPORARY DIVERSION SWALES OR OTHER MEANS OF MAINTAINING ADEQUATE SITE DRAINAGE. 12. ALL EXISTING TREES SHOWN ARE TO REMAIN UNLESS OTHERWISE NOTED (REFER TO LANDSCAPE PLANS FOR ALL LANDSCAPING REMOVAL REQUIREMENTS). 13. ALL EXISTING TREES, BRUSH AND MISCELLANEOUS VEGETATION NÓTED TO BE REMOVED SHALL BE REMOVED FROM THE SITE AND DISPOSED OF BY THE OWNER AND/OR ENGINEER. OWNER AND/OR ENGINEER. 16. ALL FIRE ACCESS LANES WITHIN THE PROJECT AREA SHALL REMAIN IN SERVICE. CLEAN OF DEBRIS, AND ACCESSIBLE FOR USE BY EMERGENCY VEHICLES.


CONTRACTOR (REFER TO LANDSCAPE PLANS FOR ALL LANDSCAPING REMOVAL 14. CONTRACTOR SHALL UTILIZE CARE WHEN WORKING NEAR EXISTING UTILITIES TO REMAIN. ANY DAMAGE TO EXISTING UTILITIES NOT NOTED TO BE REMOVED SHALL BE REPAIRED AT CONTRACTOR'S EXPENSE AND TO THE SATISFACTION OF THE

15. CONTRACTOR SHALL REPAIR AT HIS EXPENSE ANY DAMAGE TO EXISTING ASPHALT. CONCRETE, CURBS, SIDEWALKS, ETC. RESULTING FROM CONSTRUCTION TRAFFIC AND/OR OPERATIONS. REPAIRS SHALL BE MADE TO THE SATISFACTION OF THE

17. ALL EXISTING SANITARY SEWERS, STORM SEWERS, WATER MAINS OR IRRIGATION LINES AND APPURTENANCES NOTED FOR REMOVAL WITHIN THE AREA OF THE PROPOSED CONSTRUCTION SHALL BE REMOVED FROM THE SITE AND DISPOSED OF BY THE CONTRACTOR. ALL ABANDONED SEWER LINES SHALL BE PLUGGED AT BOTH ENDS WITH A MINIMUM OF TWO (2) FEET LONG NON-SHRINK CONCRETE MORTAR PLUGS UNLESS OTHERWISE

18. CONTRACTOR SHALL MAKE NECESSARY ARRANGEMENTS TO HAVE RECYCLABLE MATERIALS REMOVED FROM THE SITE AND RECYCLED.

19. SEE GENERAL NOTES SHEET FOR ADDITIONAL INFORMATION AND REQUIREMENTS.

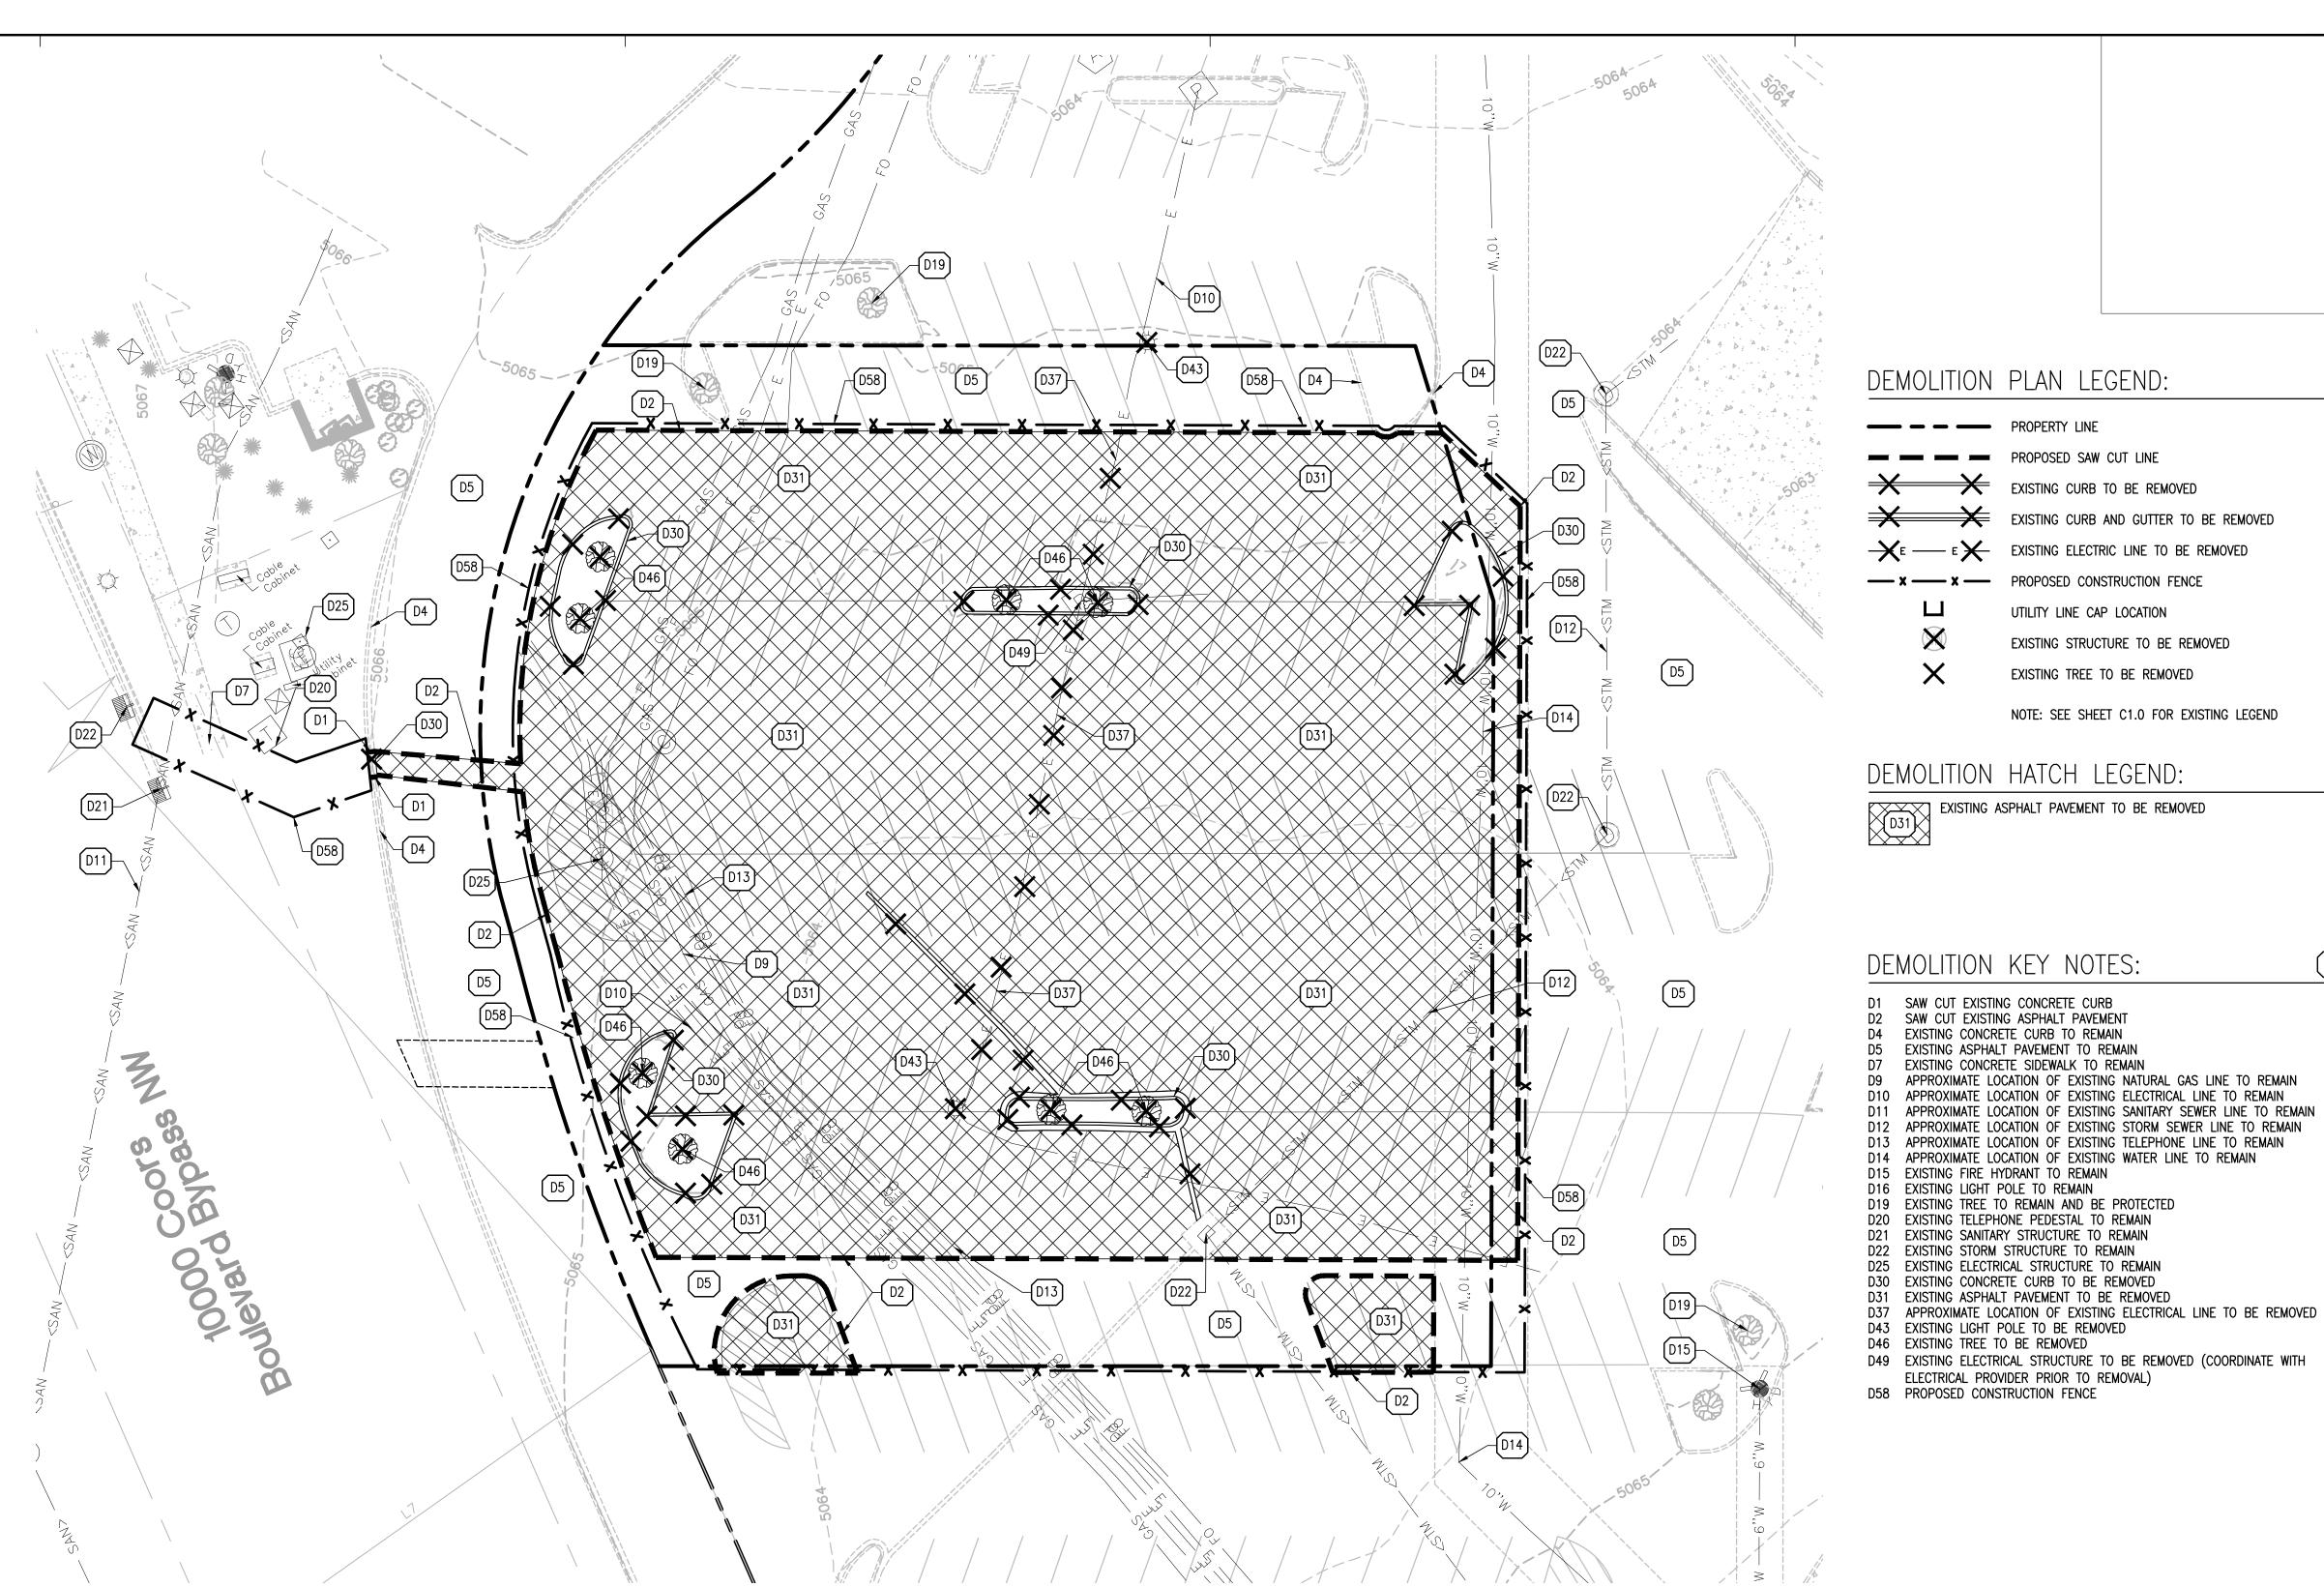



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PROJECT TEAM

**ISSUE/REVISION RECORD** 

04/11/24 COORDINATION SET 05/22/24 PERMIT SET 06/14/24 BID SET 07/12/24 PERMIT RESPONSE 07/24/24 PERMIT RESPONSE

**PROFESSIONAL SEAL** 

PROFESSIONAL IN CHARGE **ZACH MICHELS** PROFESSIONAL ENGINEER LICENSE NO. 28488

PROJECT MANAGER EDWARD GOSS **QUALITY CONTROL** EDWARD GOSS DRAWN BY

**PROJECT NAME** 

BUBBA'S 33

**ALBUQUERQUE** 

**NEW MEXICO** 

**10000 COORS BYPASS NW ALBUQUERQUE, NM 87114** 




PROJECT NUMBER 20182050 0

SHEET TITLE

**DEMOLITION PLAN** 

**SHEET NUMBER** 

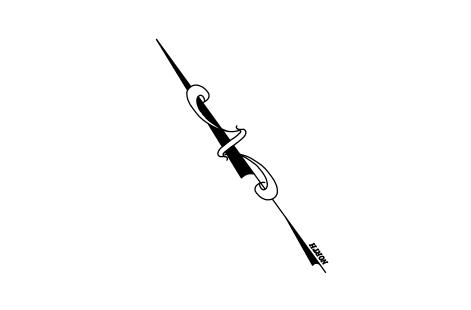

ELECTRICAL PROVIDER PRIOR TO REMOVAL)

- PROPERTY LINE

PROPOSED SAW CUT LINE

UTILITY LINE CAP LOCATION

EXISTING TREE TO BE REMOVED

EXISTING ASPHALT PAVEMENT TO BE REMOVED

EXISTING CURB TO BE REMOVED

EXISTING CURB AND GUTTER TO BE REMOVED


EXISTING ELECTRIC LINE TO BE REMOVED

EXISTING STRUCTURE TO BE REMOVED

NOTE: SEE SHEET C1.0 FOR EXISTING LEGEND

GRAPHIC SCALE ( IN FEET ) 1 inch = 20 ft.



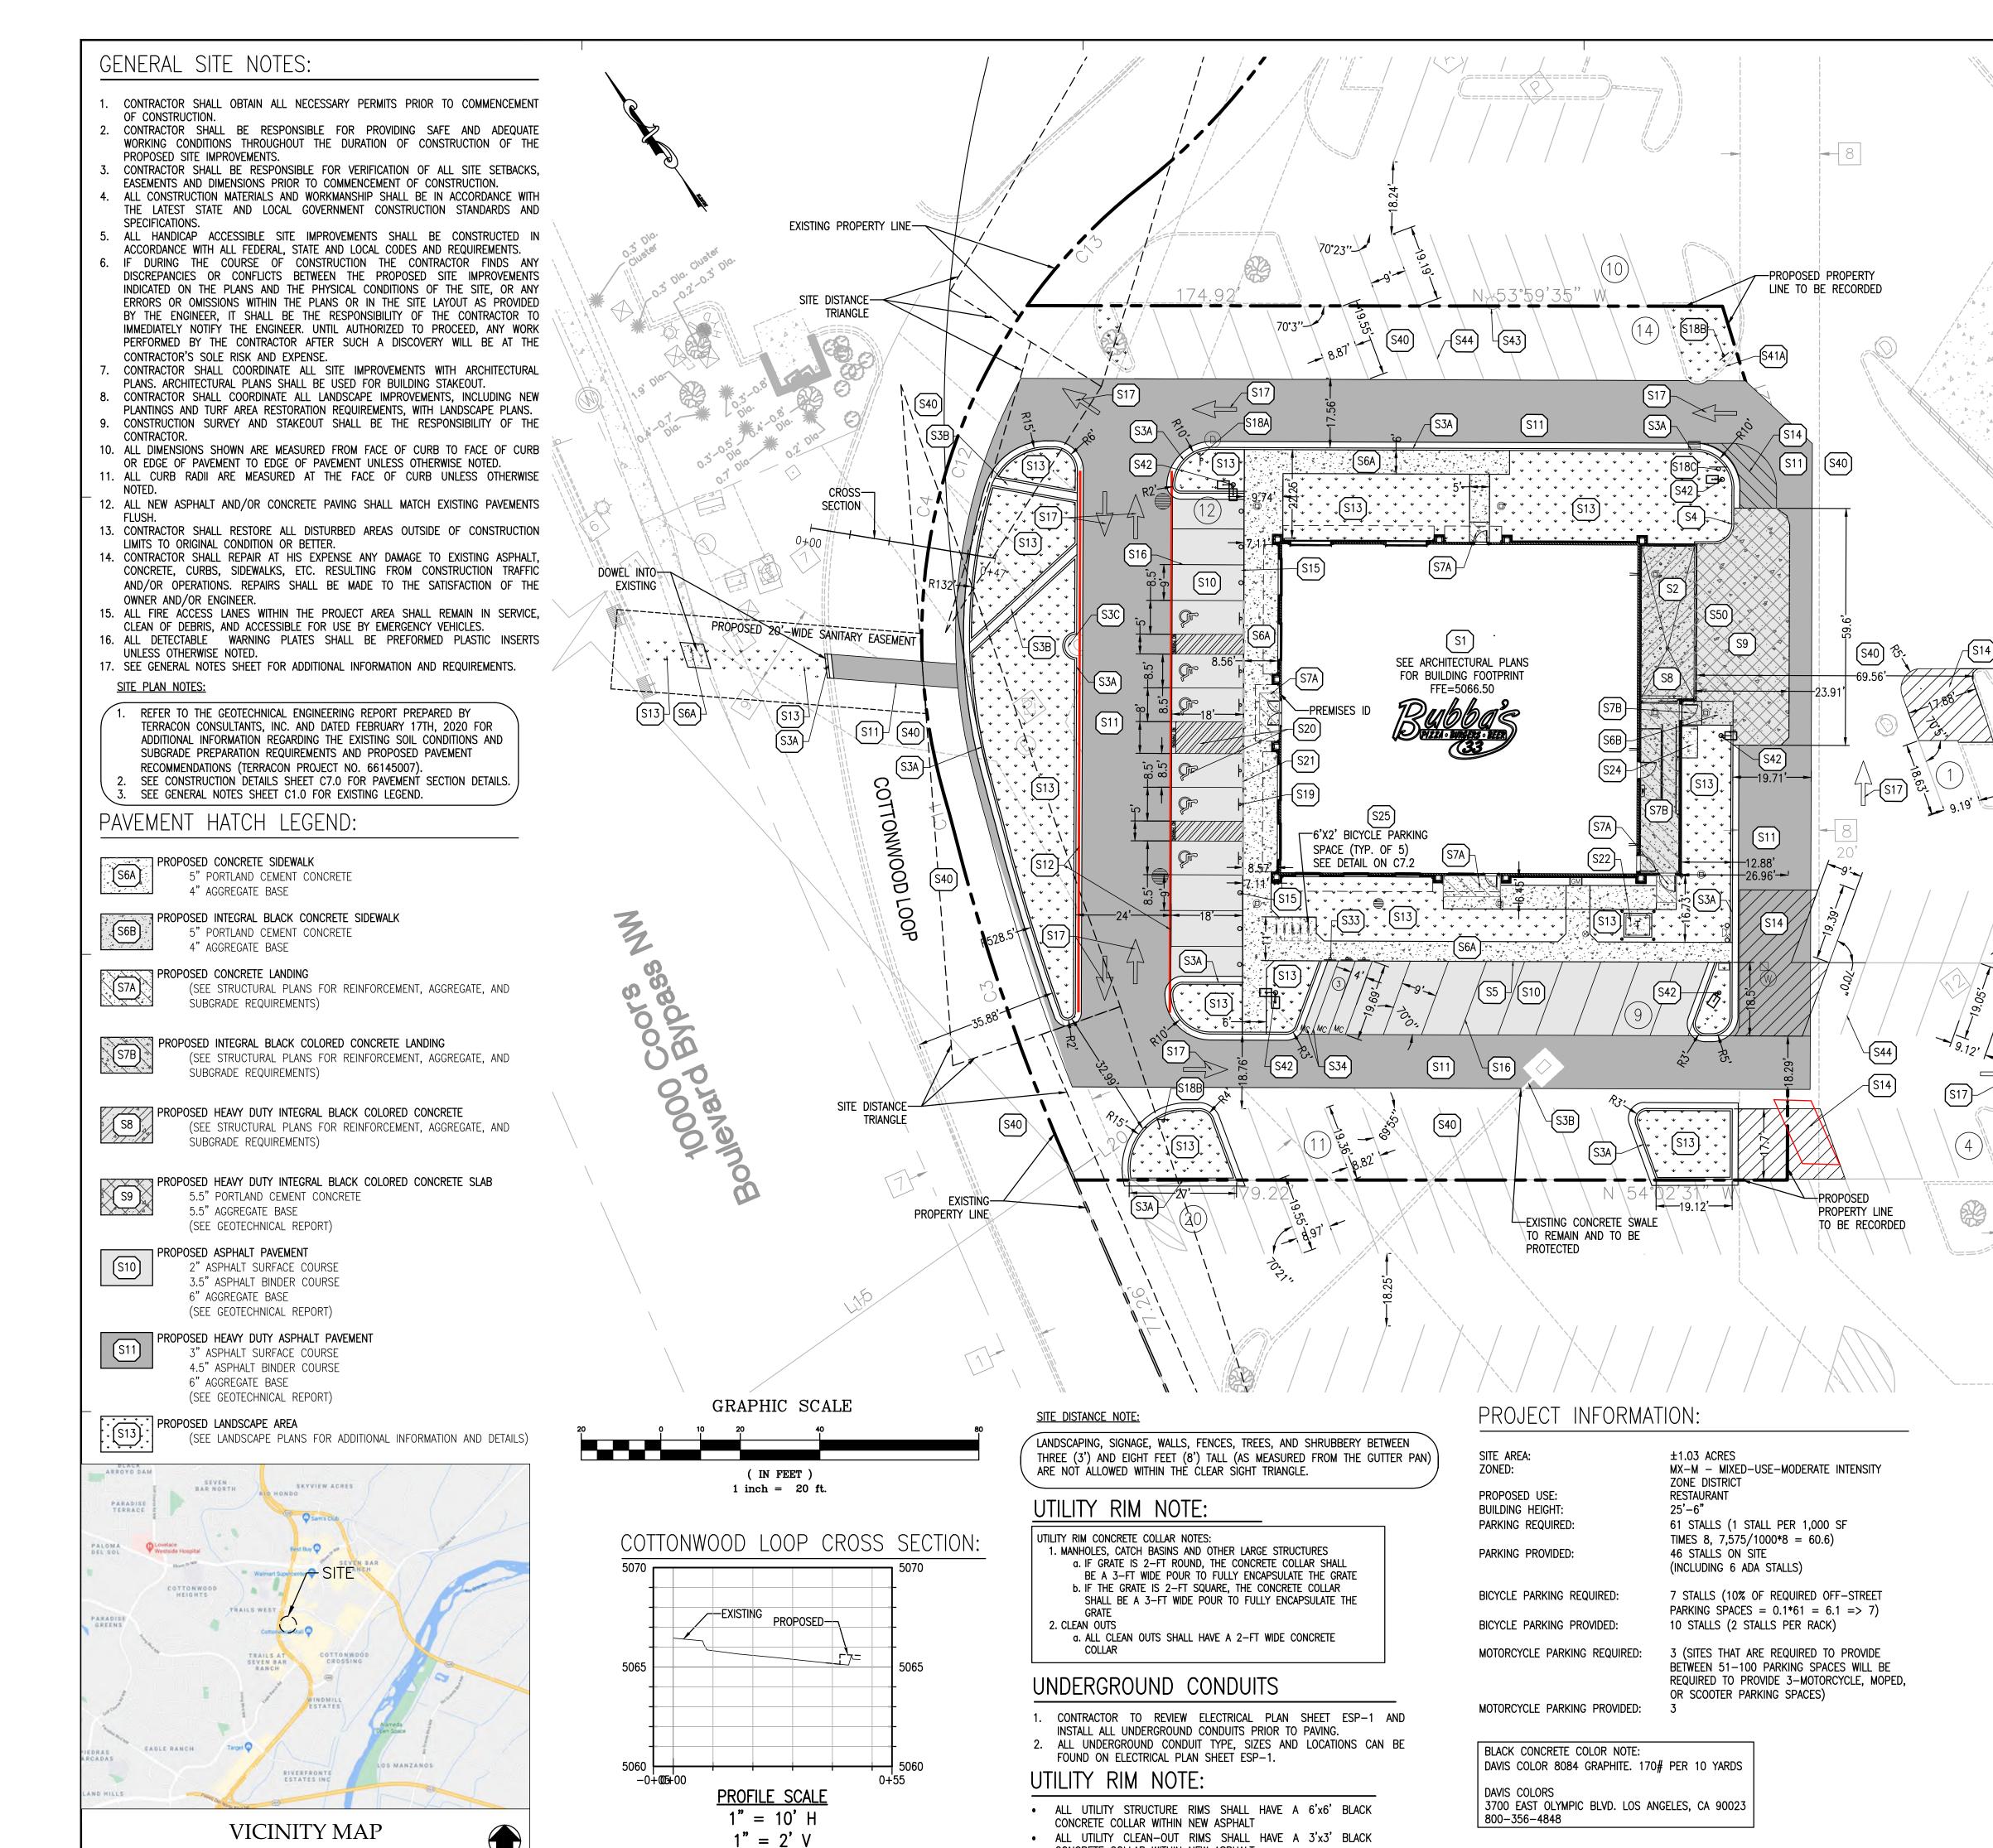

CONCRETE COLLAR WITHIN NEW ASPHALT

www.greenbergfarrow.com

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PROJECT TEAM

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**PROJECT NAME** 

EDWARD GOSS **QUALITY CONTROL** EDWARD GOSS DRAWN BY

PROPOSED HEAVY DUTY INTEGRAL BLACK COLORED CONCRETE SLAB (SEE GEOTECHNICAL REPORT FOR ADDITIONAL INFORMATION AND DETAILS, SEE DETAIL ON SHEET C7.0)

S10 PROPOSED ASPHALT PAVEMENT (SEE GEOTECHNICAL REPORT FOR ADDITIONAL INFORMATION AND DETAILS, SEE DETAIL ON SHEET C7.0) S11 PROPOSED HEAVY DUTY ASPHALT PAVEMENT (SEE GEOTECHNICAL REPORT FOR

STRUCTURAL S8 DUMPSTER ENCLOSURE PLANS FOR ADDITIONAL INFORMATION

ADDITIONAL INFORMATION AND DETAILS, SEE DETAIL ON SHEET C7.0) S12 PROPOSED FIRE LANE STRIPING PER LOCAL CODE

S13 PROPOSED LANDSCAPE AREA (SEE LANDSCAPE PLANS FOR ADDITIONAL INFORMATION AND DETAILS)

S14 PROPOSED STRIPED ISLAND PER LOCAL CODE S15 PROPOSED CONCRETE BOLLARD AT FLUSH CURB (TYP. OF 6, SEE DETAIL ON

PROPOSED LEGEND

PROPERTY LINE

PROPOSED FLUSH CURB

PROPOSED CONCRETE CURB AND GUTTER

PROPOSED PARKING STALL COUNT

PROPOSED CONCRETE WHEEL STOP

PROPOSED STORM SEWER STRUCTURES

PROPOSED SANITARY SEWER GREASE INTERCEPTOR

PROPOSED FIRE DEPARTMENT CONNECTION (FDC)

PROPOSED TRANSFORMER PAD AND STEEL BOLLARDS

PROPOSED ELECTRIC METER, CT CABINET AND DISCONNECT

PROPOSED SANITARY SEWER STRUCTURES

PROPOSED WATER SERVICE TAP

S1 PROPOSED BUBBA'S 33 BUILDING (SEE ARCHITECTURAL AND STRUCTURAL

S3A PROPOSED CONCRETE CURB AND GUTTER (SEE DETAIL ON SHEET C7.0) S3B PROPOSED 1.5' WIDE CONCRETE SWALE (SEE DETAIL ON SHEET C7.1)

PROPOSED CONCRETE BARRIER CURB (SEE DETAIL ON SHEET C7.0)

S6B PROPOSED INTEGRAL BLACK CONCRETE SIDEWALK (SEE DETAIL ON SHEET

S7A PROPOSED CONCRETE LANDING (SEE STRUCTURAL PLANS FOR ADDITIONAL

S8 PROPOSED HEAVY DUTY INTEGRAL BLACK COLORED CONCRETE (SEE THE

S7B PROPOSED INTEGRAL BLACK COLORED CONCRETE LANDING (SEE STRUCTURAL

PROPOSED MONOLITHIC CONCRETE CURB AND SIDEWALK (SEE DETAIL ON

S3C PROPOSED CURB TO EYEBROW AROUND EXISTING UTILITY STRUCTURE

S6A PROPOSED CONCRETE SIDEWALK (SEE DETAIL ON SHEET C7.0)

PLANS FOR ADDITIONAL INFORMATION AND DETAILS)

PROPOSED TRASH ENCLOSURE (SEE ARCHITECTURAL AND STRUCTURAL PLANS

PROPOSED GAS METER

PLANS FOR ADDITIONAL INFORMATION AND DETAILS)

FOR ADDITIONAL INFORMATION AND DETAILS)

SITE KEY NOTES

INFORMATION AND DETAILS)

AND DETAILS)

PROPOSED SIGN

PROPOSED PYLON SIGN

PROPOSED LIGHT POLE

SHEET C7.1) S16 PROPOSED 4" WHITE PAVEMENT STRIPING PER LOCAL CODE

S17 PROPOSED DIRECTIONAL TRAFFIC ARROW (SEE DETAIL ON SHEET C7.0) S18A PROPOSED 30" R5-1 "DO NOT ENTER" SIGN (SEE DETAILS ON SHEET C7.2)

S18B PROPOSED 24"X36" R6-2L "ONE WAY" SIGN (SEE DETAILS ON SHEET C7.2) S18C PROPOSED 24"X36" R6-2R "ONE WAY" SIGN (SEE DETAILS ON SHEET C7.2) S19 PROPOSED HANDICAP ACCESSIBLE PARKING SIGN PER LOCAL CODE,

66-7-352.4C NMSA 1978 (TYP. OF 6, SEE DETAIL ON SHEET C7.0) S20 PROPOSED BLUE HANDICAP ACCESSIBLE PARKING STALL STRIPING AND SYMBOL PER LOCAL CODE, 66-1-4.1.B NMSA 1978 (TYP., SEE DETAIL ON

SHEET C7.0) S21 PROPOSED PAVEMENT TO FLUSH WITH PROPOSED SIDEWALK PER ADA REQUIMENTS

S22 PROPOSED CONCRETE TRANSFORMER PAD WITH STEEL BOLLARD PROTECTION

(CONTRACTOR SHALL COORDINATE CONCRETE TRANSFORMER PAD LOCATION, SIZE AND THICKNESS WITH ELECTRIC COMPANY PRIOR TO INSTALLATION)

S24 PROPOSED 4'x8' CONCRETE PAD WITH 1 PERCENT MAX. CROSS SLOPE S25 PROPOSED MAGLIN MBR501 BIKE RACKS WITH BLACK POWDER COATED FINISH (TOTAL OF 5 BIKE RACKS PROVIDING 10 BICYCLE PARKING SPACES - SEE DETAIL ON SHEET C7.2)

S33 PROPOSED MOTORCYCLÉ PARKING SIGN PER THE CITY OF ALBUQUERQUE ZONING CODE (TYP. OF 3, SEE DETAIL ON SHEET C7.2)

S34 PROPOSED MOTORCYCLE PARKING STALLS TO HAVE "MC" PAINTED IN WHITE AT THE REAR OF THE PARKING STALLS PER THE CITY OF ALBUQUERQUE ZONING CODE (TYP. OF 3).

S35 CURB TRANSITION FOR 0" TO 6" IN HEIGHT S40 EXISTING ASPHALT PAVEMENT TO REMAIN

S41A EXISTING CONCRETE CURB AND GUTTER TO REMAIN

S42 PROPOSED LIGHT POLE S43 EXISTING LIGHT POLE TO REMAIN

S44 EXISTING PAVEMENT STRIPING TO REMAIN S50 THE SLOPE IS GREATER THAN #" PER FOOT ON THE APPROACH MEASURING 37'TO THE FACE OF TRASH ENCLOSURE. SINCE SLOPE IS GRATER THAN AN 1" PER FOOT, SHIMS SHALL BE PUT ON THE BOTTOM OF THE DUMPSTERS

BUBBA'S 33

**ALBUQUERQUE NEW MEXICO** 

**10000 COORS BYPASS NW ALBUQUERQUE, NM 87114** 



PROJECT NUMBER

**SHEET TITLE** SITE

**PLAN** 

#### **GENERAL GRADING NOTES:** ALL GRADING AND SITE PREPARATION WORK SHALL CONFORM WITH THE RECOMMENDATIONS AND SPECIFICATIONS CONTAINED IN THE GEOTECHNICAL REPORT. CONTRACTOR SHALL CAREFULLY PRESERVE ALL SITE BENCHMARKS AND REFERENCE POINTS DURING CONSTRUCTION OPERATIONS. CONTRACTOR IS SPECIFICALLY CAUTIONED THAT THE LOCATION AND/OR ELEVATION OF EXISTING UTILITIES AS SHOWN ON THESE PLANS IS BASED ON RECORDS OF THE VARIOUS UTILITY COMPANIES AND, WHERE POSSIBLE, MEASUREMENTS TAKEN IN THE FIELD. THE INFORMATION IS NOT TO BE RELIED ON AS BEING EXACT OR COMPLETE. THE CONTRACTOR MUST CALL THE LOCAL UTILITY LOCATION CENTER AT LEAST FORTY-EIGHT (48) HOURS BEFORE ANY EXCAVATION TO REQUEST EXACT FIELD LOCATIONS OF THE UTILITIES. IT SHALL BE THE RESPONSIBILITY OF THE CONTRACTOR TO RELOCATE ALL EXISTING UTILITIES WHICH CONFLICT WITH THE PROPOSED SITE IMPROVEMENTS SHOWN ON THE PLANS. -. CONTRACTOR SHALL INSTALL APPROPRIATE TREE PROTECTION MEASURES PRIOR TO COMMENCEMENT OF SITE GRADING OPERATIONS. EXISTING GRADES FLUSH. CONTRACTOR SHALL ENSURE POSITIVE DRAINAGE TO ALL STORM DRAINAGE

5. ALL PROPOSED GRADING, PAVEMENT, APRONS, CURBS, WALKS, ETC. SHALL MATCH

STRUCTURES. AREAS OF SURFACE PONDING SHALL BE CORRECTED BY THE CONTRACTOR AT NO ADDITIONAL EXPENSE TO THE OWNER.

ALL EXISTING AND PROPOSED TOP OF FRAME ELEVATIONS FOR STORM, SANITARY, WATER AND OTHER UTILITY STRUCTURES SHALL BE ADJUSTED TO MEET FINISHED GRADE WITHIN THE PROJECT LIMITS. 8. CONTRACTOR SHALL UTILIZE CARE WHEN WORKING NEAR EXISTING UTILITIES TO

BE REPAIRED AT THE CONTRACTOR'S EXPENSE AND TO THE SATISFACTION OF THE OWNER AND/OR ENGINEER. CONTRACTOR SHALL REPAIR AT HIS EXPENSE ANY DAMAGE TO EXISTING ASPHALT, CONCRETE, CURBS, SIDEWALKS, ETC. RESULTING FROM CONSTRUCTION TRAFFIC AND/OR OPERATIONS. REPAIRS SHALL BE MADE TO THE SATISFACTION OF THE

OWNER AND/OR ENGINEER. 10. CONTRACTOR SHALL RESTORE ALL DISTURBED AREAS OUTSIDE OF CONSTRUCTION LIMITS TO ORIGINAL CONDITION OR BETTER.

11. MAXIMUM CROSS SLOPES AND LONGITUDINAL SLOPES FOR ALL CONCRETE SIDEWALKS AND HANDICAP ACCESSIBLE ROUTES SHALL NOT EXCEED 2% AND 5%,

12. MAXIMUM SLOPES WITHIN THE HANDICAP ACCESSIBLE PARKING AREAS SHALL NOT EXCEED 2% IN ANY DIRECTION.

13. MAXIMUM GRADE DIFFERENCE BETWEEN PAVEMENT SURFACES AND ADJACENT CONCRETE SIDEWALKS FOR THE ACCESSIBLE ROUTE TO THE BUILDING SHALL NOT EXCEED 1/4" VERTICAL OR 1/2" WHEN BEVELED.

14. ALL HANDICAP ACCESSIBLE EXTERIOR DOORWAY LOCATIONS REQUIRE AN EXTERIOR LANDING THAT IS A MINIMUM OF FIVE (5) FEET IN LENGTH WITH A SLOPE NOT EXCEEDING 2% IN ANY DIRECTION.

15. EXCAVATION SHORING SHALL BE DONE AS NECESSARY FOR THE PROTECTION OF THE WORK AND FOR THE SAFETY OF PERSONNEL. SHORING SHALL BE IN ACCORDANCE WITH ALL O.S.H.A AND LOCAL REGULATIONS

16. ALL STRUCTURE BENCH WALLS SHALL BE SHAPED AND FORMED FOR A CLEAN TRANSITION WITH PROPER HYDRAULICS TO ALLOW THE SMOOTH CONVEYANCE OF FLOWS THROUGH THE MANHOLE OR BOX INLET. THE BENCH WALL SHALL FORM A DEFINED CHANNEL, TO A MINIMUM HEIGHT OF 80-PERCENT OF THE INSIDE DIAMETER OF THE INLET AND OUTLET PIPES TO FORM A "U" SHAPED CHANNEL CONSTRUCTED AT A MINIMUM 1/2-INCH PER FOOT SLOPE TO THE MANHOLE WALL. 17. ALL STORM WATER INLETS AND CATCH BASIN CASTINGS SHALL HAVE THE WORDS

"NO DUMPING, DRAINS TO STREAM", OR SIMILARLY APPROVED MESSAGE, CAST IN RAISED OR RECESSED LETTERS AT A MINIMUM OF 1" IN HEIGHT. IN ADDITION, A SYMBOL OF A FISH SHALL ALSO BE CAST WITH THE LETTERS.

18. SEE GENERAL NOTES SHEET FOR ADDITIONAL INFORMATION AND REQUIREMENTS.

## PROJECT BENCHMARKS:

#### SITE BENCHMARKS:

BM #1 ACS MONUMENT "10-B13" ELEVATION= 5074.478 (NAVD 88)

BM #2 ACS MONUMENT "8-B13" ELEVATION= 5059.673 (NAVD 88)

## FLOOD NOTE:

PROJECT SITE DOES NOT LIE WITHIN A 100 YEAR FLOOD HAZARD AREA AND IS LOCATED IN ZONE "X" AS SHOWN ON THE ABOVE FEDERAL EMERGENCY MANAGEMENT AGENCY FLOOD INSURANCE RATE MAP NUMBER 35001C0108G WITH AN EFFECTIVE DATE OF SEPTEMBER 26, 2008.

## UTILITY RIM NOTE:

UTILITY RIM CONCRETE COLLAR NOTES: . MANHOLES, CATCH BASINS AND OTHER LARGE STRUCTURES

a. IF GRATE IS 2-FT ROUND, THE CONCRETE COLLAR SHALL BE A 3-FT WIDE POUR TO FULLY ENCAPSULATE THE GRATE

b. IF THE GRATE IS 2-FT SQUARE, THE CONCRETE COLLAR SHALL BE A 3-FT WIDE POUR TO FULLY ENCAPSULATE THE 2. CLEAN OUTS

a. ALL CLEAN OUTS SHALL HAVE A 2-FT WIDE CONCRETE

## UNDERGROUND CONDUITS


CONTRACTOR TO REVIEW ELECTRICAL PLAN SHEET ESP-1 AND INSTALL ALL UNDERGROUND CONDUITS PRIOR TO PAVING.

2. ALL UNDERGROUND CONDUIT TYPE, SIZES AND LOCATIONS CAN BE FOUND ON ELECTRICAL PLAN SHEET ESP-1.

## UTILITY RIM NOTE:

 ALL UTILITY STRUCTURE RIMS SHALL HAVE A 6'x6' BLACK CONCRETE COLLAR WITHIN NEW ASPHALT

• ALL UTILITY CLEAN-OUT RIMS SHALL HAVE A 3'x3' BLACK CONCRETE COLLAR WITHIN NEW ASPHALT

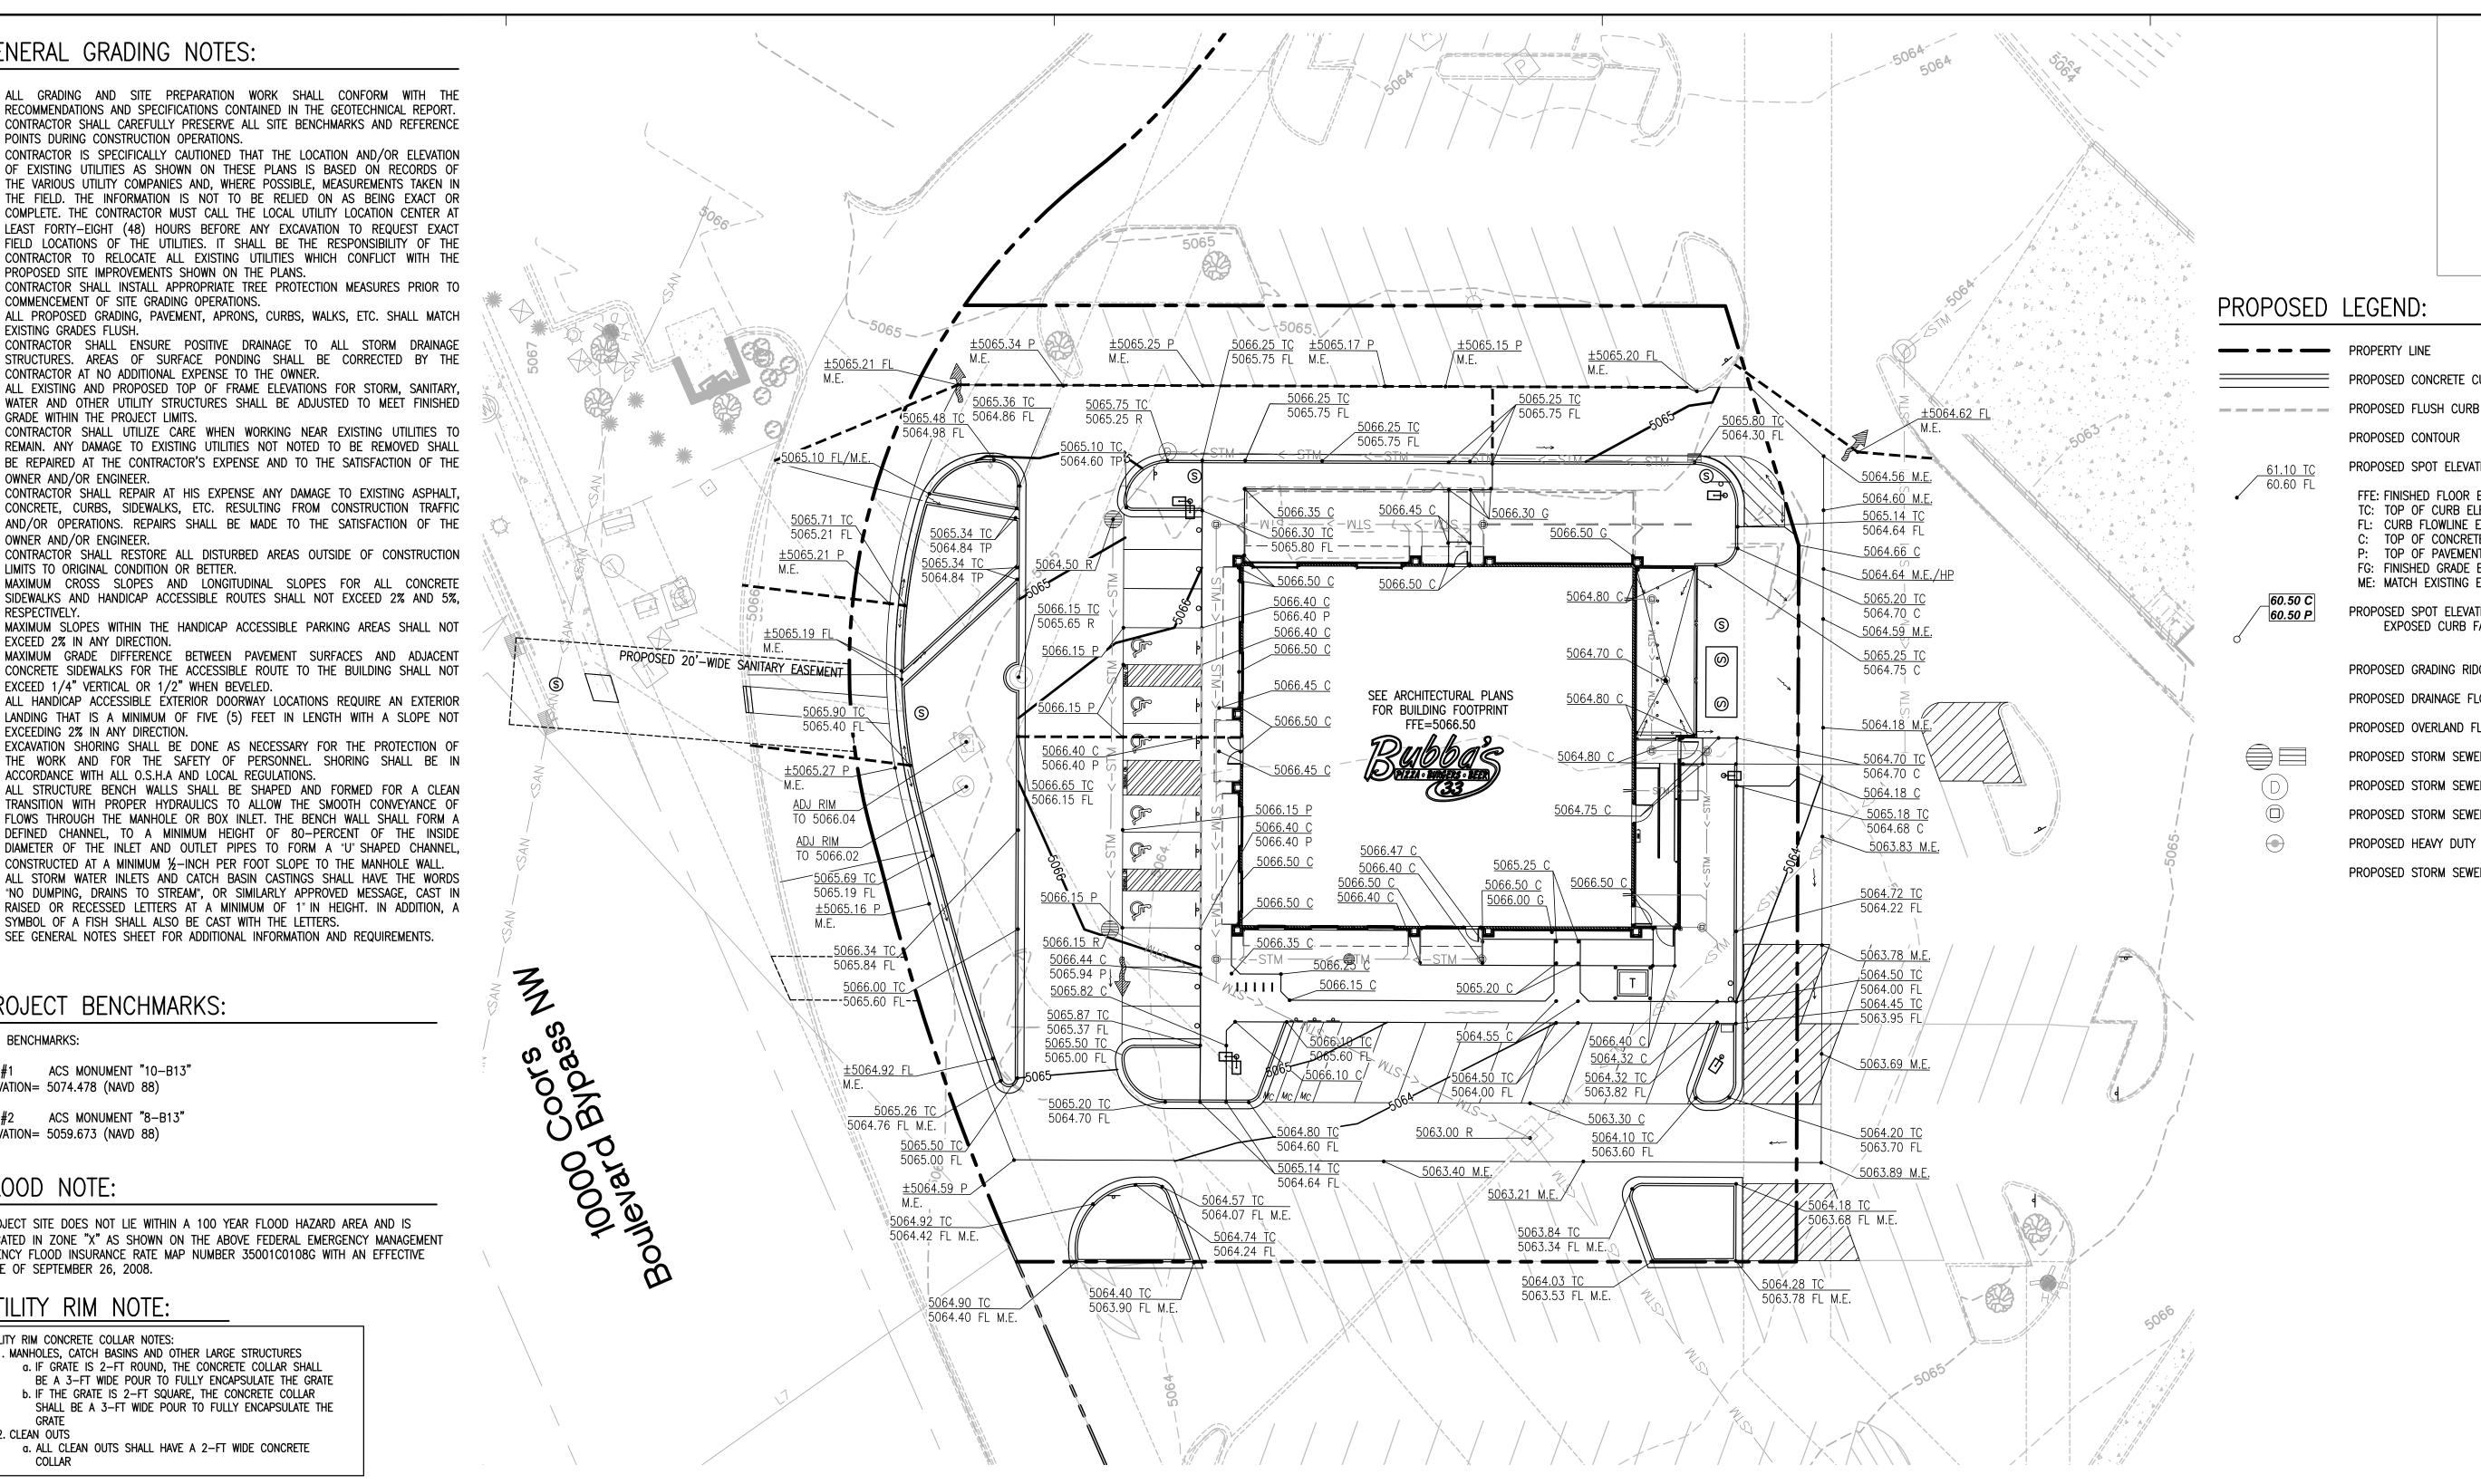



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**PROFESSIONAL SEAL** 



PROFESSIONAL IN CHARGE **ZACH MICHELS** PROFESSIONAL ENGINEER LICENSE NO. 28488

**PROJECT MANAGER** EDWARD GOSS **QUALITY CONTROL** EDWARD GOSS DRAWN BY

PROJECT NAME

BUBBA'S 33

**ALBUQUERQUE NEW MEXICO** 

**10000 COORS BYPASS NW ALBUQUERQUE, NM 87114** 



PROJECT NUMBER 20182050 0

SHEET TITLE **GRADING PLAN** 

**SHEET NUMBER** 



GRAPHIC SCALE

( IN FEET ) 1 inch = 20 ft.

PROPOSED CONCRETE CURB AND GUTTER

PROPOSED CONTOUR

PROPOSED SPOT ELEVATION

FFE: FINISHED FLOOR ELEVATION

TC: TOP OF CURB ELEVATION

FL: CURB FLOWLINE ELEVATION

C: TOP OF CONCRETE ELEVATION

P: TOP OF PAVEMENT ELEVATION

EXPOSED CURB FACE VARIES

FG: FINISHED GRADE ELEVATION

ME: MATCH EXISTING ELEVATION

PROPOSED SPOT ELEVATION

PROPOSED GRADING RIDGE LINE

PROPOSED DRAINAGE FLOW DIRECTION

PROPOSED OVERLAND FLOOD ROUTE

PROPOSED STORM SEWER CLEAN OUT

PROPOSED HEAVY DUTY AREA DRAIN

PROPOSED STORM SEWER

PROPOSED STORM SEWER STRUCTURE WITH OPEN GRATE

PROPOSED STORM SEWER STRUCTURE WITH CLOSED LID

## **GENERAL GRADING NOTES:** 1. ALL GRADING AND SITE PREPARATION WORK SHALL CONFORM WITH THE RECOMMENDATIONS AND SPECIFICATIONS CONTAINED IN THE GEOTECHNICAL REPORT. CONTRACTOR SHALL CAREFULLY PRESERVE ALL SITE BENCHMARKS AND REFERENCE POINTS DURING CONSTRUCTION OPERATIONS. CONTRACTOR IS SPECIFICALLY CAUTIONED THAT THE LOCATION AND/OR ELEVATION OF EXISTING UTILITIES AS SHOWN ON THESE PLANS IS BASED ON RECORDS OF THE VARIOUS UTILITY COMPANIES AND, WHERE POSSIBLE, MEASUREMENTS TAKEN IN THE FIELD. THE INFORMATION IS NOT TO BE RELIED ON AS BEING EXACT OR COMPLETE. THE CONTRACTOR MUST CALL THE LOCAL UTILITY LOCATION CENTER AT LEAST FORTY-EIGHT (48) HOURS BEFORE ANY EXCAVATION TO REQUEST EXACT FIELD LOCATIONS OF THE UTILITIES. IT SHALL BE THE RESPONSIBILITY OF THE CONTRACTOR TO RELOCATE ALL EXISTING UTILITIES WHICH CONFLICT WITH THE PROPOSED SITE IMPROVEMENTS SHOWN ON THE PLANS. COMMENCEMENT OF SITE GRADING OPERATIONS. EXISTING GRADES FLUSH.

- -. CONTRACTOR SHALL INSTALL APPROPRIATE TREE PROTECTION MEASURES PRIOR TO ALL PROPOSED GRADING, PAVEMENT, APRONS, CURBS, WALKS, ETC. SHALL MATCH
- 3. CONTRACTOR SHALL ENSURE POSITIVE DRAINAGE TO ALL STORM DRAINAGE STRUCTURES. AREAS OF SURFACE PONDING SHALL BE CORRECTED BY THE CONTRACTOR AT NO ADDITIONAL EXPENSE TO THE OWNER.
- ALL EXISTING AND PROPOSED TOP OF FRAME ELEVATIONS FOR STORM, SANITARY WATER AND OTHER UTILITY STRUCTURES SHALL BE ADJUSTED TO MEET FINISHED GRADE WITHIN THE PROJECT LIMITS. 8. CONTRACTOR SHALL UTILIZE CARE WHEN WORKING NEAR EXISTING UTILITIES TO
- REMAIN. ANY DAMAGE TO EXISTING UTILITIES NOT NOTED TO BE REMOVED SHALL BE REPAIRED AT THE CONTRACTOR'S EXPENSE AND TO THE SATISFACTION OF THE CONTRACTOR SHALL REPAIR AT HIS EXPENSE ANY DAMAGE TO EXISTING ASPHALT CONCRETE, CURBS, SIDEWALKS, ETC. RESULTING FROM CONSTRUCTION TRAFFIC
- AND/OR OPERATIONS. REPAIRS SHALL BE MADE TO THE SATISFACTION OF THE OWNER AND/OR ENGINEER. 10. CONTRACTOR SHALL RESTORE ALL DISTURBED AREAS OUTSIDE OF CONSTRUCTION
- LIMITS TO ORIGINAL CONDITION OR BETTER. 11. MAXIMUM CROSS SLOPES AND LONGITUDINAL SLOPES FOR ALL CONCRETE SIDEWALKS AND HANDICAP ACCESSIBLE ROUTES SHALL NOT EXCEED 2% AND 5%,
- 12. MAXIMUM SLOPES WITHIN THE HANDICAP ACCESSIBLE PARKING AREAS SHALL NOT EXCEED 2% IN ANY DIRECTION.
- 13. MAXIMUM GRADE DIFFERENCE BETWEEN PAVEMENT SURFACES AND ADJACENT CONCRETE SIDEWALKS FOR THE ACCESSIBLE ROUTE TO THE BUILDING SHALL NOT EXCEED 1/4" VERTICAL OR 1/2" WHEN BEVELED.
- 14. ALL HANDICAP ACCESSIBLE EXTERIOR DOORWAY LOCATIONS REQUIRE AN EXTERIOR LANDING THAT IS A MINIMUM OF FIVE (5) FEET IN LENGTH WITH A SLOPE NOT EXCEEDING 2% IN ANY DIRECTION.
- 15. EXCAVATION SHORING SHALL BE DONE AS NECESSARY FOR THE PROTECTION OF THE WORK AND FOR THE SAFETY OF PERSONNEL. SHORING SHALL BE IN ACCORDANCE WITH ALL O.S.H.A AND LOCAL REGULATIONS
- 16. ALL STRUCTURE BENCH WALLS SHALL BE SHAPED AND FORMED FOR A CLEAN TRANSITION WITH PROPER HYDRAULICS TO ALLOW THE SMOOTH CONVEYANCE OF FLOWS THROUGH THE MANHOLE OR BOX INLET. THE BENCH WALL SHALL FORM A DEFINED CHANNEL, TO A MINIMUM HEIGHT OF 80-PERCENT OF THE INSIDE DIAMETER OF THE INLET AND OUTLET PIPES TO FORM A "U" SHAPED CHANNEL CONSTRUCTED AT A MINIMUM 1/2-INCH PER FOOT SLOPE TO THE MANHOLE WALL.
- 17. ALL STORM WATER INLETS AND CATCH BASIN CASTINGS SHALL HAVE THE WORDS "NO DUMPING, DRAINS TO STREAM", OR SIMILARLY APPROVED MESSAGE, CAST IN RAISED OR RECESSED LETTERS AT A MINIMUM OF 1" IN HEIGHT. IN ADDITION, A SYMBOL OF A FISH SHALL ALSO BE CAST WITH THE LETTERS.
- 18. SEE GENERAL NOTES SHEET FOR ADDITIONAL INFORMATION AND REQUIREMENTS.

## PROJECT BENCHMARKS:

## SITE BENCHMARKS:

BM #1 ACS MONUMENT "10-B13" ELEVATION= 5074.478 (NAVD 88)

BM #2 ACS MONUMENT "8-B13" ELEVATION= 5059.673 (NAVD 88)


## FLOOD NOTE:

PROJECT SITE DOES NOT LIE WITHIN A 100 YEAR FLOOD HAZARD AREA AND IS LOCATED IN ZONE "X" AS SHOWN ON THE ABOVE FEDERAL EMERGENCY MANAGEMENT AGENCY FLOOD INSURANCE RATE MAP NUMBER 35001C0108G WITH AN EFFECTIVE DATE OF SEPTEMBER 26, 2008.

## UTILITY RIM NOTE:

- ALL UTILITY STRUCTURE RIMS SHALL HAVE A 6'x6' CONCRETE COLLAR WITHIN NEW ASPHALT
- ALL UTILITY CLEAN-OUT RIMS SHALL HAVE A 3'x3' CONCRETE

## COLLAR WITHIN NEW ASPHALT

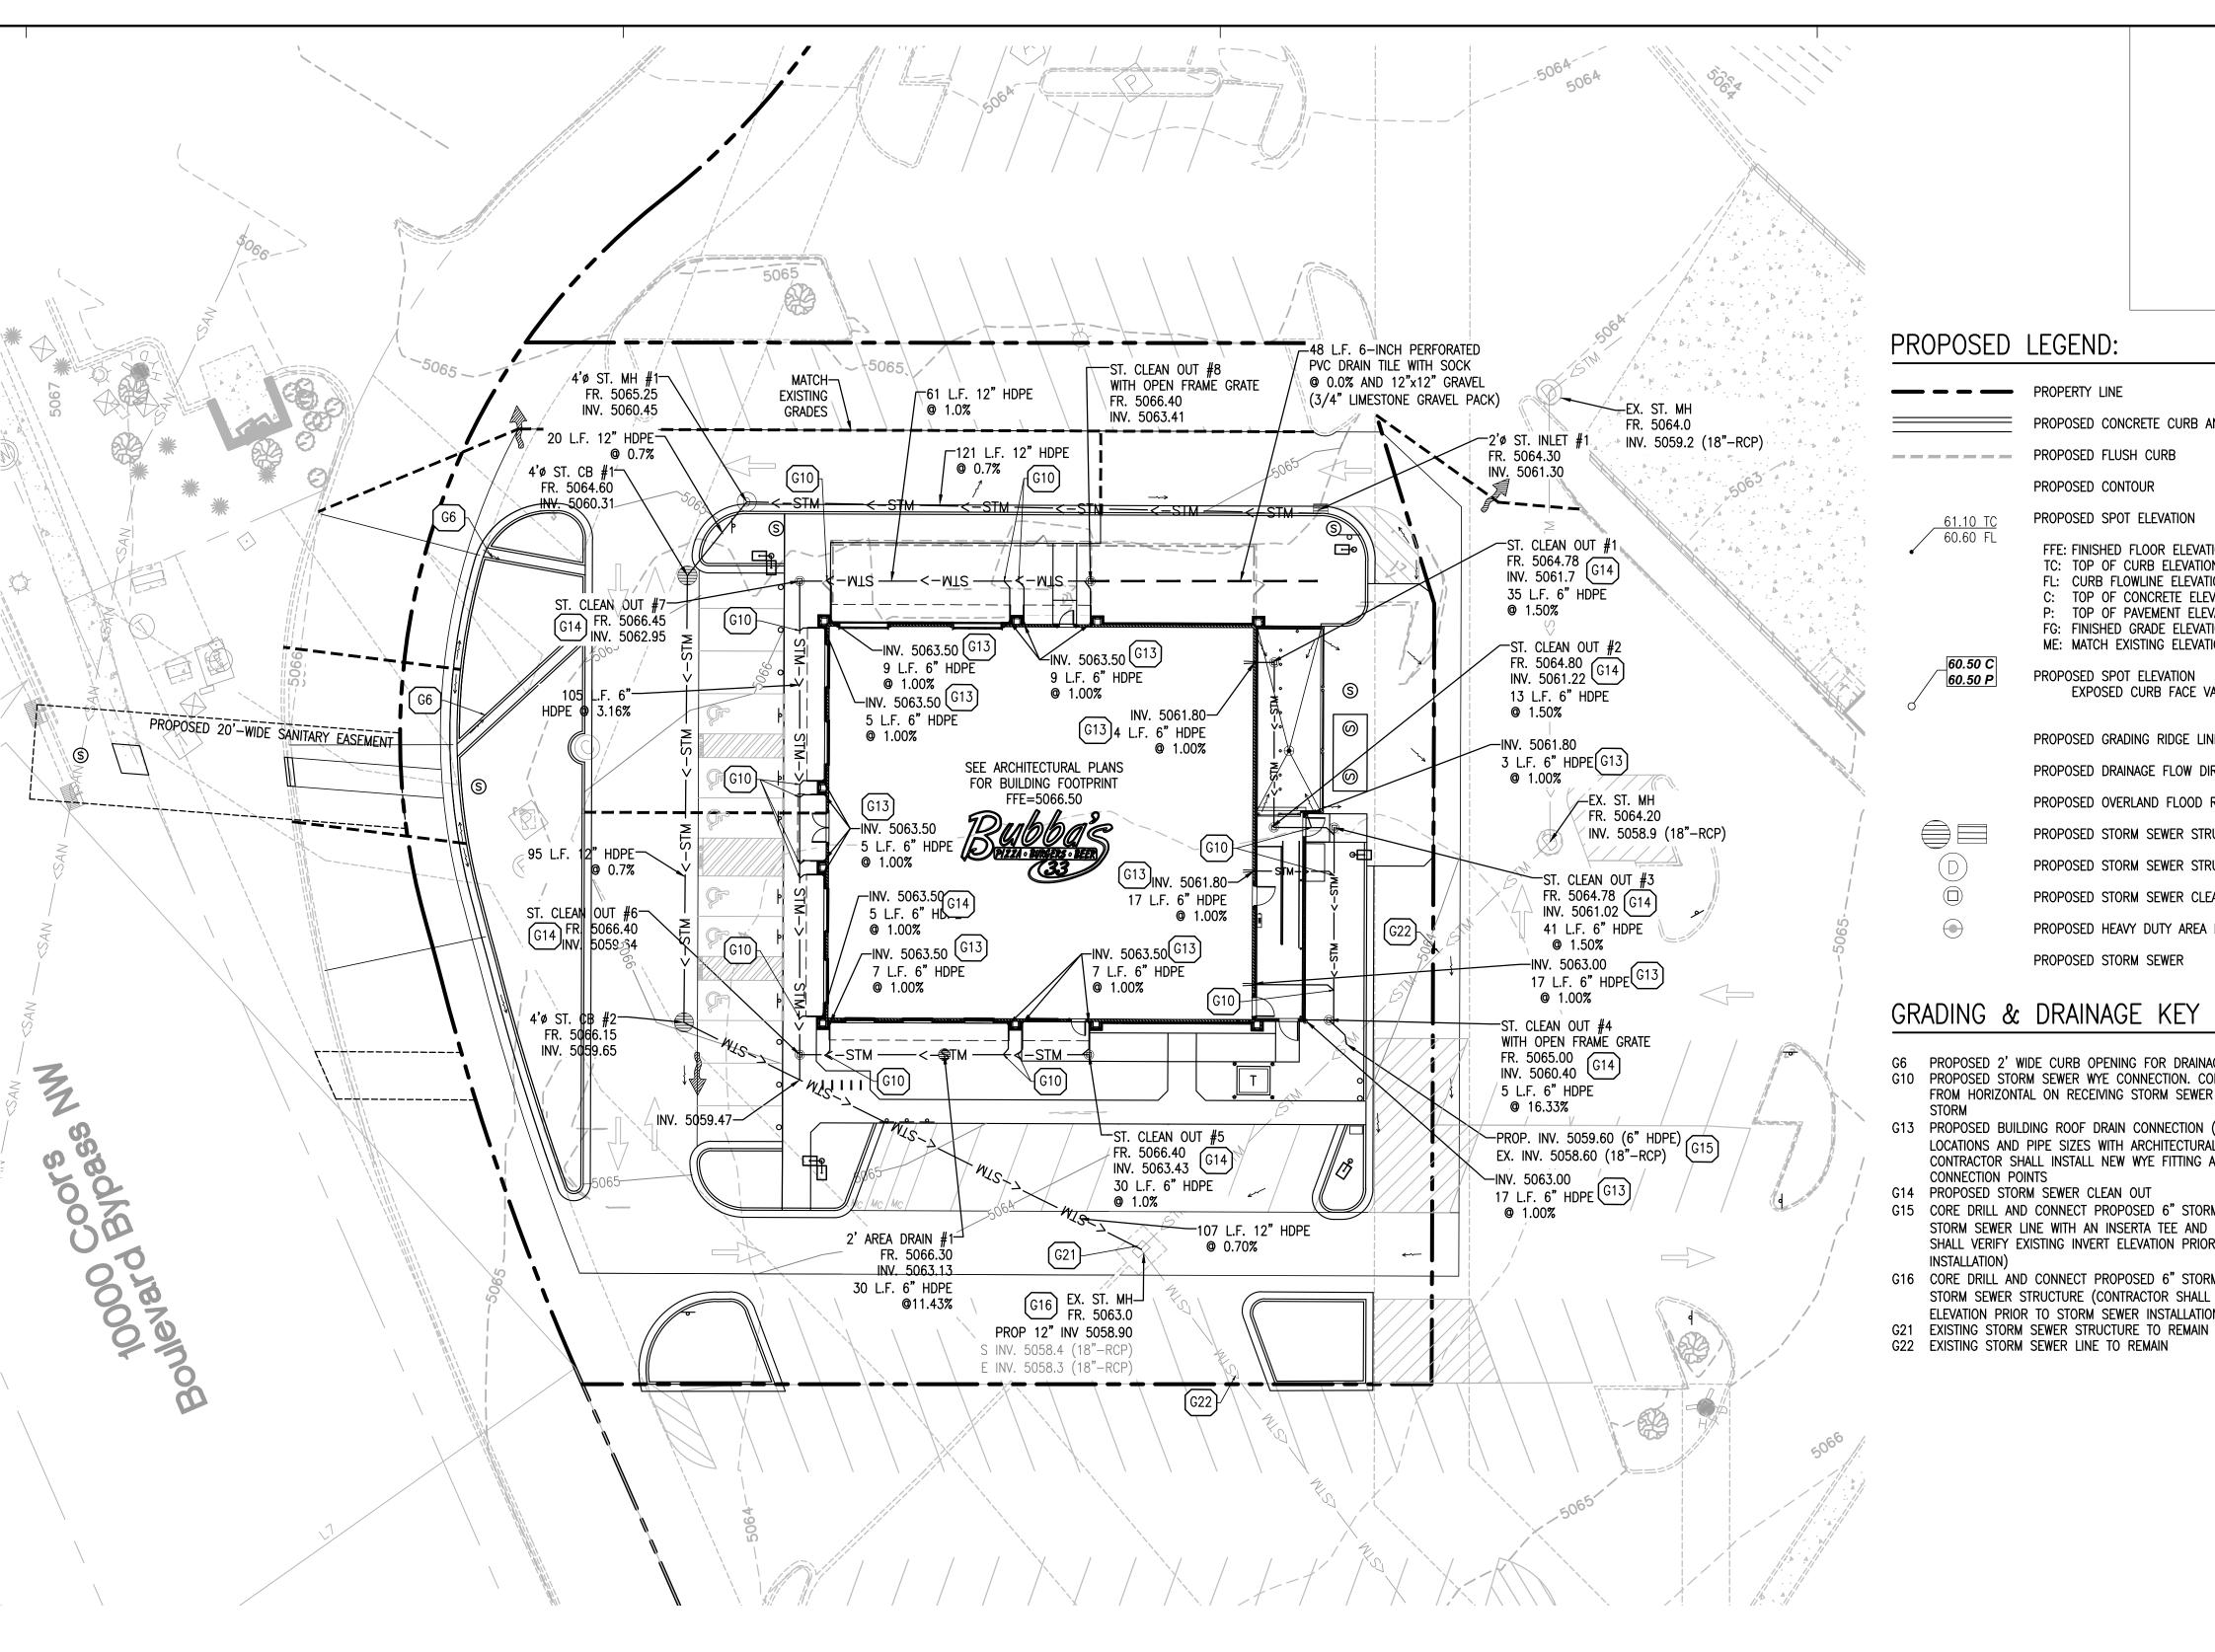



- PROPERTY LINE PROPOSED CONCRETE CURB AND GUTTER ---- PROPOSED FLUSH CURB PROPOSED CONTOUR PROPOSED SPOT ELEVATION FFE: FINISHED FLOOR ELEVATION TC: TOP OF CURB ELEVATION FL: CURB FLOWLINE ELEVATION C: TOP OF CONCRETE ELEVATION P: TOP OF PAVEMENT ELEVATION FG: FINISHED GRADE ELEVATION ME: MATCH EXISTING ELEVATION PROPOSED SPOT ELEVATION EXPOSED CURB FACE VARIES PROPOSED GRADING RIDGE LINE PROPOSED DRAINAGE FLOW DIRECTION PROPOSED OVERLAND FLOOD ROUTE PROPOSED STORM SEWER STRUCTURE WITH OPEN GRATE PROPOSED STORM SEWER STRUCTURE WITH CLOSED LID PROPOSED STORM SEWER CLEAN OUT PROPOSED HEAVY DUTY AREA DRAIN PROPOSED STORM SEWER

## GRADING & DRAINAGE KEY NOTES:

- G6 PROPOSED 2' WIDE CURB OPENING FOR DRAINAGE G10 PROPOSED STORM SEWER WYE CONNECTION. CONTRACTOR TO ROLL WYE UP FROM HORIZONTAL ON RECEIVING STORM SEWER TO CONNECT TO UPSTREAM
- G13 PROPOSED BUILDING ROOF DRAIN CONNECTION (COORDINATE EXACT LOCATIONS AND PIPE SIZES WITH ARCHITECTURAL AND PLUMBING PLANS). CONTRACTOR SHALL INSTALL NEW WYE FITTING AT PROPOSED STORM SEWER CONNECTION POINTS
- G15 CORE DRILL AND CONNECT PROPOSED 6" STORM SEWER LINE TO EXISTING STORM SEWER LINE WITH AN INSERTA TEE AND RISER SECTION (CONTRACTOR SHALL VERIFY EXISTING INVERT ELEVATION PRIOR TO STORM SEWER
- G16 CORE DRILL AND CONNECT PROPOSED 6" STORM SEWER LINE TO EXISTING STORM SEWER STRUCTURE (CONTRACTOR SHALL VERIFY EXISTING INVERT ELEVATION PRIOR TO STORM SEWER INSTALLATION)
- G22 EXISTING STORM SEWER LINE TO REMAIN



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PROJECT TEAM

**ISSUE/REVISION RECORD** 

DESCRIPTION

04/11/24 COORDINATION SET 05/22/24 PERMIT SET 06/14/24 BID SET 07/12/24 PERMIT RESPONSE 07/24/24 PERMIT RESPONSE



PROFESSIONAL IN CHARGE **ZACH MICHELS** PROFESSIONAL ENGINEER

LICENSE NO. 28488 PROJECT MANAGER EDWARD GOSS **QUALITY CONTROL** EDWARD GOSS

**DRAWN BY** 

**PROJECT NAME** 

BUBBA'S 33

**ALBUQUERQUE** 

**NEW MEXICO** 


**10000 COORS BYPASS NW ALBUQUERQUE, NM 87114** 




PROJECT NUMBER 20182050.0


SHEET TITLE DRAINAGE PLAN


**SHEET NUMBER** 

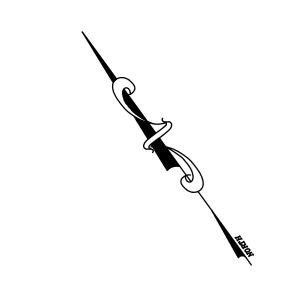


GRAPHIC SCALE ( IN FEET ) 1 inch = 20 ft.

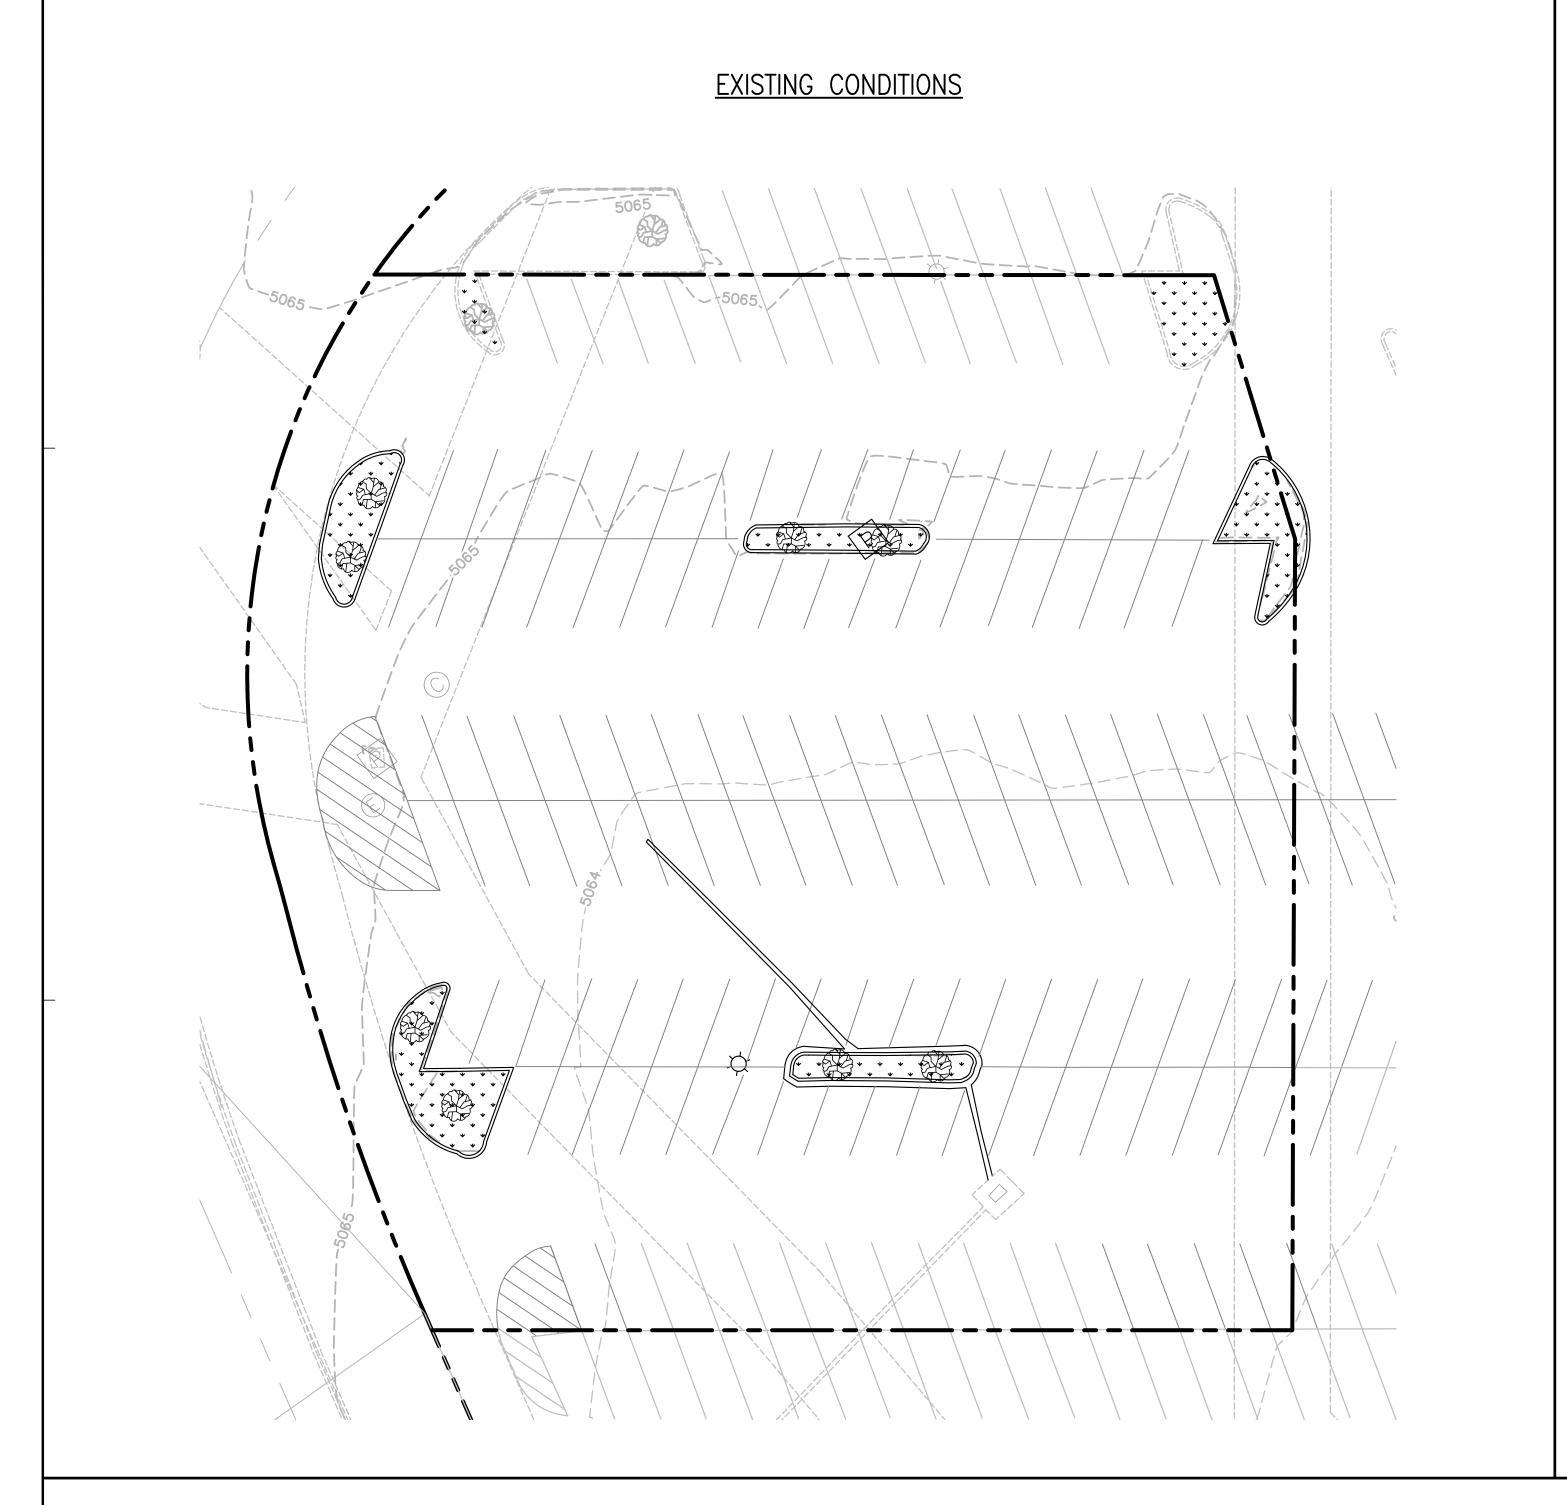

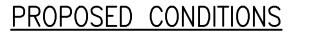

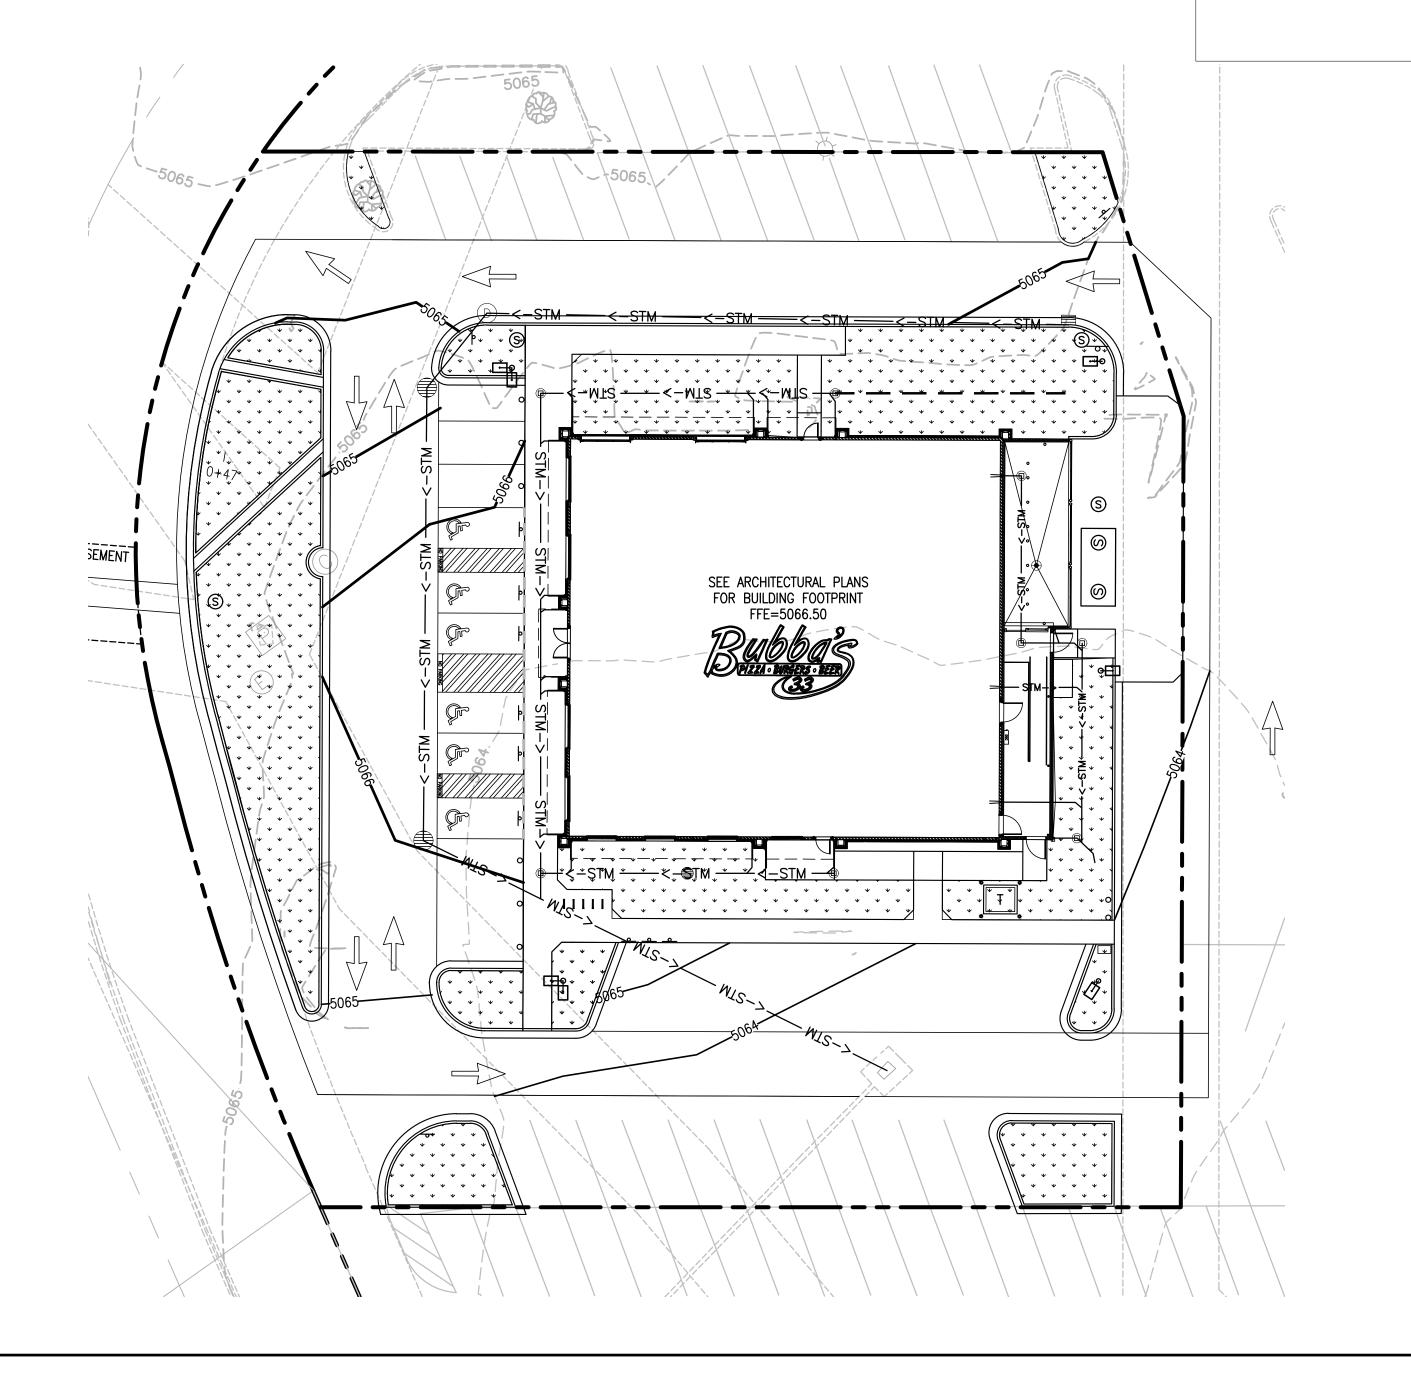

## EXHIBIT LEGEND:

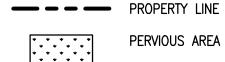

PERVIOUS AREA

## STORMWATER SUMMARY TABLE:

TOTAL SITE AREA: 44,717 SQ. FT./1.03 ACRES **EXISTING CONDITIONS:** 

43,078 SQ. FT./0.99 ACRES EXISTING IMPERVIOUS AREA: EXISTING PERVIOUS AREA: 1,639 SQ. FT./0.04 ACRES

36,763 SQ. FT./0.85 ACRES

7,954 SQ. FT./0.18 ACRES 44,717

PROPOSED CONDITIONS:

PROPOSED IMPERVIOUS AREA: PROPOSED PERVIOUS AREA:

STORMWATER CALCULATIONS:

THE SITE IS LOCATED IN ZONE 1 AND HAS LAND TREATMENT IN AREAS B & D.

PEAK DISCHARGE (100 YEAR, 6-HOUR STORM EVENT): ZONE 1, LAND TREATMENT AREA B = 2.16 CFS ZONE 1, LAND TREATMENT AREA D = 4.12 CFS

**EXISTING:** 

 $= Q_{PB}(A_B) + Q_{PD}(A_D) = 2.16(0.04) + 4.12(0.99)$ 

PROPOSED:

RUNOFF (Q)

RUNOFF (Q)

=  $Q_{PB}(A_B) + Q_{PD}(A_D) = 2.16(0.18) + 4.12(0.85)$ = 3.89

THE RUNOFF IS DECREASED IN THE PROPOSED CONDITIONS.

STORMWATER DESIGN IS BASED ON ARTICLE 6-2(A) FROM THE THE CITY OF ALBUQUERQUE DEVELOPMENT PROCESS MANUAL.

## DISTURBED SITE AREA TABLE:

39,797 SQ. FT. / 0.91 ACRES TOTAL DISTURBED AREA: IMPERVIOUS AREA: 31,601 SQ. FT. / 0.72 ACRES 8,196 SQ. FT. / 0.19 ACRES PERVIOUS AREA:

## STORMWATER QUALITY VOLUME:


STORMWATER QUALITY VOLUME

= 0.26\*(NEW IMPERVIOUS AREA)\*(1/12)= 0.26'\*31,892\*(1/12)

THE OWNER HAS ELECTED TO PAY FOR THE STORMWATER QUALITY VOLUME. THE PAYMENT-IN-LIEU WILL BE \$5,568.

= 691 CF

SWQ VOLUME PAYMENT CALCULATION = \$8/CF\*(SWQ VOLUME)= \$8/CF\*691 = \$5,528

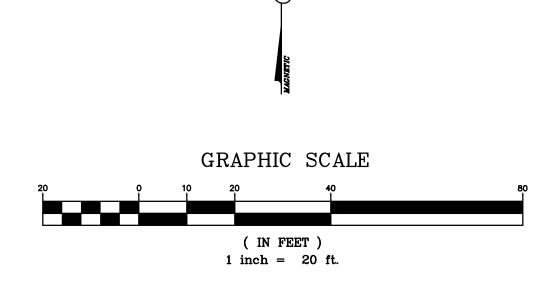



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PROFESSIONAL SEAL



PROFESSIONAL IN CHARGE **ZACH MICHELS** PROFESSIONAL ENGINEER

LICENSE NO. 28488 PROJECT MANAGER EDWARD GOSS **QUALITY CONTROL** EDWARD GOSS **DRAWN BY** 

> PROJECT NAME BUBBA'S 33

> **ALBUQUERQUE**

**NEW MEXICO** 10000 COORS BYPASS NW


ALBUQUERQUE, NM 87114




PROJECT NUMBER 20182050.0

SHEET TITLE

PRE/POST **LAND USE COMPARISON** 

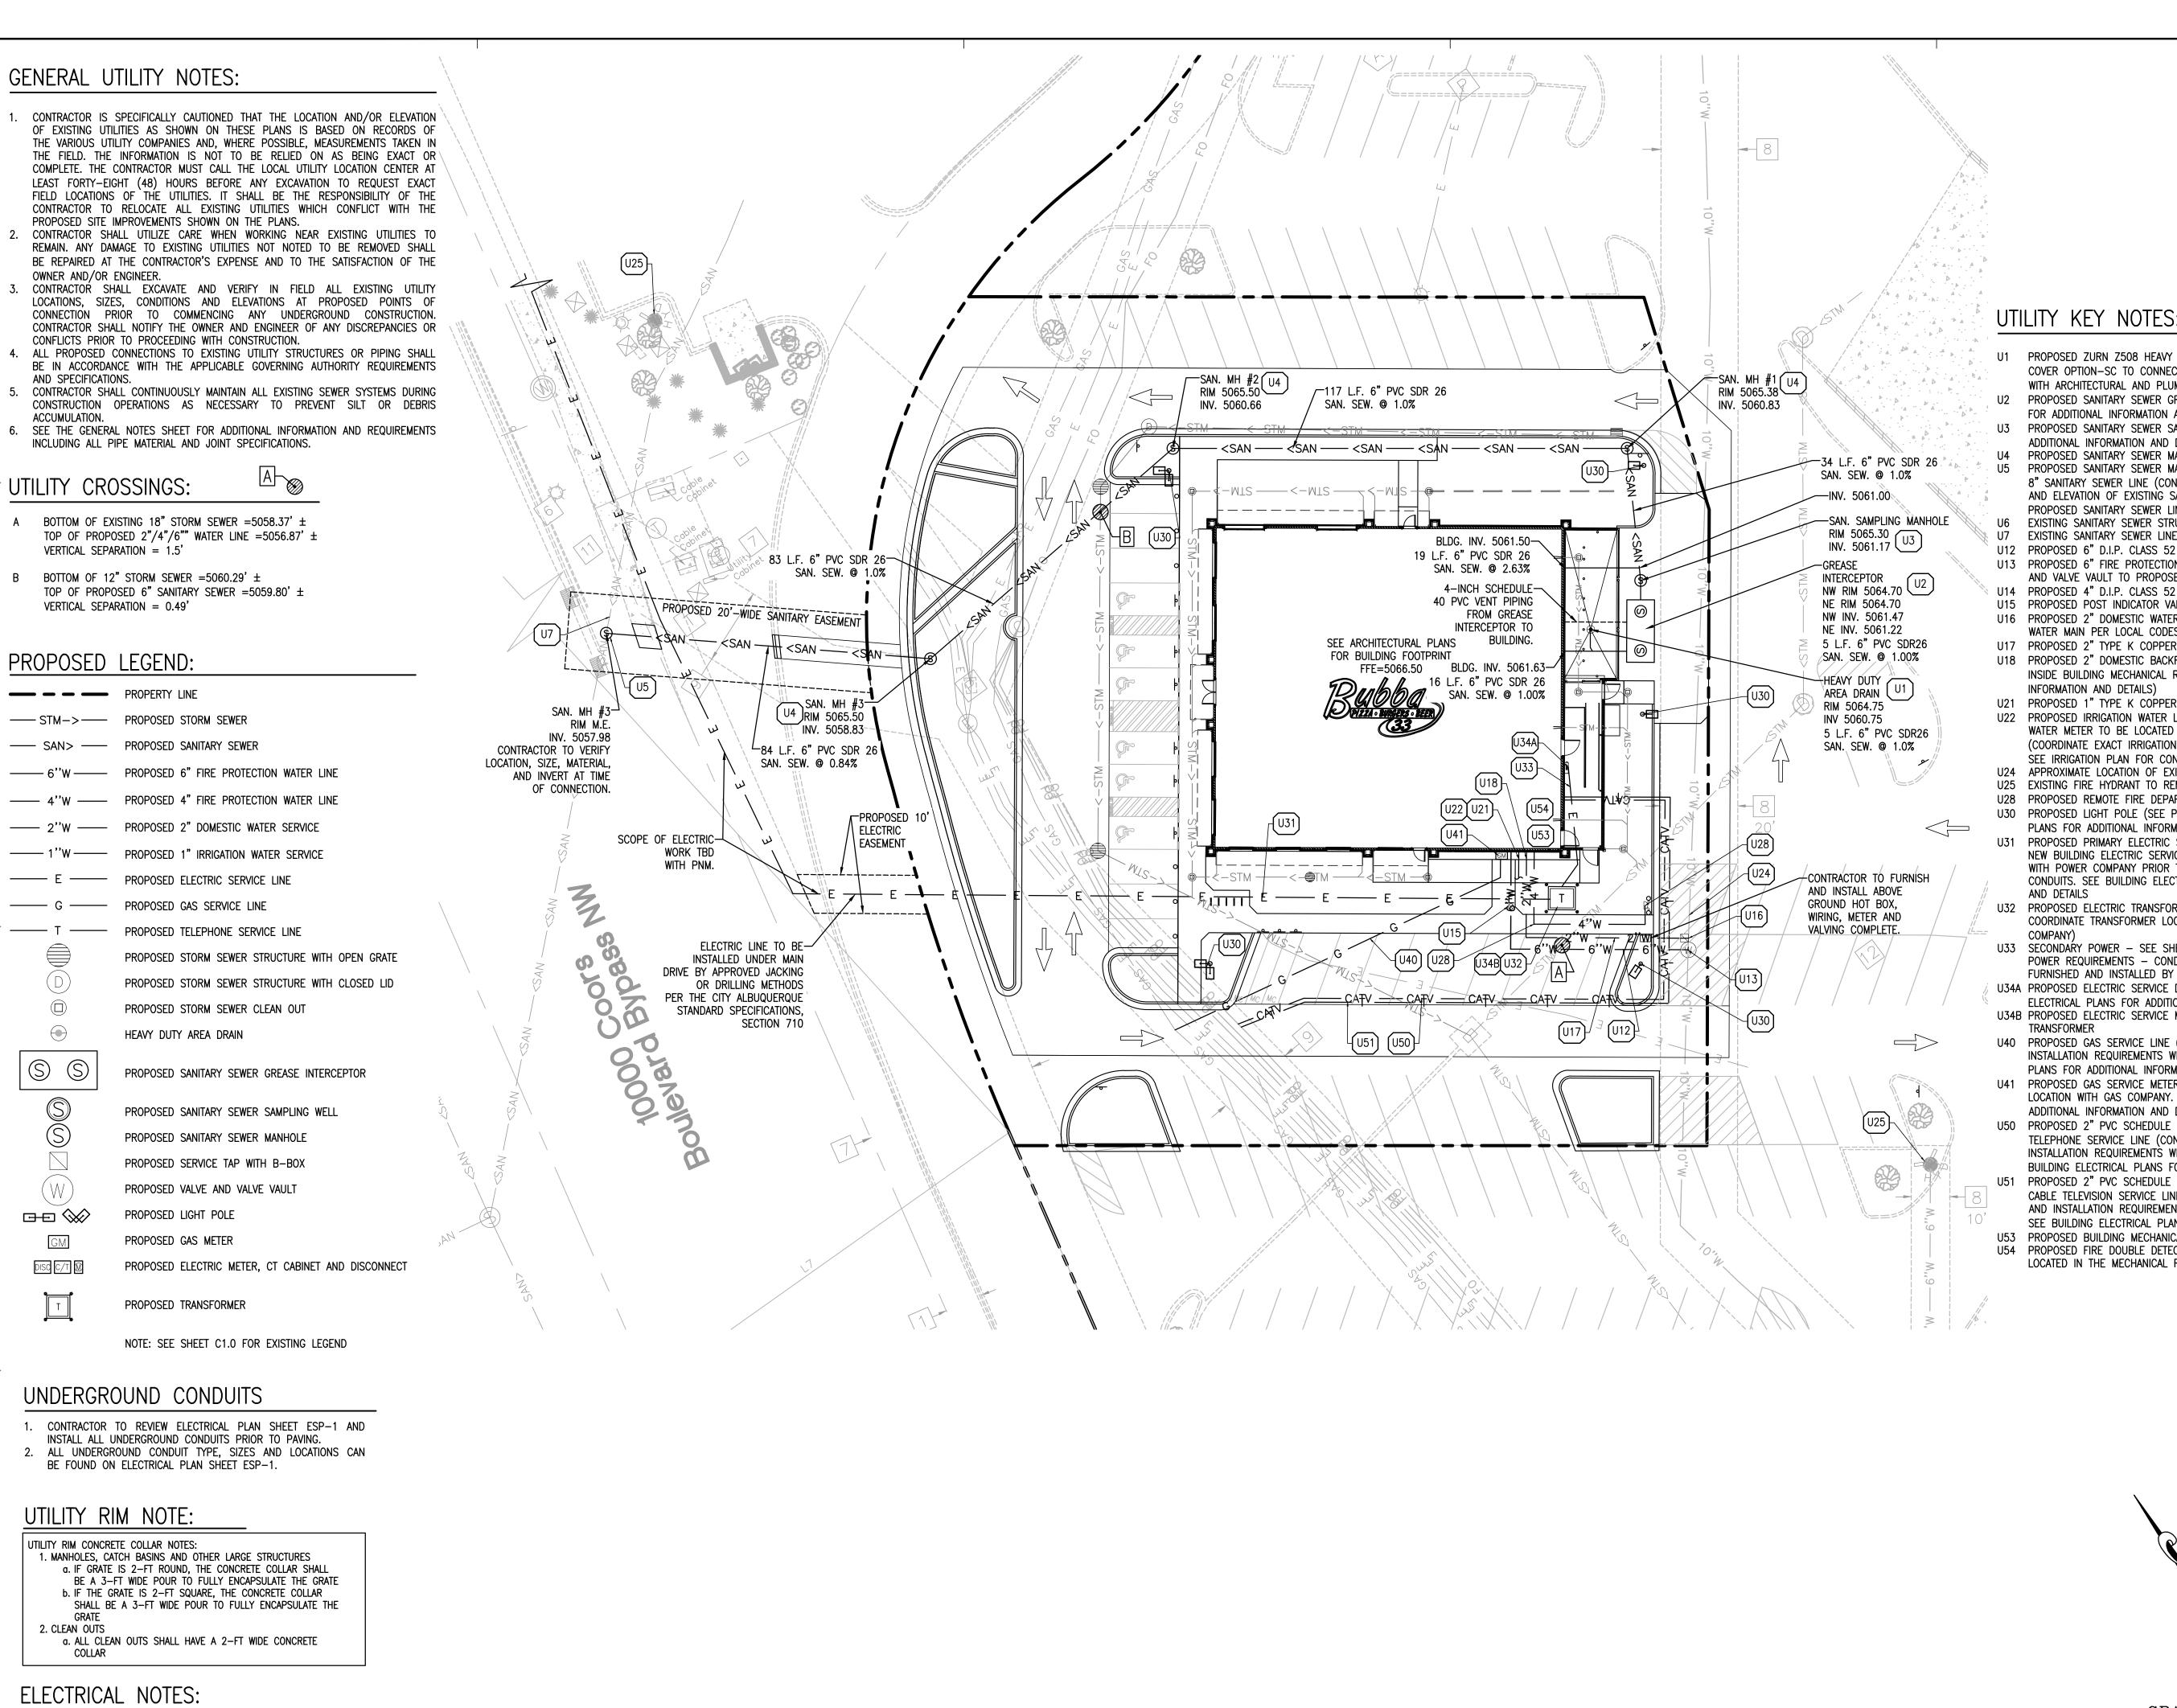

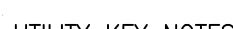

U1 PROPOSED ZURN Z508 HEAVY DUTY AREA DRAIN WITH REMOVABLE SOLID COVER OPTION—SC TO CONNECT TO SANITARY SEWER SYSTEM (COORDINATE WITH ARCHITECTURAL AND PLUMBING PLANS)

U2 PROPOSED SANITARY SEWER GREASE INTERCEPTOR (SEE PLUMBING PLANS FOR ADDITIONAL INFORMATION AND DETAIL)

U3 PROPOSED SANITARY SEWER SAMPLING WELL (SEE PLUMBING PLANS FOR ADDITIONAL INFORMATION AND DETAIL) PROPOSED SANITARY SEWER MANHOLE

PROPOSED SANITARY SEWER MANHOLE TO BE CONSTRUCTED OVER EXISTING 8" SANITARY SEWER LINE (CONTRACTOR SHALL FIELD VERIFY EXACT LOCATION AND ELEVATION OF EXISTING SANITARY INVERT PRIOR TO INSTALLING PROPOSED SANITARY SEWER LINES)

U6 EXISTING SANITARY SEWER STRUCTURE TO REMAIN U7 EXISTING SANITARY SEWER LINE TO REMAIN

U12 PROPOSED 6" D.I.P. CLASS 52 FIRE PROTECTION WATER SERVICE LINE

U13 PROPOSED 6" FIRE PROTECTION WATER SERVICE TAPPING SLEEVE, VALVE, AND VALVE VAULT TO PROPOSED WATER MAIN PER LOCAL CODES

U14 PROPOSED 4" D.I.P. CLASS 52 FIRE PROTECTION WATER SERVICE LINE

U15 PROPOSED POST INDICATOR VALVE PER LOCAL CODES U16 PROPOSED 2" DOMESTIC WATER SERVICE TAP WITH B-BOX TO EXISTING

WATER MAIN PER LOCAL CODES

U17 PROPOSED 2" TYPE K COPPER DOMESTIC WATER SERVICE LINE U18 PROPOSED 2" DOMESTIC BACKFLOW PREVENTION DEVICE TO BE LOCATED

INSIDE BUILDING MECHANICAL ROOM (SEE PLUMBING PLANS FOR ADDITIONAL INFORMATION AND DETAILS) U21 PROPOSED 1" TYPE K COPPER IRRIGATION WATER LINE STUB

U22 PROPOSED IRRIGATION WATER LINE BACKFLOW PREVENTION DEVICE AND 1" WATER METER TO BE LOCATED INSIDE BUILDING MECHANICAL ROOM (COORDINATE EXACT IRRIGATION STUB LOCATION WITH PLUMBING PLANS AND SEE IRRIGATION PLAN FOR CONTINUATION)

U24 APPROXIMATE LOCATION OF EXISTING WATER MAIN TO REMAIN

U25 EXISTING FIRE HYDRANT TO REMAIN

U28 PROPOSED REMOTE FIRE DEPARTMENT CONNECTION (FDC) PER LOCAL CODE U30 PROPOSED LIGHT POLE (SEE PHOTOMETRIC PLAN AND BUILDING ELECTRICAL

PLANS FOR ADDITIONAL INFORMATION AND DETAIL) U31 PROPOSED PRIMARY ELECTRIC SERVICE LINE (CONTRACTOR SHALL COORDINATE NEW BUILDING ELECTRIC SERVICE ROUTING AND INSTALLATION REQUIREMENTS WITH POWER COMPANY PRIOR TO ANY EXCAVATION OR INSTALLATION OF CONDUITS. SEE BUILDING ELECTRICAL PLANS FOR ADDITIONAL INFORMATION

U32 PROPOSED ELECTRIC TRANSFORMER LOCATION (CONTRACTOR SHALL COORDINATE TRANSFORMER LOCATION, SIZE AND DESIGN WITH POWER

U33 SECONDARY POWER - SEE SHEET E3, DETAIL 1 FOR SECONDARY ELECTRICAL POWER REQUIREMENTS - CONDUIT AND WIRE QUANTITY AND SIZE TO BE FURNISHED AND INSTALLED BY ELECTRICAL CONTRACTOR

U34A PROPOSED ELECTRIC SERVICE DISCONNECT LOCATION (SEE BUILDING ELECTRICAL PLANS FOR ADDITIONAL INFORMATION AND DETAIL)

U34B PROPOSED ELECTRIC SERVICE METER AND CT CABINET TO BE ON THE

U40 PROPOSED GAS SERVICE LINE (CONTRACTOR SHALL COORDINATE ROUTING AND INSTALLATION REQUIREMENTS WITH GAS COMPANY. SEE BUILDING MECHANICAL PLANS FOR ADDITIONAL INFORMATION AND DETAIL)

U41 PROPOSED GAS SERVICE METER (CONTRACTOR SHALL COORDINATE METER LOCATION WITH GAS COMPANY. SEE BUILDING MECHANICAL PLANS FOR

ADDITIONAL INFORMATION AND DETAIL) U50 PROPOSED 2" PVC SCHEDULE 80 CONDUITS WITH PULL WIRE FOR NEW TELEPHONE SERVICE LINE (CONTRACTOR SHALL COORDINATE ROUTING AND

INSTALLATION REQUIREMENTS WITH TELEPHONE AND CABLE COMPANIES. SEE BUILDING ELECTRICAL PLANS FOR ADDITIONAL INFORMATION AND DETAIL) U51 PROPOSED 2" PVC SCHEDULE 80 CONDUITS WITH PULL WIRE FOR NEW

CABLE TELEVISION SERVICE LINE (CONTRACTOR SHALL COORDINATE ROUTING AND INSTALLATION REQUIREMENTS WITH TELEPHONE AND CABLE COMPANIES. SEE BUILDING ELECTRICAL PLANS FOR ADDITIONAL INFORMATION AND DETAIL)

U53 PROPOSED BUILDING MECHANICAL ROOM (SHOWN FOR REFERENCE ONLY) U54 PROPOSED FIRE DOUBLE DETECTOR CHECK ASSEMBLY AND VALVING SHALL BE LOCATED IN THE MECHANICAL ROOM. SEE PLUMBING PLANS.

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PROJECT TEAM

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**ISSUE/REVISION RECORD** DESCRIPTION

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**PROFESSIONAL SEAL** 



PROFESSIONAL IN CHARGE **ZACH MICHELS** PROFESSIONAL ENGINEER

LICENSE NO. 28488 PROJECT MANAGER EDWARD GOSS **QUALITY CONTROL** 

EDWARD GOSS DRAWN BY

**PROJECT NAME** 

BUBBA'S 33

**ALBUQUERQUE NEW MEXICO** 

**10000 COORS BYPASS NW ALBUQUERQUE, NM 87114** 



PROJECT NUMBER 20182050 (

SHEET TITLE

PLAN

**SHEET NUMBER** 

**C5.0** 


GRAPHIC SCALE

1 inch = 20 ft.

( IN FEET )

PNM STANDARDS. • REFERENCE ARCHITECTURAL PLAN SHEET ESP-1 FOR ADDITIONAL INFORMATION.

• ELECTRIC TRANSFORMER CONCRETE PAD TO BE INSTALL PER PER

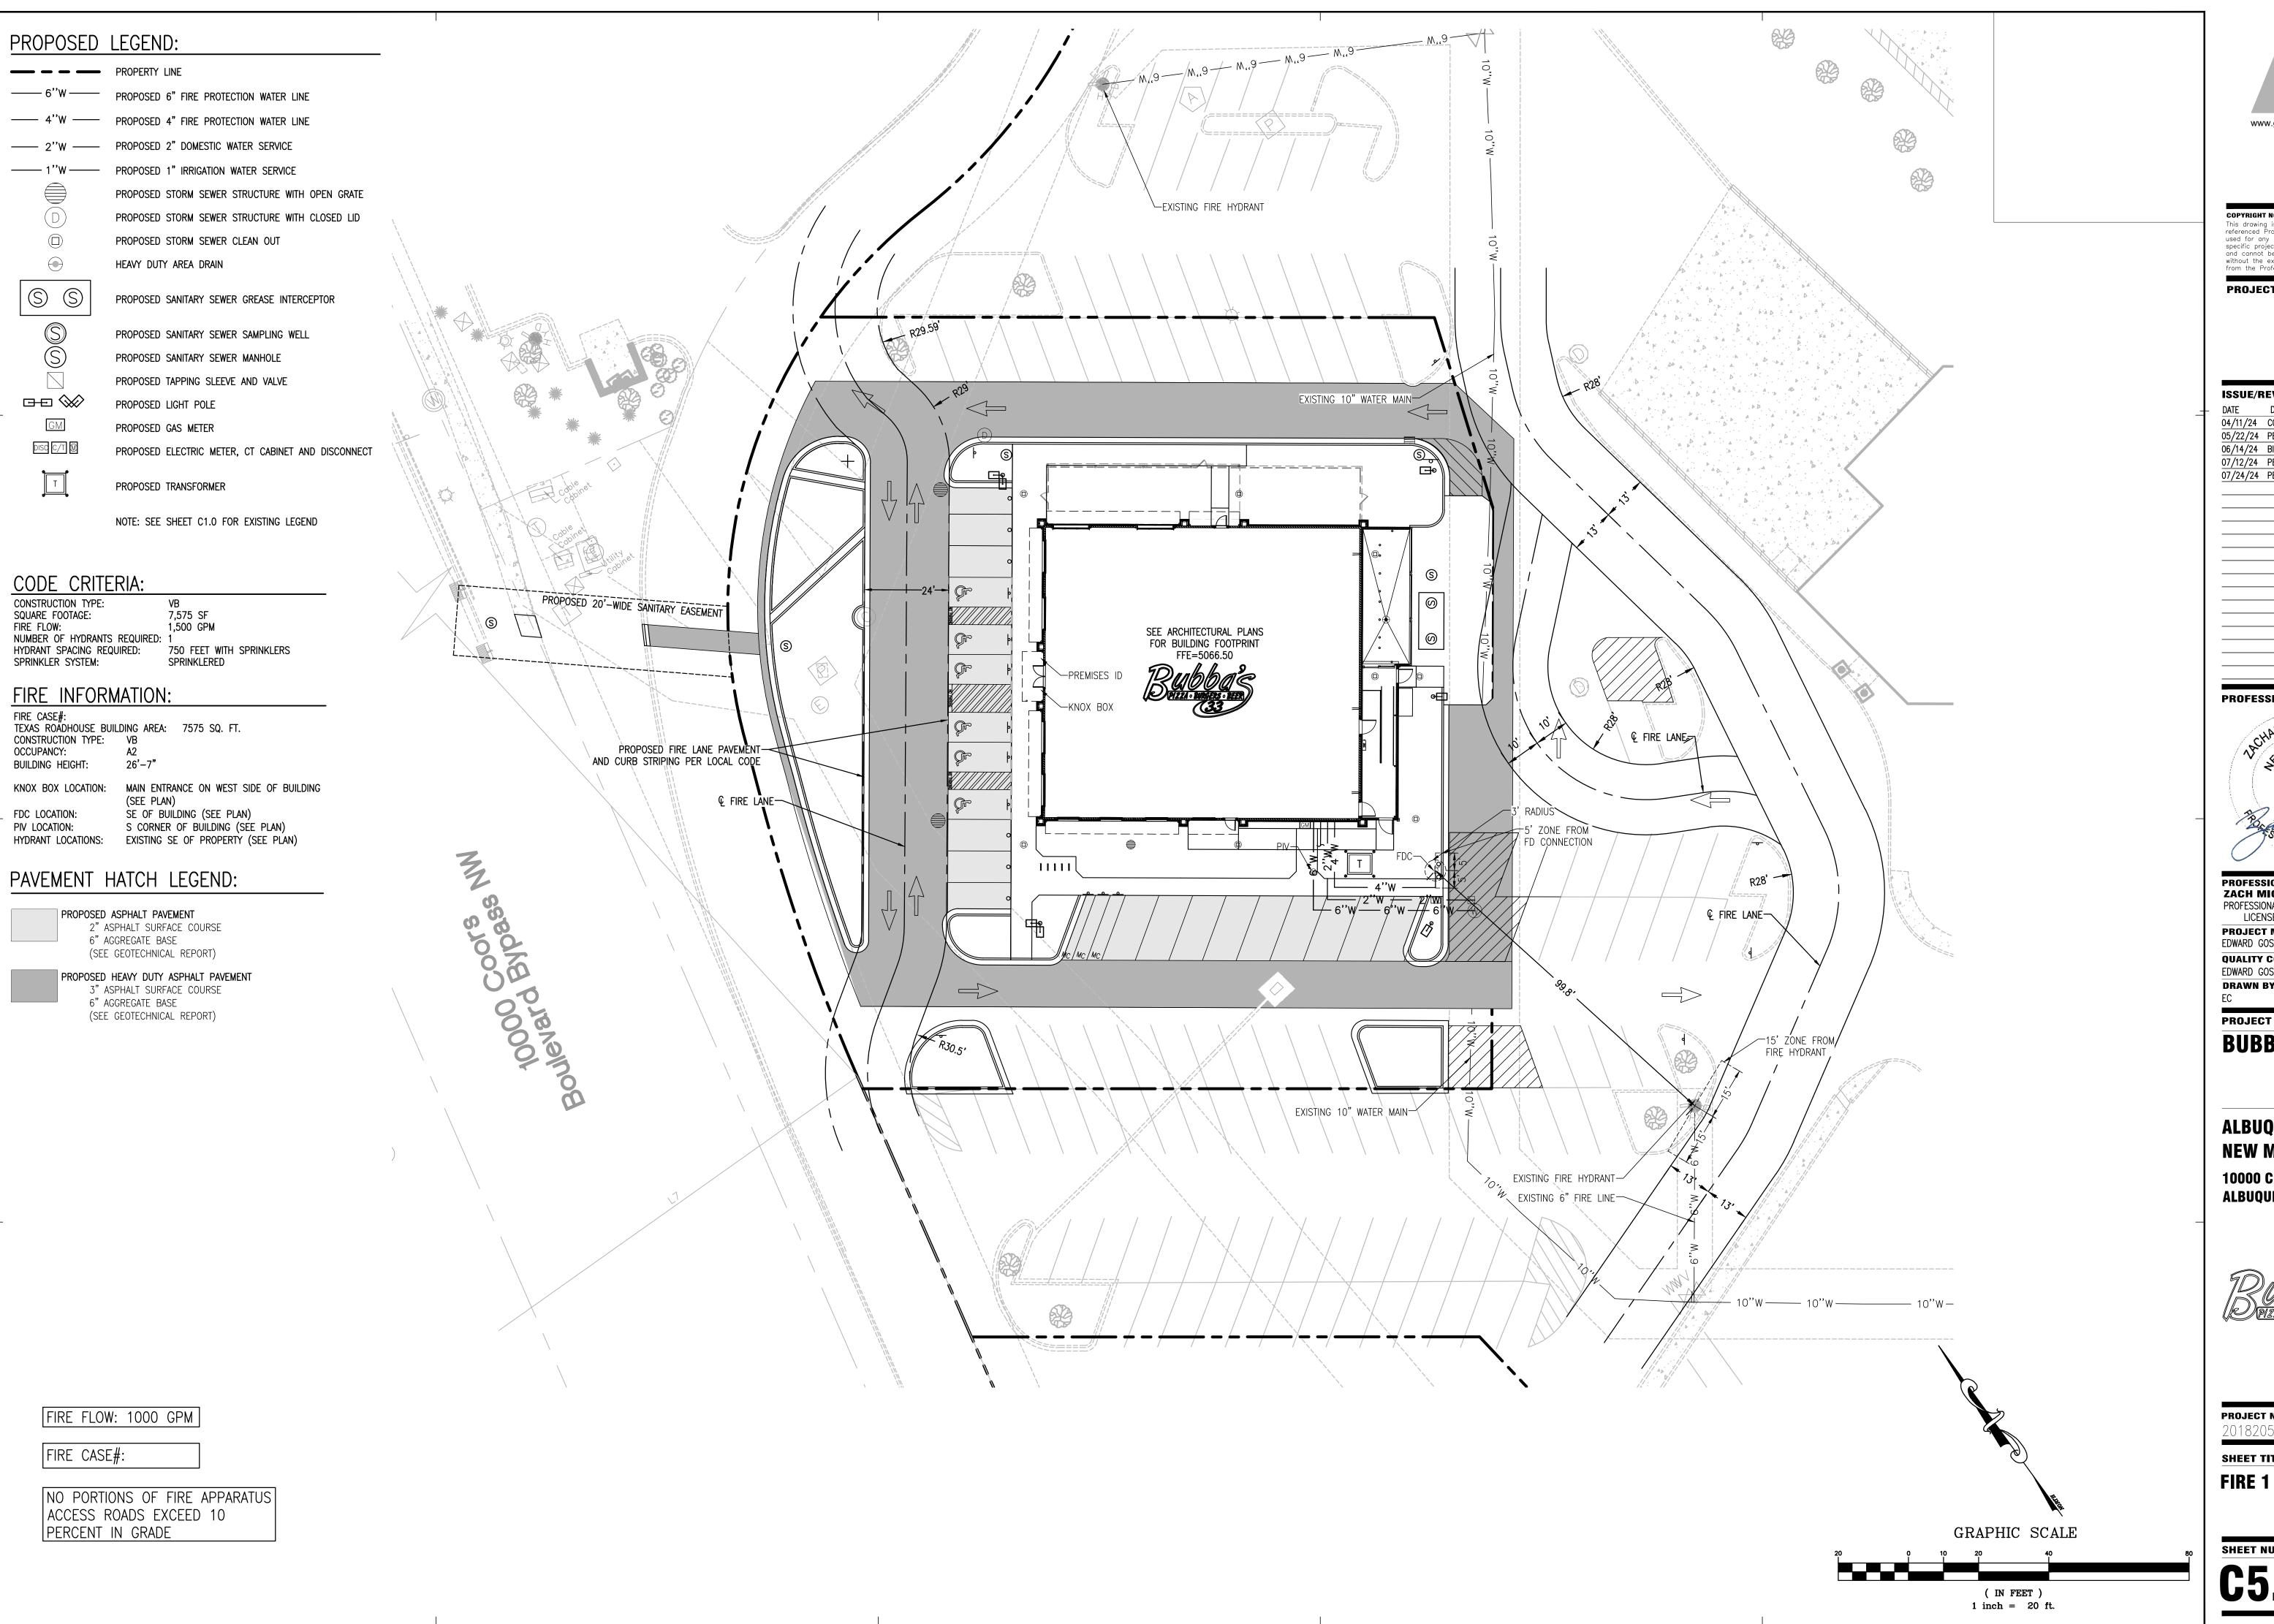



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PROFESSIONAL IN CHARGE **ZACH MICHELS** PROFESSIONAL ENGINEER LICENSE NO. 28488

PROJECT MANAGER EDWARD GOSS QUALITY CONTROL EDWARD GOSS DRAWN BY

PROJECT NAME

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**ALBUQUERQUE NEW MEXICO** 

10000 COORS BYPASS NW ALBUQUERQUE, NM 87114



**PROJECT NUMBER** 20182050.0

SHEET TITLE

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**C5.**1


## SWPPP / SESC NOTES:

SPECIFICATIONS OR MANUAL OF PRACTICE.

- I. COPIES OF THE APPROVED SOIL EROSION AND SEDIMENT CONTROL (SESC) PLANS OR STORMWATER POLLUTION PREVENTION PLANS (SWPPP) SHALL BE MAINTAINED ON THE SITE AT ALL TIMES ALONG WITH ANY NECESSARY PERMITS AND INSPECTION
- ALL EROSION AND SEDIMENTATION CONTROL MEASURES AND DEVICES SHALL BE INSTALLED AND FUNCTIONAL BEFORE THE SITE IS OTHERWISE DISTURBED. THEY SHALL BE KEPT OPERATIONAL AND MAINTAINED CONTINUOUSLY THROUGHOUT THE PERIOD OF LAND DISTURBANCE UNTIL PERMANENT SITE STABILIZATION HAS BEEN
- CONTRACTOR SHALL IMPLEMENT SITE SPECIFIC BEST MANAGEMENT PRACTICES (BMPS) AS SHOWN AND REQUIRED BY THE SWPPP/SESC. ADDITIONAL BEST MANAGEMENT PRACTICES SHALL BE IMPLEMENTED BY THE CONTRACTOR AS DICTATED BY SITE CONDITIONS OR THE PROJECT GOVERNING AUTHORITIES AT NO ADDITIONAL COST TO THE OWNER THROUGHOUT ALL PHASES OF CONSTRUCTION.
- . ALL BEST MANAGEMENT PRACTICES AND CONTROLS SHALL CONFORM TO THE APPLICABLE FEDERAL, STATE, OR LOCAL REQUIREMENTS, STANDARDS, AND
- 5. IF AFTER REPEATED FAILURE ON THE PART OF THE CONTRACTOR TO PROPERLY CONTROL SOIL EROSION, SEDIMENT AND/OR POLLUTION FROM THE PROJECT SITE, THE GOVERNING AUTHORITIES RESERVE THE RIGHT TO EFFECT NECESSARY CORRECTIVE MEASURES AND CHARGE ANY COSTS TO THE CONTRACTOR.
- INLET PROTECTION SHALL BE INSTALLED AROUND EACH INLET OR CATCH BASIN WITHIN THE VICINITY OF THE DISTURBED AREA LIMITS AS SHOWN ON THE PLANS. THESE SHALL BE MAINTAINED UNTIL THE TRIBUTARY DRAINAGE AREAS HAVE ADEQUATE GRASS COVER AND/OR APPROPRIATE GROUND STABILIZATION.
- ALL STREETS ADJACENT TO THE PROJECT SITE SHALL BE KEPT FREE OF DIRT, MUD AND DEBRIS. CONTRACTOR SHALL CLEAN ADJACENT PAVEMENTS AT THE END OF EACH WORKING DAY WHEN NECESSARY.
- B. CONTRACTORS SHALL MINIMIZE BARE EARTH SURFACES DURING CONSTRUCTION TO THE EXTENT PRACTICABLE.
- 9. ALL DISTURBED AREAS SHALL BE SEEDED OR SODDED AS SOON AS IS PRACTICABLE.
- 10. IF DURING CONSTRUCTION OPERATIONS ANY LOOSE MATERIALS ARE DEPOSITED I THE FLOW LINE OF GUTTERS, DRAINAGE STRUCTURES, OR DITCHES SUCH THAT THE NATURAL FLOW LINE OF WATER IS OBSTRUCTED, THIS LOOSE MATERIAL SHALL BE
- 11. ALL SEDIMENT SHALL BE PREVENTED FROM ENTERING ANY EXISTING STORM DRAINAGE SYSTEMS BY THE USE OF INLET PROTECTION OR OTHER APPROVED FUNCTIONAL METHODS. THE CONTRACTOR SHALL BE RESPONSIBLE FOR REMOVING SEDIMENT RESULTING FROM CONSTRUCTION ACTIVITIES ASSOCIATED WITH THIS
- 12. CONSTRUCTION ACCESS POINTS TO THE SITE SHALL BE PROTECTED IN SUCH WAY AS TO PREVENT TRACKING OF MUD OR SOIL ONTO PUBLIC THOROUGHFARES. ALL SEDIMENT SPILLED, DROPPED, WASHED OR TRACKED ONTO PUBLIC RIGHTS-OF-WAY MUST BE REMOVED IMMEDIATELY BY THE CONTRACTOR.
- 13. SUFFICIENT OIL AND GREASE ABSORBING MATERIALS AND FLOTATION BOOMS SHALL BE MAINTAINED ON SITE OR READILY AVAILABLE TO CONTAIN AND CLEAN-UP FUEL OR CHEMICAL SPILLS AND LEAKS.
- 14. DUST SHALL BE ADEQUATELY CONTROLLED ON THE PROJECT SITE AT ALL TIMES DURING CONSTRUCTION.
- 15. RUBBISH, TRASH, GARBAGE, LITTER, OR OTHER SUCH MATERIALS SHALL BE DEPOSITED INTO SEALED TRASH CONTAINERS. MATERIALS SHALL BE PREVENTED FROM LEAVING THE PREMISES THROUGH THE ACTION OF WIND OR STORMWATER DISCHARGE INTO DRAINAGE DITCHES OR WATERS OF THE STATE.
- 16. DURING DEWATERING OPERATIONS, WATER SHALL BE PUMPED OR OTHERWISE DISCHARGED FROM THE SITE INTO SEDIMENT BASINS, SILT TRAPS, DEWATERING BAGS OR POLYMER MIXING SWALES. DEWATERING DIRECTLY INTO FIELD TILES OR STORMWATER SYSTEMS IS PROHIBITED.
- 17. ALL DISTURBED AREAS SHALL BE SEEDED OR SODDED WITHIN THREE (3) DAYS OF
- 18. ALL SOIL STOCKPILES SHALL BE STABILIZED WITHIN THREE (3) DAYS OF FORMING THE STOCKPILE.
- 19. STABILIZATION MEASURES SHALL BE INITIATED AS SOON AS PRACTICABLE II PORTIONS OF THE SITE WHERE CONSTRUCTION ACTIVITIES HAVE TEMPORARILY OR PERMANENTLY CEASED. BUT IN NO CASE MORE THAN SEVEN (7) DAYS AFTER THE CONSTRUCTION ACTIVITY IN THAT PORTION OF THE SITE HAS TEMPORARILY OR PERMANENTLY CEASED AS FOLLOWS:
- 19.1. WHEN THE INITIATION OF STABILIZATION MEASURES BY THE 7TH DAY AFTER CONSTRUCTION ACTIVITY TEMPORARILY OR PERMANENTLY CEASES IS PRECLUDED BY SNOW COVER, STABILIZATION MEASURES SHALL BE INITIATED AS SOON AS PRACTICABLE.
- 19.2. WHEN CONSTRUCTION ACTIVITY WILL RESUME ON A PORTION OF THE SITE WITHIN 14 DAYS FROM WHEN ACTIVITIES CEASED (I..E. THE TOTAL TIME PERIOD THAT CONSTRUCTION ACTIVITY IS TEMPORARILY CEASED IS LESS THAN 14 DAYS), THEN STABILIZATION MEASURES DO NOT HAVE TO BE INITIATED ON THAT PORTION OF THE SITE BY THE 7TH DAY AFTER CONSTRUCTION ACTIVITY TEMPORARILY CEASES.
- 20. PRE-QUALIFIED PERSONNEL (PROVIDED BY THE CONTRACTOR) SHALL INSPECT DISTURBED AREAS OF THE CONSTRUCTION SITE THAT HAVE NOT BEEN FINALLY STABILIZED, STRUCTURAL CONTROL MEASURES, AND LOCATIONS WHERE VEHICLES ENTER OR EXIT THE SITE AT LEAST ONCE EVERY SEVEN (7) CALENDAR DAYS AND WITHIN TWENTY-FOUR (24) HOURS OF THE END OF A RAINFALL EVENT THAT IS 0.5 INCH OR GREATER (OR EQUIVALENT SNOWFALL). REQUIRED REPAIRS SHOULD BE COMPLETED WITHIN FORTY-EIGHT (48) HOURS OF THE INSPECTION.
- 21. EROSION CONTROL BLANKETS SHALL BE USED IN AREAS OF 4:1 SLOPE OR 22. ALL TEMPORARY EROSION CONTROL AND SEDIMENT CONTROL MEASURES SHALL BE
- REMOVED THIRTY (30) DAYS AFTER FINAL SITE STABILIZATION IS ACHIEVED OR AFTER THE TEMPORARY MEASURES ARE NO LONGER NEEDED. TRAPPED SEDIMENT SHALL BE PROPERLY STABILIZED OR DISPOSED OF OFF SITE BY THE CONTRACTOR.
- 23. PRIOR TO COMMENCING LAND DISTURBING ACTIVITIES IN AREAS OTHER THAN THOSE INDICATED ON THESE PLANS (INCLUDING BUT NOT LIMITED TO ADDITIONAL PHASES OF DEVELOPMENT AND OFF-SITE BORROW OR WASTE AREAS) A SUPPLEMENTARY STORM WATER POLLUTION PREVENTION PLAN SHALL BE SUBMITTED TO THE OWNER AND ENGINEER FOR REVIEW.
- 24. ALL CONSTRUCTION VEHICLE TRAFFIC MUST REMAIN WITHIN THE LIMITS OF CONSTRUCTION.

## DISTURBED SITE AREA TABLE:

TOTAL DISTURBED AREA: 39,797 SQ. FT. / 0.91 ACRES 31,892 SQ. FT. / 0.73 ACRES IMPERVIOUS AREA: PERVIOUS AREA: 7,905 SQ. FT. / 0.18 ACRES

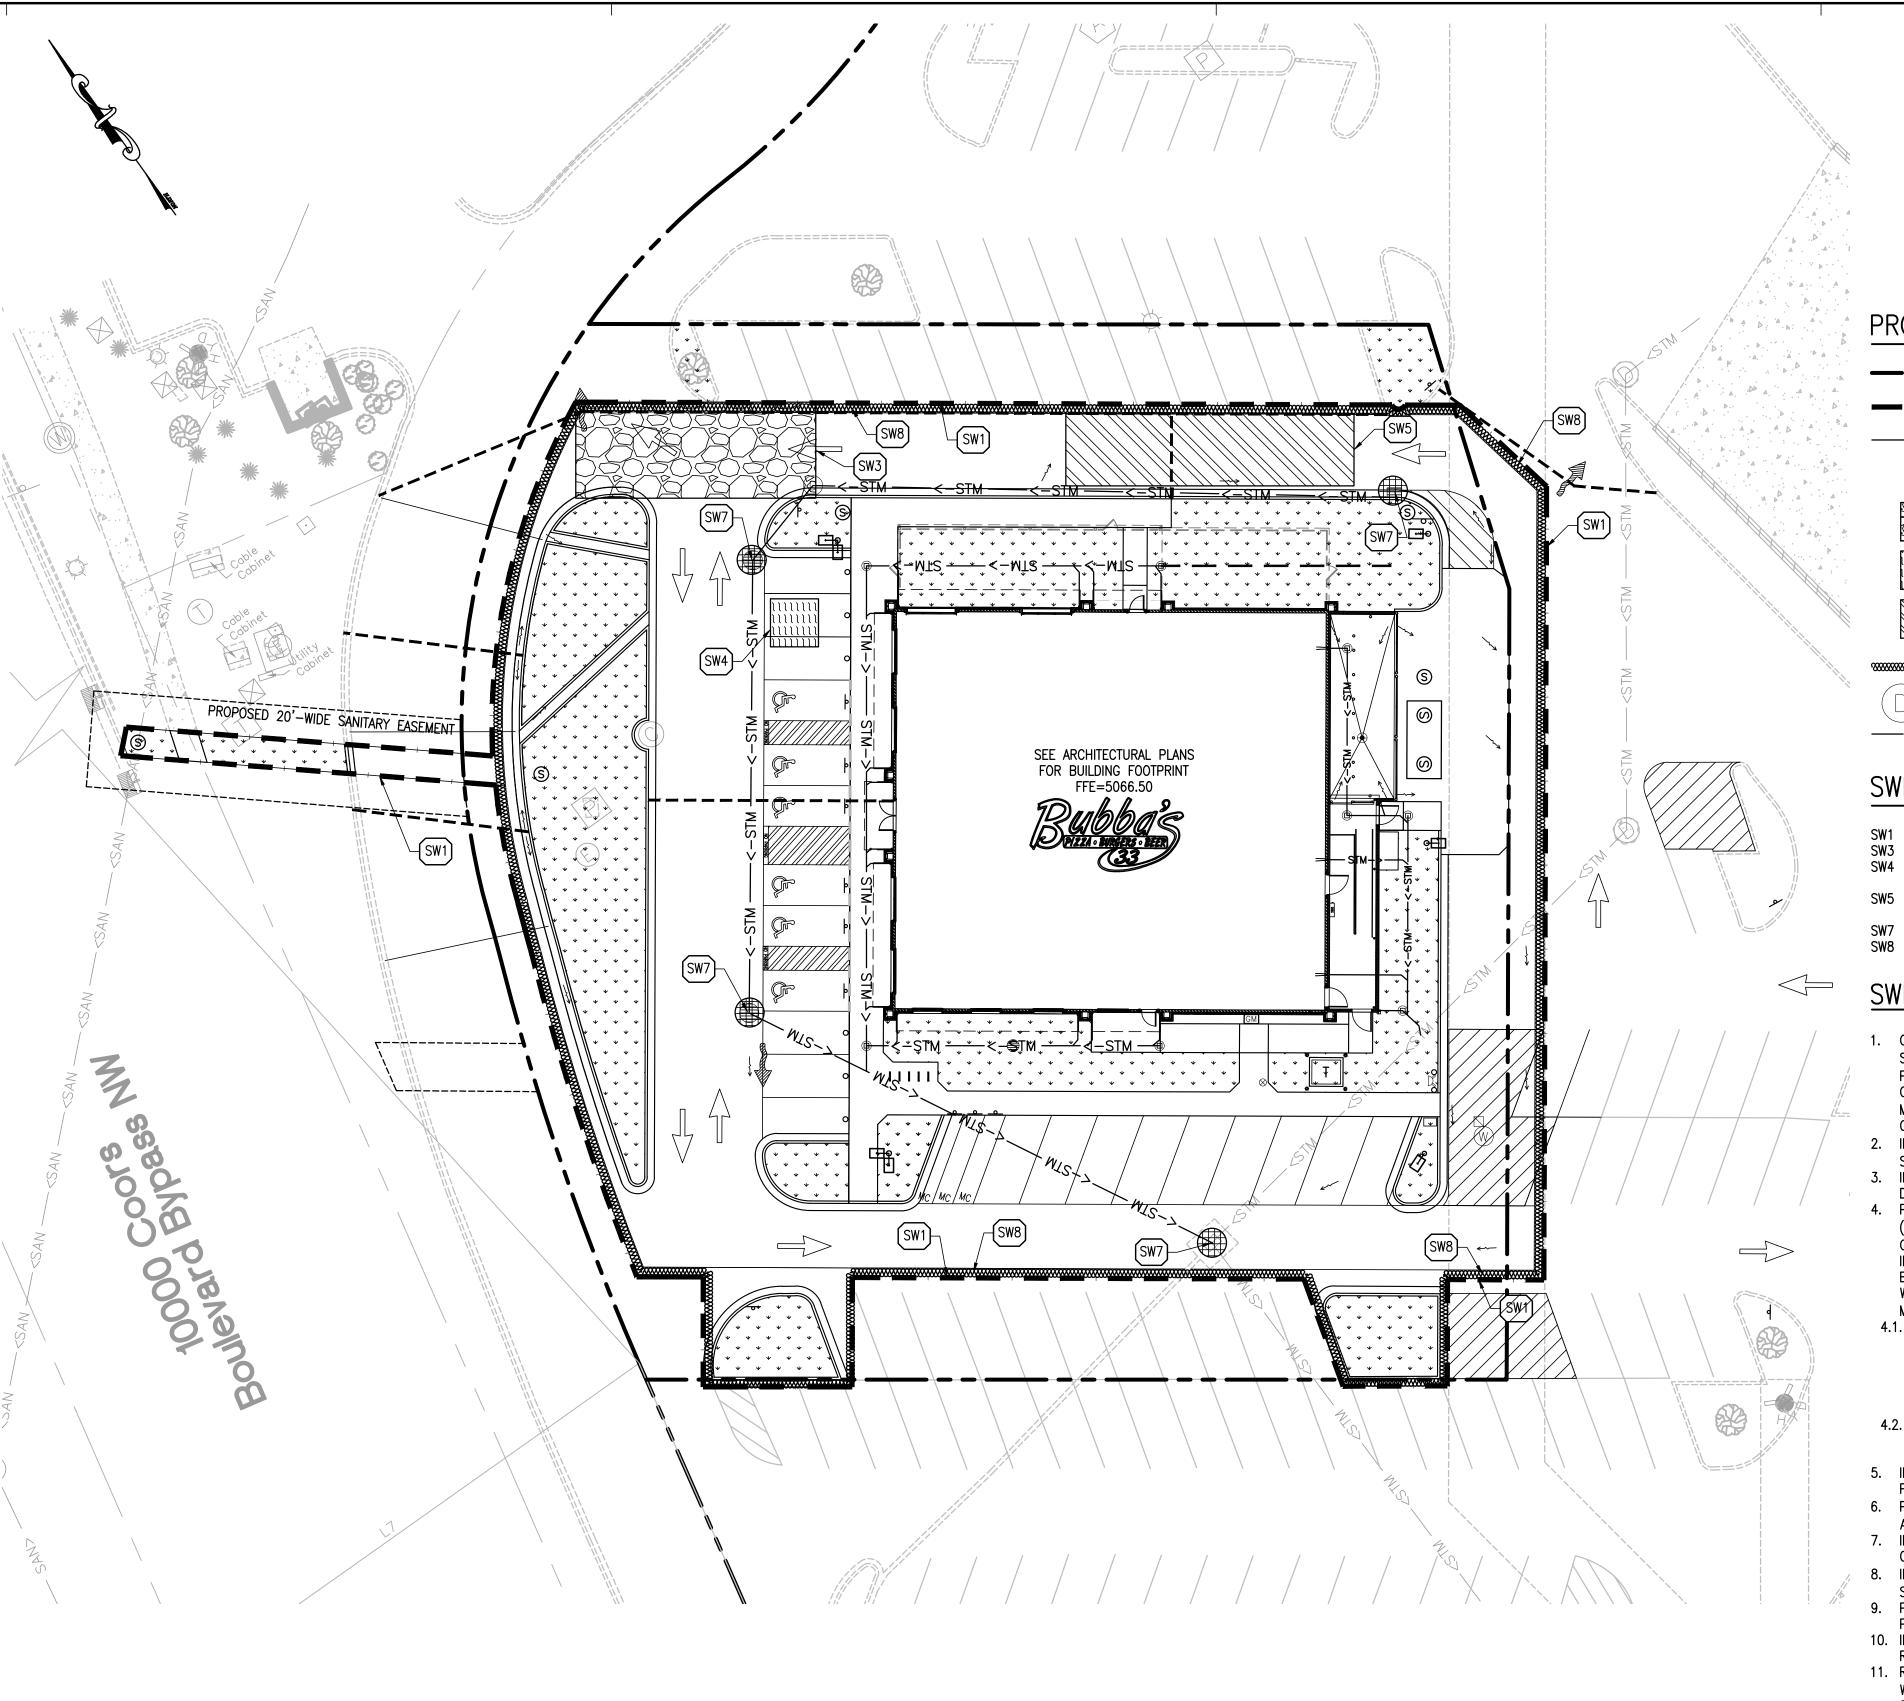



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PROFESSIONAL IN CHARGE

**ZACH MICHELS** 

PROFESSIONAL ENGINEER

PROJECT MANAGER

**QUALITY CONTROL** 

PROJECT NAME

BUBBA'S 33

**ALBUQUERQUE** 

**10000 COORS BYPASS NW** 

**ALBUQUERQUE, NM 87114** 

**NEW MEXICO** 

EDWARD GOSS

EDWARD GOSS

DRAWN BY

LICENSE NO. 28488

05/22/24 PERMIT SET

06/14/24 BID SET

PROJECT TEAM

## PROPOSED LEGEND:

— — — PROPERTY LINE

LAND DISTURBANCE LIMITS (SEE DISTURBED AREA TABLE)

PROPOSED SILT FENCE

PROPOSED INLET PROTECTION INSERT

PROPOSED CONCRETE WASHOUT (SUGGESTED LOCATION)

PROPOSED STABILIZED CONSTRUCTION ENTRANCE

PROPOSED CONTRACTOR STAGING AREA (SUGGESTED LOCATION)

PROPOSED GRAVEL FILTER BAG

PROPOSED STORM SEWER STRUCTURES

—— STM> —— PROPOSED STORM SEWER

SWPPP KEY NOTES:

SW1 PROPOSED PROJECT LAND DISTURBANCE LIMITS

SW3 PROPOSED STABILIZED CONSTRUCTION ENTRANCE SW4 PROPOSED CONCRETE WASHOUT WITH MINIMUM 30-MIL POLYETHYLENE LINING

AND LOCATION SIGNAGE SW5 PROPOSED CONTRACTOR STAGING AREA INCLUDING MATERIALS STORAGE,

COVERED TRASH DUMPSTER, AND PORTABLE TOILET FACILITIES

SW7 PROPOSED INLET PROTECTION SW8 PROPOSED GRAVEL FILTER BAG

## SWPPP/SESC CONSTRUCTION SCHEDULE:

- OBTAIN ALL APPLICABLE SITE PERMITS AND THOROUGHLY REVIEW PROJECT'S SOIL EROSION AND SEDIMENT CONTROL PLAN (SESC) OR STORMWATER POLLUTION PREVENTION PLANS (SWPPP) PRIOR TO COMMENCEMENT OF CONSTRUCTION OPERATIONS. CONTRACTOR SHALL BE RESPONSIBLE FOR MAINTAINING AND UPDATING THE SWPPP/SESC THROUGHOUT THE DURATION OF CONSTRUCTION AS NECESSARY UNTIL FINAL SITE STABILIZATION IS ACHIEVED. 2. INSTALL PERIMETER SEDIMENT CONTROL MEASURES (I.E. SILT FENCE AND
- STABILIZED CONSTRUCTION ENTRANCE). INSTALL INLET PROTECTION DEVICES FOR EXISTING STORM SEWER INLETS AND DRAINAGE STRUCTURES.
- 4. PERFORM SITE INSPECTIONS ON A WEEKLY BASIS AND WITHIN TWENTY-FOUR (24) HOURS OF THE END OF A RAINFALL EVENT THAT IS 0.5 INCH OR GREATER (OR EQUIVALENT SNOWFALL). AT A MINIMUM, THE INSPECTIONS SHALL INCLUDE THE DISTURBED AREAS OF THE CONSTRUCTION SITE THAT HAVE NOT BEEN FINALLY STABILIZED, ALL STRUCTURAL CONTROL MEASURES, LOCATIONS WHERE VEHICLES ENTER OR EXIT THE SITE, AND ANY ADDITIONAL BEST MANAGEMENT PRACTICES IDENTIFIED IN THE SWPPP/SESC.
- 4.1. ALL SITE EROSION AND SEDIMENT CONTROL MEASURES AND BEST MANAGEMENT PRACTICES SHALL BE THE RESPONSIBILITY OF THE GENERAL CONTRACTOR AND SHALL BE CONTINUOUSLY MAINTAINED THROUGHOUT THE DURATION OF CONSTRUCTION. CONTRACTOR SHALL MAKE AND COMPLETE THE REQUIRED REPAIRS WITHIN FORTY-EIGHT (48) HOURS OF THE INSPECTION. 4.2. CONTRACTOR IS RESPONSIBLE FOR INSTALLATION OF ANY ADDITIONAL
- STRUCTURAL CONTROL MEASURES NECESSARY TO PREVENT EROSION AND SEDIMENTATION AS DETERMINED BY THE SITE INSPECTIONS. 5. INSTALL NEW STORM SEWERS AND OTHER SITE UTILITIES AS INDICATED ON THE
- 6. PROVIDE TEMPORARY SEEDING AND/OR MULCHING FOR ALL DISTURBED SITE AREAS THAT WILL NOT BE WORKED ON FOR MORE THAN FOURTEEN (14) DAYS.
- 7. INSTALL TEMPORARY CONCRETE WASHOUT FACILITY PRIOR TO COMMENCEMENT OF ANY CONCRETE WORK ON SITE. 8. INSTALL CURBS AND BEGIN SITE PAVING OPERATIONS (I.E. DRIVEWAYS,
- SIDEWALKS, ETC.) 9. PERFORM STREET CLEANING OPERATIONS AND OTHER BEST MANAGEMENT PRACTICES AS NEEDED FOR AREAS ADJACENT TO THE PROJECT SITE.
- 10. INSTALL BUILDING FOUNDATION AND COMPLETE BUILDING CONSTRUCTION AND REMAINING SITE IMPROVEMENTS.
- 11. REMOVE ALL TEMPORARY SITE EROSION AND SEDIMENT CONTROL MEASURES WITHIN THIRTY (30) DAYS OF FINAL SITE STABILIZATION ONCE PERMANENT STABILIZATION OF THE ENTIRE SITE HAS BEEN COMPLETED AND ALL GROUND COVER IS ESTABLISHED.



20182050.0

SHEET TITLE


**STORMWATER POLLUTION** PREVETION PLAN

SHEET NUMBER

( IN FEET )

1 inch = 20 ft.

GRAPHIC SCALE

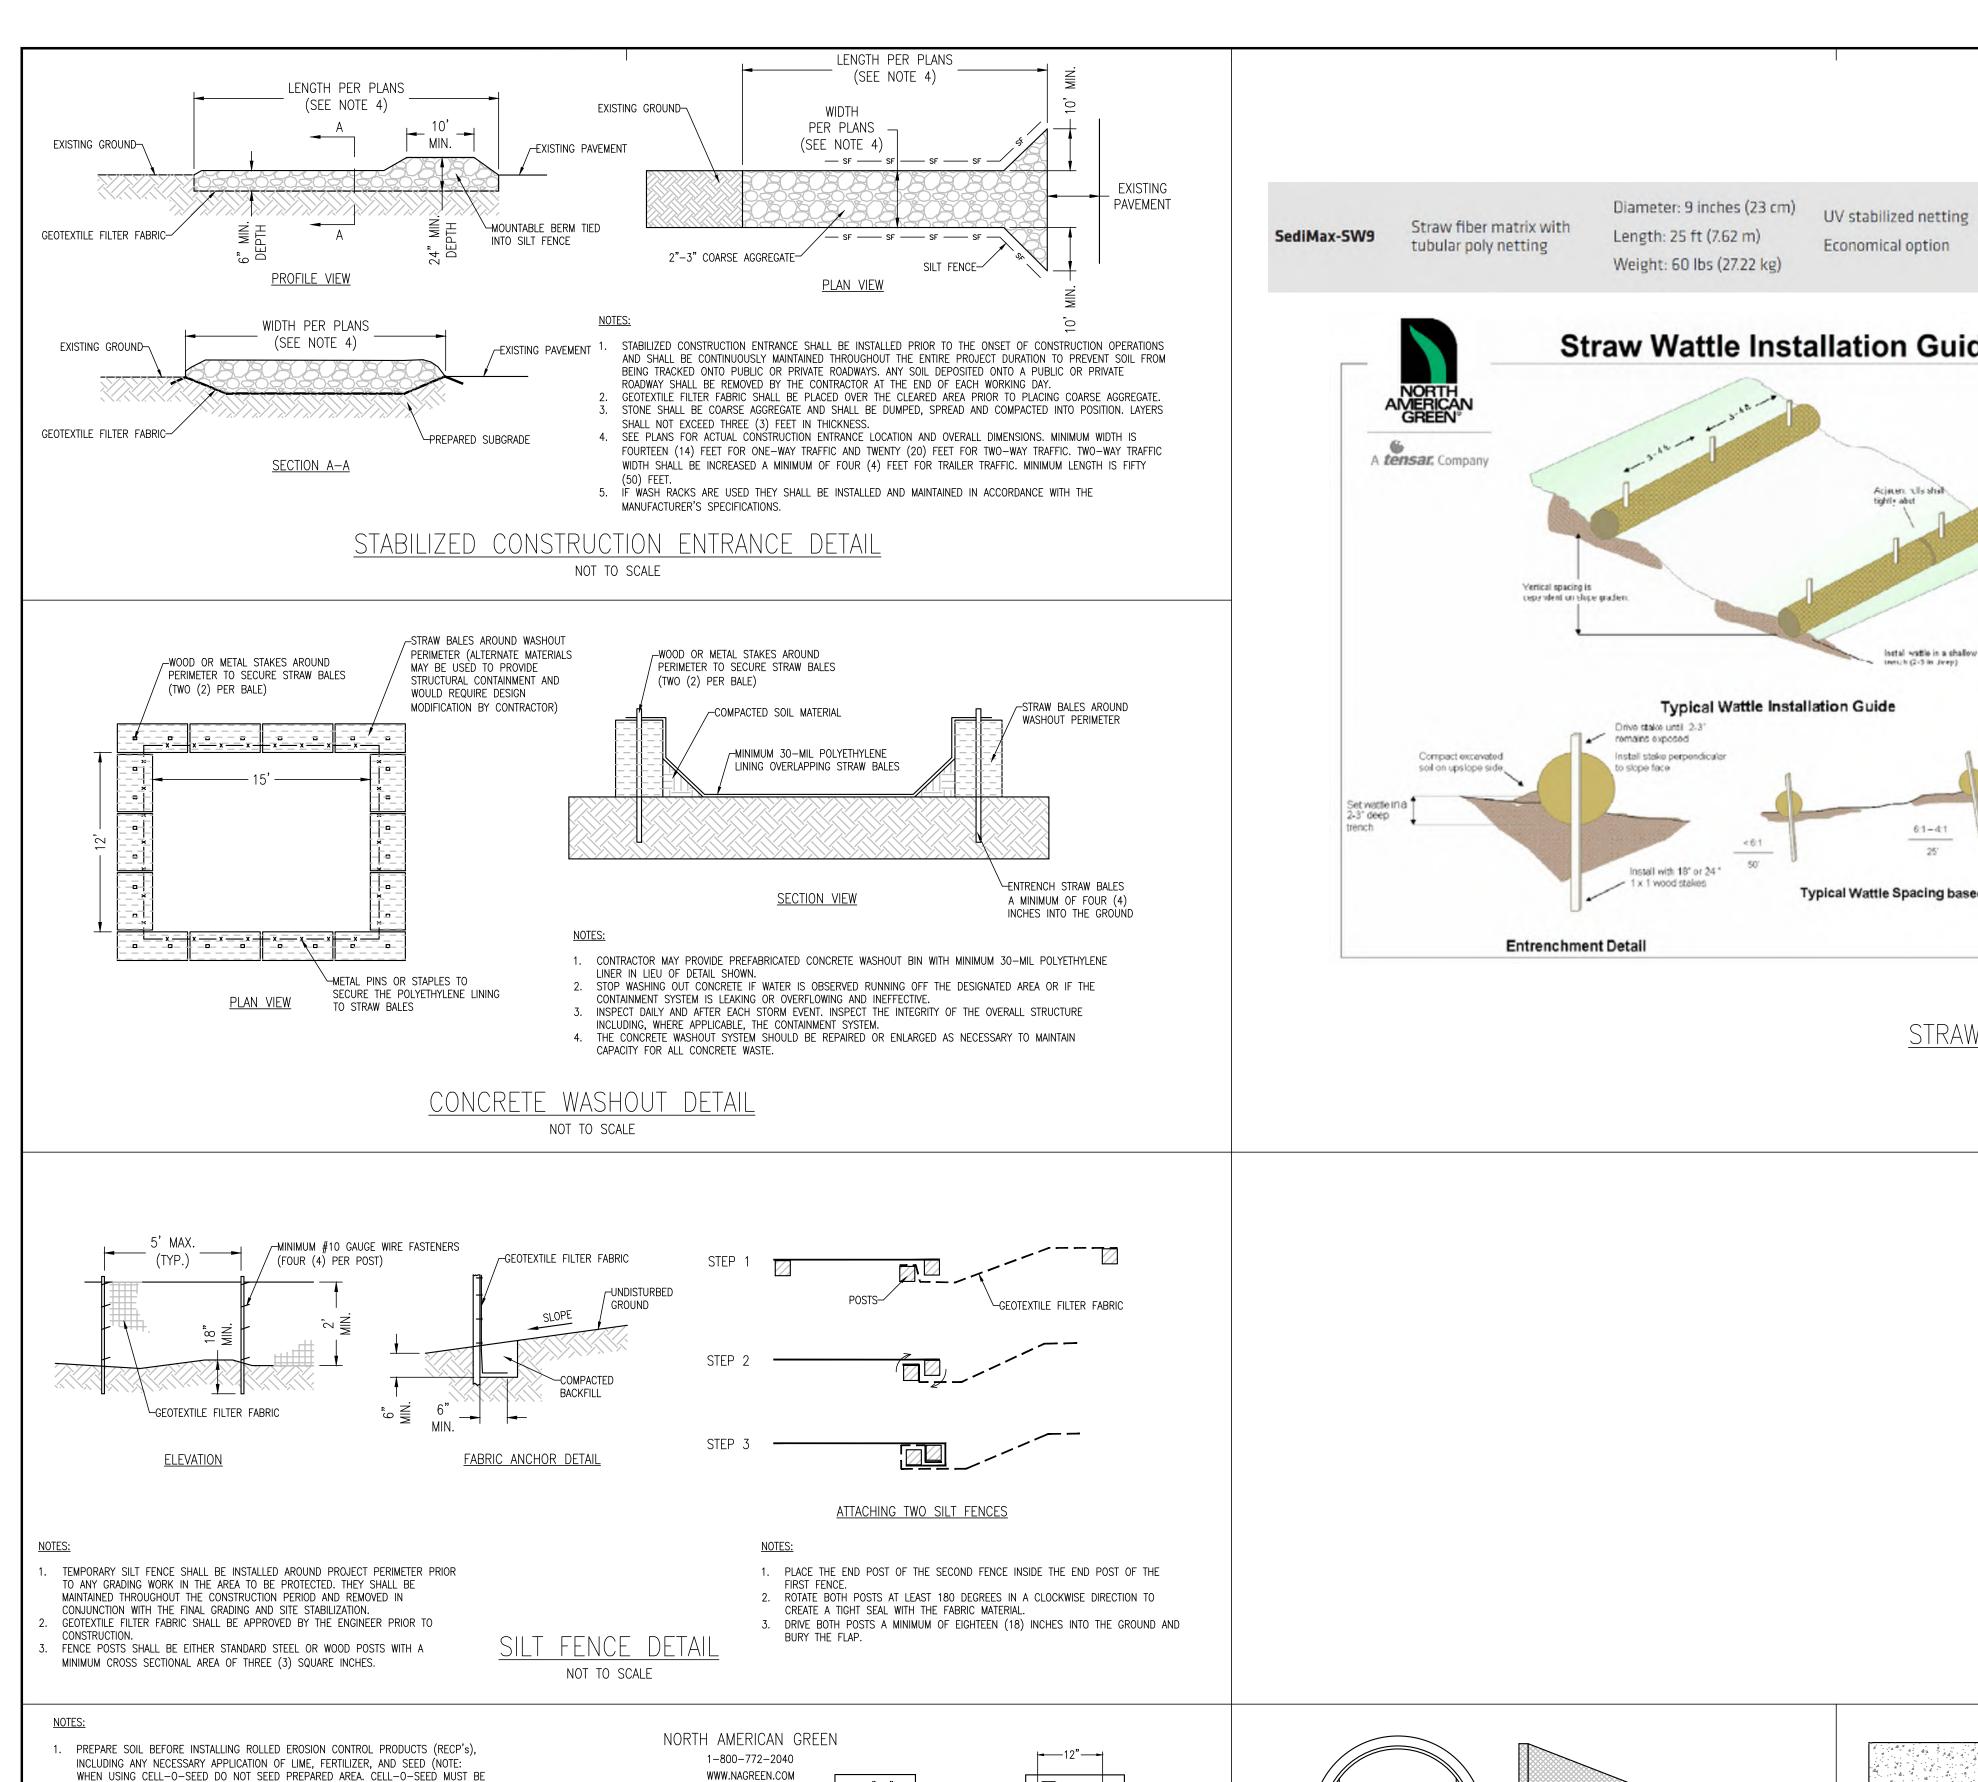

INSTALLED WITH PAPER SIDE DOWN).

ACROSS THE WIDTH OF THE RECP's.

2. BEGIN AT THE TOP OF THE SLOPE BY ANCHORING THE RECP'S IN A 6" (15 CM) DEEP X 6" (15 CM) WIDE TRENCH WITH APPROXIMATELY 12" (30cm) OF RECP's EXTENDED BEYOND THE UP-SLOPE PORTION OF THE TRENCH. ANCHOR THE RECP's

WITH A ROW OF STAPLES/STAKES APPROXIMATELY 12" (30 CM) APART IN THE BOTTOM OF THE TRENCH. BACKFILL AND COMPACT THE TRENCH AFTER STAPLING. APPLY SEED TO COMPACTED SOIL AND FOLD REMAINING 12" (30 CM) PORTION OF RECP'S BACK OVER SEED AND COMPACTED SOIL. SECURE RECP'S OVER COMPACTED SOIL WITH A ROW OF STAPLES/STAKES SPACED APPROXIMATELY 12" (30 CM) APART

3. ROLL THE RECP'S (A.) DOWN OR (B.) HORIZONTALLY ACROSS THE SLOPE. RECP'S

COLORED DOTS CORRESPONDING TO THE APPROPRIATE STAPLE PATTERN.

CM-12.5 CM) OVERLAP DEPENDING ON RECP'S TYPE.

NECESSARY TO PROPERLY SECURE THE RECP's).

WILL UNROLL WITH APPROPRIATE SIDE AGAINST THE SOIL SURFACE. ALL RECP'S MUST BE SECURELY FASTENED TO SOIL SURFACE BY PLACING STAPLES/STAKES IN

APPROPRIATE LOCATIONS AS SHOWN IN THE STAPLE PATTERN GUIDE. WHEN USING THE DOT SYSTEM, STAPLES/STAKES SHOULD BE PLACED THROUGH EACH OF THE

4. THE EDGES OF PARALLEL RECP'S MUST BE STAPLED WITH APPROXIMATELY 2"-5" (5

5. CONSECUTIVE RECP'S SPLICED DOWN THE SLOPE MUST BE PLACED END OVER END

6. ONLY BIODEGRADABLE STAPLES SHALL BE USED (NOTE: IN LOOSE SOIL CONDITIONS, THE USE OF STAPLE OR STAKE LENGTHS GREATER THAN 6" (15 CM) MAY BE

EROSION CONTROL BLANKET DETAIL

NOT TO SCALE

(SHINGLE STYLE) WITH AN APPROXIMATE 3" (7.5 CM) OVERLAP. STAPLE THROUGH

OVERLAPPED AREA, APPROXIMATELY 12" (30 CM) APART ACROSS ENTIRE RECP's

Slope breaks **Straw Wattle Installation Guide** loctal wattle in a challow Typical Wattle Installation Guide Drive stake until 2-3" remains exposed 21-1:1 Install stake perpendicular slope face Install with 18" or 24 " 1 x 1 wood stakes Typical Wattle Spacing based on Slope Gradient

Economical option

STRAW WATTLE DETAIL NOT TO SCALE

#### **OPERATION & MAINTENANCE**

Highway and construction sites

Perimeter control

Inlet capture

Sediment shall be removed from the upstream side of the ditch check when sediment has reached one-half the height of the ditch check. Inspect any fabric for tears or dislodging after sediment is removed and repair or replace immediately. Additional requirements may apply per manufacturer specifications or permit requirements.

Products shall be maintained in same condition as when installed. Rolled erosion control ditch checks must be replaced whenever tears, splits, unraveling or compressed straw or excelsior is apparent.

Any fabric used as a base or apron underneath the plastic permeable or synthetic porous runoff control structure ditch checks that is torn or dislodged must be replaced or repaired.

Remove debris (litter, corn stalks) when observed.

Water or sediment going around the ditch check indicates incorrect installation or that maintenance is required. The flow of water over the center of the ditch check or through the device must be reestablished. The manufactured ditch check may need lengthening up the side slope, sediment removed from the pores, or the flow velocities are too great for the type of ditch check.

Manufactured ditch checks are not designed to be part of the permanent storm water system. Their material components are not conducive to being incorporated into soils once they have reached their useful life.

Remove manufactured ditch checks once all upslope areas are stabilized and swale or ditch stabilization is complete. The biodegradable form of plastic permeable ditch checks can be left in place on top of the permanent stabilization such as blankets to provide velocity reductions provided they are not a hazard to mowing operations. Vegetated ditch checks may remain in place within the ditch or swale if permanent vegetation is desired, such as in the case of establishing a vegetated swale.

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PROJECT TEAM

ISSUE/REVISION RECORD DESCRIPTION

04/11/24 COORDINATION SET 05/22/24 PERMIT SET 06/14/24 BID SET 07/12/24 PERMIT RESPONSE 07/24/24 PERMIT RESPONSE

**PROFESSIONAL SEAL** 



PROFESSIONAL IN CHARGE **ZACH MICHELS** PROFESSIONAL ENGINEER

LICENSE NO. 28488 **PROJECT MANAGER** EDWARD GOSS **QUALITY CONTROL** EDWARD GOSS

DRAWN BY

PROJECT NAME

BUBBA'S 33

**ALBUQUERQUE NEW MEXICO** 

**10000 COORS BYPASS NW ALBUQUERQUE, NM 87114** 



PROJECT NUMBER 20182050 (

SHEET TITLE


**STORMWATER POLLUTION** PREVETION DETAILS

**SHEET NUMBER** 

1. FRAME: TOP FLANGE FABRICATED FROM 1-1/4"X1-1/4"X1-1/8" CHANNEL. HANDLES AND SUSPENSION BRACKETS FABRICATED FROM 1-1/4"X1-1/4"FLAT STOCK. ALL DOMESTIC STEEL CONFORMING TO ASTM-A36. SEDIMENT BAG: BAG FABRICATED FROM 4 OZ./SQ.YD. NON-WOVEN POLYPROPYLENE GEOTEXTILE REINFORCED WITH POLYESTER MESH. BAG SECURED TO BASE RIM WITH A STAINLESS STEEL STRAP AND CATCH-ALL INLET PROTECTION DETAIL

NOT TO SCALE

THE DIKE SHOULD BE FOLDED UNDER THE DIKE CONSTRUCTION DIKE SECTION ADHESIVE SHALL BE PLACED WHERE THE UNITS CONCRETE PAVEMENT USE LIQUID NAIL OR APPROVED EQUAL. OVERLAP AND A 20" STRIP ALONG BOTH EDGES. ASPHALT PAVEMENT USE EMULSIFIED ASPHALT. FXISTING CONCRETE OR ASPHALT PAVEMENT SILT DIKE ON PAVEMENT DETAIL NOT TO SCALE

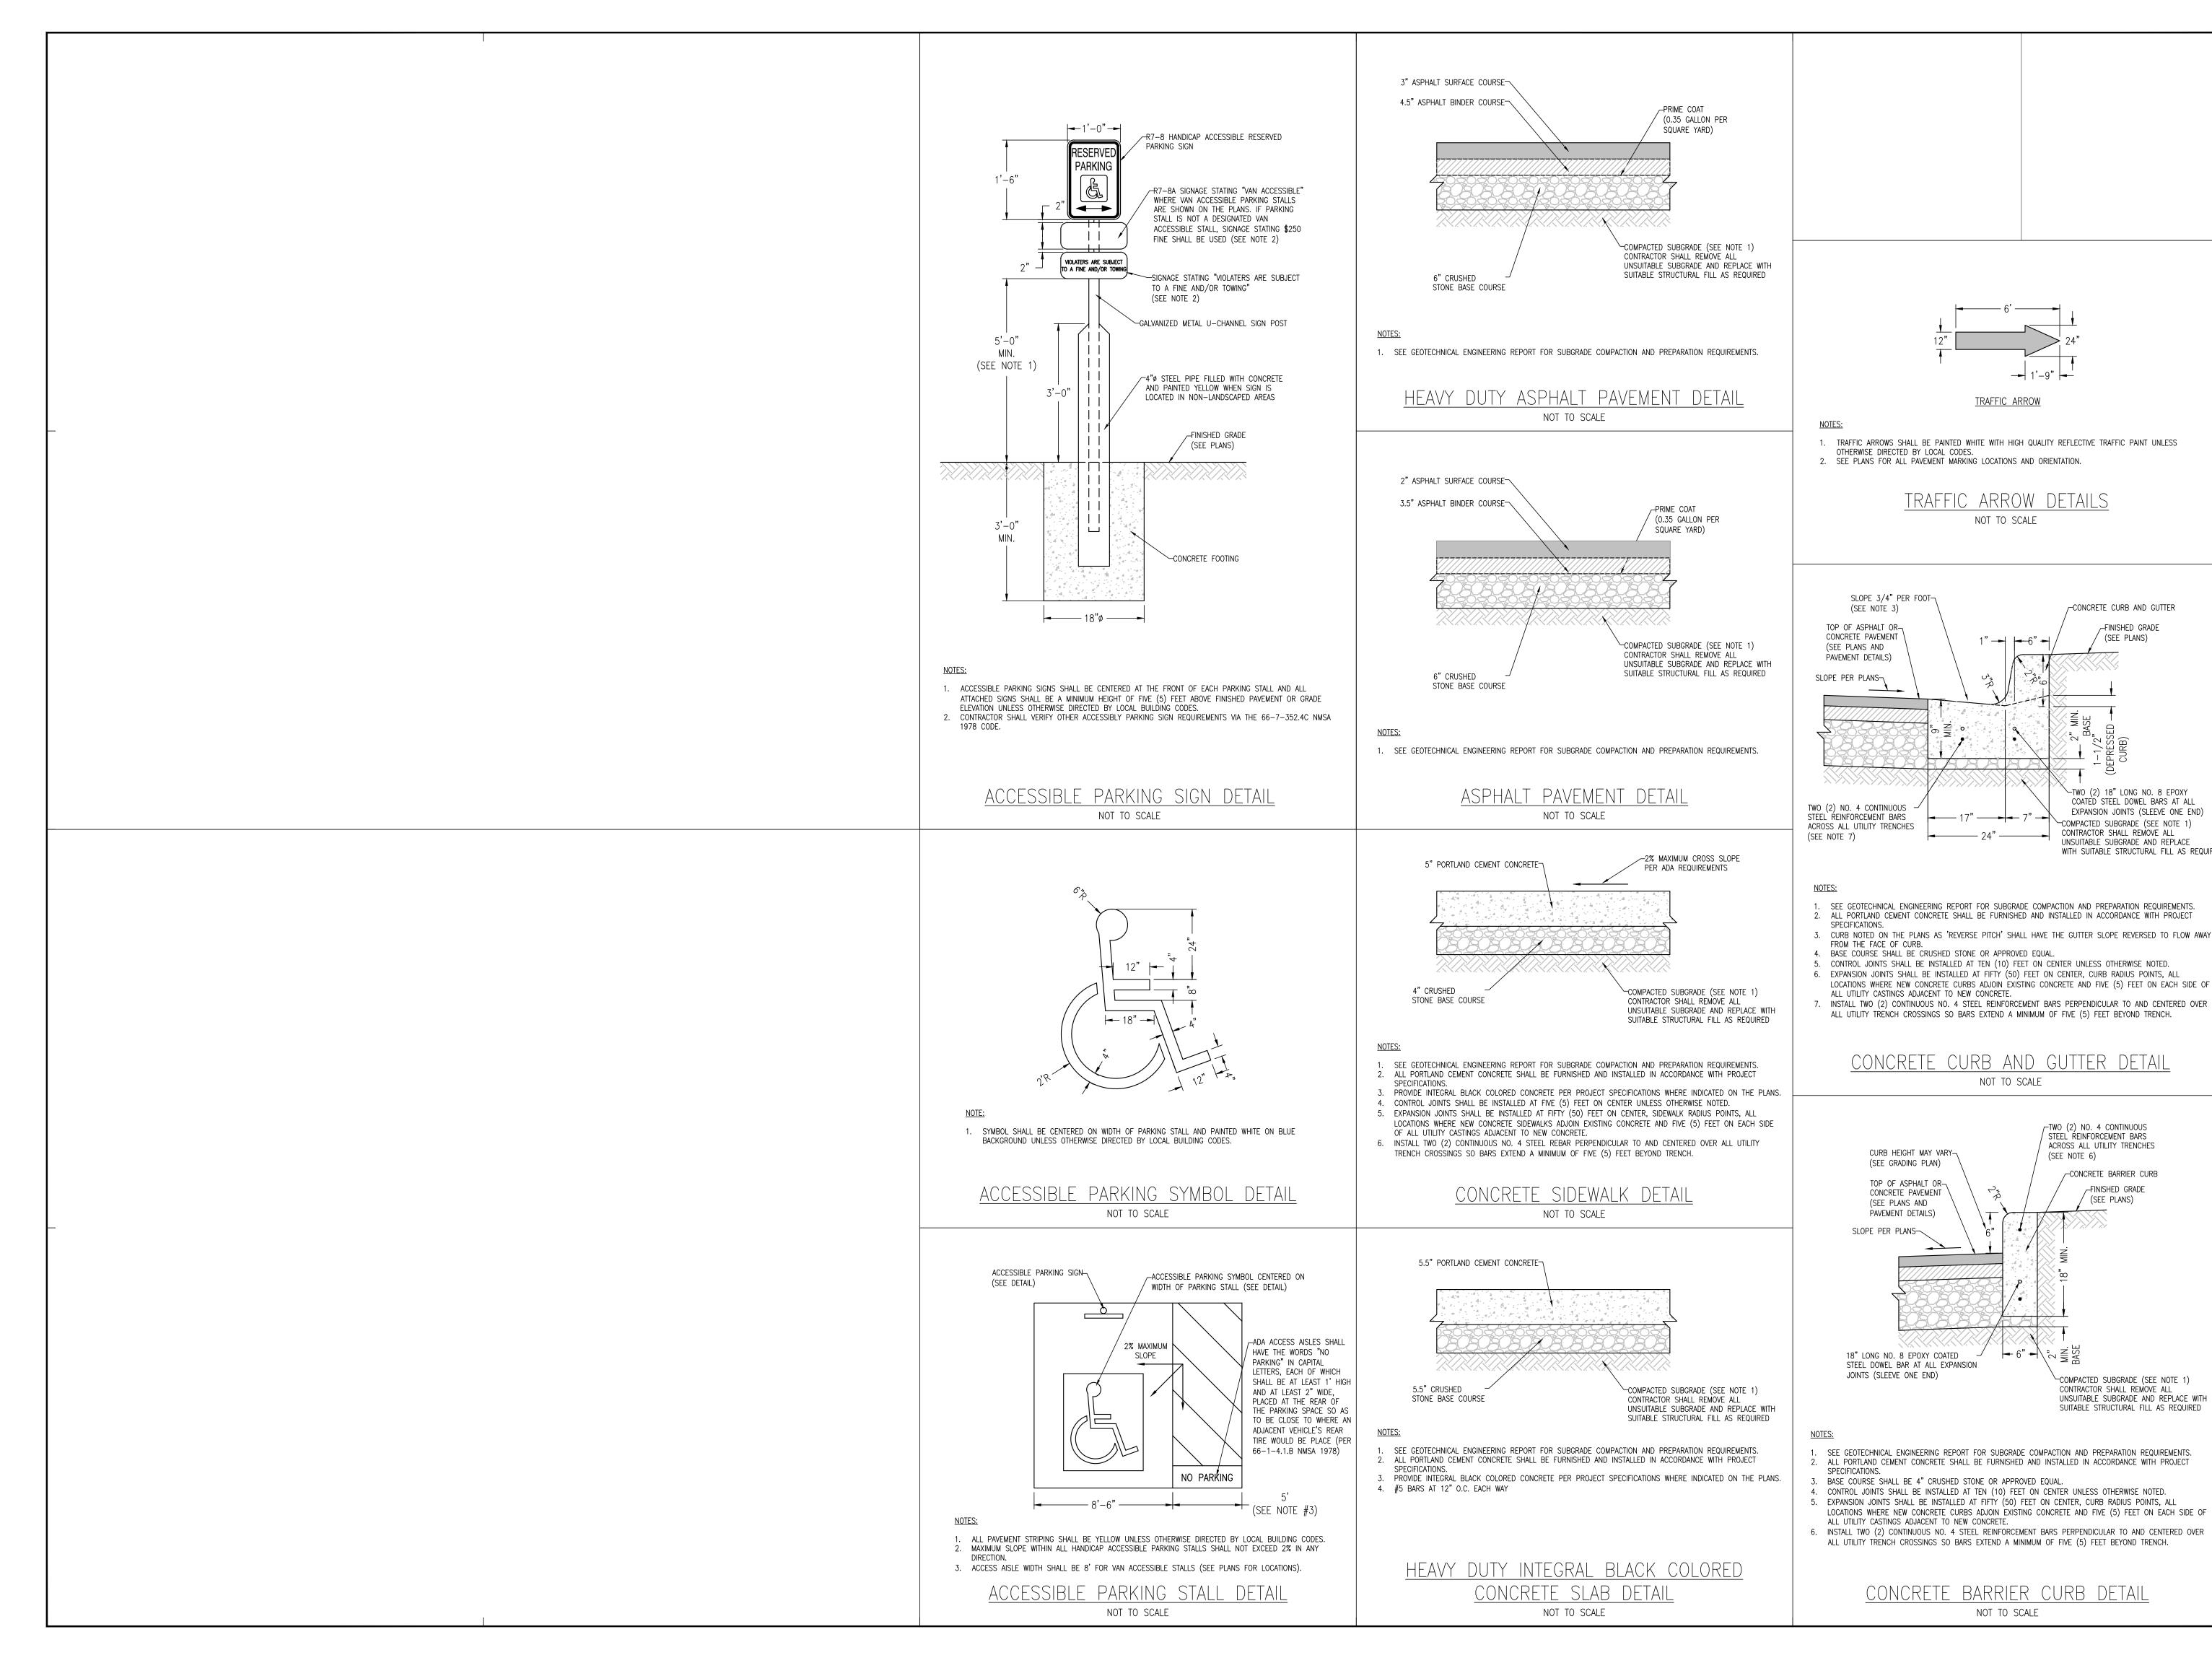



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referenced Professional and is not to be specific project and site names herein.

**PROJECT TEAM** 

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**ISSUE/REVISION RECORD** 

DESCRIPTION 04/11/24 COORDINATION SET

05/22/24 PERMIT SET 06/14/24 BID SET

07/12/24 PERMIT RESPONSE 07/24/24 PERMIT RESPONSE

CONCRETE CURB AND GUTTER

FINISHED GRADE

-TWO (2) 18" LONG NO. 8 EPOXY COATED STEEL DOWEL BARS AT ALL

-COMPACTED SUBGRADE (SEE NOTE 1)

UNSUITABLE SUBGRADE AND REPLACE WITH SUITABLE STRUCTURAL FILL AS REQUIRED

CONTRACTOR SHALL REMOVE ALL

\_TWO (2) NO. 4 CONTINUOUS

STEEL REINFORCEMENT BARS

(SEE NOTE 6)

ACROSS ALL UTILITY TRENCHES

CONCRETE BARRIER CURB

(SEE PLANS)

\_FINISHED GRADE

└COMPACTED SUBGRADE (SEE NOTE 1)

UNSUITABLE SUBGRADE AND REPLACE WITH

SUITABLE STRUCTURAL FILL AS REQUIRED

CONTRACTOR SHALL REMOVE ALL

EXPANSION JOINTS (SLEEVE ONE END)

(SEE PLANS)



PROFESSIONAL IN CHARGE ZACH MICHELS PROFESSIONAL ENGINEER LICENSE NO. 28488

PROJECT MANAGER EDWARD GOSS **QUALITY CONTROL** 

EDWARD GOSS DRAWN BY

PROJECT NAME BUBBA'S 33


**ALBUQUERQUE NEW MEXICO** 

**10000 COORS BYPASS NW** ALBUQUERQUE, NM 87114



PROJECT NUMBER

SHEET TITLE **CONSTRUCTION DETAILS** 

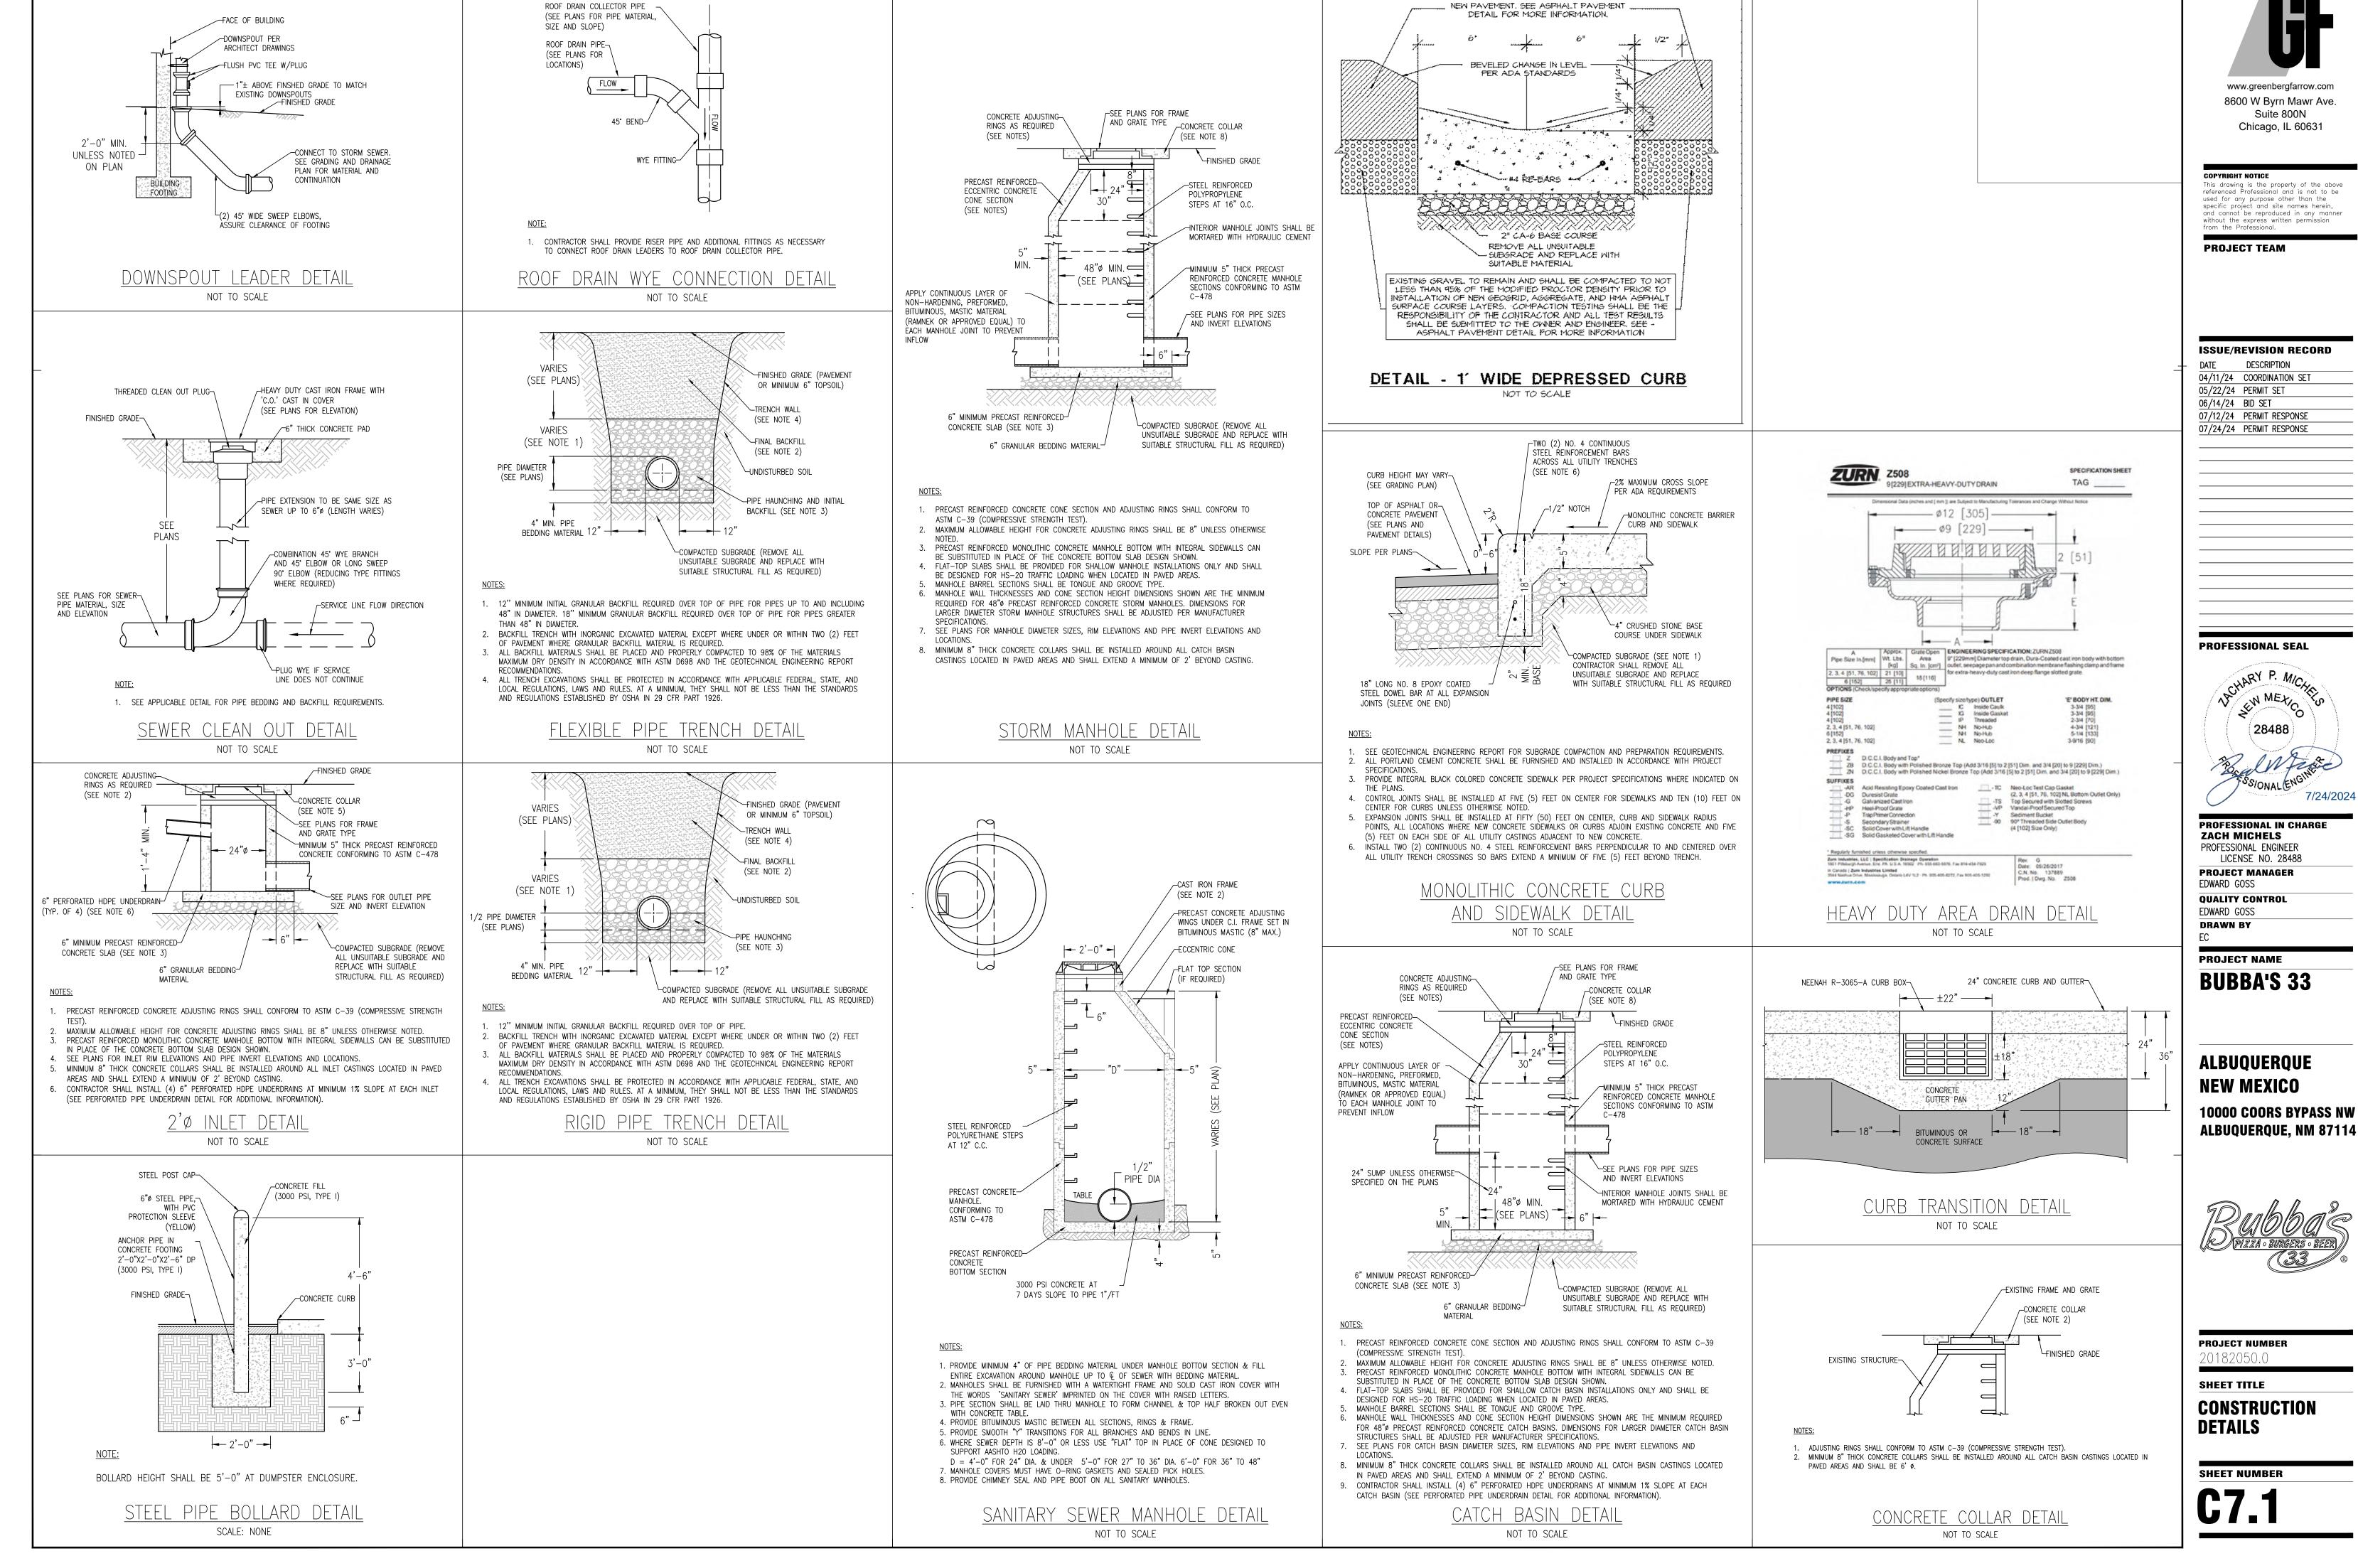


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ALBUQUERQUE, NM 87114



√4"ø STEEL PIPE FILLED WITH CONCRETE


AND PAINTED YELLOW WHEN SIGN IS

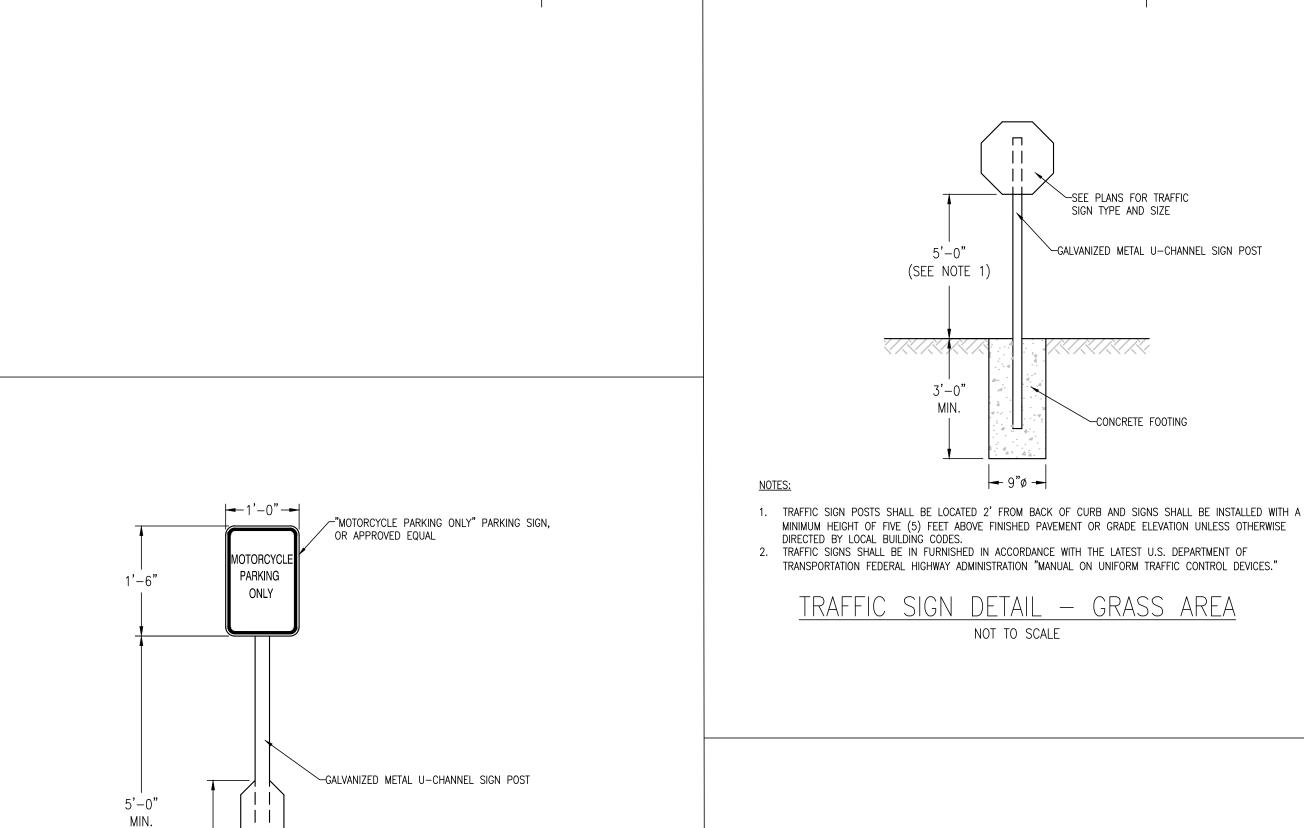LOCATED IN NON-LANDSCAPED AREAS

FINISHED GRADE

(SEE PLANS)

CONCRETE FOOTING

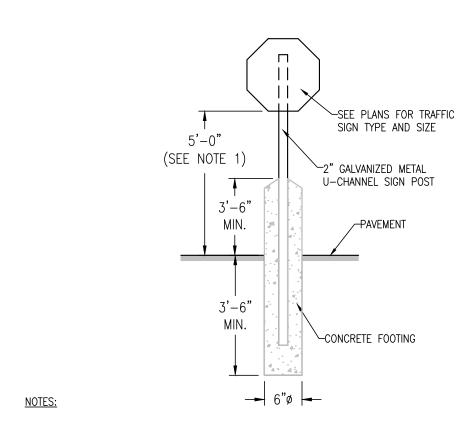

- 1. TRAFFIC SIGN POSTS SHALL BE LOCATED 2' FROM BACK OF CURB AND SIGNS SHALL BE INSTALLED WITH A MINIMUM HEIGHT OF FIVE (5) FEET ABOVE FINISHED PAVEMENT OR GRADE ELEVATION UNLESS OTHERWISE DIRECTED BY LOCAL BUILDING CODES.
- 2. TRAFFIC SIGNS SHALL BE IN FURNISHED IN ACCORDANCE WITH THE LATEST U.S. DEPARTMENT OF TRANSPORTATION FEDERAL HIGHWAY ADMINISTRATION "MANUAL ON UNIFORM TRAFFIC CONTROL DEVICES."

SIGN, POST & BOLLARD DETAIL -PAVED AREAS NOT TO SCALE





R5-1 DO NOT ENTER SIGN DETAIL NOT TO SCALE





R6-2L ONE WAY (ARROW) R6-2R ONE WAY (ARROW (RIGHT) SIGN DETAIL (LEFT) SIGN DETAIL NOT TO SCALE NOT TO SCALE 

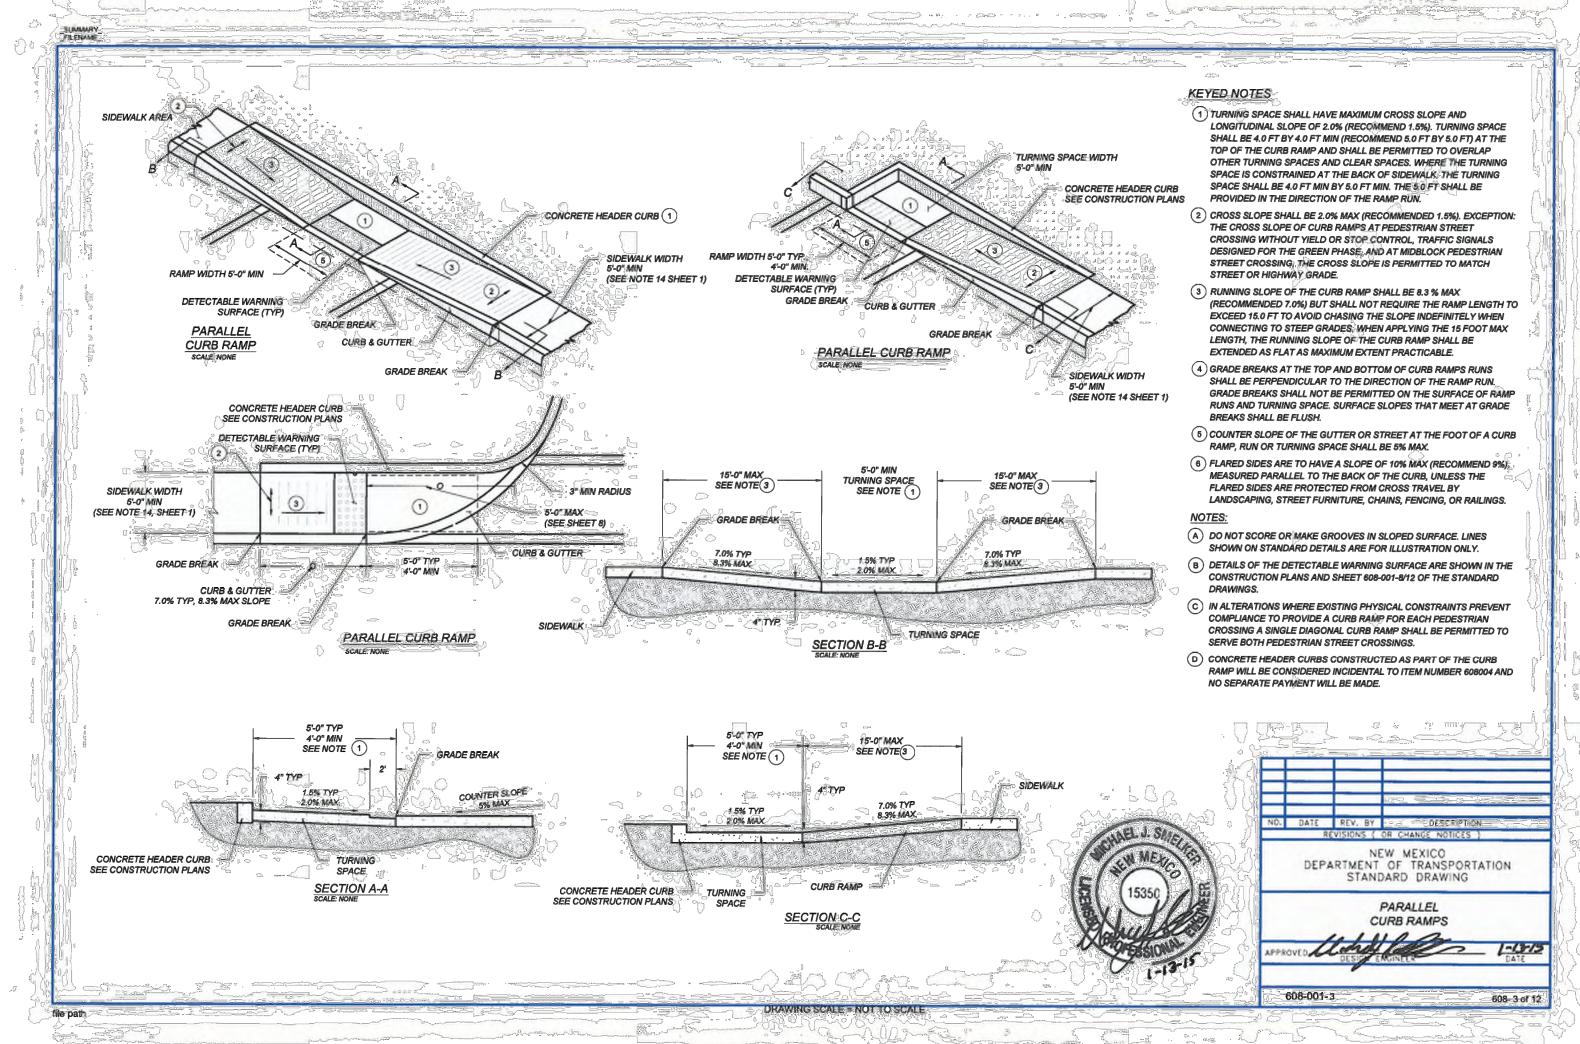

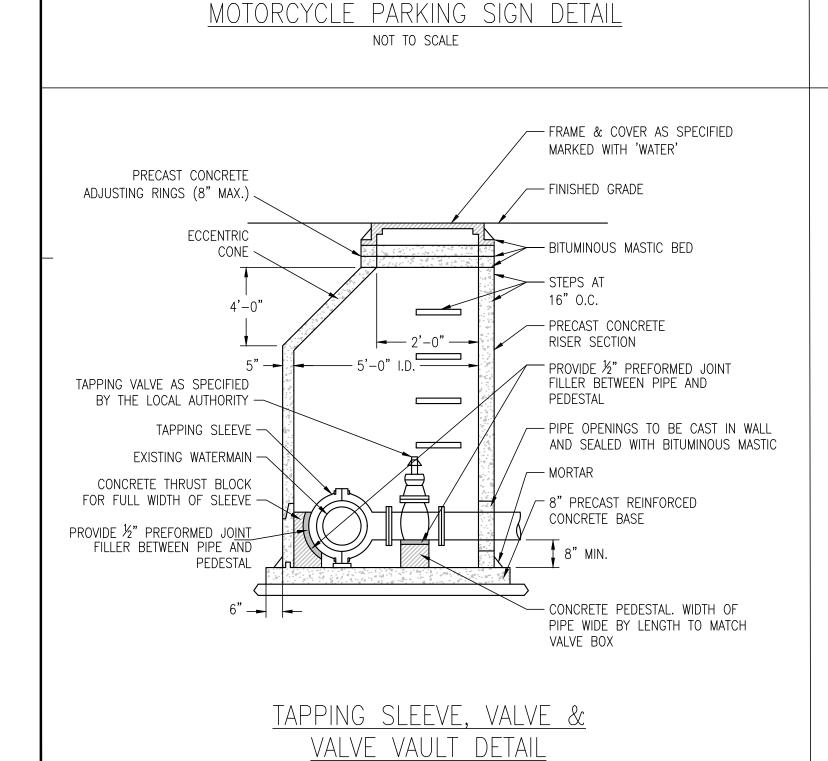

SCALE: NONE


1. MOTORCYCLE PARKING SIGNS SHALL BE CENTERED AT THE FRONT OF EACH PARKING STALL AND ALL

ELEVATION UNLESS OTHERWISE DIRECTED BY LOCAL BUILDING CODES.

ATTACHED SIGNS SHALL BE A MINIMUM HEIGHT OF FIVE (5) FEET ABOVE FINISHED PAVEMENT OR GRADE

(SEE NOTE 1)

NOTES:

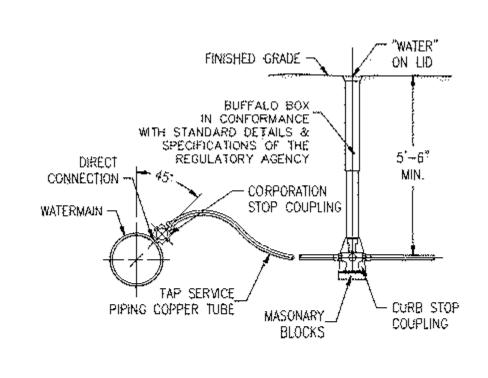

1. SERVICE PIPE TO BE WEAVED IN TRENCH TO ALLOW AT LEAST ONE (1) FOOT EXTRA LENGTH

- 2. UPON COMPLETION OF WATER SERVICE CONSTRUCTION ALL BOXES ARE TO BE FULLY EXTENDED AND LEFT PROTRUDING ABOVE THE PROPOSED GRADE.
- 3. GRANULAR BACKFILL TO BE PLACED UNDER PAVEMENT AS SPECIFIED.
- JET ALL TRENCHES.

WATER SERVICE DETAIL SCALE: NONE



1. THE BIKE RACK IS 36.625" IN HEIGHT WHICH EXCEEDS THE 30" HEIGHT MINIMUM THE BIKE RACK IS 19.25" WIDE WHICH EXCEEDS THE 18" MINIMUM. THE BIKE RACK IS SUPPORTED HORIZONTALLY IN TWO PLACES.


4. THE BIKE RACK SUPPORTS BICYCLES IN AN UPRIGHT POSITION. 5. THE BIKE RACK ALLOWS VARYING BICYCLE FRAME SIZES AND STYLES TO BE ATTACHED. 6. THE USER IS NOT REQUIRED TO LIFT THE BICYCLE TO LOCK IT TO 7. EACH BICYCLE PARKING SPACE IS ACCESSIBLE WITHOUT MOVING

8. THE BIKE RACK WILL BE ANCHORED TO A CONCRETE PAD.

ANOTHER BICYCLE.

BIKE RACK DETAIL

NOT TO SCALE

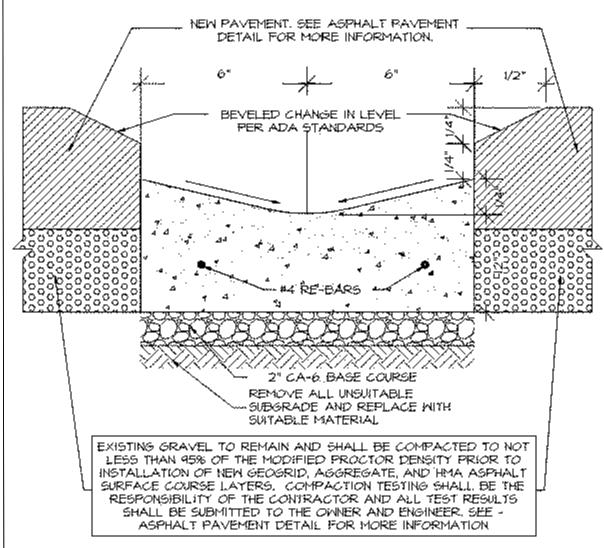

DETAIL - 1' WIDE DEPRESSED CURB

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**ISSUE/REVISION RECORD** DESCRIPTION 04/11/24 COORDINATION SET 05/22/24 PERMIT SET 06/14/24 BID SET 07/12/24 PERMIT RESPONSE 07/24/24 PERMIT RESPONSE

**PROFESSIONAL SEAL** 



PROFESSIONAL IN CHARGE ZACH MICHELS

PROFESSIONAL ENGINEER LICENSE NO. 28488 **PROJECT MANAGER** EDWARD GOSS **QUALITY CONTROL** 

EDWARD GOSS **DRAWN BY** 

**PROJECT NAME BUBBA'S 33** 

**ALBUQUERQUE NEW MEXICO 10000 COORS BYPASS NW** 


ALBUQUERQUE, NM 87114



**PROJECT NUMBER** 

SHEET TITLE

**CONSTRUCTION DETAILS** 

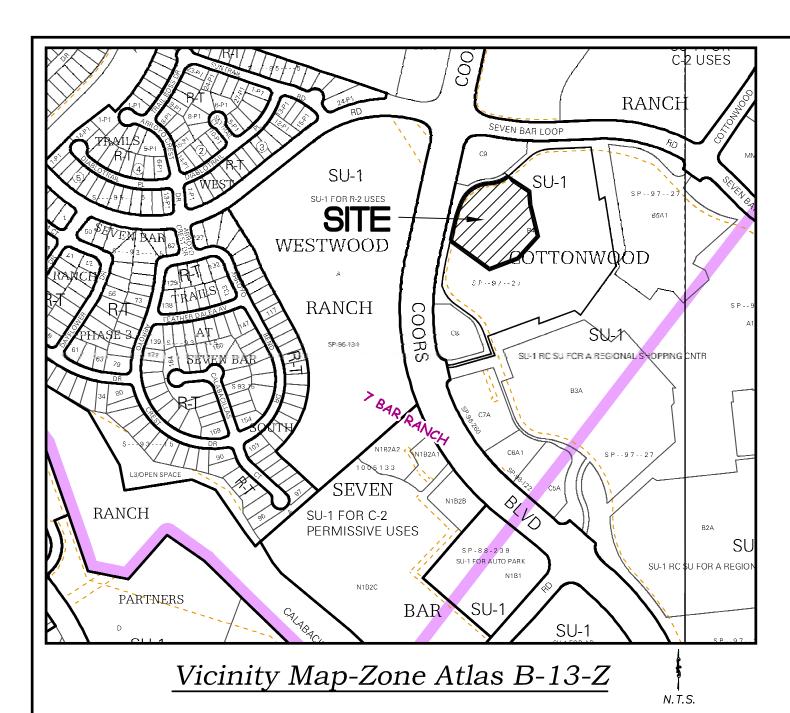

## Exceptions 9-19

- RESERVATIONS CONTAINED IN PATENT FROM UNITED STATES OF AMERICA RECORDED IN BOOK 64, PAGE 412, RECORDS OF BERNALILLO COUNTY, NEW MEXICO.

  AFFECTS SUBJECT PROPERTY BLANKET IN NATURE
- (10) COVENANTS, CONDITIONS, RESTRICTIONS, TERMS, PROVISIONS AND EASEMENTS AS SHOWN AND NOTED ON PLATS BOOK 95C, FOLIO 5, BOOK 95C, FOLIO 263 AND IN BOOK 97C, FOLIO 33, RECORDS OF BERNALILLO COUNTY, NEW MEXICO, BUT DELETING ANY COVENANT, CONDITION OR RESTRICTION INDICATING A PREFERENCE, LIMITATION OR DISCRIMINATION BASED ON RACE, COLOR, RELIGION, SEX, HANDICAP, FAMILIAL STATUS, OR NATIONAL ORIGIN TO THE EXTENT SUCH COVENANTS, CONDITIONS OR RESTRICTIONS VIOLATE 42 USC

## AFFECTS SUBJECT PROPERTY - EASEMENTS SHOWN HEREON AS 116789 10 11 AND 12

- 11 RIGHT OF WAY EASEMENT GRANTED TO THE MOUNTAIN STATES TELEPHONE AND TELEGRAPH COMPANY BY DOCUMENT, FILED APRIL 21, 1965, RECORDED IN BOOK RW 143, PAGE 329, RECORDS OF BERNALILLO COUNTY, NEW MEXICO. DOES NOT AFFECT SUBJECT PROPERTY
- 12 AMENDED AND RESTATED RIGHT OF WAY GRANTED BY AND BETWEEN GAS COMPANY OF NEW MEXICO, A NEW MEXICO CORPORATION AND SIMON PROPERTY GROUP, L.P., A DELAWARE LIMITED PARTNERSHIP, FILED SEPTEMBER 20, 1994, RECORDED IN BOOK 9426, PAGE 9234, AS DOCUMENT NO. 94114777, RECORDS OF BERNALILLO COUNTY, NEW MEXICO DOES NOT AFFECT SUBJECT PROPERTY
- 13 EASEMENT AGREEMENT BETWEEN SIMON PROPERTY GROUP, L.P., A DELAWARE LIMITED PARTNERSHIP AND THE CITY OF ALBUQUERQUE, NEW MEXICO. FILED JANUARY 5, 1995, RECORDED IN BOOK 951, PAGE 2613, AS DOCUMENT NO. 95001280, RECORDS OF BERNALILLO COUNTY, NEW MEXICO.

  DOES NOT AFFECT SUBJECT PROPERTY
- 14 EASEMENT AGREEMENT BETWEEN SIMON PROPERTY GROUP, L.P., A DELAWARE LIMITED PARTNERSHIP AND NEW MEXICO UTILITIES, INC., A NEW MEXICO CORPORATION, FILED JANUARY 5, 1995, RECORDED IN BOOK 951, PAGE 2894, AS DOCUMENT NO. 95001389, RECORDS OF BERNALILLO COUNTY, NEW MEXICO.

  AFFECTS SUBJECT PROPERTY SHOWN HEREON AS [2]
- 15 SUPPLEMENT TO PUBLIC UTILITY EASEMENTS BETWEEN SIMON PROPERTY GROUP, L.P., A DELAWARE LIMITED PARTNERSHIP AND PUBLIC SERVICE COMPANY OF NEW MEXICO, FILED JANUARY 9, 1995, RECORDED IN BOOK 951, PAGE 4913, AS DOCUMENT NO. 95002255, RECORDS OF BERNALILLO COUNTY, NEW MEXICO. DOES NOT AFFECTS SUBJECT PROPERTY
- (16) CONSTRUCTION, OPERATION AND RECIPROCAL EASEMENT AGREEMENT FILED DECEMBER 28, 1995, RECORDED IN BOOK 9531, PAGE 5334, AS DOCUMENT NO. 95132176, RECORDS OF BERNALILLO COUNTY, NEW MEXICO. ASSIGNMENT AND ASSUMPTION OF OPERATING AGREEMENTS FILED SEPTEMBER 23, 2004, RECORDED IN BOOK A84, PAGE 4099, AS DOCUMENT NO. 2004134467, RECORDS OF BERNALILLO COUNTY, NEW MEXICO. AFFECTS SUBJECT PROPERTY BLANKET IN NATURE
- AGREEMENT REGARDING RESTRICTION OF RESERVE TRACTS FILED DECEMBER 28, 1995, RECORDED IN BOOK 9531, PAGE 5550, AS DOCUMENT NO. 95132177, RECORDS OF BERNALILLO COUNTY, NEW MEXICO.

  AFFECTS SUBJECT PROPERTY BLANKET IN NATURE
- 18 LEASE AND RESTRICTIVE COVENANTS AND EXCLUSIVE USE RIGHTS AS CONTAINED THEREIN, BETWEEN MALL AT COTTONWOOD II LLC, A DELAWARE LIMITED LIABILITY COMPANY (THE "LANDLORD"), AND HOBBY LOBBY STORES, INC., AN OKLAHOMA CORPORATION (THE "TENANT"), AS EVIDENCED BY MEMORANDUM OF LEASE FILED APRIL 6, 2018, RECORDED IN DOCUMENT NO. 2018030246, RECORDS OF BERNALILLO COUNTY, NEW MEXICO. NOT SURVEY RELATED
- 19 RIGHTS OF TENANT(S) IN THE LAND, IF ANY, AND RIGHTS OF ALL PARTIES CLAIMING BY, THROUGH OR UNDER SAID TENANT(S).

  NOT SURVEY RELATED

## Indexing Information

Section 7, Township 11 North, Range 3 East, N.M.P.M. as Projected into the Town of Alameda Grant Subdivision: Cottonwood Mall Owner: Mall at Cottonwood II LLC c/o Washington Prime Group LP UPC #: 101306546539410602

## Benchmark -NAVD 88

ACS MONUMENT "10-B13" HAVING AN ELEVATION OF 5074.478 (NAVD 88). ACS MONUMENT "8-B13" HAVING AN ELEVATION OF 5059.673 (NAVD 88).

## Record Legal Description

PROPOSED TRACT B-4-A-3, BEING A PORTION OF TRACT B-4-A, PLAT OF SECOND REVISION PLAT OF COTTONWOOD MALL, ALBUQUERQUE, NEW MEXICO, AS SHOWN ON RECORDED PLAT FILED IN THE OFFICE OF THE COUNTY CLERK OF BERNALILLO COUNTY, NEW MEXICO, ON JANUARY 31, 1997, IN PLAT BOOK 97C, FOLIO 33.

THE PARCEL DESCRIBED HEREON IS THE SAME AS SHOWN ON THE TITLE COMMITMENT PROVIDED BY FIRST AMERICAN TITLE, HAVING FILE NO. 2463939 AND AN EFFECTIVE DATE OF DECEMBER 31, 2019

## Flood Notes

BASED UPON SCALING, THIS PROPERTY LIES WITHIN FLOOD ZONE X WHICH IS DEFINED AS AN AREA OF MINIMAL FLOOD HAZARD AS DETERMINED BY F.E.M.A. AND SHOWN ON THE FLOOD INSURANCE RATE MAP DATED SEPTEMBER 26, 2008, MAP NO. 35001C0108G.

#### **Documents**

- 1. TITLE COMMITMENT PROVIDED BY FIRST AMERICAN TITLE, HAVING FILE NO. 2463939 AND AN EFFECTIVE DATE OF DECEMBER 31, 2019.
- 2. PLAT OF RECORD FOR SECOND REPLAT OF COTTONWOOD MALL, FILED IN THE BERNALILLO COUNTY CLERK'S OFFICE ON JANUARY 31, 1997, IN BOOK 97C, PAGE 33.
- 3. SPECIAL WARRANTY DEED FOR SUBJECT PROPERTY (TRACT B-4-A), FILED IN THE BERNALILLO COUNTY CLERK'S OFFICE ON JUNE 16, 2017, AS DOC. NO. 2017058178.

## Contact Information for New Utilities

WATER AND SEWER

ALBUQUERQUE BERNALILLO COUNTY WATER UTILITY ASSOCIATION
C/O KRISTOPHER CADENA
600 2ND STREET NW, SUITE 201
ALBUQUERQUE, NM 87102
(505) 289-3301

DRAINAGE/STORMWARER MANAGEMENT

CITY OF ALBUQUERQUE HYDROLOGY SECTION
C/O DOUG HUGHES
600 2ND STREET NW
ALBUQUERQUE, NM 87102
(505) 924-3986

ELECTRIC PUBLIC SERVICE OF NEW MEXICO (PNM)
C/O RODNEY FUENTES

C/O RODNEY FUENTES
2401 AZTEC ROAD NE, MS Z110
ALBUQUERQUE, NM 87107
(505) 241-4476

TELEPHONE CENTURYLINK
C/O DON DAVALOS

C/O DON DAVALOS
4301 BOGAN AVE NE
ALBUQUERQUE, NM 87109
(505) 767-7449

S NEW MEXICO GAS COMPANY (NMGAS)

C/O JEFF ESTVANKO 7120 WYOMING BOULEVARD NE, SUITE 20

ALBUQUERQUE, NM 87109 (505) 798-3373

ROADWAY REGLATORY AUTHORITY CITY OF ALBUQUERQUE TRANSPORTATION SECTION

C/O JEANNE WOLFENBARGER 600 2ND STREET NW ALBUQUERQUE, NM 87102 (505) 924-3981

## Zoning Notes

No zoning report was provided by client. The following information is based upon the zone designation and the conditions as reflected on city website. According to the City of Albuquerque Official IDO Website, http://cabq.maps.arcgis.com, on January 23, 2020, the subject property is zoned "MX-M" (Mixed Use-Moderate Intensity Zone District), the subject property is subject to the following conditions:

Front Setback: 5 ft. minimum
Side Setback: Interior: 0 ft.; Street Side: 5 ft. minimum
Rear Setback: 15 ft.

Building Height: 45 ft. maximum

\* Although property is zoned "MX—M", the subject property is subject to the setbacks listed above. However, an approved Site Development Plan more than likely will be required prior to development and may require more or less restrictive setbacks.

For additional information regarding the specific usage, visit the IDO Website: http://cabq.maps.arcgis.com

#### Parking Information

Required (for Restaurant): 8 Spaces per 1,000 Sq. Ft. (GFA)

Current Parking Spaces in the area Surveyed ("Topo Limits")

Regular Total Spaces: 230

The parking space count as shown is based upon the parking lot as is. Obviously a building envelope and parking lot reconfiguration will result in a different space count.

Current zoning code forbids lot lines traversing parking spaces, so reconfiguration of the spaces immediately adjoining the site must be approved by the city before the property can be properly subdivided.

## Notes

- 1. FIELD SURVEY PERFORMED IN DECEMBER 2019 AND JANUARY 2020.
- 2. ALL DISTANCES ARE GROUND DISTANCES: U.S. SURVEY FOOT.
  3. THE COORDINATES SHOWN HEREON REFERENCES MODIFIED GROUND NEW MEXICO STATE PLANE COORDINATES (NAD 83-CENTRAL), USING GROUND TO GRID FACTOR OF 0.999678829, USING AND ORIGIN OF (0,-8.29).
- 4. WITH REGARD TO UNDERGROUND UTILITY LOCATIONS, SOURCE INFORMATION FROM PLANS AND MARKINGS WERE COMBINED WITH OBSERVED EVIDENCE OF UTILITIES PURSUANT TO SECTION 5.E.iv. TO DEVELOP A VIEW OF THE UNDERGROUND UTILITIES. HOWEVER, LACKING EXCAVATION, THE EXACT LOCATION OF UNDERGROUND FEATURES CANNOT BE ACCURATELY, COMPLETELY AND RELIABLY DEPICTED. IN ADDITION, IN SOME JURISDICTIONS, 811 OR OTHER SIMILAR UTILITY LOCATE REQUESTS FROM SURVEYORS MAY BE IGNORED OR RESULT IN AN INCOMPLETE RESPONSE, WHICH MAY AFFECT THIS SURVEYOR'S ASSESSMENT OF THE LOCATION OF THE UTILITIES. WHERE ADDITIONAL OR MORE DETAILED INFORMATION IS REQUIRED, THE CLIENT IS ADVISED THAT THAT EXCAVATION AND/OR A PRIVATE UTILITY LOCATE REQUEST MAY BE NECESSARY. INVERT DATA SHOWN WITH A ± SHOULD BE
- CONSIDERED TAKEN FROM AS—BUILTS. (NM811 TICKET NO. 20JA070725).

  5. THE SUBJECT PROPERTY AND ADJOINING TRACTS ARE SUBJECT TO THE FOLLOWING:

   CONSTRUCTION, OPERATION AND RECIPROCAL EASEMENT AGREEMENT FILED DECEMBER
- 28, 1995, IN BOOK 95-31, PAGES 5334-5549.

   AGREEMENT REGARDING RESTRICTION OF RESERVE TRACTS, FILED ON DECEMBER 28,
- 1995 IN BOOK 95-31, PAGE 5550-5610.

  6. NO BUILDINGS EXISTING WITHIN THE LIMITS OF THE SURVEYED AREA OF THE PROPERTY.

  7. RECENT CONSTRUCTION TO MALL BUILDING, NEW CURBING AND LOADING DOCK AREA WAS
- WAS OBSERVED WHILE CONDUCTING FIELD SURVEY.

  8. WHILE NO SPECIFIC INFORMATION IS AVAILABLE BY THE CONTROLLING JURISDICTION CONCERNING PLANNED STREET WIDENING, THE SURVEYOR REFERS TO THE FOLLOWING WEBSITE FOR LONG RANGE STREET CLASSIFICATION, THE STREET WIDTH AND RETURN REQUIREMENTS FOR THE DIFFERENT CLASSIFICATIONS AND EVEN SPECIAL PLANNED
- CORRIDOR AND MASTER PLANS: HTTP://www.cabq.gov/gis

  9. NO WETLAND DELINEATION MARKERS WERE OBSERVED IN THE FIELD DURING THIS SURVEY.

  10. WHILE THE PROPERTY IS DESIGNATED AS A PORTION OF TRACT B-4-A, THE TRACT IS CURRENTLY INVOLVED IN A REPLAT TO CREATE A ± 0.9 ACRES TRACT SOUTH OF THE
- THE REMAINING PORTION OF SAID TRACT B-4-A WILL BECOME TRACT B-4-A-1).

  11. THIS PROPERTY IS REFLECTED ON A PRELIMINARY ALTA BECAUSE THE LOT LINES FOR PROPOSED TRACT B-4-A-3 DO NOT YET EXIST AND MUST BE APPROVED THROUGH THE SUBDIVISION PROCESS BEFORE THE LOT WILL BE CONSIDERED "LEGAL" IN THE EYES OF THE CITY. THE PURPOSE FOR THIS PRELIMINARY ALTA IS FOR THE PURPOSE OF PROVIDING A SURVEY THAT REFLECTS THE EXCEPTIONS IN THE TITLE COMMITMENT TO AID IN THE BUYER OBTAINING A SURVEY DURING THE DUE DILIGENCE PERIOD.

SUBJECT PROPERTY (PARTIALLY SHOWN HEREON AS "PROPOSED TRACT B-4-A-2" AND

## Preliminary Boundary Survey

ALTA/NSPS Land Title Survey

Topographic Map
for
Proposed Tract B-4-A-3
2nd Revision

Cottonwood Mall
City of Albuquerque
Bernalillo County, New Mexico
November 2020

## Surveyor's Certificate for ALTA

To: Texas Roadhouse Holdings LLC; Strategic Restaurant Concepts, LLC, Mall at Cottonwood II, LLC, a Delaware limited liability company, First American Title Insurance Company:

This is to certify that this map or plat and the survey on which it is based were made in accordance with the 2016 Minimum Standard Detail Requirements for ALTA/NSPS Land Title Surveys, jointly established and adopted by ALTA and NSPS, and includes items 1—5, 6(a), 6(b), 7(b), 8, 9, 11, 13, 14—18, 20 and 21 of Table A thereof. The Field Work was completed on February 24, 2020.

DATE OF PLAT OR MAP

Will Plotner Jr.

Revisions:

N.M.R.P.S. No. 14271

4/1/2020 — Original
11/9/2020 — Revised to add an area to the west of property
to the subject property

Date

I, Will Plotner Jr., New Mexico Professional Surveyor No. 14271, do hereby certify that this boundary survey plat and the actual survey on the ground upon which it is based were performed by me or under my direct supervision; that I am responsible for this survey; that this survey meets the minimum standards for surveying in New Mexico; and that it is true and correct to the best of my knowledge and belief. I further certify that this survey is not a land division or subdivision as defined in the New Mexico subdivision act and that this instrument is a boundary survey plat of an existing tract or tracts.

Will Plotner Jr. N.M.R.P.S. No. 14271

Date

Date

Surveyor's Certificate for Topographic Map

I, WILL PLOTNER JR., A NEW MEXICO REGISTERED PROFESSIONAL LAND SURVEYOR DO HEREBY CERTIFY THAT THE TOPOGRAPHIC MAP SHOWN HEREON IS TRUE AND CORRECT TO THE BEST OF MY KNOWLEDGE AND BELIEF.


Will Plotner Jr.
N.M.R.P.S. No. 14271


CSI-CARTESIAN SURVEYS INC.

P.O. BOX 44414 RIO RANCHO, N.M. 87174

Phone (505) 896 - 3050 Fax (505) 891 - 0244

Sheet 1 of 2

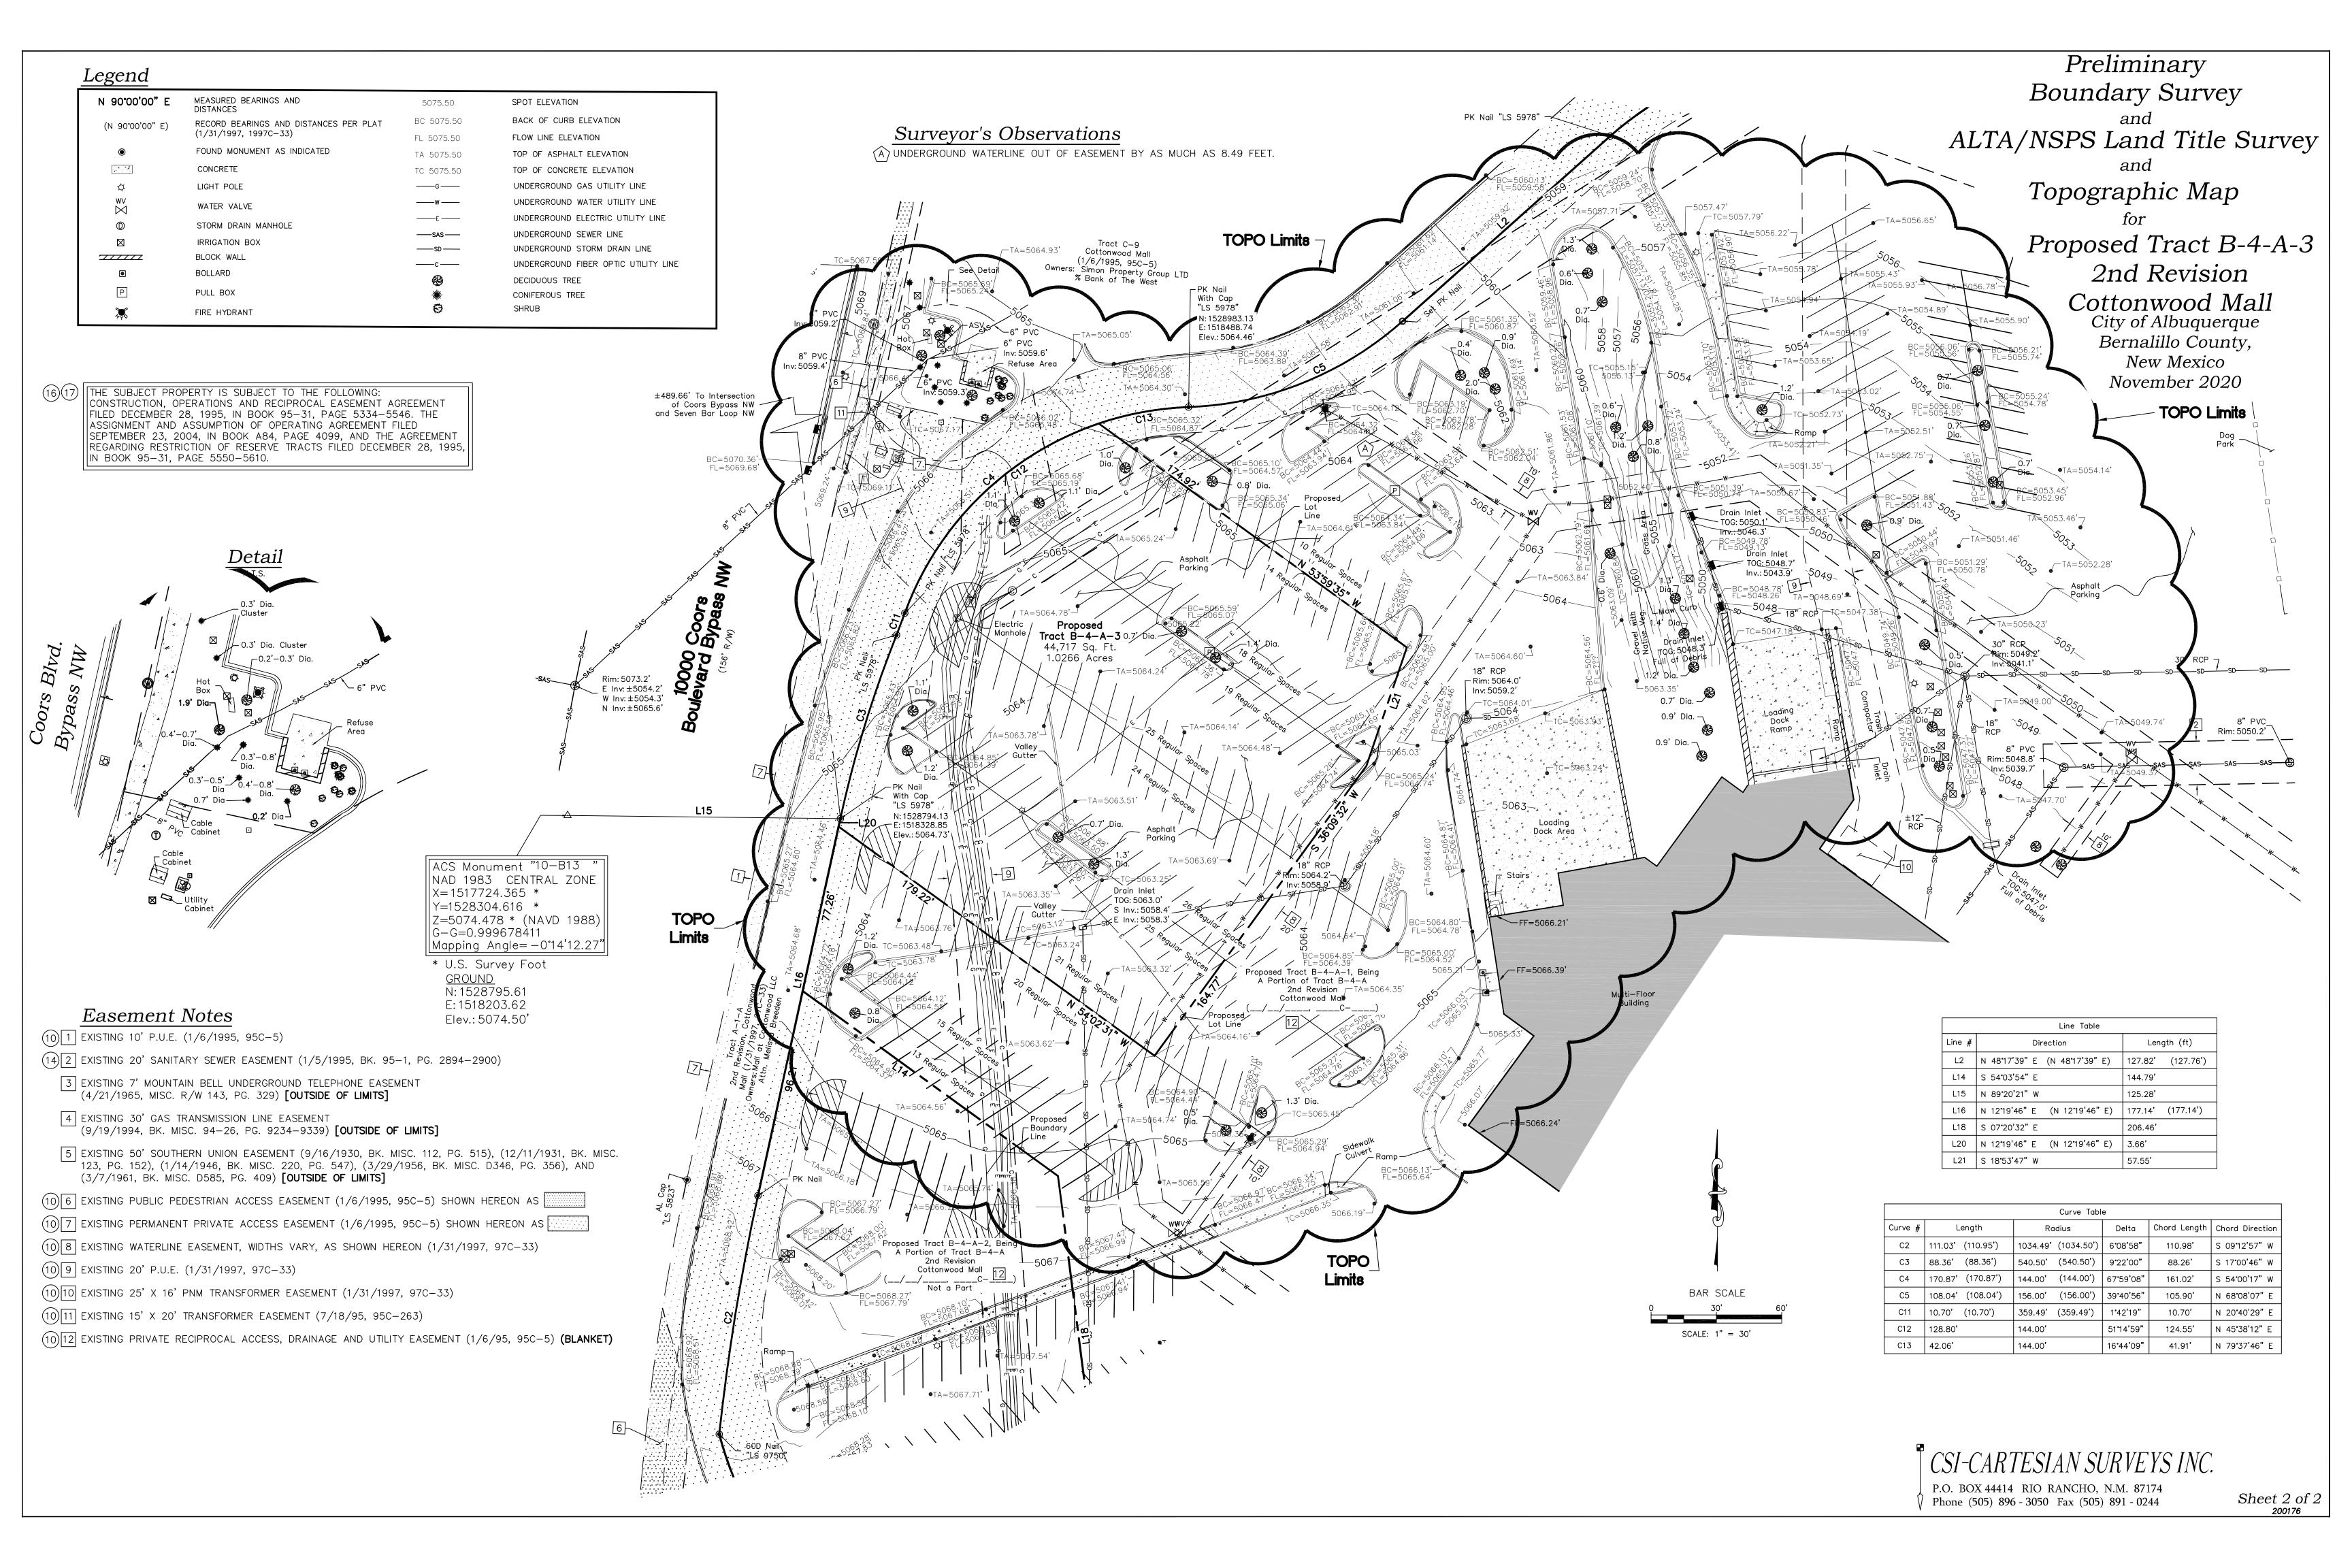

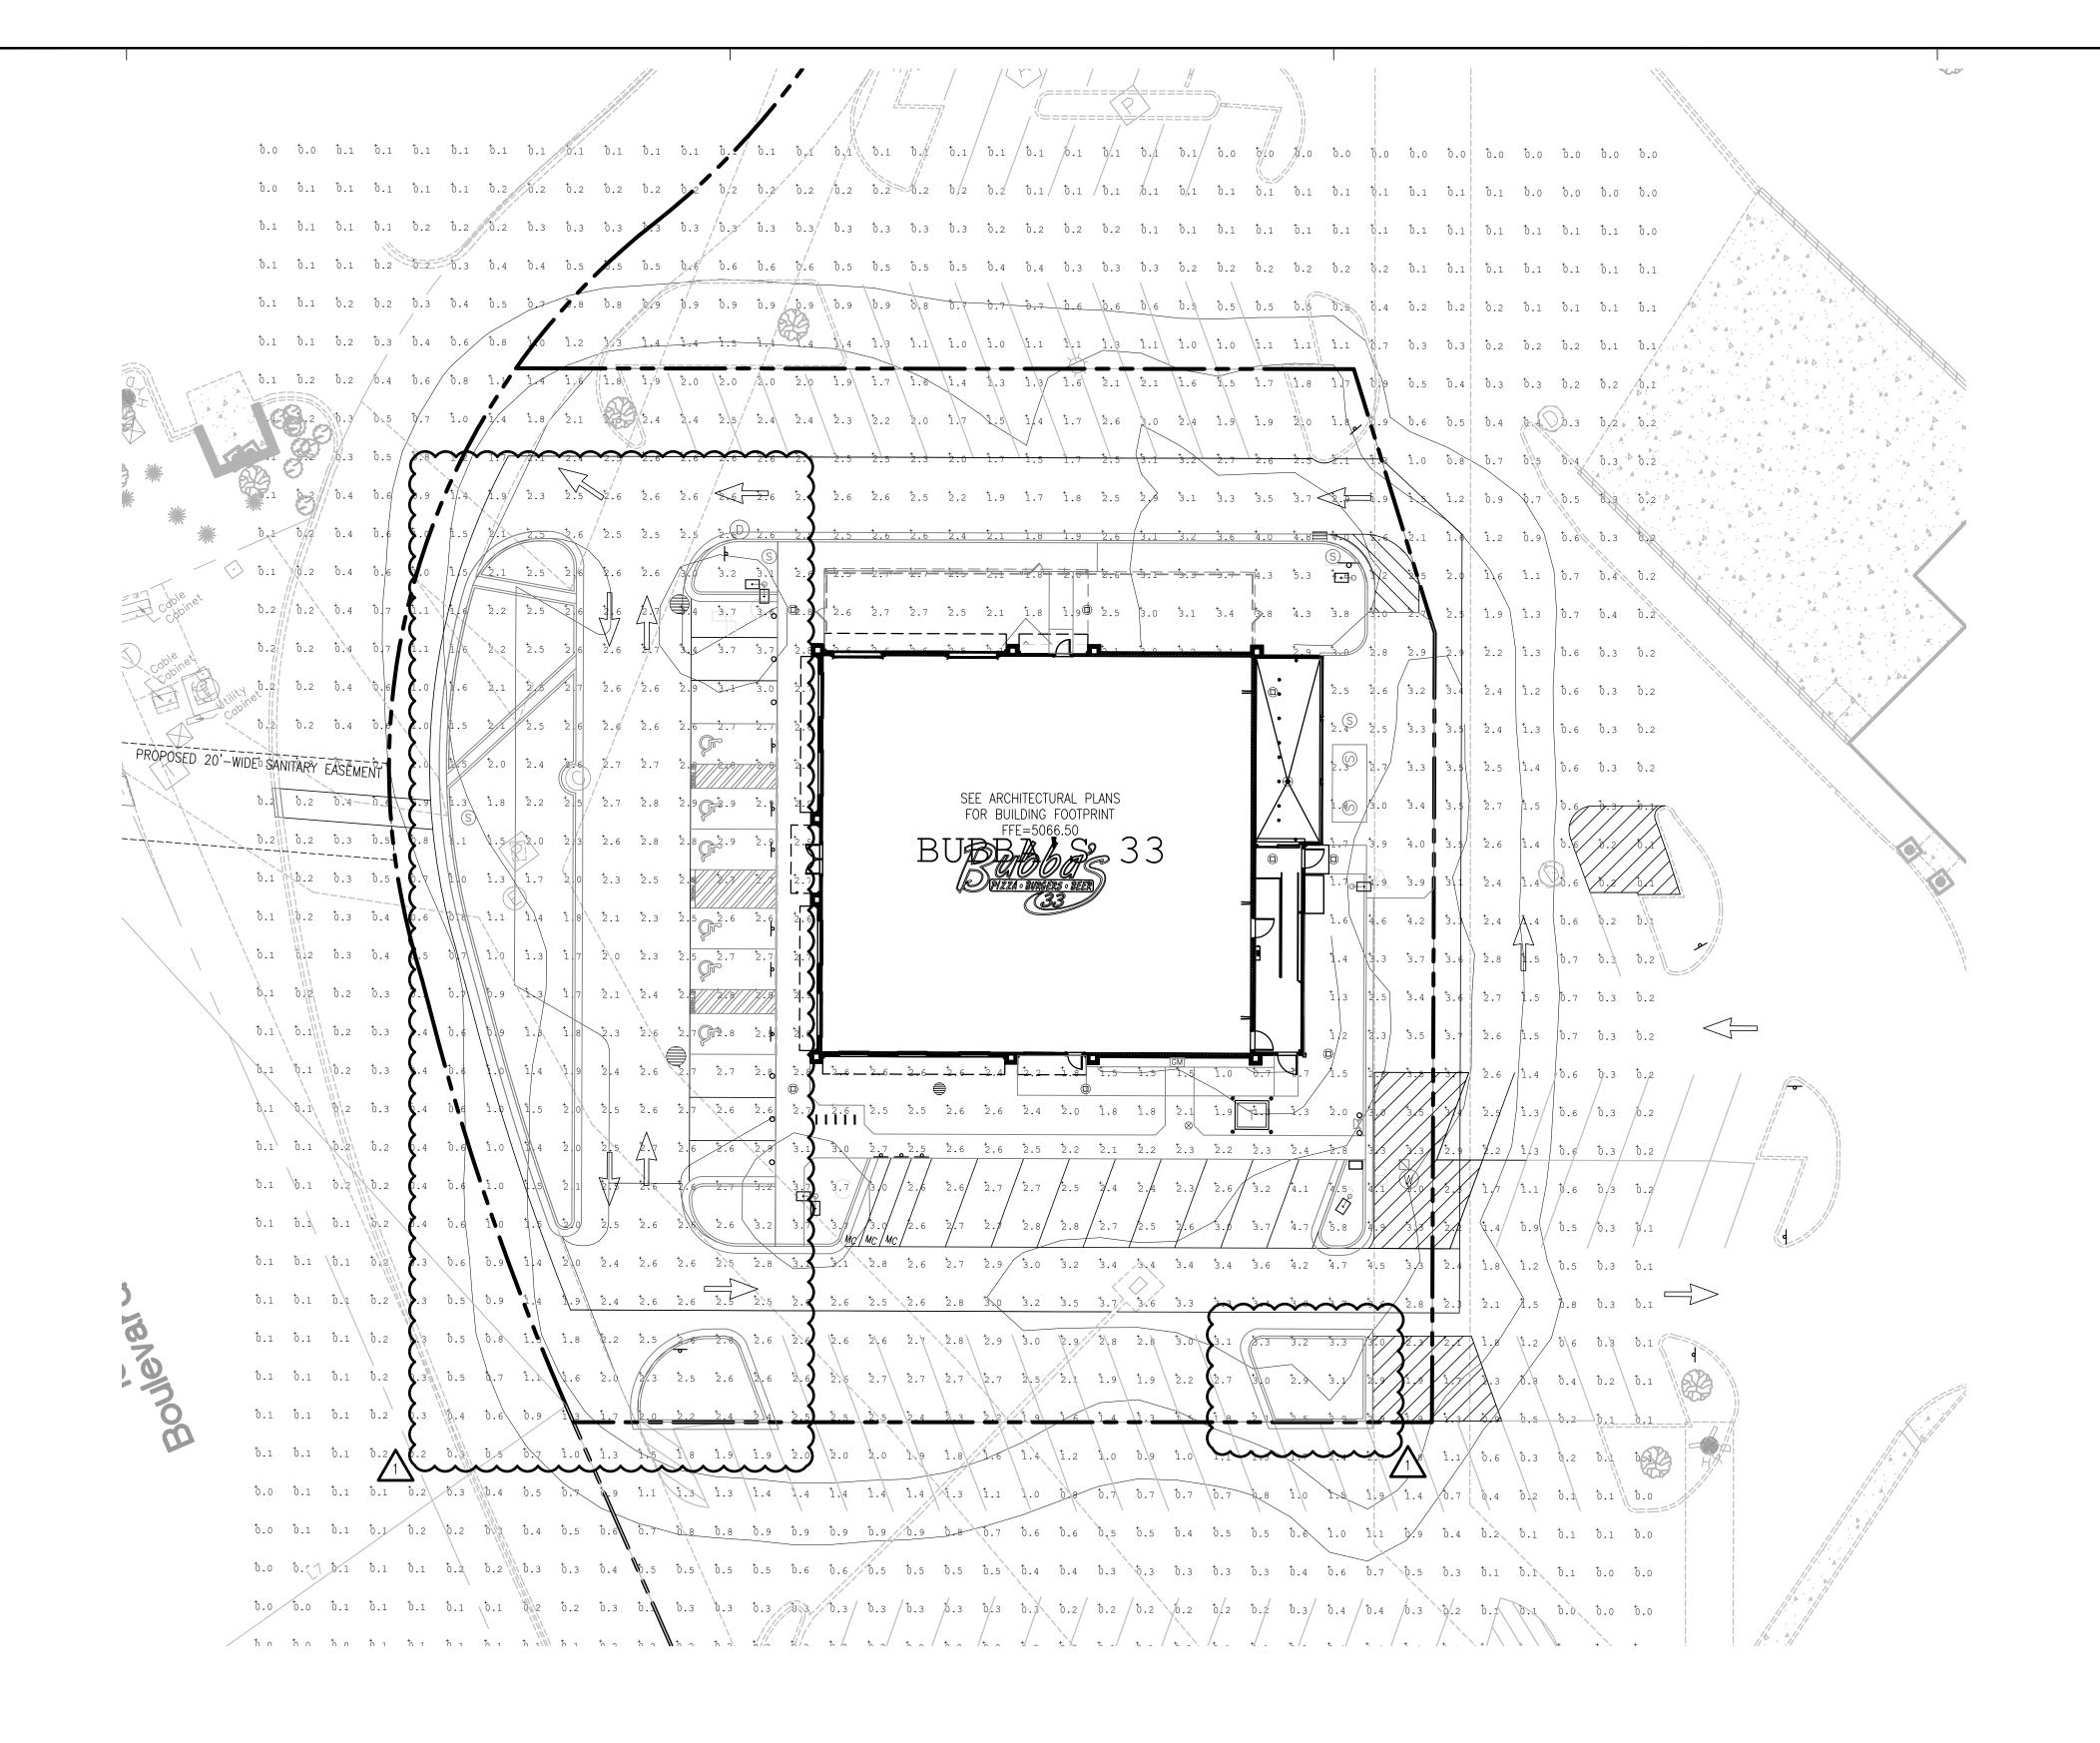


Calculation Summary									
Label	Avg	Max	Min	Avg/Min	Max/Min				
EXTENDED	1.38	5.8	0.0	N.A.	N.A.				
PARKING LOT SURFACE	2.65	4.9	1.3	2.04	3.77				

LIGHT LEVELS ARE MAINTAINED FOOT-CANDLES, INITIAL LEVELS ARE SLIGHTLY HIGHER

Luminai	naire Schedule								
Symbol	Qty	Label	Arrangement	Luminaire	LLF	CCT	Luminaire	Mounting	Description
				Lumens			Watts	Height	
	1	A	SINGLE	18783	0.900	4000K	145	27.5	VP-1-160L-135-4K7-2-UNV-A-DBT / SES-25-40-01-F-B4-DBT
	2	В	SINGLE	21487	0.900	4000K	172	27.5	VP-1-160L-160-4K7-4F-UNV-A-DBT / SES-25-40-01-F-B4-DBT
8	2	C	2 @ 90 degrees	23172	0.900	4000K	172	27.5	(2) VP-1-160L-160-4K7-5QW-UNV-A-DBT / SES-25-40-01-F-B4-DBT

POLES ARE 25'-0" ON 2'-6"

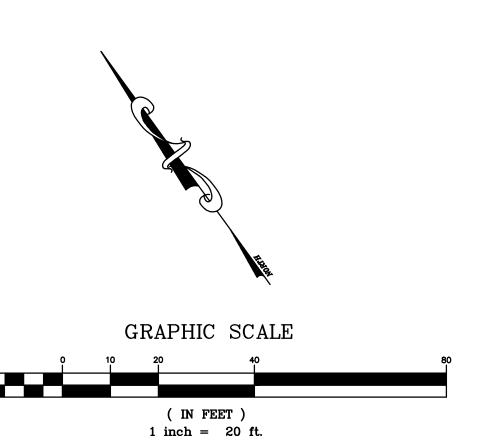



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PROJECT TEAM

ISSUE/REVISION RECORD

DATE DESCRIPTION

04/11/24 COORDINATION SET 05/22/24 PERMIT SET 06/14/24 BID SET 07/12/24 PERMIT RESPONSE 07/24/24 PERMIT RESPONSE

PROFESSIONAL SEAL

PROFESSIONAL IN CHARGE ZACH MICHELS PROFESSIONAL ENGINEER LICENSE NO. 28488

PROJECT MANAGER
EDWARD GOSS

QUALITY CONTROL
EDWARD GOSS

DRAWN BY

PROJECT NAME

BUBBA'S 33

ALBUQUERQUE NEW MEXICO

10000 COORS BYPASS NW ALBUQUERQUE, NM 87114




**PROJECT NUMBER** 20182050.0

SHEET TITLE

PHOTOMETRIC PLAN

SHEET NUMBER

PH1.0

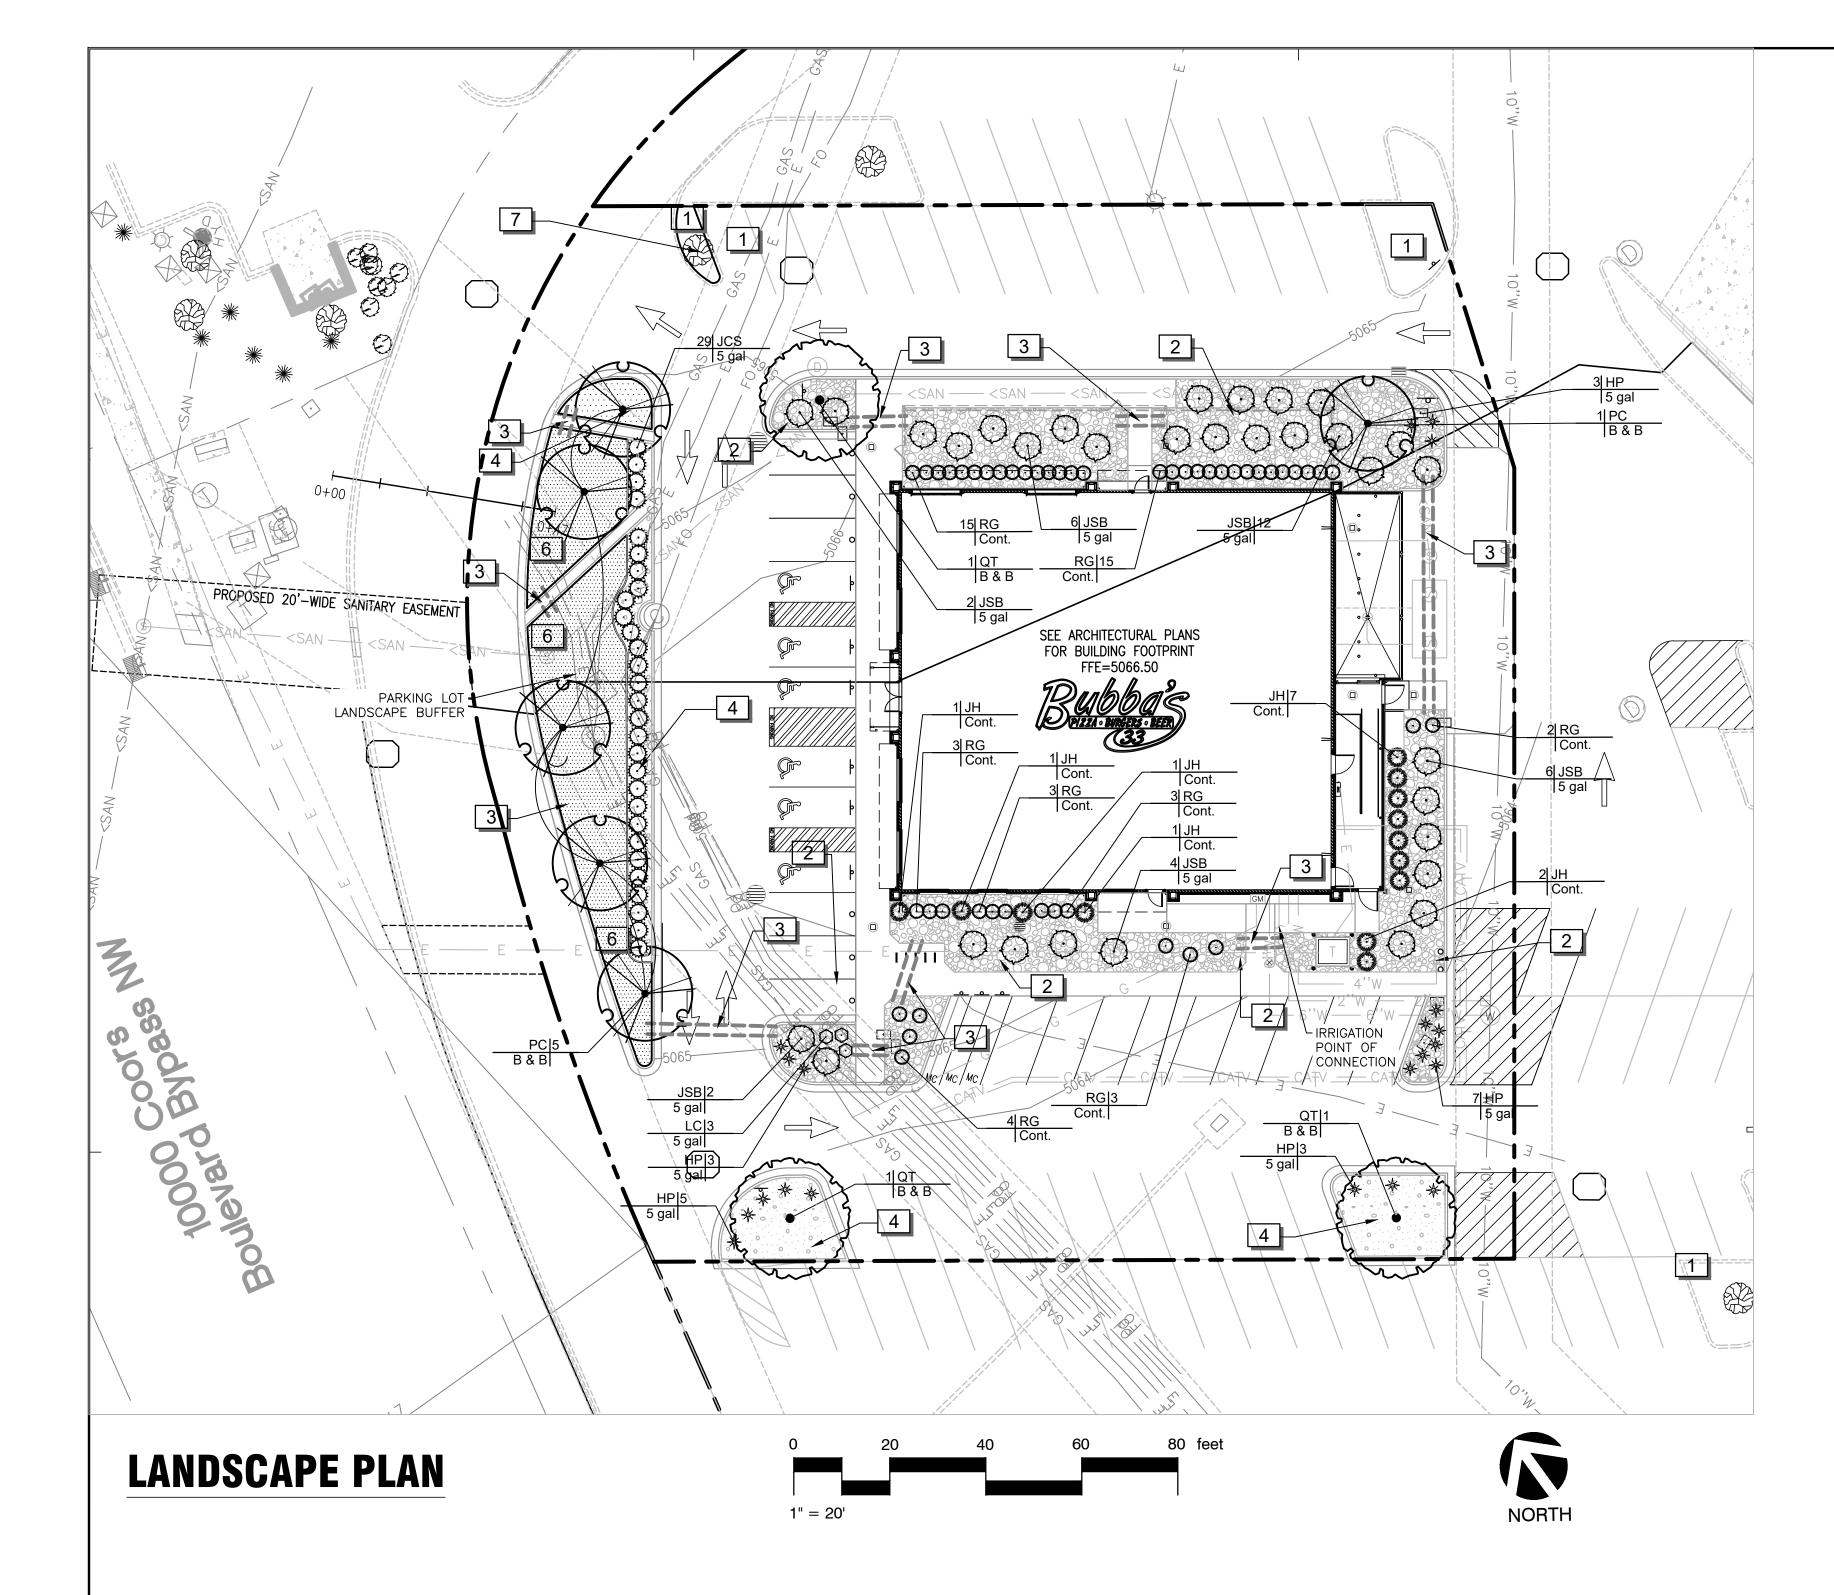

## LANDSCAPE CALCULATIONS:

REQUIRED: PROVIDED:

15% SITE LANDSCAPE AREA 15% (6,709 SF) 15.2% (6,800 SF) (CALCULATION: 6,800 SF/44,727 = 15.2%)

1 TREE PER 10 PARKING SPACES 6 TREES

(60/10=6)

FRONT LOT EDGE

(REQUIRED: 10' LANDSCAPE BUFFER WITH A CONTINUOUS LINE OF EVERGREEN SHRUBBERY 3 FEET IN HEIGHT)

8 TREES (INCLUDING 1 EXISTING TREE)

PARKING LOT TREE COVERAGE

(REQUIRED: NO PARKING SPACE MAY BE MORE THAN 100 FEET FROM A TREE TRUNK)

## REFERENCE NOTES SCHEDULE

SYMBOL

DESCRIPTION

ANY DAMAGE TO ADJACENT PROPERTY OR AREAS OF WORK BY OTHERS IS TO BE REPAIRED TO ITS ORIGINAL CONDITION WITH NO ADDITIONAL COST TO OWNER.

INSTALL RIVER ROCK MULCH 5"-7" DIAMETER ON WEED BARRIER IN PLANT BED ADJACENT TO BUILDING FOUNDATION AND WHERE INDICATED ON PLAN. RIVER ROCK MULCH TO BE INSTALLED FLUSH WITH TOP OF SIDEWALK.

4", SCHEDULE 40 PVC IRRIGATION SLEEVE.

INSTALL 3" DEPTH DECOMPOSED GRANITE 1" MINUS DIAMETER, TAN/BROWN COLOR ON FILTER FABRIC WEED BARRIER IN LANDSCAPE AREAS, AND LEVELED TO A NEAT CLEAN APPEARANCE, 1/2" BELOW CONCRETE LEVEL.

EXISTING TREE TO REMAIN. PROVIDE PROTECTION DURING THE ENTIRE CONSTRUCTION PROCESS.

6 ALL LAWNS ARE TO BE ESTABLISHED BY SEEDING WITH VARIETY COMMON TO LOCALITY.

## PLANT SCHEDULE

SYMBOL	CODE	QTY	BOTANICAL NAME	COMMON NAME	ROOT	CAL		
TREES	PC	6	PISTACIA CHINENSIS	CHINESE PISTACHE	B & B	2"CAL		
	QT	3	QUERCUS TEXANA	TEXAS RED OAK	B & B	2"CAL		
SYMBOL	CODE	QTY	BOTANICAL NAME	COMMON NAME	SIZE	<u>HEIGHT</u>		
SHRUBS								
*	HP	21	HESPERALOE PARVIFLORA	RED YUCCA	5 GAL			
	JH	13	JUNIPERUS CHINENSIS 'HETZII COLUMNARIS'	HETZI COLUMN JUNIPER	CONT.	7` HT. MIN.		
3)***C	JCS	29	JUNIPERUS CHINENSIS 'SEA GREEN'	SEA GREEN JUNIPER	5 GAL	36" HT. MIN.		
Ö	JSB	32	JUNIPERUS SABINA 'BUFFALO'	BUFFALO JUNIPER	5 GAL			
$\bigcirc$	LC	3	LEUCOPHYLLUM FRUTESCENS 'COMPACTA'	COMPACT TEXAS RANGER	5 GAL			
	RG	48	ROSMARINUS OFFICINALIS 'GORIZIA'	ROSEMARY 'GORIZIA'	CONT.	24" HT. MIN		
SYMBOL	CODE	QTY	BOTANICAL NAME	COMMON NAME				
GROUND CO	<u>/ERS</u> BD	2,815 SF	BOUTELOUA DACTYLOIDES	BUFFALO GRASS				
3" DEPTH DECOMPOSED GRANITE ON FILTER FABRIC WEED BARRIER								

## SHRUB HEIGHT MEASUREMENTS ARE TO BE AS MEASURED FROM TOP OF ROOTBALL (TYP.)

## **GENERAL NOTES:**

1" MINUS DIAMETER, TAN/BROWN COLOR .

1. GRAPHIC SYMBOLS TAKE PRECEDENCE OVER WRITTEN QUANTITIES AND KEYS ON PLAN.

RIVER ROCK MULCH ON FILTER FABRIC WEED BARRIER

- 2. CONTRACTOR TO REPAIR AND REPLACE ANY PLANT MATERIAL DAMAGED BY THIS CONSTRUCTION OUTSIDE PROJECT LIMITS. ANY EXISTING PLANT MATERIAL DAMAGED BY CONTRACTOR DURING CONSTRUCTION SHALL BE REPLACED WITH LIKE MATERIAL OF SIMILAR SPECIES AND SIZE AT THE CONTRACTOR'S EXPENSE WITH NO ADDITIONAL COST TO OWNER OR TENANT.
- 3. TWO WEEKS PRIOR TO PLANTING, THE CONTRACTOR SHALL SUBMIT TO THE OWNER / OWNER'S REPRESENTATIVE A PLANT PHOTO SUBMITTAL FOR APPROVAL. IF REQUESTED, BY THE OWNER, THE LANDSCAPE ARCHITECT WILL TAG THE MATERIAL.
- 4. EACH PHOTO SHALL CLEARLY SHOW THE SIZE, FORM, AND BRANCHING STRUCTURE AND QUALITY OF THE PLANT.
- 5. EACH PHOTO SHALL HAVE THE PLANT NAME, SIZE AND SPECIFICATIONS LABELED ON THE PHOTO.
- 6. ANY PHOTO SHOWING A GROUP OF PLANTS CLOSE TOGETHER WILL NOT BE ACCEPTED.
- 7. NO PARTIAL OR INCOMPLETE SUBMITTAL WILL BE ACCEPTED FOR REVIEW. ANY REJECTED SPECIES WILL BE SUBJECT TO RESUBMITTAL.
- 8. SAMPLES OF RIVER ROCK COBBLESTONE ARE TO BE PROVIDED TO OWNER/TENANT FOR REVIEW AND APPROVAL TWO (2) WEEKS PRIOR TO CONSTRUCTION. NO COBBLESTONE IS TO BE INSTALLED WITHOUT PRIOR APPROVAL FROM TEXAS ROADHOUSE.
- 9. REFER TO THE LATEST CIVIL PLANS FOR DISTURBED AREAS TO BE RESTORED. ADDITIONAL RESTORATION MAY BE NEEDED DUE TO FIELD CONDITIONS. SEE CIVIL SITE PLAN.
- 10. CONTRACTOR TO PROVIDE SITE IRRIGATION FOR ALL LANDSCAPE AREAS. IRRIGATION FOR THESE AREAS TO PROVIDE 100% COVERAGE OF ALL PLANTED AREAS. SHRUB BEDS TO BE WATERED WITH SUBSURFACE IRRIGATION. LAWN AREAS TO BE KEPT ON SEPARATE ZONES FROM SHRUB BEDS, DO NOT SPRAY ONTO BUILDING. IRRIGATION SYSTEM TO BE DESIGNED INSTALLED PER ALL LOCAL, STATE AND FEDERAL CODES.
- 11. REFER TO PLUMBING PLANS FOR BACKFLOW PREVENTER INFORMATION (IF LOCATED WITHIN THE BUILDING). IF BACKFLOW PREVENTOR IS LOCATED OUTSIDE, REFER TO SHEET L2.1 IRRIGATION NOTES AND DETAILS.

## MAINTENANCE OF LANDSCAPING:

THE OWNER, TENANT, OR AGENT, IF ANY, SHALL BE RESPONSIBLE FOR PROVIDING, PROTECTING AND MAINTAINING ALL LANDSCAPING IN HEALTHY GROWING CONDITIONS, REPLACING IT WHEN NECESSARY TO ENSURE CONTINUOUS CONFORMANCE WITH THESE GUIDELINES AND KEEPING IT FREE FROM REFUSE AND DEBRIS. MAINTENANCE SHALL INCLUDE THE REPLACEMENT OF ALL DEAD PLANT MATERIAL WITHIN THE GUARANTEED CONTRACT PERIOD.



Chicago, IL 60631

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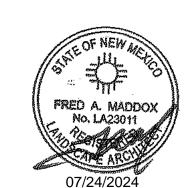
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PROJECT TEAM

05/22/24 PERMIT SET 06/14/24 BID SET 07/24/24 PERMIT RESPONSE

PROFESSIONAL SEAL



PROFESSIONAL IN CHARGE FRED MADDOX PROFESSIONAL LANDSCAPE ARCHITECT

PROJECT MANAGER EDWARD GOSS

QUALITY CONTROL
DENNIS JARRARD

DRAWN BY

PROJECT NAME

TEXAS ROADHOUSE

> ALBUQUERQUE NEW MEXICO

10000 COORS BYPASS NW ALBUQUERQUE, NM 87114



**PROJECT NUMBER** 20182050.0

SHEET TITLE

LANDSCAPE PLAN

SHEET NUMBER

**L1.0** 

#### PLANTING NOTES


- 1. LANDSCAPE PLANS ARE FOR THE LOCATION AND IDENTIFICATION OF PLANT MATERIAL ONLY. NO OTHER WORK IS TO BE PERFORMED BASED ON THESE PLANS.
- 2. QUANTITIES ON THE PLANT SCHEDULE ARE PROVIDED FOR CONVENIENCE. THE CONTRACTOR SHALL BE RESPONSIBLE FOR HIS/HER OWN QUANTITY CALCULATIONS. IN THE EVENT OF A DISCREPANCY BETWEEN THE LANDSCAPE PLANS AND THE PLANT SCHEDULE, THE LANDSCAPE PLAN WILL TAKE PRECEDENCE. THE CONTRACTOR SHALL INFORM THE TEXAS ROADHOUSE CONSTRUCTION MANAGER IMMEDIATELY UPON DISCOVERING ANY QUANTITY DISCREPANCIES.
- 3. THE CONTRACTOR SHALL NOT CHANGE OR SUBSTITUTE PLANT VARIETIES OR SPECIES WITHOUT PRIOR WRITTEN APPROVAL FROM THE TEXAS ROADHOUSE CONSTRUCTION MANAGER.
- 4. CONTRACTOR SHALL TAKE 3 REPRESENTATIVE SOIL SAMPLES OF EACH PROPOSED PLANT BED AND SUBMIT COPIES OF THE RESULTS TO THE TEXAS ROADHOUSE CONSTRUCTION MANAGER PRIOR TO BEGINNING WORK.
- 5. CONTRACTOR SHALL ENSURE POSITIVE DRAINAGE OF ALL PLANTING HOLES AND PLANT BEDS PRIOR TO INSTALLATION.
- 6. QUALITY OF PLANT MATERIAL: ALL PLANTS SHALL CONFORM TO THE CURRENT VERSION OF THE AMERICAN STANDARD FOR NURSERY STOCK (ANSI Z60.1)

PLANT MATERIAL SHALL BE FREE OF DISEASE AND/OR INSECTS, AND SHALL HAVE A HEALTHY ROOT SYSTEM WITH NO CIRCLING OR KINKED ROOTS. CONTAINER PLANTS SHALL NOT BE ROOT BOUND. PLANT MATERIAL SHALL CONFORM TO THE CURRENT STANDARDS OF THE AMERICAN STANDARD FOR NURSERY STOCK.


TREES SHALL HAVE STRAIGHT TRUNKS, DENSE CANOPIES AND STRONG BRANCHING WITH GOOD CROTCH ANGLES. CONTRACTOR SHALL SUBMIT GRADE PHOTOS OF EACH TREE TO LANDSCAPE ARCHITECT PRIOR TO DELIVERY.

ALL PLANT MATERIAL SHALL BE SUFFICIENTLY WATERED TO WET THE ENTIRE ROOT BALL WITHIN TWO HOURS OF PLANTING.

- 7. <u>INSPECTION AND APPROVAL OF PLANT MATERIAL</u>: ALL PLANT MATERIAL SHALL BE INSPECTED AND APPROVED BY THE TEXAS ROADHOUSE CONSTRUCTION MANAGER UPON DELIVERY TO THE SITE, PRIOR TO INSTALLATION. CONTRACTOR SHALL GIVE TEXAS ROADHOUSE CONSTRUCTION MANAGER AT LEAST LEAST ONE WEEK NOTICE PRIOR TO PLANT DELIVERY.
- 8. NEW SHRUB AND GROUNDCOVER PLANTING SHALL BE A MINIMUM OF 36" AWAY FROM EXISTING TREES.
- 9. CONTRACTOR SHALL REMOVE ALL PLANT TAGS AFTER APPROVAL OF PLANT INSTALLATION BY TEXAS ROADHOUSE CONSTRUCTION MANAGER.
- 10. MAINTENANCE: CONTRACTOR SHALL MAINTAIN ALL PLANT MATERIAL FROM THE TIME IT IS INSTALLED UNTIL FINAL ACCEPTANCE OR WHEN THE OWNER TAKES OVER MAINTENANCE, WHICHEVER OCCURS FIRST. MAINTENANCE SHALL INCLUDE BUT NOT BE LIMITED TO MOWING, EDGING, WEEDING, WATERING, PRUNING, FERTILIZING, ETC.
- 11. WARRANTY: CONTRACTOR SHALL PROVIDE A ONE-YEAR WARRANTY ON ALL PLANT MATERIAL AND LABOR. WARRANTY PERIOD SHALL BEGIN UPON FINAL COMPLETION OR WHEN THE OWNER TAKES OVER MAINTENANCE, WHICHEVER OCCURS FIRST.
- 12. THE CONTRACTOR SHALL MAKE PERIODIC INSPECTIONS OF THE PROJECT DURING THE WARRANTY PERIOD TO ENSURE THAT THE ESTABLISHMENT RATE OF GROWTH IS ADEQUATE. ANY METHODS OR PRODUCTS DEEMED NOT NORMAL OR DETRIMENTAL TO GOOD PLANT GROWTH SHALL BE REPORTED TO THE LANDSCAPE ARCHITECT IN WRITING. FAILURE TO INSPECT AND REPORT WILL BE INTERPRETED AS APPROVAL AND THE CONTRACTOR SHALL BE RESPONSIBLE FOR ANY AND ALL REPLACEMENTS
- 13. LANDSCAPE AREAS ARE DEFINED AS ALL NON PAVED AREAS DISTURBED BY CONSTRUCTION. SLIGHT VARIATIONS MAY EXIST BETWEEN ACTUAL SITE CONDITIONS AND DRAWINGS. CONTRACTOR SHALL ADJUST PLANTING LAYOUT AS REQUIRED TO MAINTAIN PLANT QUANTITIES AND DESIGN INTENT.
- 14. THE CONTRACTOR SHALL NOT SUBSTITUTE ANY PLANT (IN SPECIES, VARIETY, OR PATENT) FOR ANY PLANT THAT IS SPECIFIED IN THE LEGEND. IF AVAILABILITY IS A PROBLEM, THE CONTRACTOR SHALL CONTACT THE TEXAS ROADHOUSE CONSTRUCTION MANAGER TO DISCUSS ACCEPTABLE OPTIONS.
- 15. COORDINATE ALL NECESSARY EXCAVATION AREAS WITH OWNER'S REPRESENTATIVE.
- 16. FINISHED GRADE(S) NOTED ON THE LANDSCAPE DETAILS TO BE FIELD VERIFIED/APPROVED AND MODIFIED AS PER ARCHITECTURAL AND CIVIL DRAWINGS.
- 17. THE LANDSCAPE CONTRACTOR SHALL BE RESPONSIBLE FOR THE PROPER CARE AND HANDLING OF TREES AND PLANTS FOR DELIVERY AND PLACEMENT IN PLANTING PIT. TREES THAT ARE DROPPED FROM TRUCKS OR DROPPED INTO PITS SHALL BE REJECTED FOR REPLACEMENT BY THE LANDSCAPE CONTRACTOR. IF ROOTBALLS FALL APART DURING THE PLANTING OPERATION THE PLANT SHALL NOT BE PLANTED. NEW PLANT MATERIALS SHALL BE PROVIDED TO REPLACE THOSE THAT ROOTBALLS FALL APART.
- 19. PLANT CONTAINERS SHALL BE CUT TO REMOVE ROOTBALLS THAT ARE TIGHT IN THE CONTAINER. THE CONTRACTOR SHALL NOT REMOVE THE PLANT FROM THE CONTAINER BY THE TRUNK.
- 20. LANDSCAPE CONTRACTOR SHALL BE AWARE OF ALL EXISTING SITE CONDITIONS AND PREPARE BID ACCORDINGLY.
- 21. EXISTING PLANT MATERIALS SHALL BE PROTECTED IN PLACE AND REPLACED IN LIKE SIZE, QUANTITY AND TYPE IF DAMAGED DURING CONSTRUCTION.

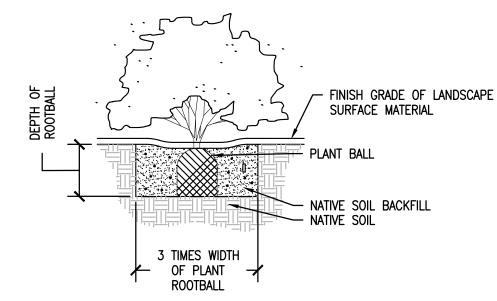



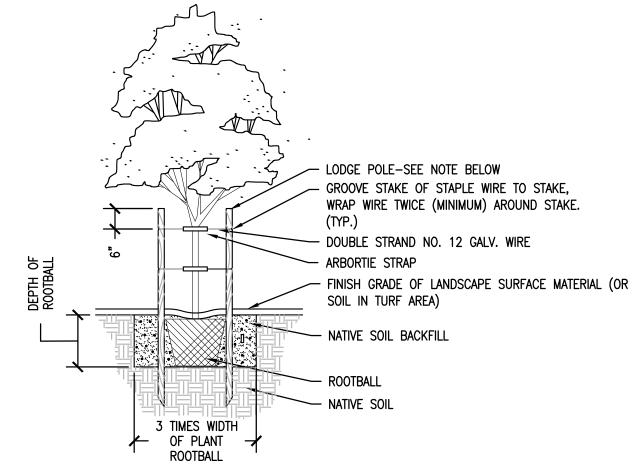

• HEIGHT OF STAKE VARIES. TOP TIE PLACED FOR MAX. SUPPORT. BOTTOM TIE PLACED

TREES THAT HAVE PREVIOUSLY BEEN STAKED IN THE NURSERY. STAKES SHALL BE LOCATED AND INSTALLED SO AS TO NOT CONTACT THE ROOTBALL OR


HALFWAY BETWEEN TOP TIE AND GRADE. SEE TREE STAKING DETAIL. ONLY STAKE

DAMAGE IRRIGATION SYSTEM WHEN DRIVEN INTO POSITION.



TREE PLANTING

SCALE: NTS

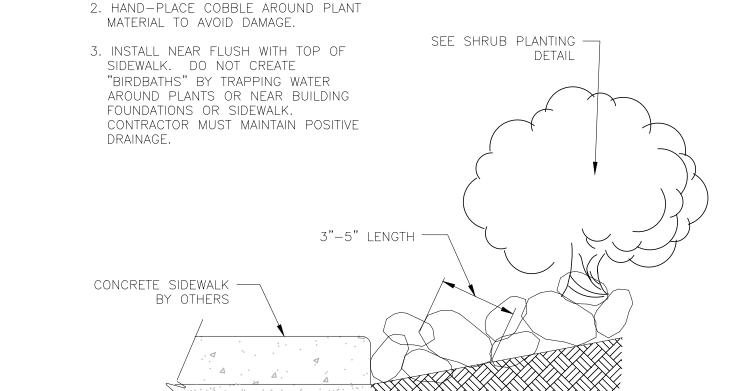

1. INSTALL 3"-5" LENGTH RIVER ROCK COBBLE, ON WEED BARRIER.

COMPACTED SUB-GRADE, SEE CIVIL-

ENGINEERING PLANS

3"-5" LENGTH RIVER ROCK COBBLE DETAIL 2

 DO NOT USE RUBBER HOSE SECTIONS. DO NOT WRAP WIRE AROUND TRUNK. - 2"X2" DOUGLAS FIR OR 2"ø LODGEPOLE PINE TREE STAKE. 8' HT. MIN - 15 GAL. TREE 12' HT. MIN. - 24" BOX TREE ARBORTIE TREE STAKING MATERIAL DOUBLE STRAND NO. 12 GALVANIZED WIRE - GROOVE STAKE OR STAPLE STRAP TO STAKE - WRAP WIRE AROUND ITSELF 5 TIMES SECURE STRAPS -MULTI-TRUNK OR LOW BRANCHED TREES TO HAVE ALL MAJOR LEADERS STAKED AND SUPPORTED.


• IT SHALL BE THE RESPONSIBILITY OF THE CONTRACTOR TO DETERMINE THE NEED TO INCREASE THE QUANTITY, HEIGHT AND DIAMETER OF TREE STAKES TO PROVIDE MAXIMUM SUPPORT AND INSURE STABILITY OF

321313.13-11

- ALL TREES. STAKES SHALL BE LOCATED AND INSTALLED SO AS TO NOT CONTACT THE ROOTBALL OR DAMAGE IRRIGATION SYSTEM WHEN DRIVEN
- INTO POSITION. IF IMPERVIOUS SUBGRADE CALICHE, ROCK OR HARDPAN EXISTS BENEATH EXCAVATED PLANT PIT, CONTRACTOR SHALL COMPLETE NECESSARY REMOVAL OR PENETRATION OF IMPERVIOUS MATERIAL TO PROVIDE NECESSARY PLANT PIT DRAINAGE AT A MINIMUM RATE OF 1 INCH PER HOUR. CONTRACTOR SHALL BE RESPONSIBLE FOR VERIFYING ADEQUATE PLANT
- PIT DRAINAGE. ALL NATIVE SOIL BACKFILL WITHIN 18" OF ROOTBALL SHALL BE SCREENED TO REMOVE ALL ROCK OR OTHER NON-SOIL MATERIALS LANRGER THAN 1-1/2" IN AND DIMENSION.



TREE STAKING DETAIL

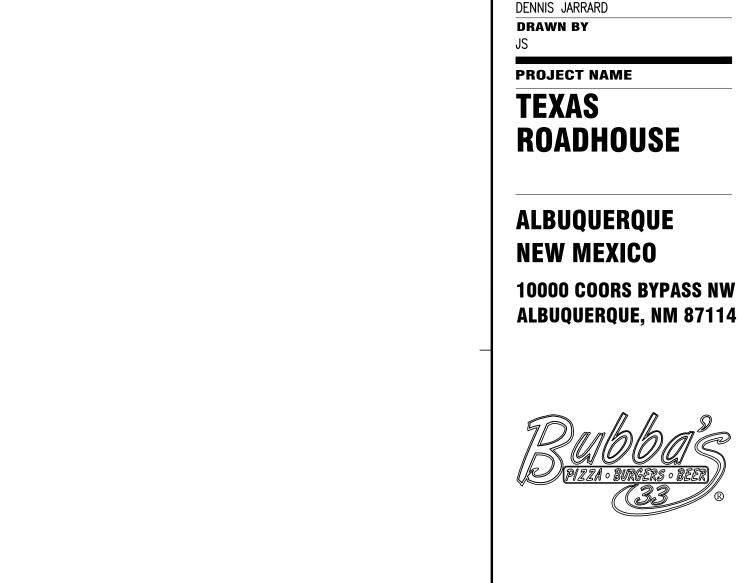

TREE PROTECTION DETAIL

NOT TO SCALE

329343.67-Ø1

- 4' HIGH SAFETY FENCE

EXISTING TREE

- WHEN PROPOSED WALKS, CURBS OR

BUILDINGS ENCROACH ON TREE DRIP LINES, INSTALL FENCING 3' BACK OF PROPOSED STRUCTURE, OTHERWISE ENCIRCLE ENTIRE DRIP LINE

> - FENCE TO BE OUTSIDE OF DRIP LINE OF TREES

3/4" REROD 8' O.C.

- EXISTING GRADE

— 4' HIGH SAFETY FENCE WITH

PROJECT NUMBER 20182050 (

www.greenbergfarrow.com

8600 W Byrn Mawr Ave.

Suite 800N

Chicago, IL 60631

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PROJECT TEAM

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ISSUE/REVISION RECORD

DESCRIPTION

05/22/24 PERMIT SET

07/24/24 PERMIT RESPONSE

**PROFESSIONAL SEAL** 

FRED A. MADDOX

No. LA23011

PROFESSIONAL IN CHARGE

PROFESSIONAL LANDSCAPE ARCHITECT

FRED MADDOX


**PROJECT MANAGER** 

**QUALITY CONTROL** 

EDWARD GOSS

06/14/24 BID SET

SHEET TITLE LANDSCAPE **NOTES AND DETAILS** 

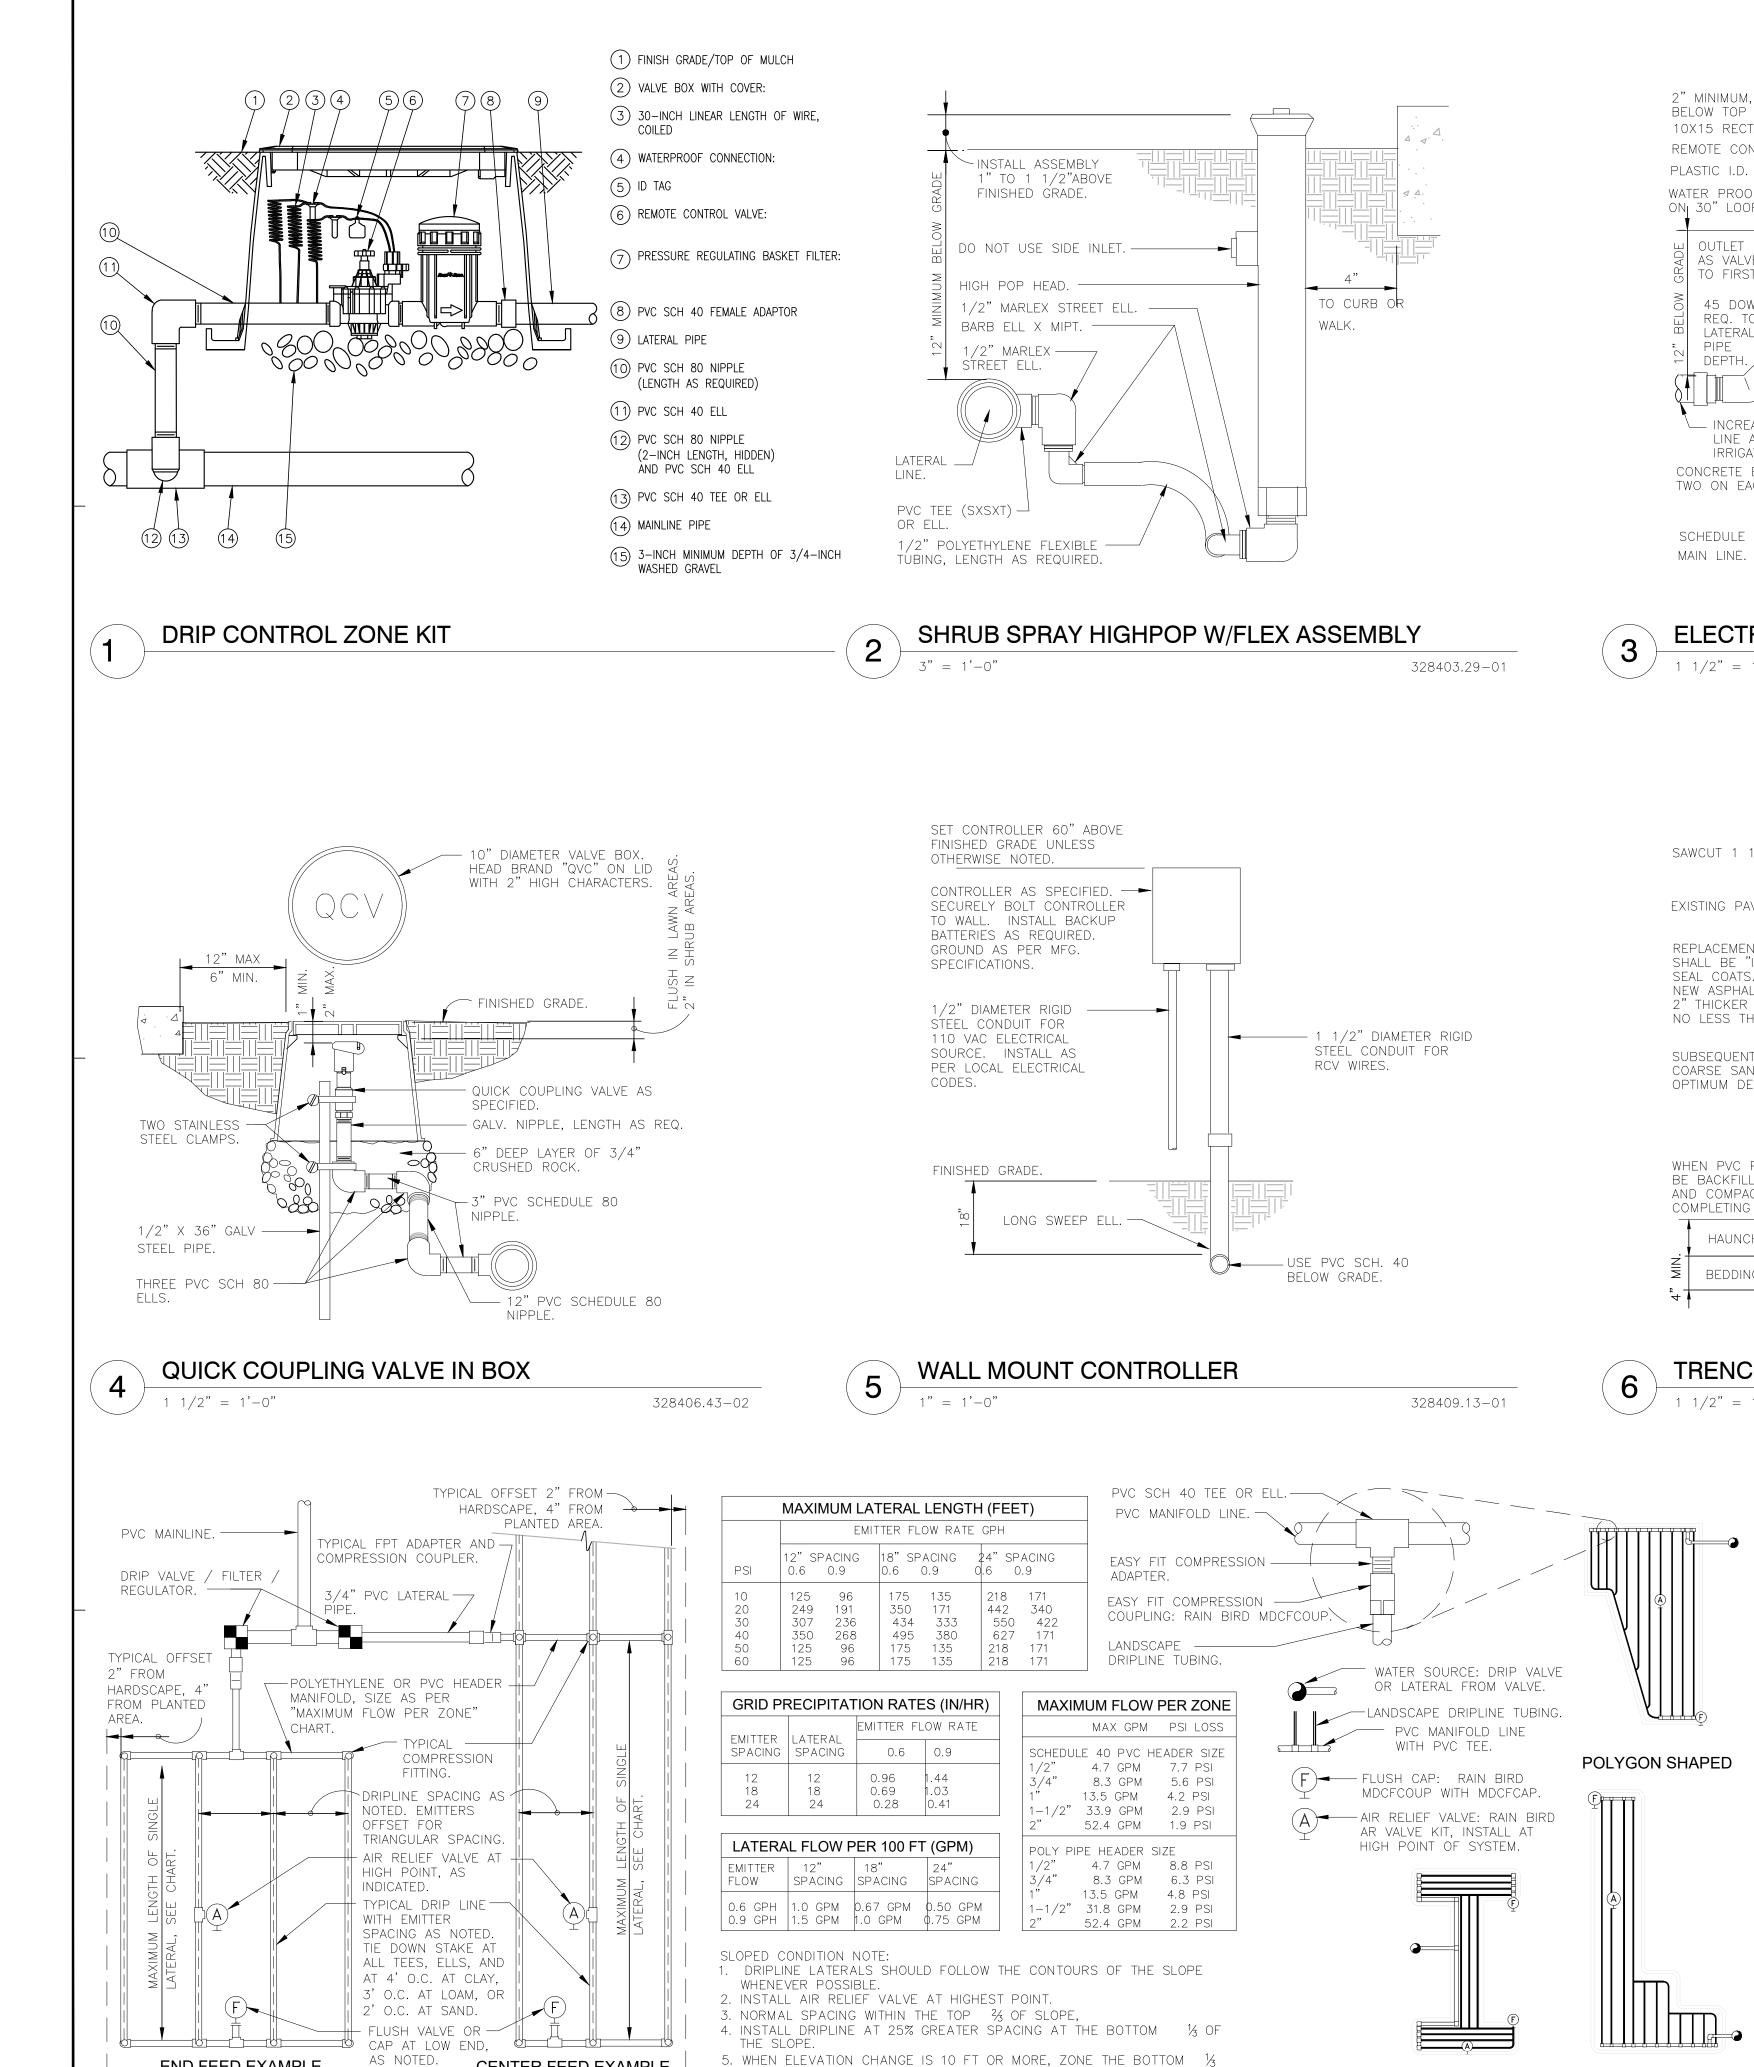


ON A SEPARATE VALVE.

AS NOTED.

TYPICAL RAIN BIRD DRIPLINE REQUIREMENTS


CENTER FEED EXAMPLE

**END FEED EXAMPLE** 

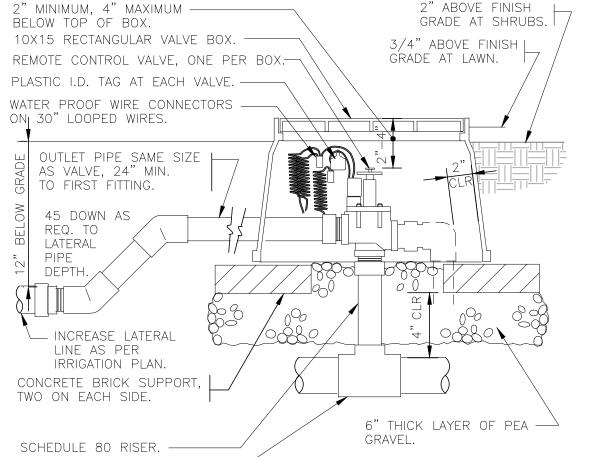

## ELECTRIC REMOTE CONTROL VALVE

328406.13-01

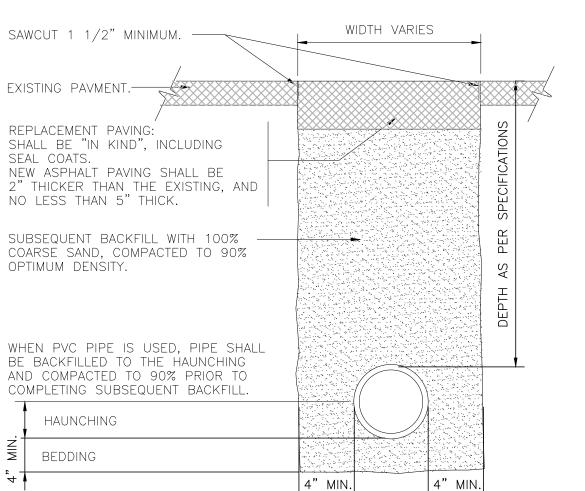

## TRENCH DETAIL AT ASPHALT PAVING

"C" SHAPED

**CURVED POLYGON** 

DOGBONE SHAPED

CORNER SHAPED

ODD SHAPED

HOURGLASS SHAPED

328413.56-01

328409.76-02

## **NOTES**

#### IRRIGATION

CONTRACTOR TO PROVIDE SITE IRRIGATION FOR ALL LANDSCAPE AREAS. IRRIGATION FOR THESE AREAS TO PROVIDE 100% COVERAGE OF ALL PLANTED AREAS. SHRUB BEDS TO BE WATERED WITH SUBSURFACE IRRIGATION. LAWN AREAS TO BE KEPT ON SEPARATE ZONES FROM SHRUB BEDS, DO NOT SPRAY ONTO BUILDING. IRRIGATION SYSTEM TO BE DESIGNED INSTALLED PER ALL LOCAL, STATE AND FEDERAL CODES.

REFER TO PLUMBING PLANS FOR BACKFLOW PREVENTER INFORMATION (IF LOCATED WITHIN THE BUILDING). IF BACKFLOW PREVENTOR IS LOCATED OUTSIDE, REFER TO SHEET L2.1 IRRIGATION NOTES AND DETAILS.

THE FOLLOWING EQUIPMENT IS TO BE USED UNLESS SUBSTITUTIONS ARE APPROVED BY OWNER:

CONTROLLER - HUNTER I-CORE IN STRONG BOX WITH HUNTER SOLAR SYNC RAIN/FREEZE SWITCH - RAIN BIRD WR2

BACKFLOW PREVENTER — FEBCO VALVES - RAIN BIRD PGA SERIES MOISTURE SENSOR - RAIN BIRD SMRT-Y (TO BE USED ON ALL PROJECTS AROUND THE BUILDING FOR

FOUNDATION PLANTINGS) TURF SPRAY HEADS - RAIN BIRD 1800 SERIES

PLANTING BED SPRAY HEADS - RAIN BIRD 1800 SERIES LARGE ROTOR HEADS - RAIN BIRD 5500, 6500 OR 8000 SERIES SMALL ROTOR HEADS - RAIN BIRD 5000 SERIES SUBSURFACE DRIP - XFS-P-09-12-100 PRESSURE REGULATOR KIT - RAIN BIRD XCZ INSTALL U-SERIES NOZZLES WHERE APPLICABLE.

CONTRACTOR QUALIFICATIONS: INSTALLATION OF THE IRRIGATION SYSTEM SHALL BE UNDER THE SUPERVISION OF A SUPERINTENDENT CURRENTLY LICENSED AS A LANDSCAPE IRRIGATOR IN THE STATE OR LOCAL JURISDICTION.

GUARANTEE: GUARANTEE THE UNDERGROUND SPRINKLER SYSTEM AGAINST DEFECTS IN THE MATERIALS AND WORKMANSHIP FOR ONE (1) YEAR AFTER FINAL ACCEPTANCE.

EXISTING UTILITIES: CONTRACTOR IS RESPONSIBLE FOR LOCATING UNDERGROUND UTILITIES PRIOR TO CONSTRUCTION. ANY UTILITIES DAMAGED BY CONTRACT ARE TO BE REPAIRED AT HIS EXPENSE WITH NO

WORKMANSHIP: PROVIDE FULL AND COMPLETE COVERAGE OF ALL IRRIGATED AREAS. COMPLY WITH REQUIREMENTS OF THE UNIFORM PLUMBING CODE AND ALL OTHER APPLICABLE CODES.

TRENCHING: PROTECT ANY EXISTING PLANT MATERIAL. ROUTE EXCAVATION TRENCHES TO AVOID DAMAGE TO EXISTING TREES. COORDINATE CONFIGURATION OF PLANTING BEDS WITH LANDSCAPE CONTRACTOR. TO ENSURE PROPER LOCATION OF TURF AND SHRUB IRRIGATION HEADS. STAKE ALL SPRINKLER HEAD LOCATIONS AND TRENCH TO A MINIMUM WIDTH OF 4" AND 18" BELOW FINISH GRADE FOR THE MAIN SUPPLY AND A MINIMUM WIDTH OF 3" AND 12" BELOW FINISH GRADE FOR LATERALS AND WIRING.

PIPING: ALL PIPING IS TO BE SIZED FOR A MAXIMUM WATER VELOCITY OF 5 FEET PER SECOND. LAY PIPE ON A SOLID SUBBASE, UNIFORMLY SLOPED WITHOUT HUMPS AND DEPRESSIONS. KEEP PIPE INTERIOR CLEAN AT ALL TIMES.

BACKFLOW PREVENTER: INSTALL BACKFLOW PREVENTER AS PER CITY CODES AND STANDARDS. INSTALL 12"x18" PLASTIC ACCESS BOX FLUSH WITH GRADE AND BACKFILL WITH 2" OF GRAVEL IN BOTTOM OF BOX. COORDINATE LOCATION WITH CIVIL ENGINEER, UNLESS OTHERWISE REQUIRED BY LOCAL CODES.

VALVES: CLEAN AND TEST PRIOR TO INSTALLATION. INSTALL PLUMB AND STRAIGHT. SET PLASTIC VALVE BOX WITH 2" GRAVEL SUMP AND STABILIZE WITH COMPACTED SOIL.

BACKFILL: USE BACKFILL FREE FROM ROCKS AND OTHER UNSUITABLE MATERIALS WHICH COULD DAMAGE PIPE OR CREATE SETTLING PROBLEMS. APPLY BACKFILL MATERIAL IN 6" LAYERS AND TAMP EACH LAYER TO PREVENT SETTLING. USE TOPSOIL (NOT SUBSOIL) WITHIN THE TOP 6" OF BACKFILL. ACHIEVE FINISH GRADE AND REPAIR ALL DAMAGED EXISTING TURF AND PLANTINGS. REMOVED EXCESS EXCAVATION AND BACKFILL MATERIAL FROM THE SITE IMMEDIATELY.


SPRINKLER HEADS: FLUSH LATERAL LINES WITH FULL HEAD OF WATER AND INSTALL HEADS. LOCATE SPRINKLER HEADS TO MAINTAIN A DISTANCE OF 6" FROM WALLS AND 2" FROM OTHER BOUNDARIES.

WIRING: LAY WIRING BESIDE PIPE IN TRENCHES. PROVIDE A MINIMUM COVERING OF 12" FOR WIRING LAID IN SEPARATE TRENCHES. WATERPROOF ALL CONNECTIONS WITH SPEARS DRI-SPLICE WIRE CONNECTORS AS RECOMMENDED BY MANUFACTURER. BUNDLE AND TAPE MULTIPLE WIRES AT A MAXIMUM OF 10 FOOT INTERVALS. PROVIDE A 30" EXPANSION LOOP AT EACH ELECTRIC REMOTE CONTROL VALVE AND A EVERY 100' INTERVAL BY WRAPPING WIRE AROUND 1/2" PIPE 15 TIMES.

AUTOMATIC CONTROLLER: PROVIDE 120 VOLT ELECTRICAL CURRENT TO THE CONTROLLER IN CONDUIT IN ACCORDANCE WITH LOCAL, STATE, AND FEDERAL CODES.

CLEAN-UP: KEEP THE PREMISES AND PUBLIC STREETS FREE FROM ACCUMULATION OF WASTE MATERIAL AT THE COMPLETION OF THE WORK REMOVE ALL WASTE, EXCESS MATERIAL, RUBBISH AND EQUIPMENT AND LEAVE THE SITE CLEAN.

FINAL ACCEPTANCE: PERFORM OPERATIONAL TEST WITH THE OWNER PRESENT AFTER SYSTEM IS COMPLETE AND IRRIGATION HEADS ADJUSTED TO FINAL POSITION. DEMONSTRATE TO OWNER THAT THE ENTIRE SYSTEM MEETS COVERAGE REQUIREMENTS, AND FUNCTIONS PROPERLY. PROVIDE THE OWNER WITH COMPLETE WRITTEN INSTRUCTIONS FOR PROPER OPERATION AND MAINTENANCE OF THE SPRINKLER

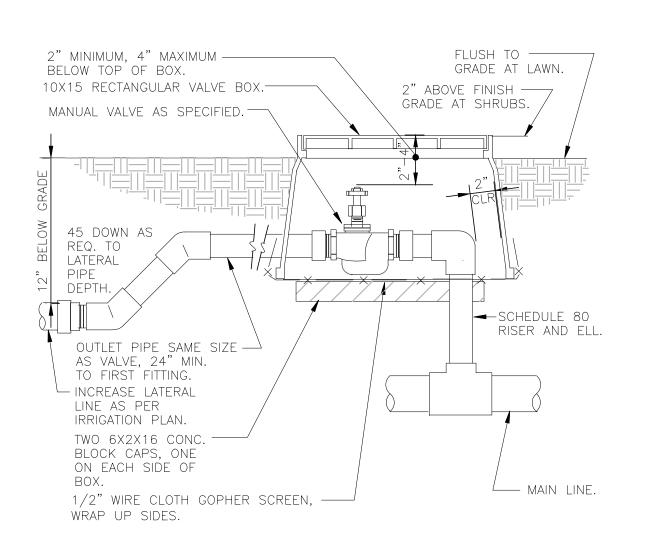

MANUAL CONTROL VALVE IN BOX

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PROJECT TEAM

ISSUE/REVISION RECORD

DESCRIPTION 05/22/24 PERMIT SET 06/14/24 BID SET 07/24/24 PERMIT RESPONSE

**PROFESSIONAL SEAL** 



PROFESSIONAL IN CHARGE FRED MADDOX PROFESSIONAL LANDSCAPE ARCHITECT

**PROJECT MANAGER** EDWARD GOSS **QUALITY CONTROL** DENNIS JARRARD

DRAWN BY

**PROJECT NAME** 

**TEXAS ROADHOUSE** 

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**PROJECT NUMBER** 20182050 (

**SHEET TITLE IRRIGATION** 

**NOTES AND DETAILS** 

**SHEET NUMBER** 

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