CITY OF ALBUQUERQUE



Planning Department Transportation Development Services Section

February 2, 2007

George R. Rainhart, Registered Architect 2325 San Pedro NE, Ste. 2-B Albuquerque, NM 87110

Re:

Certification Submittal for Final Building Certificate of Occupancy for

New Mexico Educators Federal Credit Union, [B-14 / D10B]

10090 Coors Blvd NW

Architect's Stamp Dated 02/01/07

Dear Mr. Rainhart:

P.O. Box 1293

The TCL / Letter of Certification submitted on February 1, 2007 is sufficient for acceptance by this office for final Certificate of Occupancy (C.O.). Notification has been made to the Building and Safety Section.

Albuquerque

Sincerely.

New Mexico 87103

www.cabq.gov

Nilo E. Salgado-Fernandez, P.E.

Senior-Traffic Engineer

Development and Building Services

Planning Department

c:


Engineer Hydrology file CO Clerk

TRAFFIC CERTIFICATION


I, George Rainhart, NMPE OR NMRA NMRA OF THE FIRM George Rainhart Architect & Associates, HEREBY CERTIFY THAT THIS PROJECT HAS IS IN DESIGN SUBSTANTIAL COMPLIANCE WITH AND IN ACCORDANCE WITH THE DESIGN INTENT OF THE APPROVED PLAN DATED September 29, 2006. THE RECORD INFORMATION EDITED ONTO THE ORIGINAL DESIGN DOCUMENT HAS BEEN OBTAINED BY Anton Dattilo OF THE FIRM George Rainhart Architect & Associate. I FURTHER CERTIFY THAT I HAVE PERSONALLY VISITED THE PROJECT SITE ON February 2, 2006 AND HAVE DETERMINED BY VISUAL INSPECTION THAT THE SURVEY DATA PROVIDED IS REPRESENTATIVE OF ACTUAL SITE CONDITIONS AND IS TRUE AND CORRECT TO THE BEST OF MY KNOWLEDGE AND BELIEF. THIS CERTIFICATION IS SUBMITTED IN SUPPORT OF A REQUEST FOR Temporary Certificate of Occupancy.


Note: A credit union replaced a restaurant use AA was revised 4/21/06

THE RECORD INFORMATION PRESENTED HEREON IS NOT NECESSARILY COMPLETE AND INTENDED ONLY TO VERIFY SUBSTANTIAL COMPLIANCE OF THE TRAFFIC ASPECTS OF THIS PROJECT. THOSE RELYING ON THE RECORD DOCUMENT ARE ADVISED TO OBTAIN INDEPENDENT VERIFICATION OF ITS ACCURACY BEFORE USING IT FOR ANY OTHER PURPOSE.

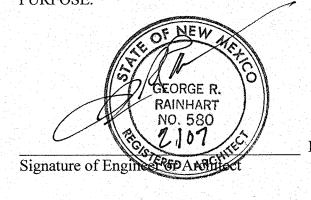


ENGINEER'S OR ARCHITECT'S STAMP

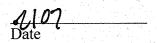

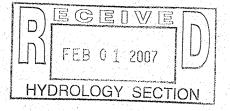



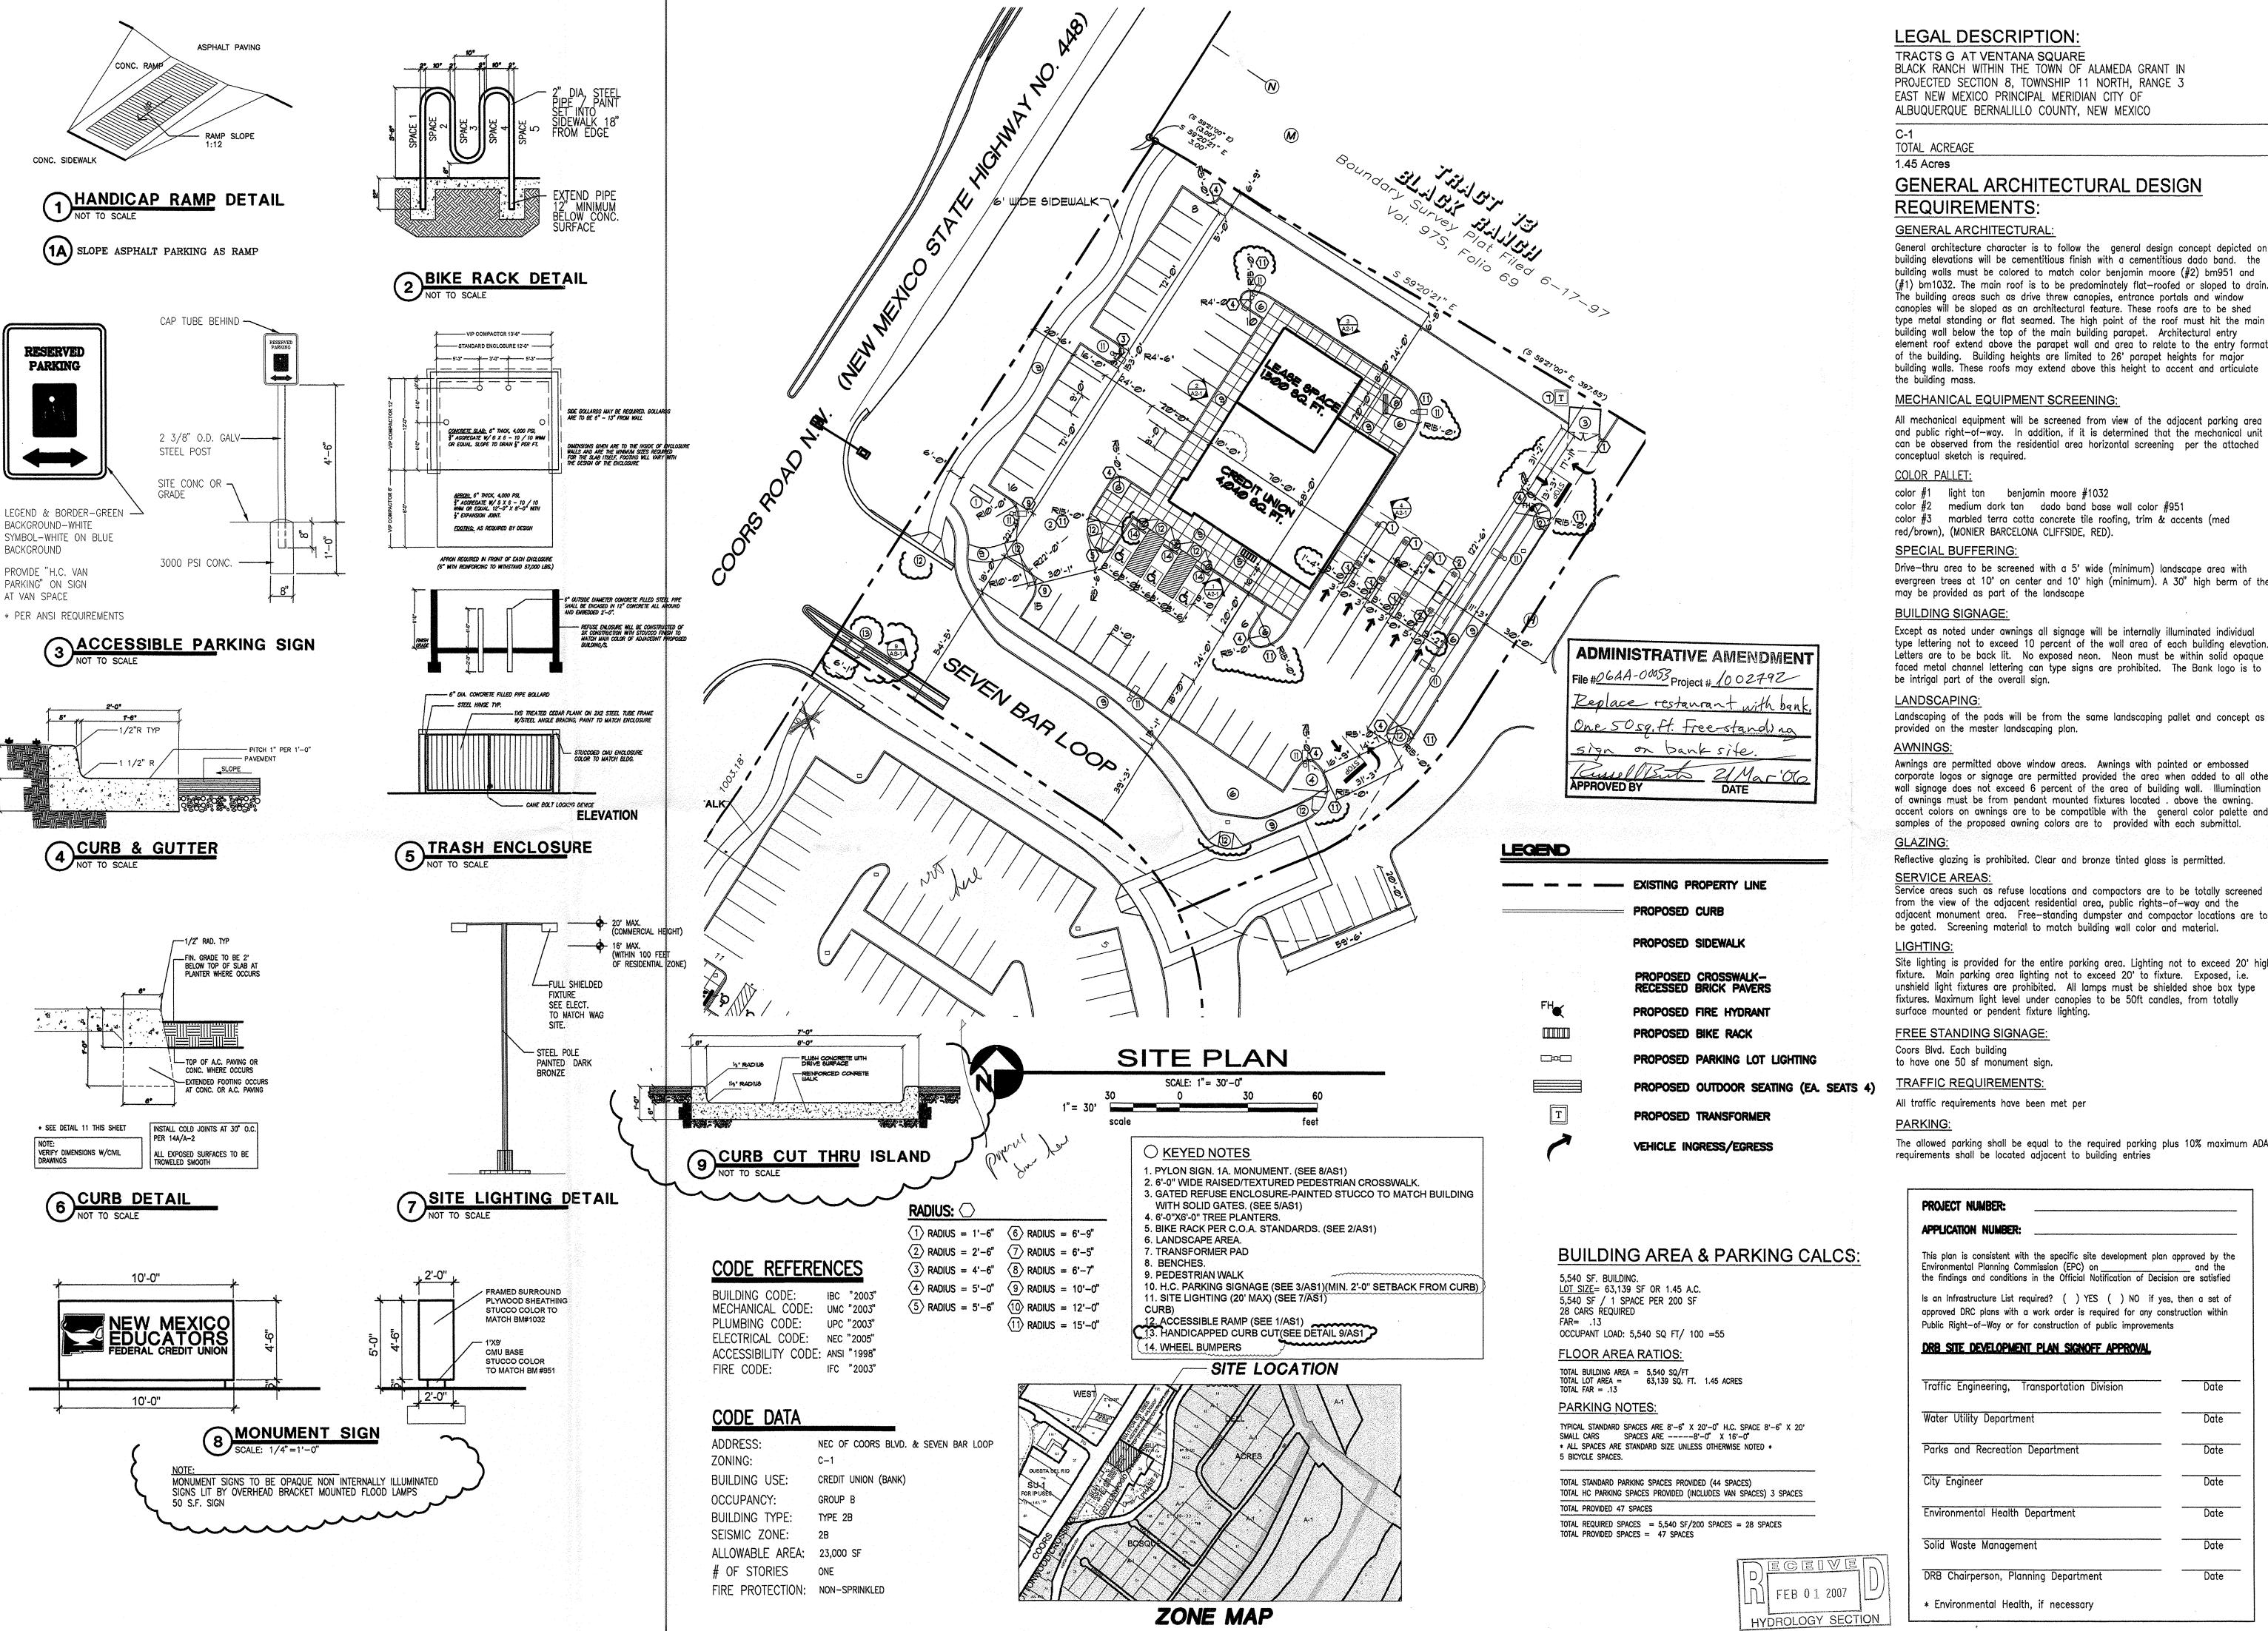

General architecture character is to follow the general design concept depicted on building elevations will be cementitious finish with a cementitious dado band. the building walls must be colored to match color benjamin moore (#2) bm951 and (#1) bm1032. The main roof is to be predominately flat—roofed or sloped to drain. The building areas such as drive threw canopies, entrance portals and window canopies will be sloped as an architectural feature. These roofs are to be shed type metal standing or flat seamed. The high point of the roof must hit the main building wall below the top of the main building parapet. Architectural entry element roof extend above the parapet wall and area to relate to the entry format of the building. Building heights are limited to 26' parapet heights for major building walls. These roofs may extend above this height to accent and articulate

All mechanical equipment will be screened from view of the adjacent parking area and public right-of-way. In addition, if it is determined that the mechanical unit can be observed from the residential area horizontal screening per the attached

color #3 marbled terra cotta concrete tile roofing, trim & accents (med

Drive—thru area to be screened with a 5' wide (minimum) landscape area with evergreen trees at 10' on center and 10' high (minimum). A 30" high berm of the

Except as noted under awnings all signage will be internally illuminated individual type lettering not to exceed 10 percent of the wall area of each building elevation. Letters are to be back lit. No exposed neon. Neon must be within solid opaque faced metal channel lettering can type signs are prohibited. The Bank logo is to

Landscaping of the pads will be from the same landscaping pallet and concept as

Awnings are permitted above window areas. Awnings with painted or embossed corporate logos or signage are permitted provided the area when added to all other wall signage does not exceed 6 percent of the area of building wall. Illumination of awnings must be from pendant mounted fixtures located , above the awning. accent colors on awnings are to be compatible with the general color palette and samples of the proposed awning colors are to provided with each submittal.

from the view of the adjacent residential area, public rights-of-way and the adjacent monument area. Free-standing dumpster and compactor locations are to

Site lighting is provided for the entire parking area. Lighting not to exceed 20' high fixture. Main parking area lighting not to exceed 20' to fixture. Exposed, i.e. unshield light fixtures are prohibited. All lamps must be shielded shoe box type

The allowed parking shall be equal to the required parking plus 10% maximum ADA

PRELIMINARY NOT FOR CONSTRUCTION

SUITE 2-B SUITE 2-B MEXICO 8711 FAX (505) 8

GEORGE RAINHART, AF 2325 SAN PEDRO NE., ALBUQUERQUE, NEW N PHONE (505) 884-9110

REDIT UNION		DRAWN BY:	WRS		
	RS FEDERAL CF	N BAR LOOP	JOB NO.	0560	
PROJECT TITLE	NEW MEXICO EDUCATORS FEDERAL CREDIT UNION	NEC OF COORS BLVD. & SEVEN BAR LOOP ALBUQUERQUE, NEW MEXICO	PROJECT MANAGER	Anton Dattilo	SITE PLAN

DATE:	sheet-			
3.13.2006	101			
SCALE:	AOI			
1"=30'	of-			

