TY OF ALBUQUERQUE

Planning Department Alan Varela, Director



Mayor Timothy M. Keller

June 25, 2024

Jacob Liberman Tierra West, LLC 5571 Midway Park PI NE Albuquerque, NM 87109

Re: Honeywell

9201 Pan American Fwy NE

Conceptual Traffic Circulation Layout for DFT Approval

Engineer's Stamp 06-21-24 (B17-D001B)

Dear Mr. Liberman,

The conceptual TCL submittal received 01-26-2024 is approved for DHO and/or DFT submittal. When submitting this project through the building permit process, a full Traffic Circulation Layout

will need to be submitted and approved prior to building permit.

When the site construction is completed and an inspection for Certificate of Occupancy (C.O.) is requested, use the original City stamped approved TCL for certification. Redline any minor changes and adjustments that were made in the field. A NM registered architect or engineer must stamp, sign, and date the certification TCL along with indicating that the development was built in "substantial compliance" with the TCL. Submit this certification, the TCL, and a completed Drainage and Transportation Information Sheet to front counter personnel for log in and evaluation by Transportation.

Albuquerque

Once verification of certification is completed and approved, notification will be made to Building Safety to issue Final C.O. To confirm that a final C.O. has been issued, call Building Safety at 924-3690.

NM 87103


PO Box 1293


Sincerely,


www.cabq.gov


Ernest Armijo, P.E.

Principal Engineer, Planning Dept. **Development Review Services**

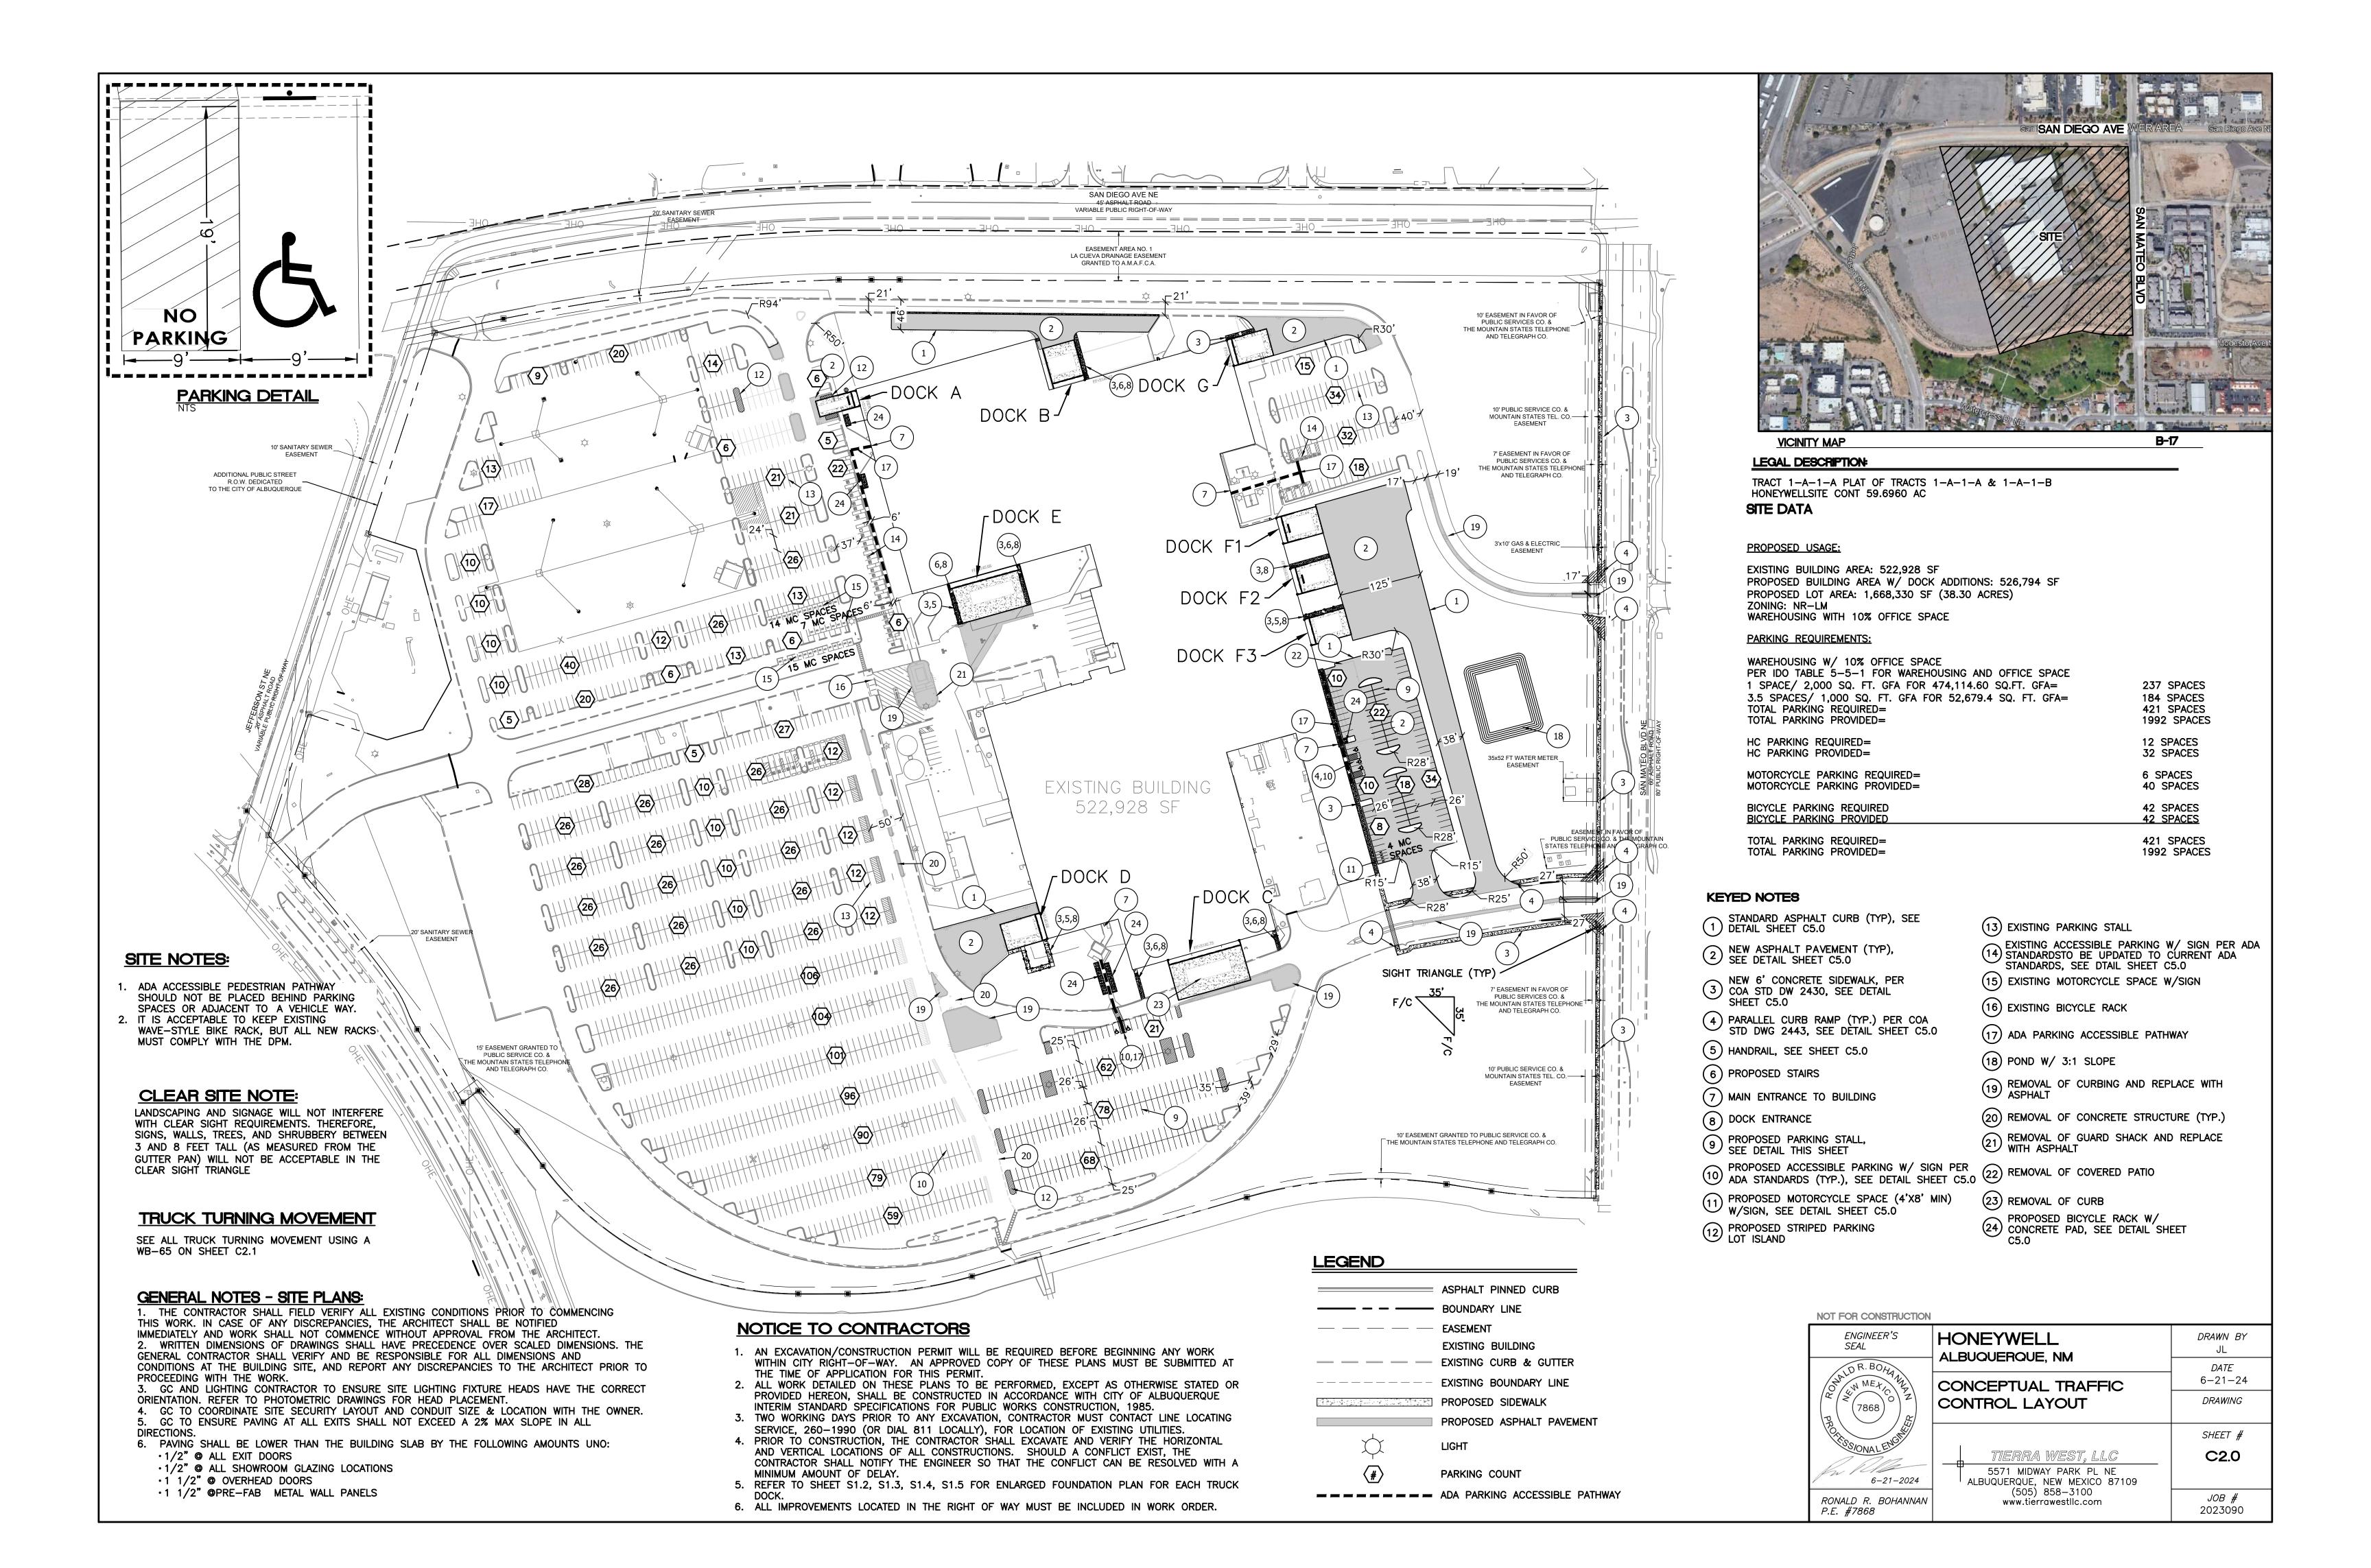

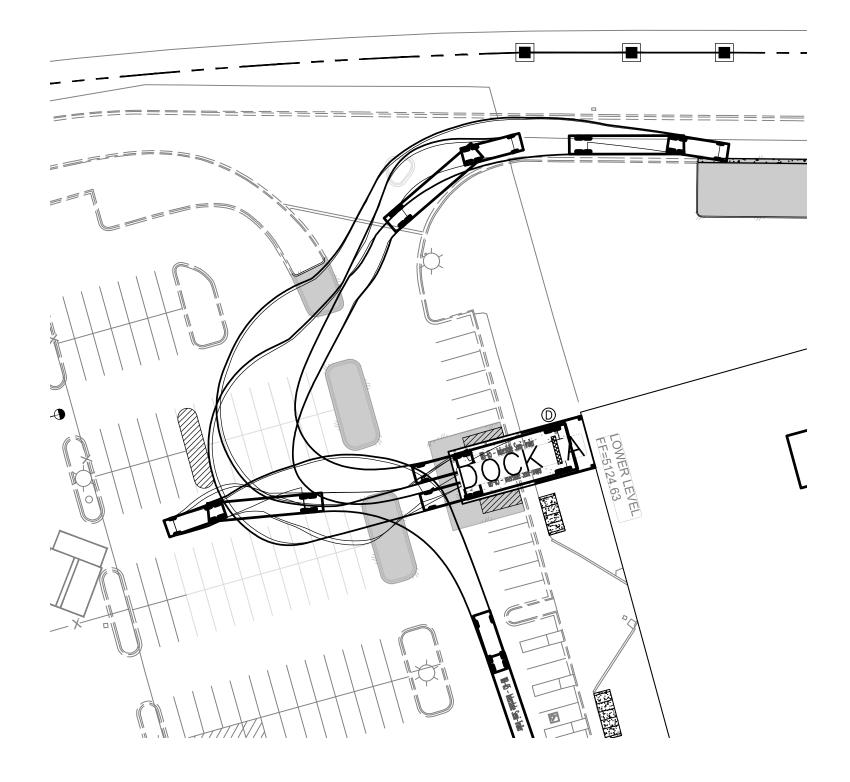

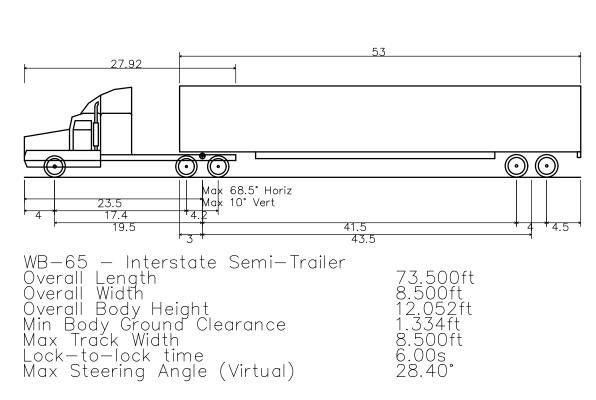

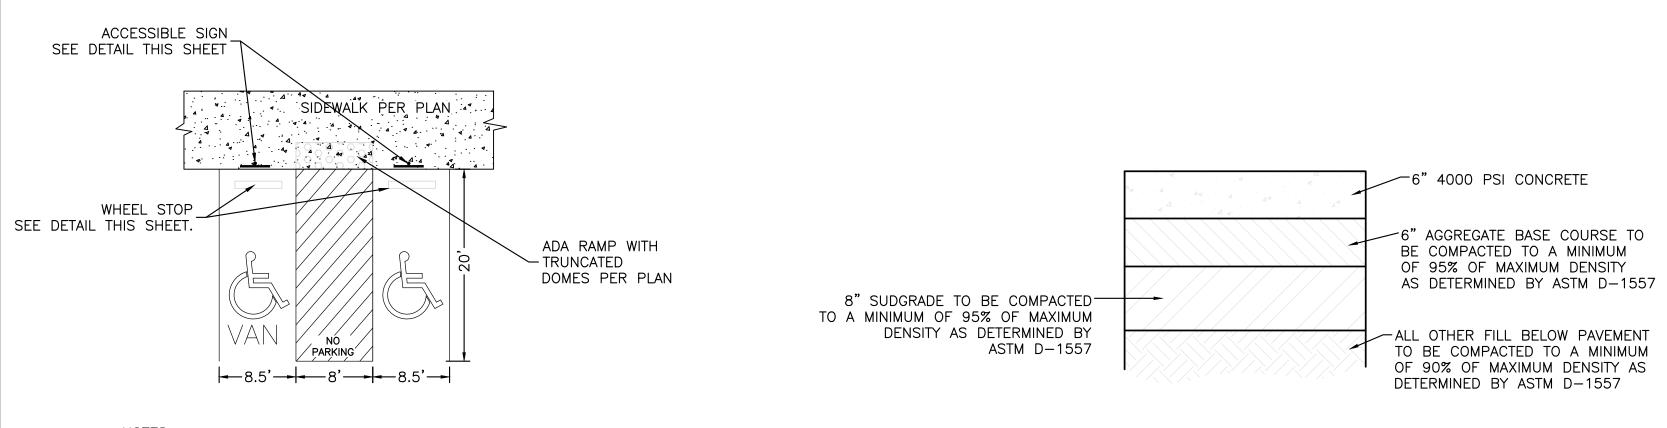


NOTES:

1)International Symbol of Accessibility shall be painted on the pavement at rear of space, white symbol on blue background.
2)Parking space lines and diagonal striping to be painted blue.
3)Access aisle shall have the words "NO PARKING" in capital letters, each of which shall be at least one foot high and at least two inches wide, placed at the rear of the parking space so as to be close to where an adjacent vehicle's rear tires would be placed.


4)ADA parking areas — not to exceed a slope greater than 2% in any direction


SCALE: NTS

(1) HC PARKING DETAIL

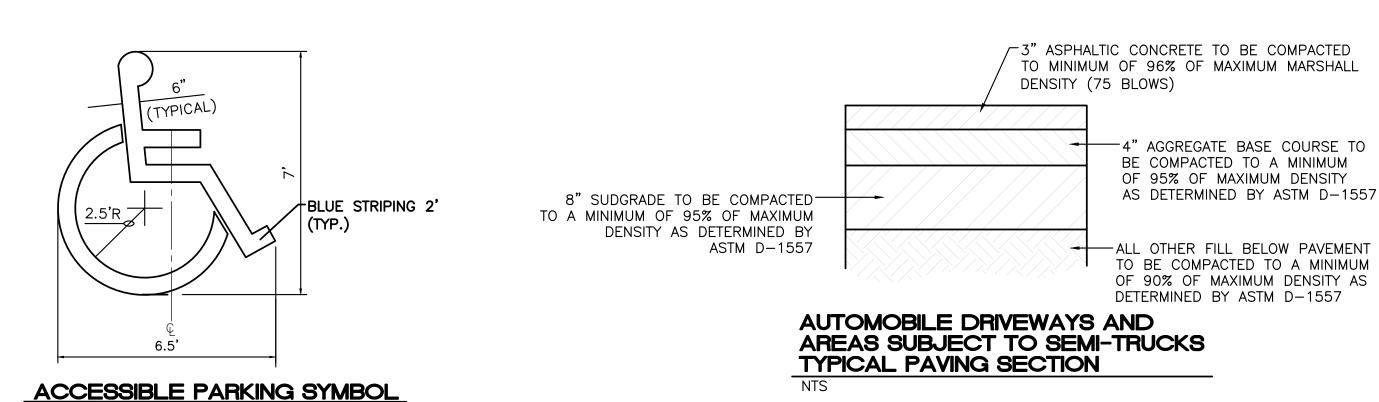


LOCATE AT EDGE OF PARKING SPACE UNLESS

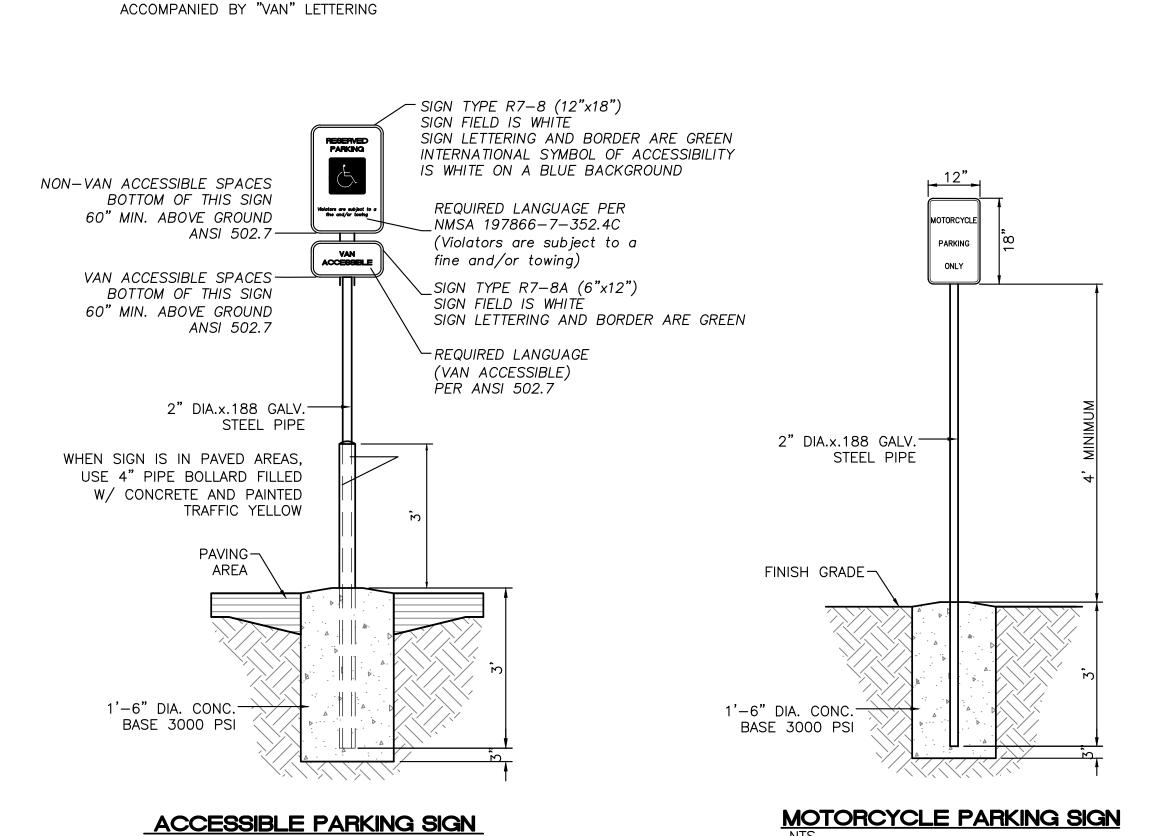

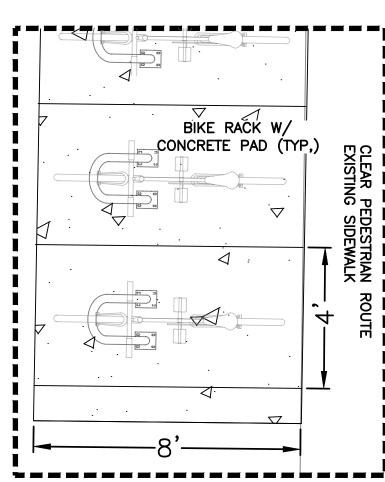

PROPOSED BICYCLE RACK W/ CONCRETE PAD DETAIL

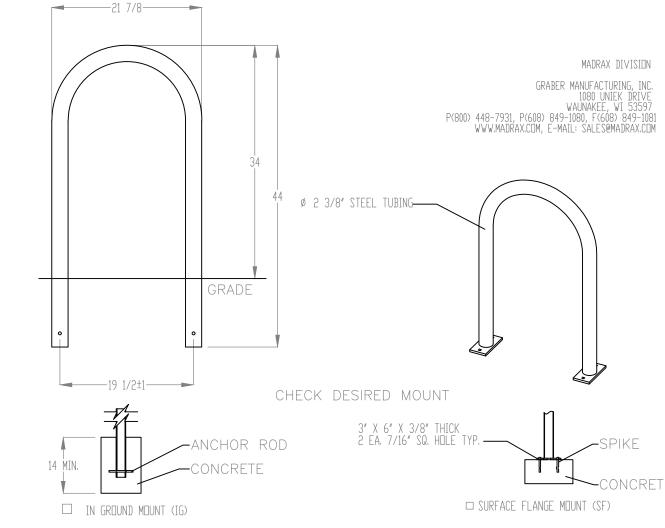

PRODUCT: U238-IG(SF)
DESCRIPTION: 'U' BIKE RACK
2 BIKE, SURFACE OR IN GROUND MOUNT
DATE: 10-4-18
ENG: SMC
CONFIDENTIAL DRAWING AND INFORMATION IS NOT TO BE COPIED OR DISCLOSED TO OTHERS WITHOUT THE CONSENT OF GRABER MANUFACTURING, INC.
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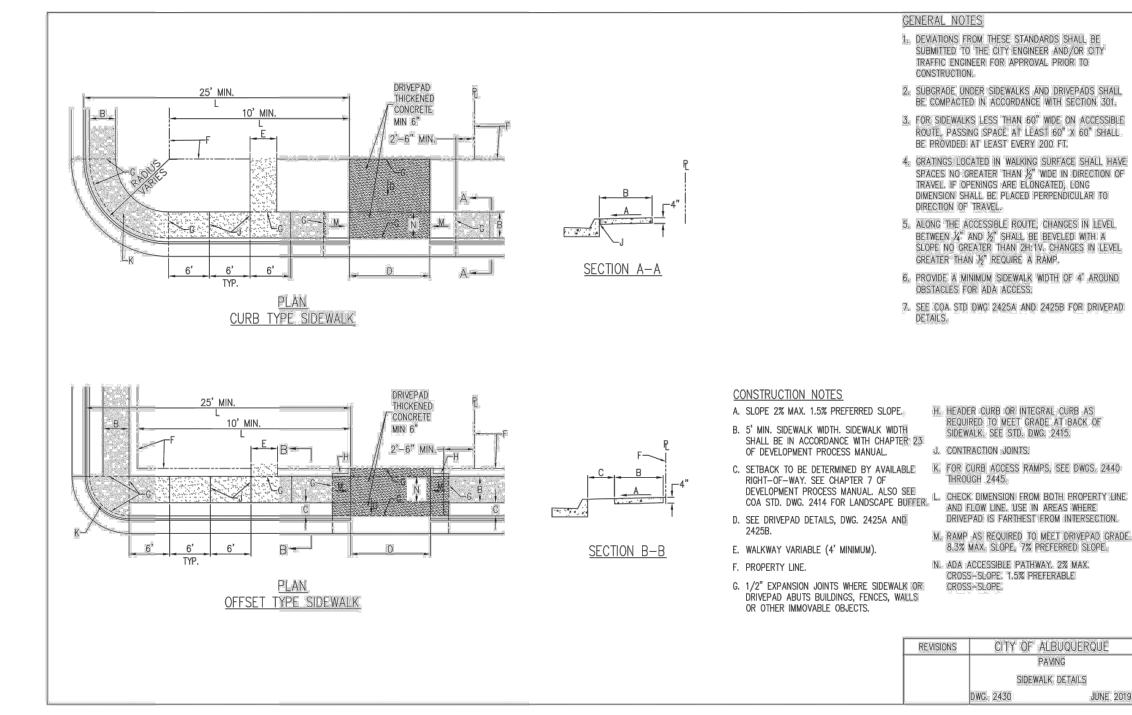
LOADING RAMP FOR SEMI-TRUCKS


PROVIDED SOILS REPORT.


NOTE: CONTRACTOR TO VERIFY WITH OWNER

NOTES:
1. INSTALL BIKE RACKS ACCORDING TO MANUFACTURER'S SPECIFICATIONS.
2. CONSULTANT TO SELECT COLOR (FINISH), SEE MANUFACTURER'S SPECIFICATIONS.
3. SEE SITE PLAN FOR LOCATION OR CONSULT DWNER.
3. BIKE RACK SHALL HAVE A 1-FOOT CLEAR ZONE ALL AROUND.
3. EACH BIKE RACK SPACE SHALL BE AT LEAST 6 FEET LONG AND 2 FEET WIDE.

BIKE RACK DETAIL SCALE: NONE



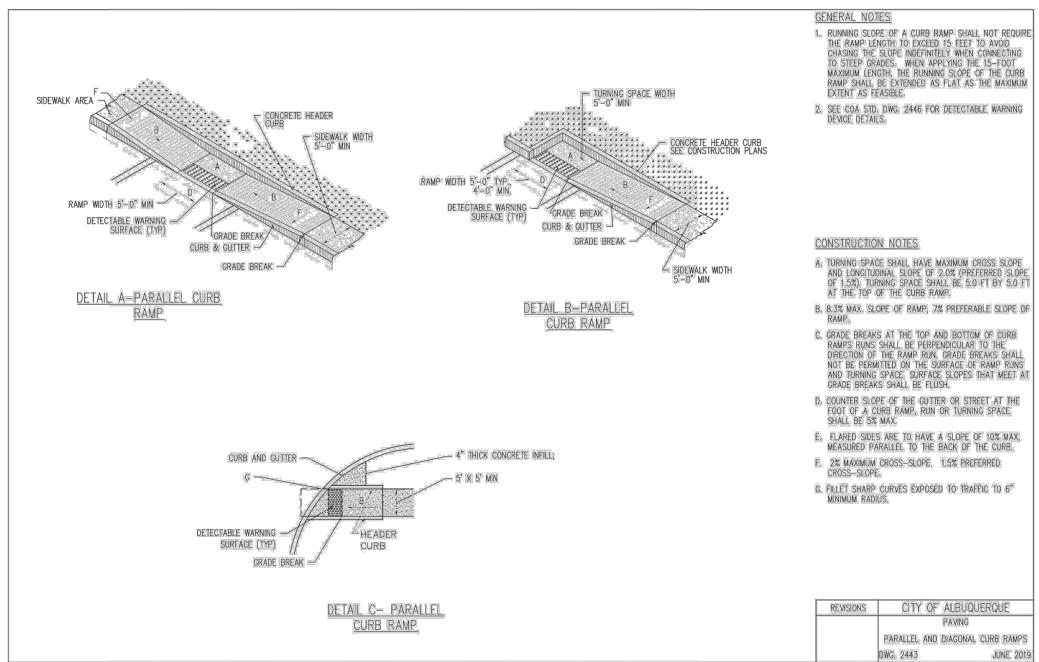

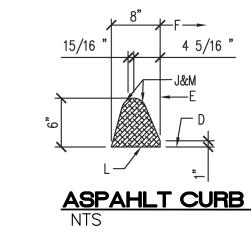

- D. EXISTING ASPHALT CONCRETE (AC) OR PORTLAND CEMENT CONCRETE (PCC) PAVEMENT.
- E. FACE OF CURB/FLOW LINE.
- F. TRAFFIC SIDE.
- J. 2" RADIUS.
- L. TACK COAT.
- M. DIMENSIONS AT ROUNDED CORNERS MEASURED TO INTERSECTION OF STRAIGHT LINE.

NOT FOR CONSTRUCTION			
	NOT	FOR	CONSTRUCTION

ENGINEER'S SEAL	HONEYWELL ALBUQUERQUE, NM	<i>DRAWN BY</i> JL
DR. BOH	ALBOGOLITGOL, INVI	DATE
DR. BOHANA WMEXICOZZ	DETAIL SHEET	6-21-24
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RONALD R. BOHANNAN P.E. #7868	(505) 858-3100 www.tierrawestllc.com	<i>JOB #</i> 2023090
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