CITY OF ALBUQUERQUE



July 21, 2016

Richard J. Berry, Mayor

Glenn S. Broughton, P.E. Bohannan Huston 7601 Jefferson NE, Suite 100 Albuquerque, NM, 87109

RE: Presbyterian Rev. Hugh Cooper

Grading & Drainage Plan (Stamp Date 6-21-16)

Hydrology File: B17D003

Dear Mr. Broughton:

Based upon the information provided in your submittal received 6-24-2016, the above-referenced is approved for ESC Building Permit.

Prior to any grading on the site, an ESC Grading Permit must be processed (see attached).

PO Box 1293

Please attach a copy of this approved plan in the construction sets when submitting for a building permit. Prior to Certificate of Occupancy release, Engineer Certification per the DPM checklist will be required.

Albuquerque

If you have any questions, you can contact me at 924-3986.

New Mexico 87103

www.cabq.gov

Abiel Carrillo, P.E.

Sincerely

Principal Engineer, Planning Dept. Development Review Services



Project Title:

City of Albuquerque

Planning Department

Development & Building Services Division

DRAINAGE AND TRANSPORTATION INFORMATION SHEET

(REV 02/2013)

Building Permit #: City Drainage #:

DRB#: EPC	#: Work 0	Order#:
Legal Description:		
City Address:		
Engineering Firm:	Contac	t:
Address:		
Phone#: Fax#	E-mail:	
Owner:	Contac	t:
Address:		
Phone#: Fax#	: E-mail:	
Architect:	Contac	t:
Address:		
Phone#: Fax#	: E-mail:	:
Surveyor:	Contac	t:
Address:		
Phone#: Fax#	E-mail:	
Contractor:	Contac	t:
Address:		
Phone#: Fax#	: E-mail:	
TYPE OF SUBMITTAL:	CHECK TYPE OF APPROVAL/ACC	CEPTANCE SOUGHT:
DRAINAGE REPORT	SIA/FINANCIAL GUARANTEE REI	LEASE
DRAINAGE PLAN 1st SUBMITTAL	JINAGE PLAN 1st SUBMITTAL PRELIMINARY PLAT APPROVAL	
DRAINAGE PLAN RESUBMITTAL	AINAGE PLAN RESUBMITTAL S. DEV. PLAN FOR SUB'D APPROVAL	
CONCEPTUAL G & D PLAN S. DEV. FOR BLDG. PERMIT APPROVAI		OVAL
GRADING PLAN SECTOR PLAN APPROVA		
EROSION & SEDIMENT CONTROL PLAN (ESC) FINAL PLAT APPROVAL		
ENGINEER'S CERT (HYDROLOGY) CERTIFICATE OF OCCUP		ERM)
CLOMR/LOMR CERTIFICATE OF OCCUPANCY (TCL TEMP)		TCL TEMP)
TRAFFIC CIRCULATION LAYOUT (TCL)	AFFIC CIRCULATION LAYOUT (TCL) FOUNDATION PERMIT APPROVAL	
ENGINEER'S CERT (TCL)	BUILDING PERMIT APPROVAL	
ENGINEER'S CERT (DRB SITE PLAN)	GRADING PERMIT APPROVAL	SO-19 APPROVAL
ENGINEER'S CERT (ESC)	PAVING PERMIT APPROVAL	ESC PERMIT APPROVAL
SO-19	WORK ORDER APPROVAL	ESC CERT. ACCEPTANCE
OTHER (SPECIFY)	GRADING CERTIFICATION	OTHER (SPECIFY)
WAS A PRE-DESIGN CONFERENCE ATTENDED:	Yes No Copy Provi	ided
DATE SUBMITTED:	By:	

Requests for approvals of Site Development Plans and/or Subdivision Plats shall be accompanied by a drainage submittal. The particular nature, location, and scope to the proposed development defines the degree of drainage detail. One or more of the following levels of submittal may be required based on the followin

- 1. Conceptual Grading and Drainage Plan: Required for approval of Site Development Plans greater than five (5) acres and Sector Plans
- Drainage Plans: Required for building permits, grading permits, paving permits and site plans less than five (5) acres Drainage Report: Required for subdivision containing more than ten (10) lots or constituting five (5) acres or more
- Erosion and Sediment Control Plan: Required for any new development and redevelopment site with 1-acre or more of land disturbing area, including project less than 1-acre than are part of a larger common plan of development

505.761.9700 / DPSDESIGN.ORG

ARCHITECTURE / DESIGN / INSPIRATION


REVISIONS

DRAWN BY	ВО
REVIEWED BY	GSB
DATE	06/21/2016
PROJECT NO	15-0129

DRAWING NAME **OVERALL &**

GENERATOR PAD GRADING PLAN

C-100

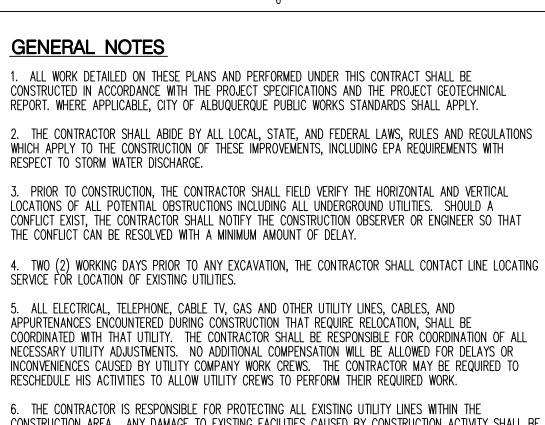

RESCHEDULE HIS ACTIVITIES TO ALLOW UTILITY CREWS TO PERFORM THEIR REQUIRED WORK.

CONSTRUCTION AREA. ANY DAMAGE TO EXISTING FACILITIES CAUSED BY CONSTRUCTION ACTIVITY SHALL BE REPAIRED OR REPLACED AT THE CONTRACTOR'S EXPENSE AND APPROVED BY THE CONSTRUCTION 7. CONSTRUCTION ACTIVITY SHALL BE LIMITED TO THE PROPERTY AND/OR PROJECT LIMITS. ANY DAMAGE

TO ADJACENT PROPERTIES RESULTING FROM THE CONSTRUCTION PROCESS SHALL BE REPAIRED OR REPLACED AT THE CONTRACTOR'S EXPENSE. 8. OVERNIGHT PARKING OF CONSTRUCTION EQUIPMENT SHALL NOT OBSTRUCT DRIVEWAYS OR DESIGNATED TRAFFIC LANES. THE CONTRACTOR SHALL NOT STORE ANY EQUIPMENT OR MATERIAL WITHIN THE PUBLIC

9. THE CONTRACTOR SHALL OBTAIN ALL THE NECESSARY PERMITS FOR THE PROJECT PRIOR TO COMMENCING CONSTRUCTION (I.E., BARRICADING, TOPSOIL DISTURBANCE, EXCAVATION PERMITS, EPA STORM WATER PERMITS, ETC.).

10. ALL PROPERTY CORNERS DESTROYED DURING CONSTRUCTION SHALL BE REPLACED AT THE CONTRACTOR'S EXPENSE. ALL PROPERTY CORNERS MUST BE RESET BY A REGISTERED LAND SURVEYOR. 11. THE CONTRACTOR SHALL PREPARE A CONSTRUCTION TRAFFIC CONTROL AND SIGNING PLAN AND OBTAIN APPROVAL OF SUCH PLAN FROM THE CITY OF ALBUQUERQUE, TRAFFIC ENGINEERING DEPARTMENT, PRIOR TO BEGINNING ANY CONSTRUCTION WORK ON OR ADJACENT TO EXISTING STREETS.

"MANUAL ON UNIFORM TRAFFIC CONTROL DEVICES" (MUTCD), US DEPARTMENT OF TRANSPORTATION, LATEST 13. THE CONTRACTOR SHALL MAINTAIN ALL CONSTRUCTION BARRICADES AND SIGNING AT ALL TIMES. THE CONTRACTOR SHALL VERIFY THE PROPER LOCATION OF ALL BARRICADING.

12. ALL BARRICADES AND CONSTRUCTION SIGNING SHALL CONFORM TO APPLICABLE SECTIONS OF THE

14. THE CONTRACTOR SHALL TAKE ALL STEPS NECESSARY TO CONFORM WITH EPA REQUIREMENTS, INCLUDING COMPLIANCE WITH NPDES PHASE 2 REQUIREMENTS.

GRADING NOTES

OR PUBLIC RIGHT-OF-WAY.

RIGHT-OF-WAY.

1. EXCEPT AS PROVIDED HEREIN, GRADING SHALL BE PERFORMED AT THE ELEVATIONS AND IN ACCORDANCE WITH THE DETAILS SHOWN ON THIS PLAN.

2. THE COST FOR REQUIRED CONSTRUCTION DUST AND EROSION CONTROL MEASURES SHALL BE INCIDENTAL TO THE PROJECT COST.

3. ALL WORK RELATIVE TO FOUNDATION CONSTRUCTION, SITE PREPARATION, AND PAVEMENT INSTALLATION, AS SHOWN ON THIS PLAN, SHALL BE CONSTRUCTED IN ACCORDANCE WITH THE "GEOTECHNICAL INVESTIGATION". ALL OTHER WORK SHALL, UNLESS OTHERWISE STATED OR PROVIDED FOR HEREON, BE CONSTRUCTED IN ACCORDANCE WITH THE PROJECT, (FIRST PRIORITY) SPECIFICATIONS, AND/OR THE CITY OF ALBUQUERQUE (COA) STANDARD SPECIFICATIONS FOR PUBLIC WORKS (SECOND PRIORITY).

4. EARTH SLOPES SHALL NOT EXCEED 3 HORIZONTAL TO 1 VERTICAL UNLESS SHOWN OTHERWISE. 5. IT IS THE INTENT OF THESE PLANS THAT THIS CONTRACTOR SHALL NOT PERFORM ANY WORK OUTSIDE OF THE PROPERTY BOUNDARIES EXCEPT AS REQUIRED BY THIS PLAN. 6. THE CONTRACTOR IS TO ENSURE THAT NO SOIL ERODES FROM THE SITE ONTO ADJACENT PROPERTY


7. A DISPOSAL SITE FOR ANY & ALL EXCESS EXCAVATION MATERIAL, AND UNSUITABLE MATERIAL AND/OR A BORROW SITE CONTAINING ACCEPTABLE FILL MATERIAL SHALL BE OBTAINED BY THE CONTRACTOR IN COMPLIANCE WITH APPLICABLE ENVIRONMENTAL REGULATIONS AND APPROVED BY THE OBSERVER. ALL COSTS INCURRED IN OBTAINING A DISPOSAL OR BORROW SITE AND HAUL TO OR FROM SHALL BE CONSIDERED INCIDENTAL TO THE PROJECT AND NO SEPARATE MEASUREMENT OR PAYMENT SHALL BE MADE.


8. PAVING AND ROADWAY GRADES SHALL BE +/- 0.1' FROM PLAN ELEVATIONS. PAD ELEVATION SHALL BE +/- 0.05' FROM BUILDING PLAN ELEVATION.

9. VERIFY ALL ELEVATIONS SHOWN ON PLAN FROM BASIS OF ELEVATION CONTROL STATION PRIOR TO BEGINNING CONSTRUCTION.

NOTE: SEE SHEET C-300 FOR PROJECT BENCHMARKS.

OVERALL GRADING PLAN

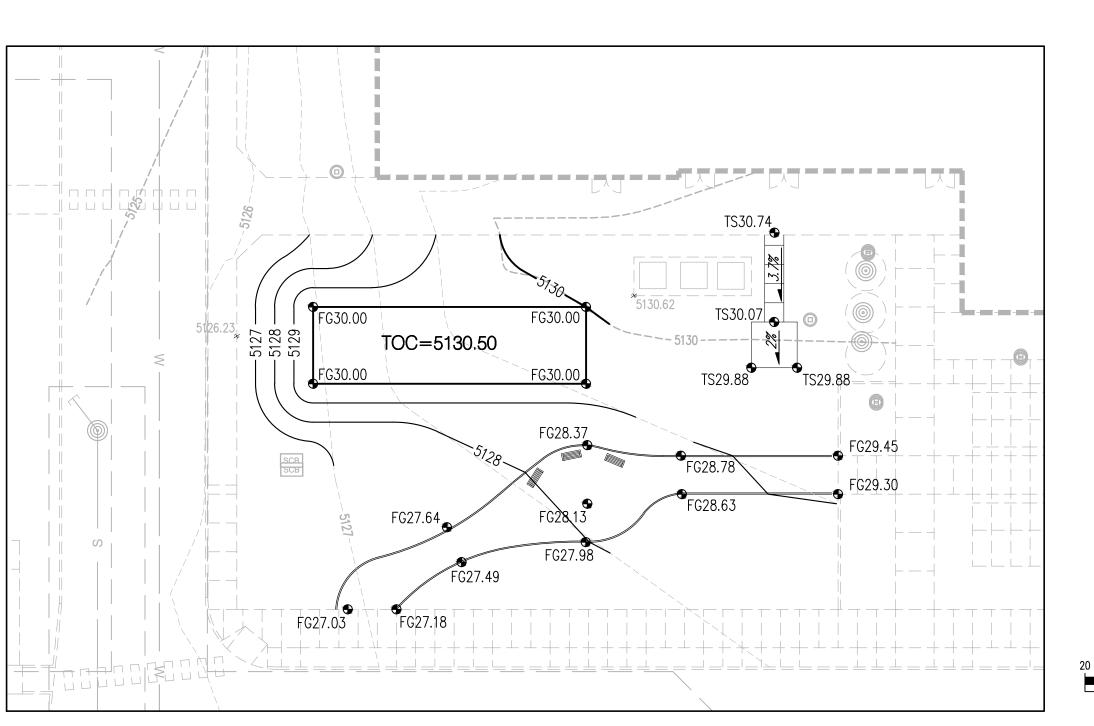

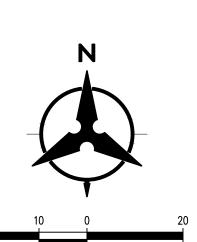

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TEXISTING 20' PUBLIC

METAL LIGHT POLE

SEWER EASEMENT

WATERLINE EASEMENT

SEE GENERATOR PAD

<u>______</u>

-SEE SHEET C-101

FOR GRADING PLAN

EXISTING 20' PUBLIC |

WATERLINE EASEMENT


TITL**E** DOC #12

GRADING PLAN

BELOW

Bohannan A Huston

GENERATOR PAD GRADING PLAN
1"=20'

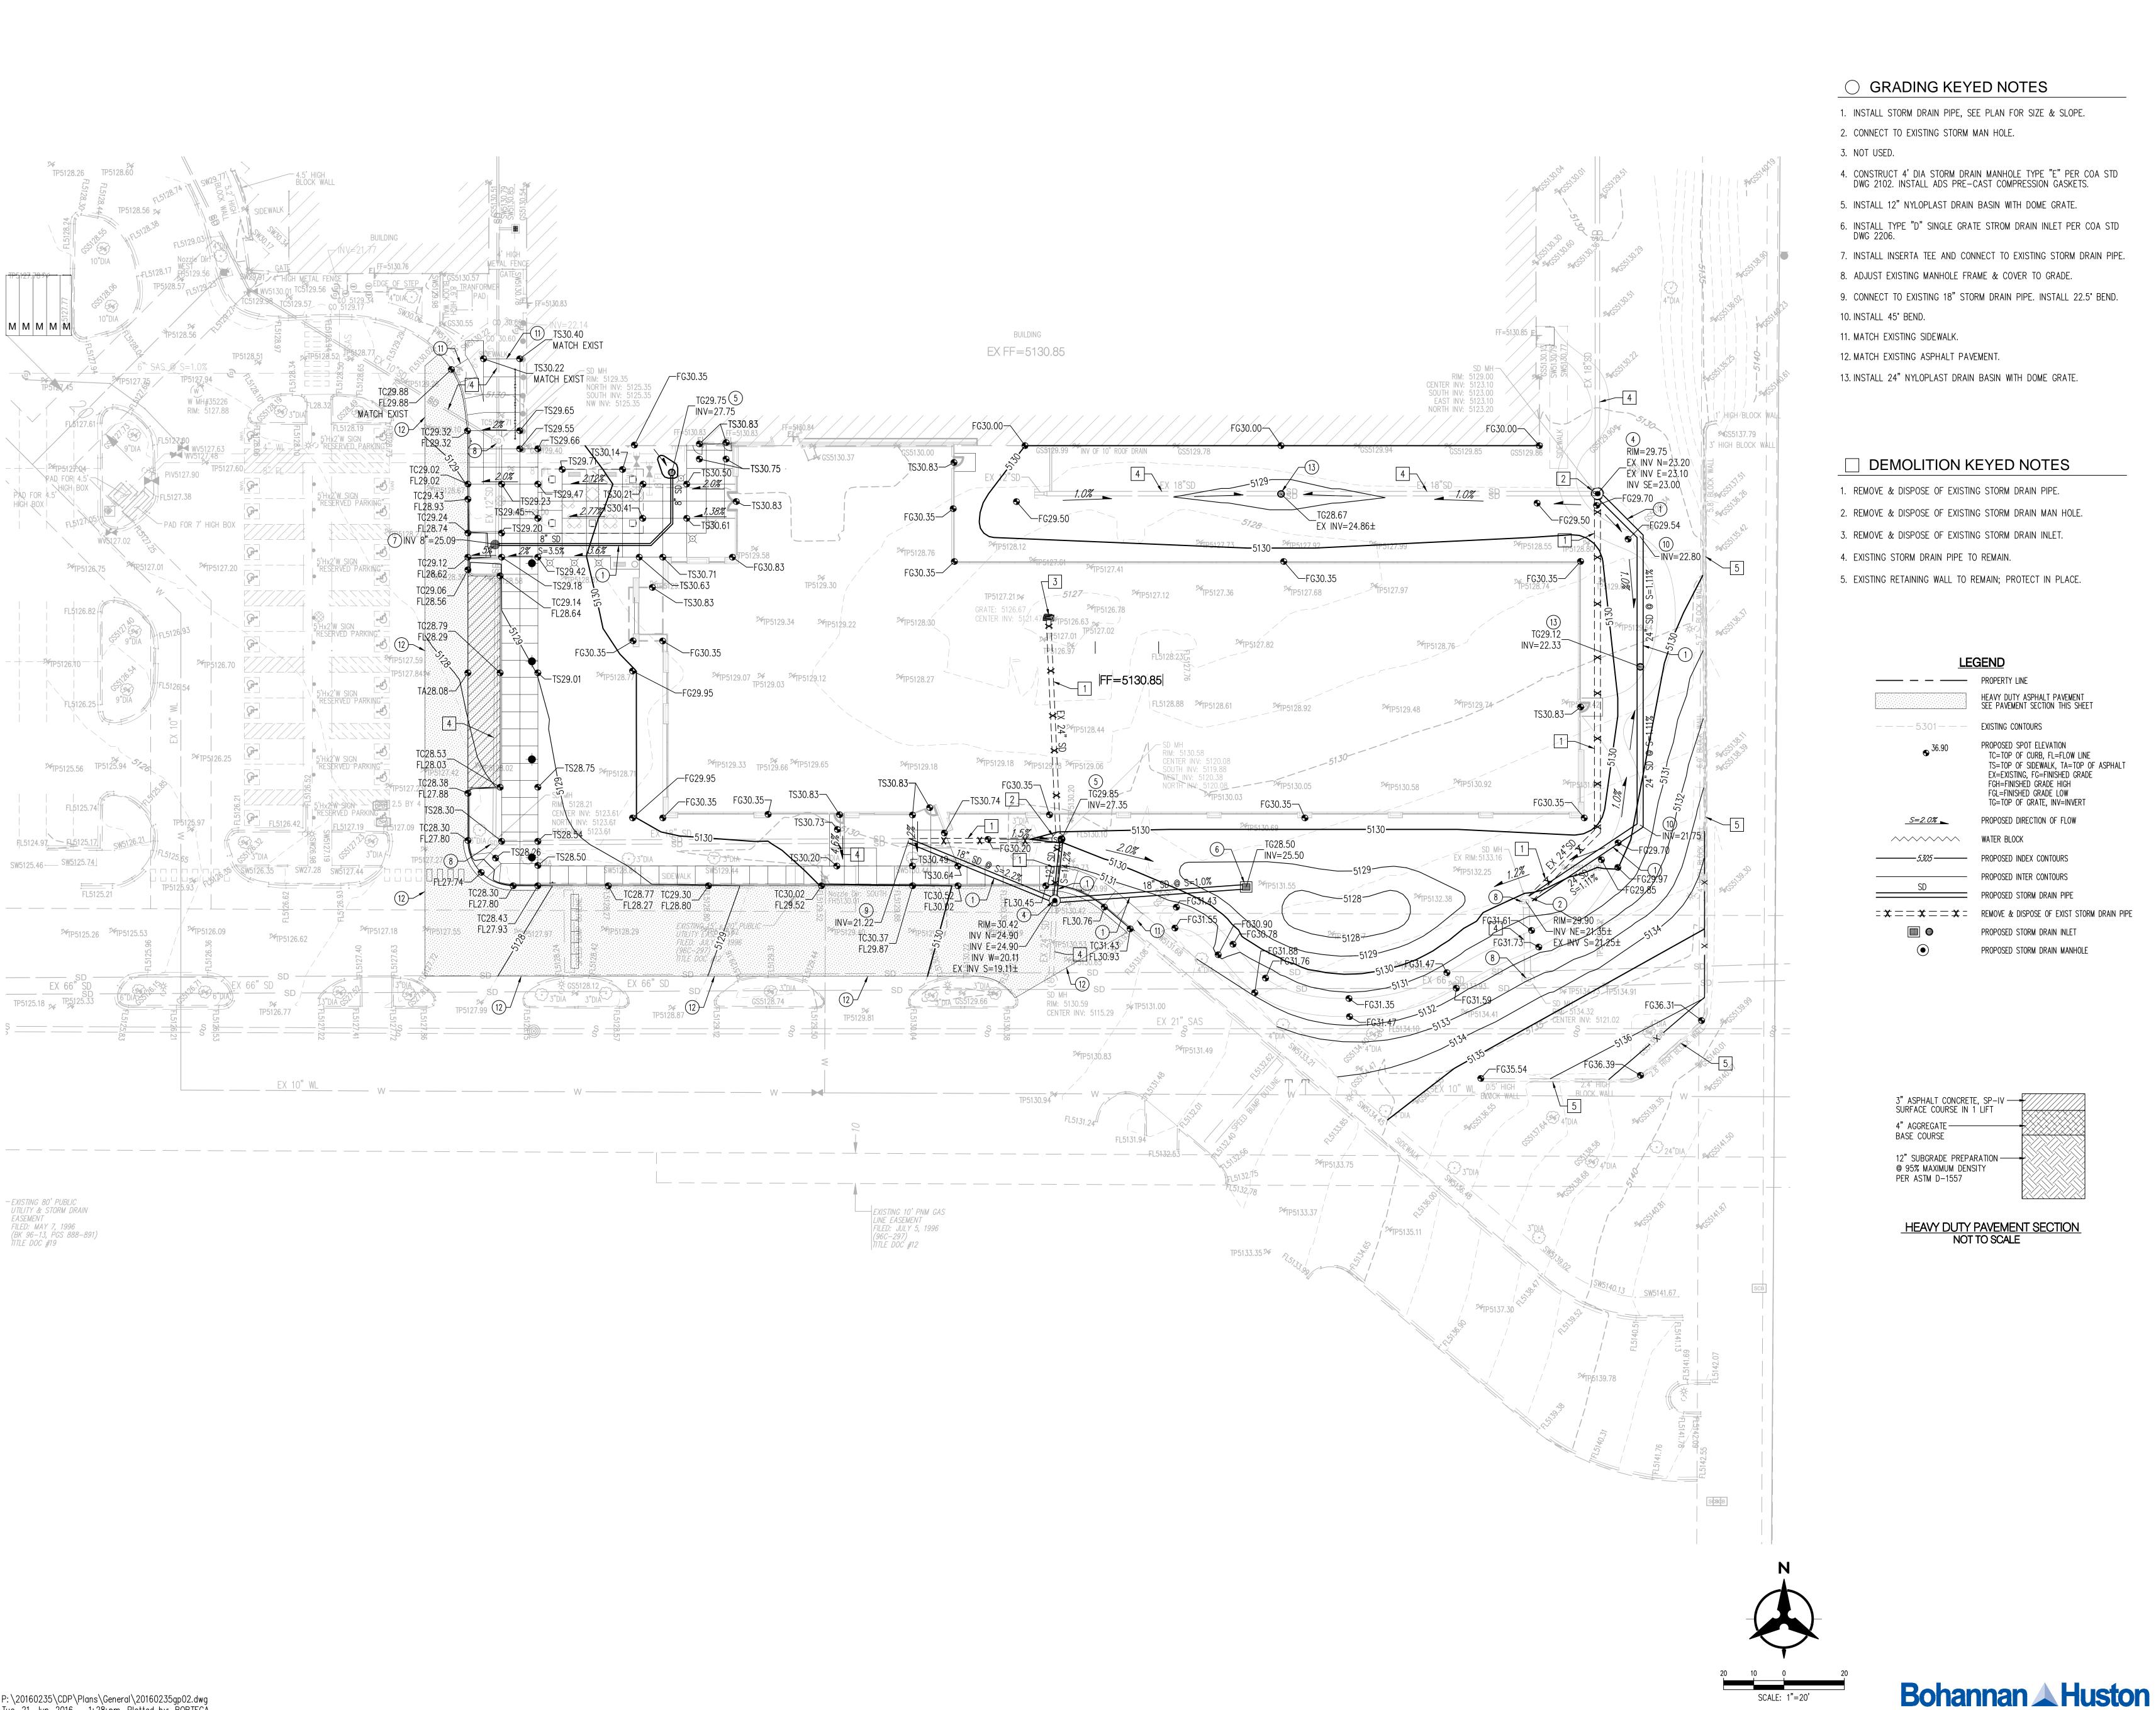

ARCHITECTURE / DESIGN / INSPIRATION

DEKKER PERICH SABATINI

7601 JEFFERSON NE, SUITE 100 ALBUQUERQUE, NM 87109

505.761.9700 / DPSDESIGN.ORG



PROJECT

Sbyterian Rev. | Administrative

CONSTRUCTION DOCUMENTS

REVISIONS

RAWN BY	ВО
EVIEWED BY	GSB
ATE	06/21/2016
ROJECT NO	15-0129

DRAWING NAME **GRADING PLAN**

C-101

