CITY OF ALBUQUERQUE

December 1, 2017



Glenn Broughton, PE Bohannan-Huston 7500 Jefferson St NE Courtyard I Albuquerque, NM 87109

Presbyterian Rev. Hugh Cooper Administrative Center Re:

9521 San Mateo Blvd. NE

Request Permanent C.O. - Accepted

Engineer's Stamp dated: 6-21-17 (B17D003)

Certification dated: 11-30-17

Dear Mr. Broughton,

Based on the Certification received 11/30/2017, the above referenced is approved for a permanent Release of Occupancy by Hydrology.

If you have any questions, you can contact me at 924-3986 or Totten Elliott at 924-3682.

PO Box 1293

Albuquerque

NM 87103

Sincerely,

mu D'Benjker James D. Hughes, P.E.

Principal Engineer, Planning Dept.

Development and Review Services

www.cabq.gov

TE/JH

C: email Serna, Yvette M.; Fox, Debi; Tena, Victoria C.; Sandoval, Darlene M.

RESPECT TO STORM WATER DISCHARGE.

SERVICE FOR LOCATION OF EXISTING UTILITIES.

REPLACED AT THE CONTRACTOR'S EXPENSE.

RIGHT-OF-WAY.

WATER PERMITS, ETC.).

OR PUBLIC RIGHT-OF-WAY.

1. ALL WORK DETAILED ON THESE PLANS AND PERFORMED UNDER THIS CONTRACT SHALL BE CONSTRUCTED IN ACCORDANCE WITH THE PROJECT SPECIFICATIONS AND THE PROJECT GEOTECHNICAL

REPORT. WHERE APPLICABLE, CITY OF ALBUQUERQUE PUBLIC WORKS STANDARDS SHALL APPLY.

2. THE CONTRACTOR SHALL ABIDE BY ALL LOCAL, STATE, AND FEDERAL LAWS, RULES AND REGULATIONS WHICH APPLY TO THE CONSTRUCTION OF THESE IMPROVEMENTS, INCLUDING EPA REQUIREMENTS WITH

4. TWO (2) WORKING DAYS PRIOR TO ANY EXCAVATION, THE CONTRACTOR SHALL CONTACT LINE LOCATING

COORDINATED WITH THAT UTILITY. THE CONTRACTOR SHALL BE RESPONSIBLE FOR COORDINATION OF ALL

CONSTRUCTION AREA. ANY DAMAGE TO EXISTING FACILITIES CAUSED BY CONSTRUCTION ACTIVITY SHALL BE

7. CONSTRUCTION ACTIVITY SHALL BE LIMITED TO THE PROPERTY AND/OR PROJECT LIMITS. ANY DAMAGE TO ADJACENT PROPERTIES RESULTING FROM THE CONSTRUCTION PROCESS SHALL BE REPAIRED OR

8. OVERNIGHT PARKING OF CONSTRUCTION EQUIPMENT SHALL NOT OBSTRUCT DRIVEWAYS OR DESIGNATED TRAFFIC LANES. THE CONTRACTOR SHALL NOT STORE ANY EQUIPMENT OR MATERIAL WITHIN THE PUBLIC

COMMENCING CONSTRUCTION (I.E., BARRICADING, TOPSOIL DISTURBANCE, EXCAVATION PERMITS, EPA STORM

CONTRACTOR'S EXPENSE. ALL PROPERTY CORNERS MUST BE RESET BY A REGISTERED LAND SURVEYOR.

OBTAIN APPROVAL OF SUCH PLAN FROM THE CITY OF ALBUQUERQUE, TRAFFIC ENGINEERING DEPARTMENT,

11. THE CONTRACTOR SHALL PREPARE A CONSTRUCTION TRAFFIC CONTROL AND SIGNING PLAN AND

12. ALL BARRICADES AND CONSTRUCTION SIGNING SHALL CONFORM TO APPLICABLE SECTIONS OF THE

"MANUAL ON UNIFORM TRAFFIC CONTROL DEVICES" (MUTCD), US DEPARTMENT OF TRANSPORTATION, LATEST

13. THE CONTRACTOR SHALL MAINTAIN ALL CONSTRUCTION BARRICADES AND SIGNING AT ALL TIMES. THE

14. THE CONTRACTOR SHALL TAKE ALL STEPS NECESSARY TO CONFORM WITH EPA REQUIREMENTS,

9. THE CONTRACTOR SHALL OBTAIN ALL THE NECESSARY PERMITS FOR THE PROJECT PRIOR TO

10. ALL PROPERTY CORNERS DESTROYED DURING CONSTRUCTION SHALL BE REPLACED AT THE

PRIOR TO BEGINNING ANY CONSTRUCTION WORK ON OR ADJACENT TO EXISTING STREETS.

CONTRACTOR SHALL VERIFY THE PROPER LOCATION OF ALL BARRICADING.

INCLUDING COMPLIANCE WITH NPDES PHASE 2 REQUIREMENTS.

NECESSARY UTILITY ADJUSTMENTS. NO ADDITIONAL COMPENSATION WILL BE ALLOWED FOR DELAYS OR INCONVENIENCES CAUSED BY UTILITY COMPANY WORK CREWS. THE CONTRACTOR MAY BE REQUIRED TO

3. PRIOR TO CONSTRUCTION, THE CONTRACTOR SHALL FIELD VERIFY THE HORIZONTAL AND VERTICAL

LOCATIONS OF ALL POTENTIAL OBSTRUCTIONS INCLUDING ALL UNDERGROUND UTILITIES. SHOULD A CONFLICT EXIST, THE CONTRACTOR SHALL NOTIFY THE CONSTRUCTION OBSERVER OR ENGINEER SO THAT

5. ALL ELECTRICAL, TELEPHONE, CABLE TV. GAS AND OTHER UTILITY LINES, CABLES, AND

RESCHEDULE HIS ACTIVITIES TO ALLOW UTILITY CREWS TO PERFORM THEIR REQUIRED WORK.

6. THE CONTRACTOR IS RESPONSIBLE FOR PROTECTING ALL EXISTING UTILITY LINES WITHIN THE

REPAIRED OR REPLACED AT THE CONTRACTOR'S EXPENSE AND APPROVED BY THE CONSTRUCTION

APPURTENANCES ENCOUNTERED DURING CONSTRUCTION THAT REQUIRE RELOCATION, SHALL BE

THE CONFLICT CAN BE RESOLVED WITH A MINIMUM AMOUNT OF DELAY.

ARCHITECTURE / DESIGN / INSPIRATION

505.761.9700 / DPSDESIGN.ORG

PROJECT

GRADING NOTES 1. EXCEPT AS PROVIDED HEREIN, GRADING SHALL BE PERFORMED AT THE ELEVATIONS AND IN ACCORDANCE WITH THE DETAILS SHOWN ON THIS PLAN. 2. THE COST FOR REQUIRED CONSTRUCTION DUST AND EROSION CONTROL MEASURES SHALL BE INCIDENTAL TO THE PROJECT COST.

3. ALL WORK RELATIVE TO FOUNDATION CONSTRUCTION, SITE PREPARATION, AND PAVEMENT INSTALLATION, AS SHOWN ON THIS PLAN. SHALL BE CONSTRUCTED IN ACCORDANCE WITH THE "GEOTECHNICAL INVESTIGATION". ALL OTHER WORK SHALL, UNLESS OTHERWISE STATED OR PROVIDED FOR HEREON, BE CONSTRUCTED IN ACCORDANCE WITH THE PROJECT, (FIRST PRIORITY) SPECIFICATIONS, AND/OR THE CITY OF ALBUQUERQUE (COA) STANDARD SPECIFICATIONS FOR PUBLIC WORKS (SECOND PRIORITY). 4. EARTH SLOPES SHALL NOT EXCEED 3 HORIZONTAL TO 1 VERTICAL UNLESS SHOWN OTHERWISE.

5. IT IS THE INTENT OF THESE PLANS THAT THIS CONTRACTOR SHALL NOT PERFORM ANY WORK OUTSIDE OF THE PROPERTY BOUNDARIES EXCEPT AS REQUIRED BY THIS PLAN. 6. THE CONTRACTOR IS TO ENSURE THAT NO SOIL ERODES FROM THE SITE ONTO ADJACENT PROPERTY

7. A DISPOSAL SITE FOR ANY & ALL EXCESS EXCAVATION MATERIAL, AND UNSUITABLE MATERIAL AND/OR A BORROW SITE CONTAINING ACCEPTABLE FILL MATERIAL SHALL BE OBTAINED BY THE CONTRACTOR IN ' COMPLIANCE WITH APPLICABLE ENVIRONMENTAL REGULATIONS AND APPROVED BY THE OBSERVER. ALL COSTS INCURRED IN OBTAINING A DISPOSAL OR BORROW SITE AND HAUL TO OR FROM SHALL BE CONSIDERED INCIDENTAL TO THE PROJECT AND NO SEPARATE MEASUREMENT OR PAYMENT SHALL BE MADE.

8. PAVING AND ROADWAY GRADES SHALL BE +/- 0.1' FROM PLAN ELEVATIONS. PAD ELEVATION SHALL BE +/- 0.05' FROM BUILDING PLAN ELEVATION.

9. VERIFY ALL ELEVATIONS SHOWN ON PLAN FROM BASIS OF ELEVATION CONTROL STATION PRIOR TO BEGINNING CONSTRUCTION.



NOTE: SEE SHEET C-300 FOR PROJECT BENCHMARKS.

OVERALL GRADING PLAN

N89° 45' 39" W 857, 00'

greens sources sources among sources sources

SEWER EASEMENT

- SAS-CLEANDUT

STORM INLET

FIRE HYDRANT HETAL LIGHT POLE

PULL BOX COMMUNICATIO DRILL HOLÈ

VALVE-POST INDICATOR

POST-PEPEYSTEEL

MANHOLE STORM SEVER
SIGN

TOP OF PAVEMENT FLOYLINE ELEVATION

METER-WATER

HANHOLE-WATER

VALVE-WATER

SIDEWALK ELEVATION

-48, PGS 892-895)_

or assessor assessor arrange

____ prome record mod___

MISC POINT (SEE PLAN)

BUILDING FINISHED FLOOR ELEVATION, FENCE-CTYPED

FILED: JULY 5, 1996

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American resource account of the

N89° 45' 39" W 1452. 18'

EXISTING 20' PUBLIC WATERLINE EASEMENT

SEE GENERATOR PAD

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PAD FOR 7' HASH BOX

GRADING PLAN

ATERLINE EASEMENT

SCALE: 1"=20'


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NOTION DESCRIPT ENTERIOR MARRIEN PROPERTY SERVICION SERVICION SERVICION DESCRIPTO CONTROL DESCRIPTO DESCRI

-SEE SHEET C-101

FOR GRADING PLAN

BARRE TRANSIT STATES CHANGE COME AND ADDRESS PROCESS CHANGE CHANG

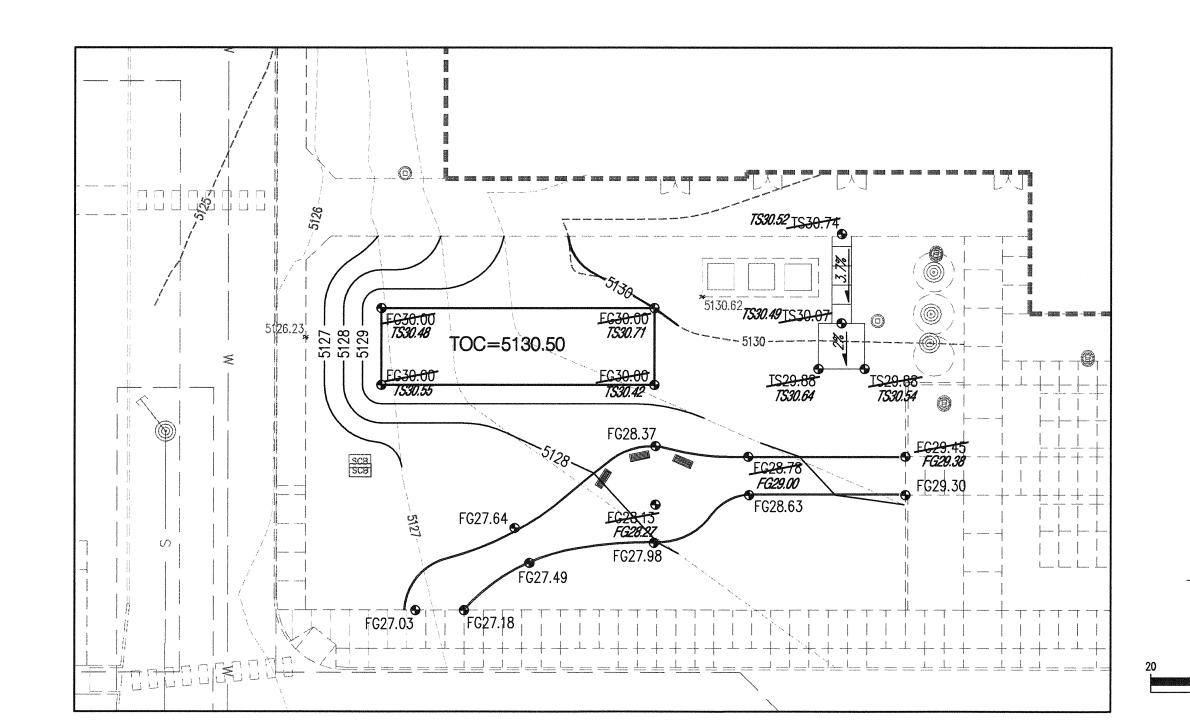

GENERATOR PAD GRADING PLAN
1"=20"

DRAINAGE CERTIFICATION

I, GLENN S. BROUGHTON, NMPE 14171, OF THE FIRM BOHANNAN HUSTON INC., HEREBY CERTIFY THAT THIS PROJECT HAS BEEN GRADED AND WILL DRAIN IN SUBSTANTIAL COMPLIANCE WITH AND IN ACCORDANCE WITH THE DESIGN INTENT OF THE APPROVED PLAN DATED 6-21-16. THE RECORD INFORMATION EDITED ONTO THE ORIGINAL DESIGN DOCUMENT HAS BEEN OBTAINED BY BRIAN MARTINEZ, NMRPS 18374. OF THE FIRM CARTESIAN SURVEYS INC. I FURTHER CERTIFY THAT I HAVE PERSONALLY VISITED THE PROJECT SITE ON 11/29/2017 AND HAVE DETERMINED BY VISUAL INSPECTION THAT THE SURVEY DATA PROVIDED IS REPRESENTATIVE OF ACTUAL SITE CONDITIONS AND IS TRUE AND CORRECT TO THE BEST OF MY KNOWLEDGE AND BELIEF. THIS CERTIFICATION IS SUBMITTED IN SUPPORT OF A REQUEST FOR A PERMANENT CERTIFICATE OF OCCUPANCY FOR THE BUILDING.

THE RECORD INFORMATION PRESENTED HEREON IS NOT NECESSARILY COMPLETE AND INTENDED ONLY TO VERIFY SUBSTANTIAL COMPLIANCE OF THE GRADING AND DRAINAGE ASPECTS OF THIS PROJECT. THOSE RELYING ON THIS RECORD DOCUMENT ARE ADVISED TO OBTAIN INDEPENDENT VERIFICATION OF ITS ACCURACY BEFORE USING IT FOR ANY OTHER PURPOSE.

LEGEND FL70.22 DESIGN GRADE AS-BUILT GRADE

REVIEWED BY GSB 06/21/2016 DATE PROJECT NO 15-0129 DRAWING NAME

CONSTRUCTION

DOCUMENTS

REVISIONS


DRAWN BY

OVERALL & GENERATOR PAD GRADING PLAN

C-100

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Bohannan A Huston

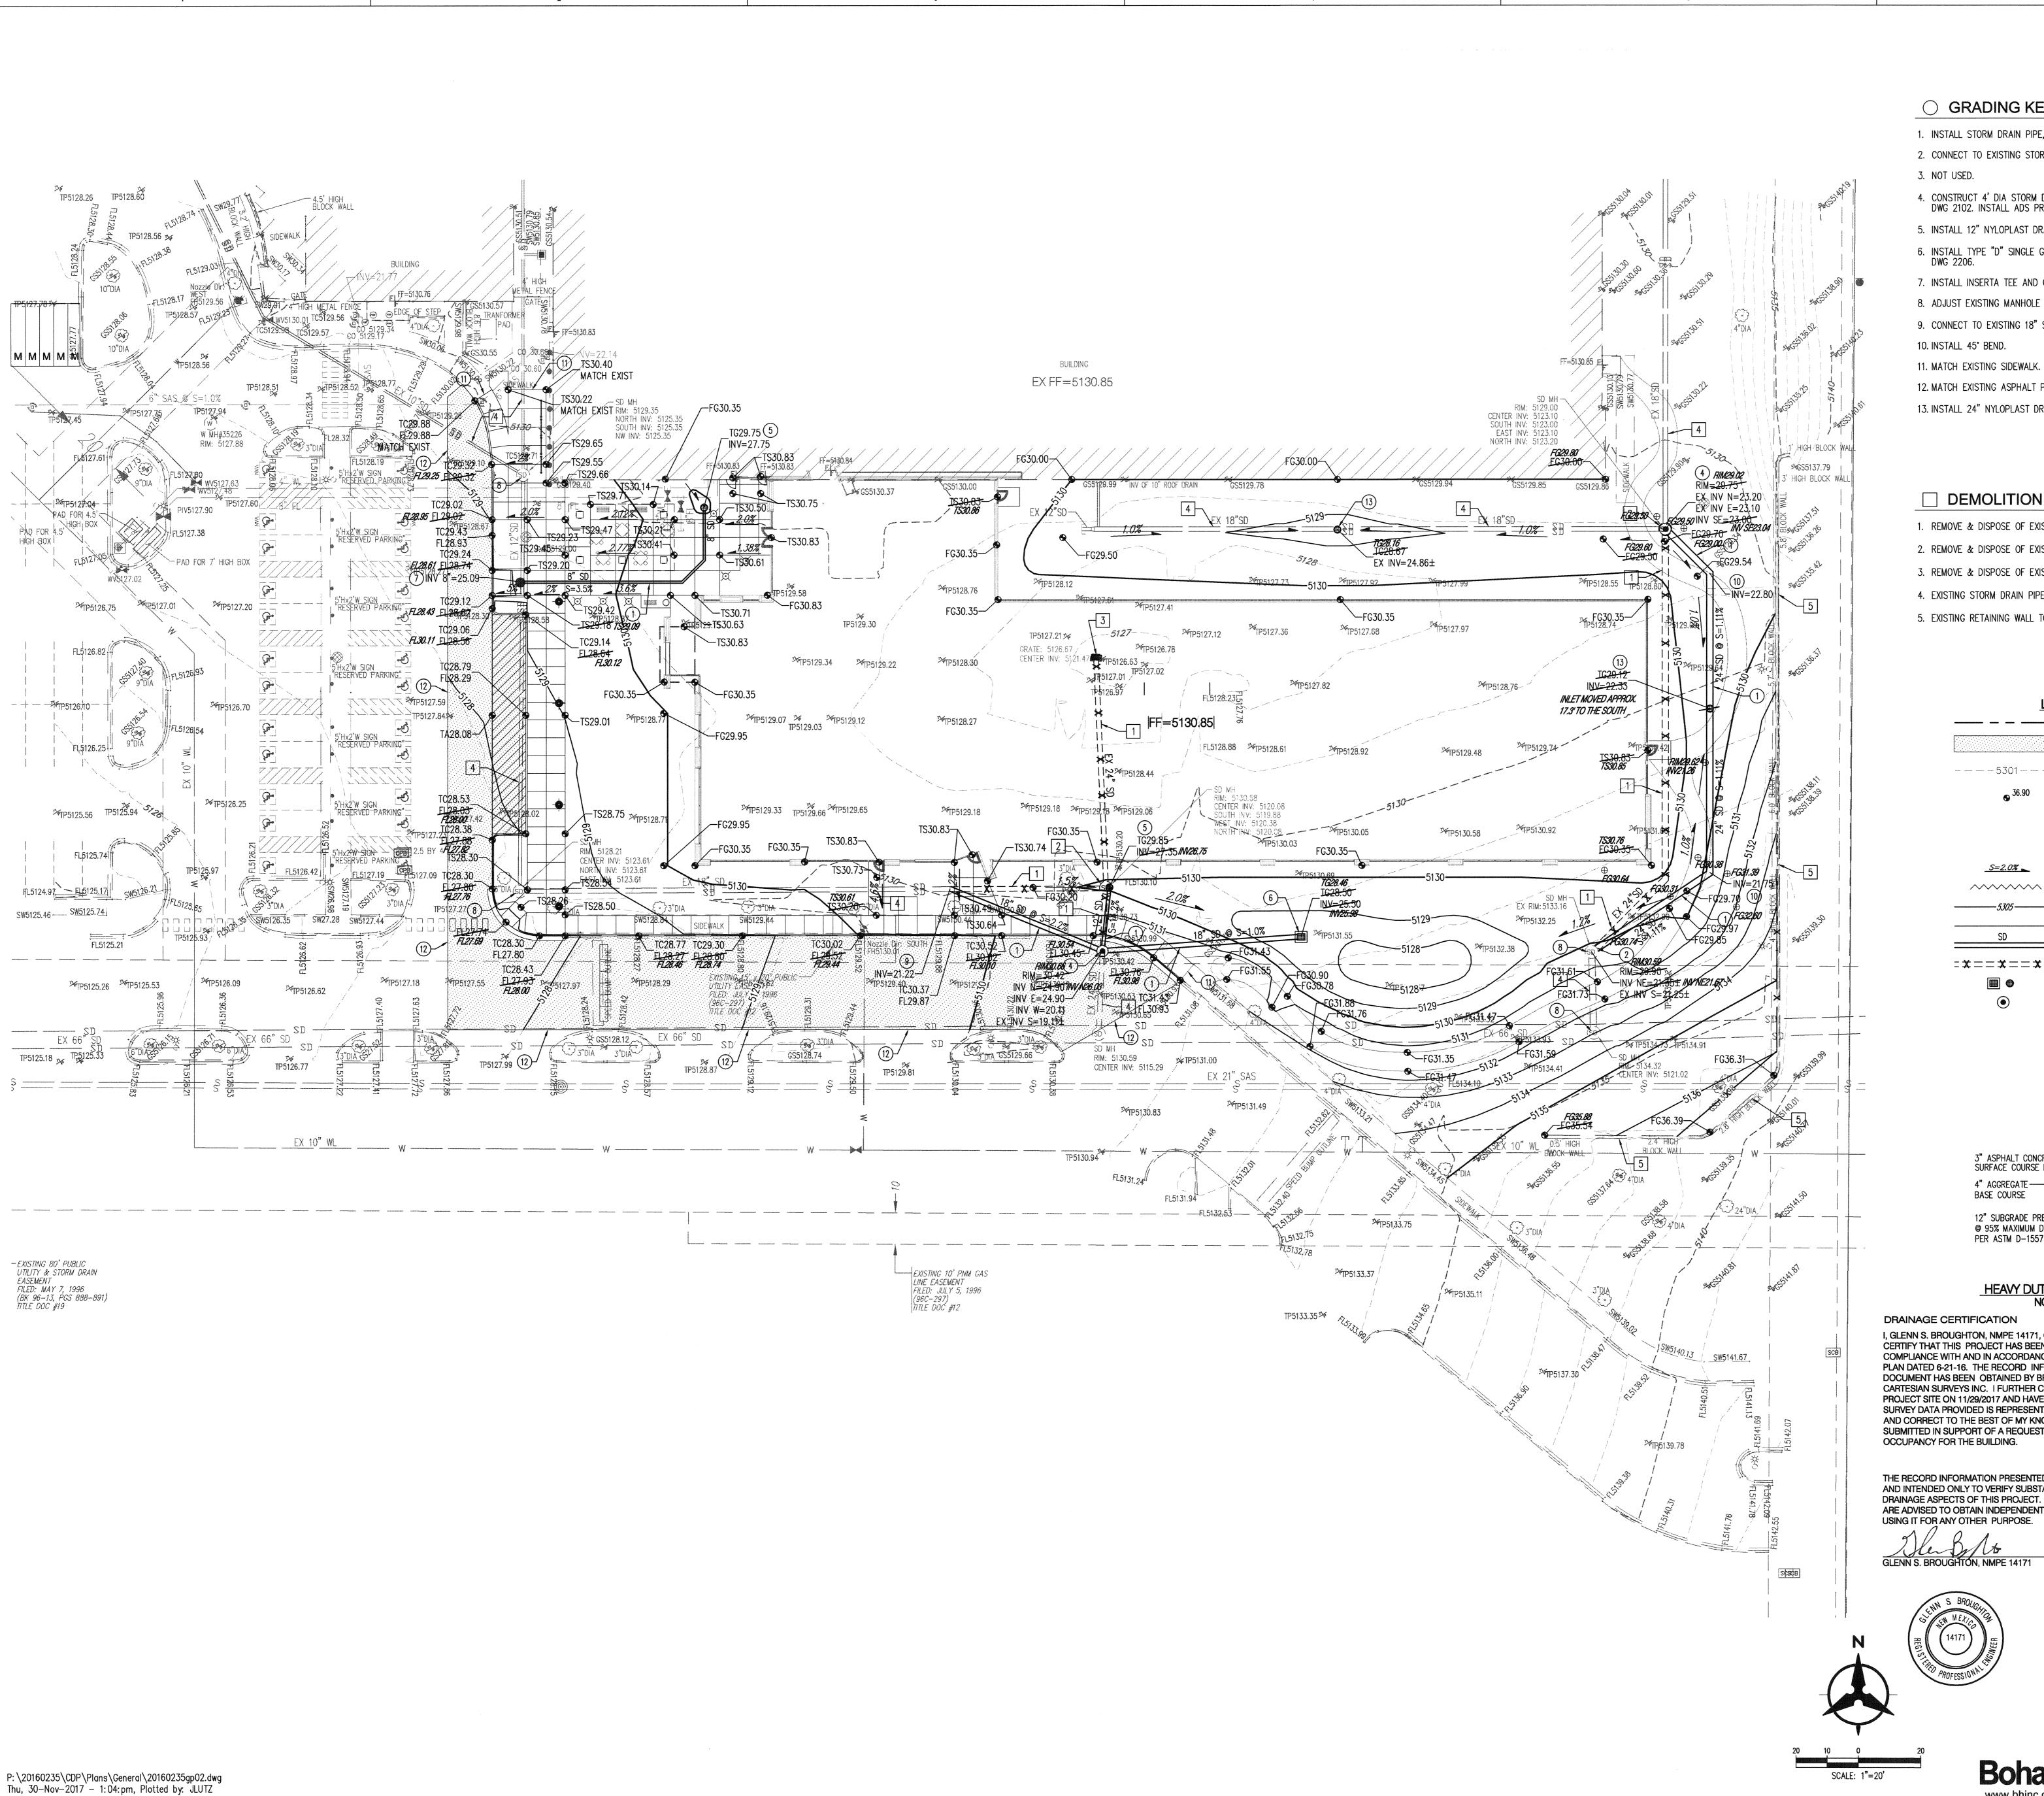


○ GRADING KEYED NOTES

- 1. INSTALL STORM DRAIN PIPE, SEE PLAN FOR SIZE & SLOPE.
- 2. CONNECT TO EXISTING STORM MAN HOLE.
- 4. CONSTRUCT 4' DIA STORM DRAIN MANHOLE TYPE "E" PER COA STD DWG 2102. INSTALL ADS PRE-CAST COMPRESSION GASKETS.
- 5. INSTALL 12" NYLOPLAST DRAIN BASIN WITH DOME GRATE.
- 6. INSTALL TYPE "D" SINGLE GRATE STROM DRAIN INLET PER COA STD DWG 2206.
- 7. INSTALL INSERTA TEE AND CONNECT TO EXISTING STORM DRAIN PIPE.
- 8. ADJUST EXISTING MANHOLE FRAME & COVER TO GRADE.
- 9. CONNECT TO EXISTING 18" STORM DRAIN PIPE. INSTALL 22.5" BEND.
- 12. MATCH EXISTING ASPHALT PAVEMENT.
- 13. INSTALL 24" NYLOPLAST DRAIN BASIN WITH DOME GRATE.

DEMOLITION KEYED NOTES

- 1. REMOVE & DISPOSE OF EXISTING STORM DRAIN PIPE.
- 2. REMOVE & DISPOSE OF EXISTING STORM DRAIN MAN HOLE.
- 3. REMOVE & DISPOSE OF EXISTING STORM DRAIN INLET.
- 4. EXISTING STORM DRAIN PIPE TO REMAIN.
- 5. EXISTING RETAINING WALL TO REMAIN; PROTECT IN PLACE.

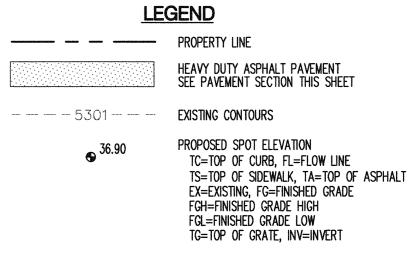

TG=TOP OF GRATE, INV=INVERT S=2.0% PROPOSED DIRECTION OF FLOW WATER BLOCK PROPOSED INTER CONTOURS PROPOSED STORM DRAIN PIPE

= ★ = = ★ = REMOVE & DISPOSE OF EXIST STORM DRAIN PIPE PROPOSED STORM DRAIN INLET PROPOSED STORM DRAIN MANHOLE

3" ASPHALT CONCRETE, SP-IV —→ SURFACE COURSE IN 1 LIFT 4" AGGREGATE — BASE COURSE 12" SUBGRADE PREPARATION —— @ 95% MAXIMUM DENSITY PER ASTM D-1557

HEAVY DUTY PAVEMENT SECTION NOT TO SCALE

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11/30/17 DATE 11-30-2017

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LEGEND


→ FL70.22 DESIGN GRADE ⊕ **5** FL70.22 FL69.24

Bohannan A Huston

DEKKER PERICH SABATINI

ARCHITECTURE / DESIGN / INSPIRATION

7601 JEFFERSON NE, SUITE 100 ALBUQUERQUE, NM 87109 505.761.9700 / DPSDESIGN.ORG

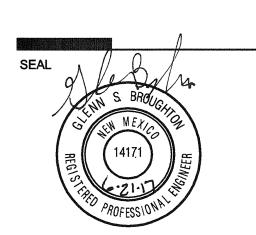

PROJECT

Sbyterian Administ ASE THREE - BI

CONSTRUCTION DOCUMENTS

REVISIONS

GSB **REVIEWED BY** 06/21/2016 DATE PROJECT NO 15-0129

DRAWING NAME **GRADING PLAN**

SHEET NO C-101



City of Albuquerque

Planning Department

Development & Building Services Division

DRAINAGE AND TRANSPORTATION INFORMATION SHEET (REV 09/2015)

Project Title:		Building Permit #:	City Drainage #:	
DRB#: EPC#:				
Legal Description:				
City Address:				
Engineering Firm:		Cont	act:	
Address:				
Phone#:	Fax#:	E-ma	ail:	
Owner:		Cont	act:	
Address:				
Phone#:	Fax#:		ail:	
Architect:		Cont	Contact:	
Address:				
Phone#: Fax#:		E-ma	ail:	
Other Contact:		Cont	act:	
Address:				
Phone#:	Fax#:		ail:	
Check all that Apply: DEPARTMENT: HYDROLOGY/ DRAINAGE			ROVAL/ACCEPTANCE SOUGHT:	
TRAFFIC/ TRANSPORTATION			BUILDING PERMIT APPROVAL	
MS4/ EROSION & SEDIMENT CO	NTROL	CERTIFICATE OF	OCCUPANCY	
TYPE OF SUBMITTAL:		PRELIMINARY PI	PRELIMINARY PLAT APPROVAL	
ENGINEER/ ARCHITECT CERTIFICATION		SITE PLAN FOR SUB'D APPROVAL		
		SITE PLAN FOR BLDG. PERMIT APPROVAL		
CONCEPTUAL G & D PLAN		FINAL PLAT APP	FINAL PLAT APPROVAL	
GRADING PLAN		SIA/ RELEASE OF	SIA/ RELEASE OF FINANCIAL GUARANTEE	
DRAINAGE MASTER PLAN		FOUNDATION PE	FOUNDATION PERMIT APPROVAL	
DRAINAGE REPORT		GRADING PERMI	GRADING PERMIT APPROVAL	
CLOMR/LOMR		SO-19 APPROVAL	SO-19 APPROVAL	
		PAVING PERMIT		
TRAFFIC CIRCULATION LAYOU	Γ (TCL)		APPROVAL	
TRAFFIC CIRCULATION LAYOUT TRAFFIC IMPACT STUDY (TIS)	Γ (TCL)	PAVING PERMIT	APPROVAL ERTIFICATION	
		PAVING PERMIT GRADING/ PAD C	APPROVAL ERTIFICATION	
TRAFFIC IMPACT STUDY (TIS)	L PLAN (ESC)	PAVING PERMIT GRADING/ PAD C WORK ORDER APP	APPROVAL ERTIFICATION ROVAL	
TRAFFIC IMPACT STUDY (TIS) EROSION & SEDIMENT CONTRO	L PLAN (ESC)	PAVING PERMIT GRADING/ PAD C WORK ORDER APP CLOMR/LOMR PRE-DESIGN MEET	APPROVAL ERTIFICATION ROVAL ING	
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COA STAFF: ELECTRONIC SUBMITTAL RECEIVED: ____