CITY OF ALBUQUERQUE



December 17, 2004

Mr. John McKenzie, P.E.

MARK GOODWIN & ASSOCIATES
P.O. Box 90606

Albuquerque, NM 87199

Re:

DAL-TILE

5601 Venice Ave. NE

Approval of Permanent Certificate of Occupancy (C.O.)

Approved Engineer's Stamp dated 05/14/2004 (H-17/D103)

Certification dated 12/17/2004

Dear John,

P.O. Box 1293

Based upon the information provided in your submittal received 12/17/2004, the above referenced certification is approved for release of Permanent Certificate of Occupancy by Hydrology.

Albuquerque

If you have any questions, you can contact me at 924-3982.

New Mexico 87103


Sincerely,


www.cabq.gov

Arlene V. Portillo
Plan Checker, Planning Dept. - Hydrology

Development and Building Services

C: Scott Davis, MGA
File

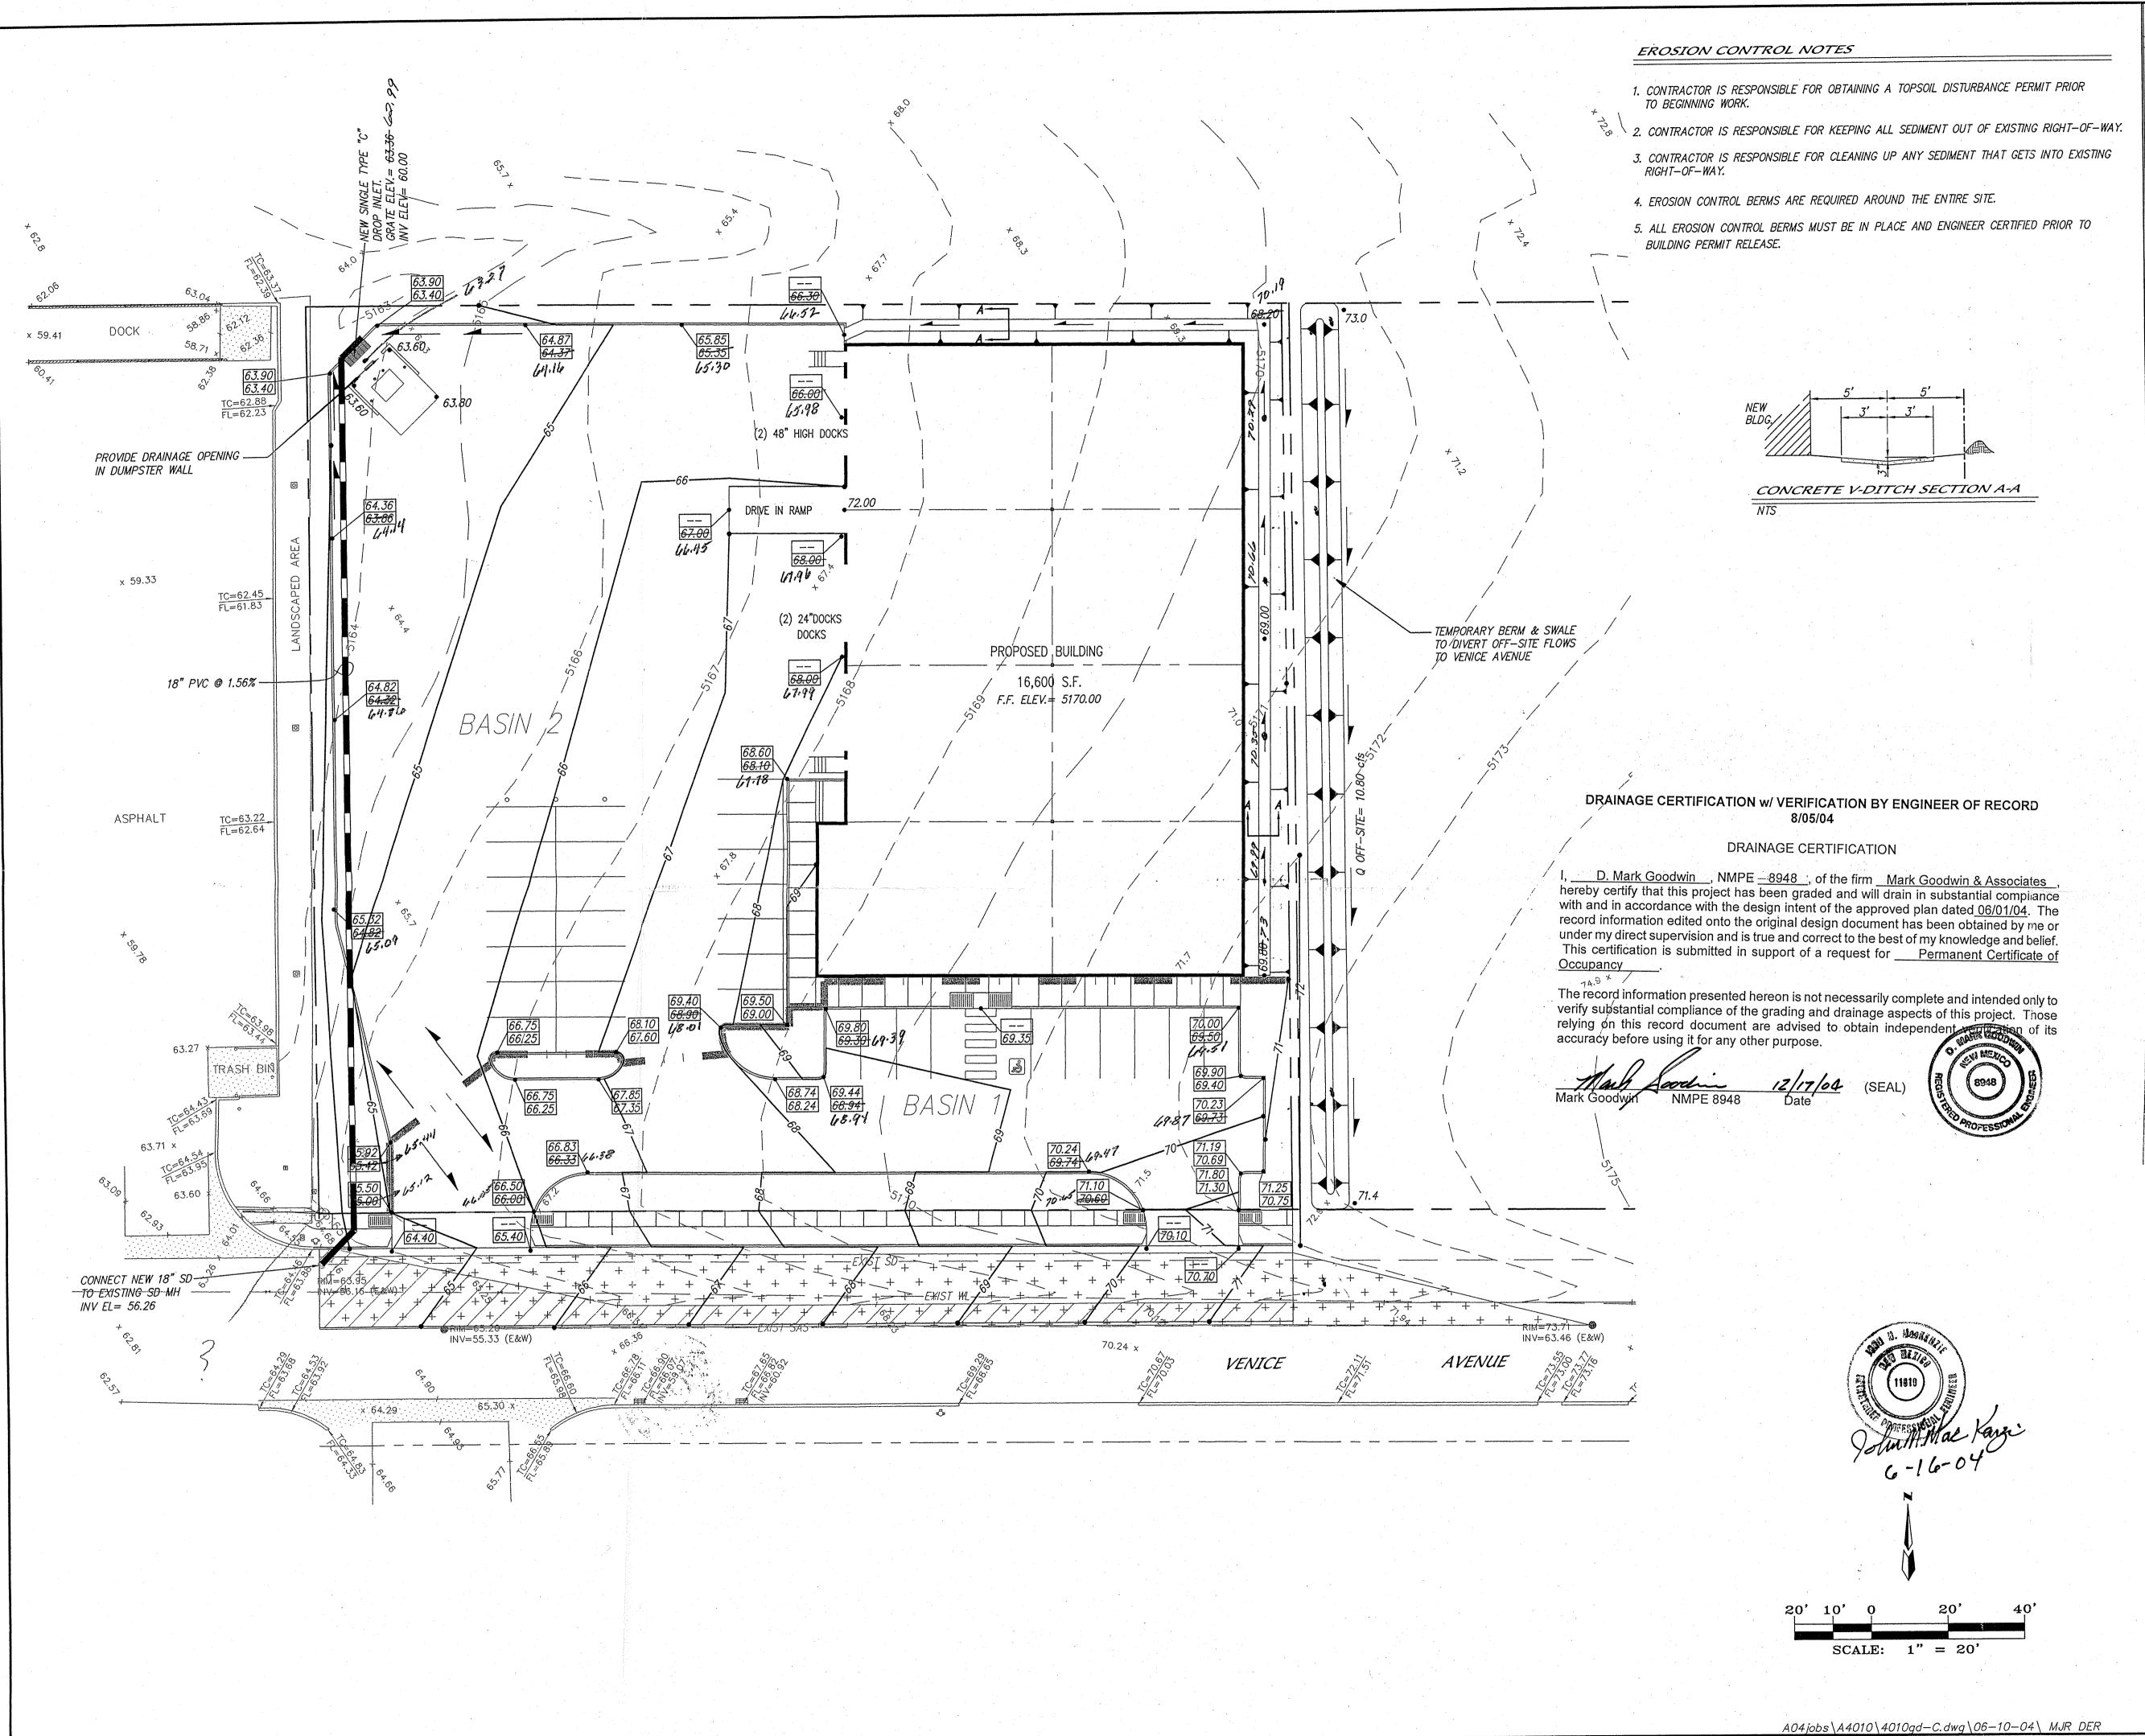

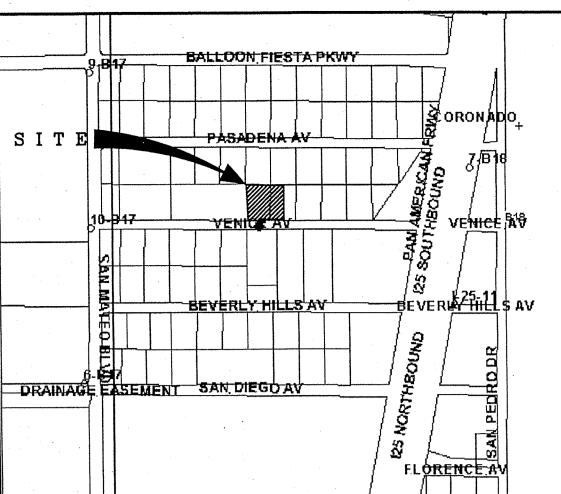

VICINITY MAP ZONE MAP: B-18-Z

ACS BENCHMARK

BENCHMARK IS A NMSHC BRASS CAP STAMPED "125-11", LOCATED NEAR THE SW CORNER OF THE CORONADO AIRFIELD ON THE EAST SIDE OF THE EAST FRONTAGE ROAD OF (I-25). GO NORTH ON THE EAST FRONTAGE ROAD FROM THE INTERSECTION OF SAN MATEO BLVD AND (I-25) 3.20 MILES TO THE STATION 29.5 FEET ON THE RIGHT. GEOGRAPHIC POSITION (NAD 1927), IN FEET N.M. STATE PLANE COORDINATES (CENTRAL ZONE) X=401,986.77, Y=1,526,246.66, ELEVATION=5206.936, NGVD29.

LEGAL DESCRIPTION

_____ 5170 ____ *EXISTING CONTOUR (MAJOR)*

NORTH ALBUQUERQUE ACRES, TRACT A, UNIT B, BLOCK 3, LOTS 24, 25 AND 26, SITUATE WITHIN THE ELENA GALLEGOS GRANT PROJECTED SECTION 13, TOWNSHIP 11 NORTH, RANGE 3 EAST, N.M.P.M., CITY OF ALBUQUERQUE, BERNALILLO COUNTY, NEW MEXICO.

LEGEND

	EXISTING CONTOUR (MINOR)
TC= FL=	EXISTING TOP OF CURB FLOWLINE
x 00.00	EXISTING SPOT ELEVATION
	EXISTING CONCRETE CURB
	EXISTING CONCRETE/SIDEWALK
exaceración	EXISTING WALL OR HEAD WALL
•	EXISTING BOLLARD
	EXISTING SANITARY SEWER MANHOLE
M	EXISTING WATER VALVE
Ф	EXISTING FIRE HYDRANT
Ø	EXISYING WATER METER
	EXISTING SPRINKLER CONTROL
Ō	EXISTING LOT LIGHT
Ø	EXISTING TELEPHONE PEDESTAL
©	EXISTING STORM SEWER MANHOLE
	EXISTING DROP INLET
	PROPOSED DROP INLET
70.00 69.50	PROPSED TOP OF CURB ELEVATION PROPSED FLOWLINE ELEVATION
70.00 •	PROPOSED SPOT ELEVATION
€ 68	PROPOSED SPOT ELEVATION
	PROPOSED 3:1 SLOPE

DALTILE

GRADING & DRAINAGE PLAN

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MARK GOODWIN & ASSOCIATES, P.A. CONSULTING ENGINEERS

P.O. BOX 90606 ALBUQUERQUE, NEW MEXICO 87199 (505)828-2200, FAX (505)797-9539

Designed: SD Drawn: MJR Checked: DMG Sheet \boldsymbol{Z} of \boldsymbol{Z} Scale: 1'' = 20' Date: 3/02/04 Job: A04010