
CITY OF ALBUQUERQUE

Planning Department Alan Varela, Director

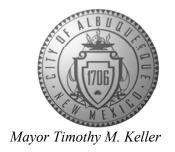

October 13, 2023

Ron Hensley, P.E. THE Group 300 Branding Iron Rd. SE Rio Rancho, NM 87124

RE: Tierra Buena Townhomes

Revised Grading and Drainage Plans Engineer's Stamp Date: 10/03/23

Hydrology File: C11D002

Dear Mr. Hensley:

PO Box 1293

Based upon the information provided in your submittal received 10/06/2023, the Revised Grading & Drainage Plans are approved for Building Permit, Grading Permit and for action by the Development Facilitation Team (DFT) on Site Plan for Building Permit. Please attach a copy of this approved plan in the construction sets for Building Permit processing along with a copy of this letter.

Albuquerque

PRIOR TO CERTIFICATE OF OCCUPANCY:

NM 87103

1. Engineer's Certification, per the DPM Part 6-14 (F): *Engineer's Certification Checklist For Non-Subdivision* is required.

www.cabq.gov

2. Please provide the executed paper Drainage Covenant (latest revision) printed on one-side only with Exhibit A and a check for \$25.00 made out to "Bernalillo County" for the stormwater quality ponds per Article 6-15(C) of the DPM to Hydrology for review at Plaza de Sol.

As a reminder, if the project total area of disturbance (including the staging area and any work within the adjacent Right-of-Way) is 1 acre or more, then an Erosion and Sediment Control (ESC) Plan and Owner's certified Notice of Intent (NOI) is required to be submitted to the Stormwater Quality Engineer (Doug Hughes, PE, jhughes@cabq.gov, 924-3420) 14 days prior to any earth disturbance.

CITY OF ALBUQUERQUE

Planning Department Alan Varela, Director



If you have any questions, please contact me at 924-3995 or rbrissette@cabq.gov .

Renée C. Brissette
Renée C. Brissette

Senior Engineer, Hydrology Planning Department

PO Box 1293

Albuquerque

NM 87103

www.cabq.gov




City of Albuquerque

Planning Department
Development & Building Services Division

DRAINAGE AND TRANSPORTATION INFORMATION SHEET (DTIS)


Project Title: MX at Petroglyphs (Tierra Buena Townhomes	Hydrology File # C11D002
Legal Description: LOT 1 VOLCANO CLIFFS SUBDIVISION UNIT 26	
City Address, UPC, OR Parcel: 99999 ROSA PARKS ROAD N.W., UPC 101106410411830201	
Applicant/Agent: THE Group	Contact: Ron Hensley
Address: 300 Branding Iron Rd. SE, Rio Rancho, NM 87124	Phone: 505-410-1622
Email: ron@thegroup.cc	
A 1' A/O RETA INVESTMENTS LLC	Contact CK Scott
Applicant/Owner: BETA INVESTMENTS, LLC Address: P.O. BOX 65808, Albuquerque	Contact: C.K. Scott Phone: 505-350-7534
Email: ck@abrazohomes.com	I none.
(Please note that a DFT SITE is one that needs Site Plan Approval & ADMIN SITE is one that does not need it.)	
TYPE OF DEVELOPMENT: PLAT (#of lots)	RESIDENCE
✓ DFT SITE	ADMIN SITE
RE-SUBMITTAL: ✓ YES NO	
DEPARTMENT: TRANSPORTATION HYDROLOGY/DRAINAGE	
TRANSFORTATION INTERPRETATION INTERP	
Check all that apply under Both the Type of Submittal and the Type of Approval Sought:	
TYPE OF SUBMITTAL:	TYPE OF APPROVAL SOUGHT:
ENGINEER/ARCHITECT CERTIFICATION	BUILDING PERMIT APPROVAL
PAD CERTIFICATION	CERTIFICATE OF OCCUPANCY
CONCEPTUAL G&D PLAN	CONCEPTUAL TCL DFT APPROVAL
GRADING & DRAINAGE PLAN	PRELIMINARY PLAT APPROVAL
DRAINAGE REPORT	FINAL PLAT APPROVAL
DRAINAGE MASTER PLAN	SITE PLAN FOR BLDG PERMIT DFT
CLOMR/LOMR	APPROVAL
TRAFFIC CIRCULATION LAYOUT (TCL)	SIA/RELEASE OF FINANCIAL GUARANTEE
ADMINISTRATIVE	FOUNDATION PERMIT APPROVAL
TRAFFIC CIRCULATION LAYOUT FOR DFT APPROVAL	✓ GRADING PERMIT APPROVAL
TRAFFIC IMPACT STUDY (TIS)	SO-19 APPROVAL
` ′	PAVING PERMIT APPROVAL
STREET LIGHT LAYOUT	GRADING PAD CERTIFICATION
OTHER (SPECIFY)	WORK ORDER APPROVAL
	CLOMR/LOMR
	OTHER (SPECIFY)
DATE SUBMITTED: 10/03/23	

REV. 09/13/23

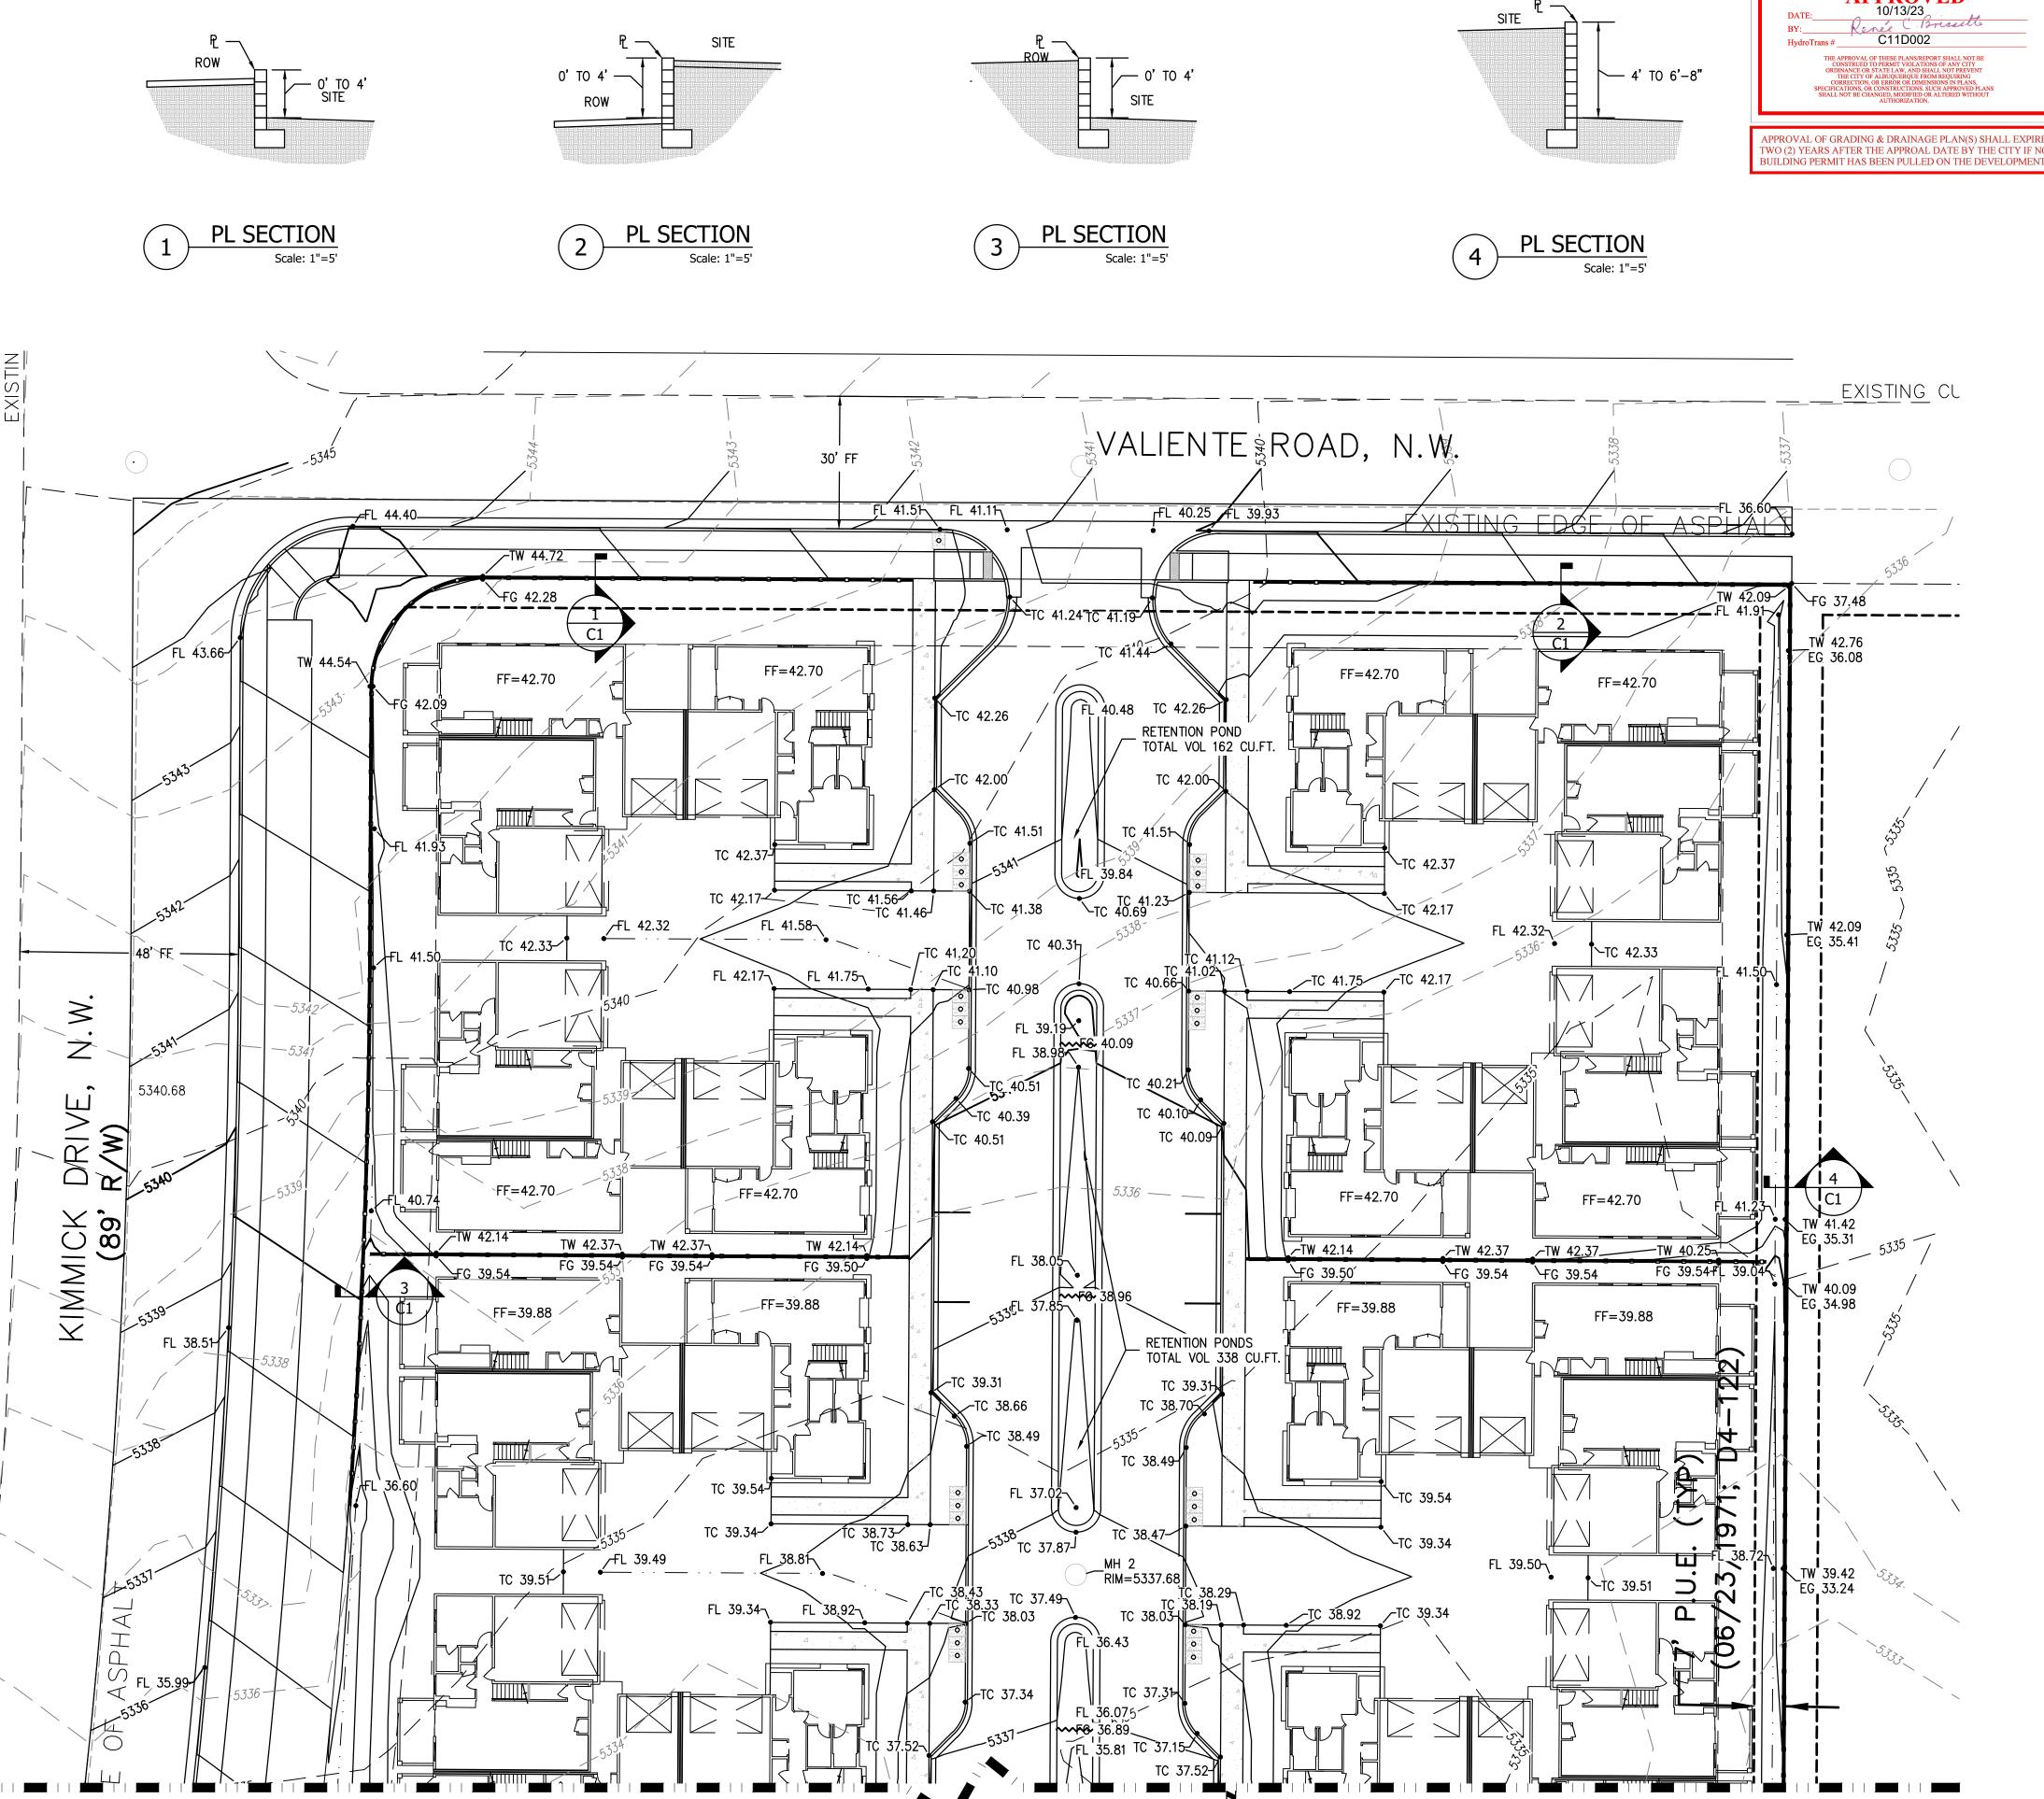

SCALE: 1" = 20'

MATCH LINE SEE SHEET C2

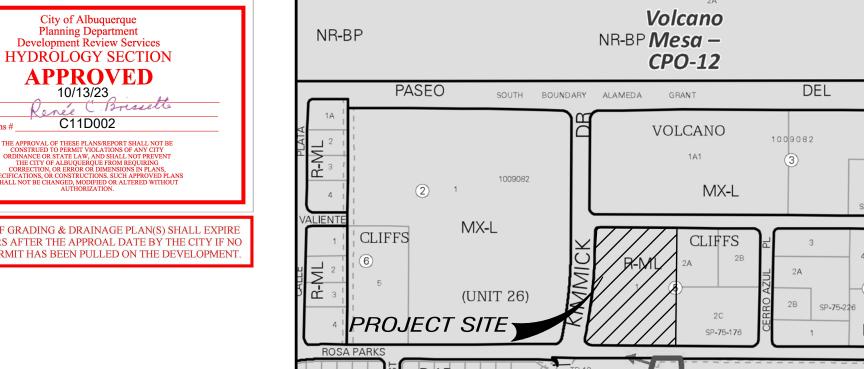

VICINITY MAP C-11-Z

NOT THE EN

THE ENGINEER HAS UNDERTAKEN LIMITED FIELD VERIFICATION OF THE LOCATION, DEPTH, SIZE, OR TYPE OF EXISTING UNDERGROUND UTILITY LINES, MAKES NO REPRESENTATION PERTAINING THERETO AND ASSUMES NO RESPONSIBILITY OR LIABILITY THEREFORE. THE CONTRACTOR SHALL INFORM ITSELF OF THE LOCATION OF ANY UTILITY LINE IN OR NEAR THE AREA OF THE WORK IN ADVANCE OF AND DURING EXCAVATION WORK. THE CONTRACTOR IS FULLY RESPONSIBLE FOR ANY AND ALL DAMAGE CAUSED BY ITS FAILURE TO LOCATE, IDENTIFY, AND PRESERVE ANY AND ALL EXISTING UTILITIES. THE CONTRACTOR SHALL COMPLY WITH STATE STATUTES, MUNICIPAL AND LOCAL ORDINANCES, RULES AND REGULATIONS PERTAINING TO THE LOCATION OF THESE LINES AND FACILITIES IN PLANNING AND CONDUCTING EXCAVATION, WHETHER BY CALLING OR NOTIFYING THE UTILITIES, COMPLYING WITH "BLUE STAKES" PROCEDURES, OR OTHERWISE.

THESE DRAWINGS DO NOT INCLUDE NECESSARY COMPONENTS FOR CONSTRUCTION SAFETY WHICH SHALL REMAIN THE RESPONSIBILITY OF THE CONTRACTOR.

THIS DOCUMENT, AND THE IDEAS AND DESIGNS INCORPORATED HEREIN, ARE INTENDED FOR USE ON THIS PROJECT AND IS NOT TO BE USED, IN WHOLE OR IN PART, FOR ANY OTHER PROJECT WITHOUT THE WRITTEN AUTHORIZATION OF THE GROUP. IN THE EVENT OF UNAUTHORIZED USE, THE USER ASSUMES ALL RESPONSIBILITY AND LIABILITY WHICH RESULTS.

GENERAL NOTES:

1. ALL WORK DETAILED ON THESE PLANS TO BE PERFORMED UNDER THIS CONTRACT SHALL, EXCEPT AS OTHERWISE STATED OR PROVIDED HEREIN, BE CONSTRUCTED IN ACCORDANCE WITH THE CITY OF ALBUQUERQUE STANDARD SPECIFICATIONS FOR PUBLIC WORKS CONSTRUCTION, 2020 EDITION.

2. THE EROSION PROTECTION SPECIFIED ON THIS PLAN IS THE MINIMUM RECOMMENDED. THE OWNER IS ENCOURAGED TO INCORPORATE EROSION RESISTANT LANDSCAPING ON AREAS WHERE EROSION MAY OCCUR SUCH AS SLOPES AND SWALES. THE OWNER IS RESPONSIBLE FOR THE INSTALLATION AND MAINTENANCE OF ALL EROSION CONTROL FEATURES NECESSARY TO PRESERVE THE DESIGN INTENT OF THE GRADING PLAN.

3. THE DRAINAGE INFRASTRUCTURE SHOWN ON THIS PLAN IS THE RESPONSIBILITY OF THE PROPERTY OWNER.

4. ALL DISTURBED AREAS OUTSIDE THE BUILDING ENVELOPE MUST BE RESEED IN ACCORDANCE WITH THE SEED MIX INDICATED IN THE OXBOW GUIDELINES.

5. TWO (2) WORKING DAYS PRIOR TO ANY EXCAVATION, CONTRACTOR MUST CONTACT LINE LOCATING SERVICE, (260–1990) FOR LOCATION OF EXISTING UTILITIES.

6. PRIOR TO CONSTRUCTION, THE CONTRACTOR SHALL EXCAVATE AND VERIFY THE HORIZONTAL AND VERTICAL LOCATIONS OF ALL OBSTRUCTIONS AND EXISTING PAVEMENT. SHOULD A CONFLICT EXIST, THE CONTRACTOR SHALL NOTIFY THE ENGINEER OR SURVEYOR SO THAT THE CONFLICT CAN BE RESOLVED WITH A MINIMUM OF DELAY.

EROSION CONTROL NOTES

- 1. CONTRACTOR IS RESPONSIBLE FOR OBTAINING A TOPSOIL DISTURBANCE PERMIT PRIOR TO BEGINNING WORK.
- 2. CONTRACTOR IS RESPONSIBLE FOR MAINTAINING RUN-OFF ON SITE DURING CONSTRUCTION
- DURING CONSTRUCTION.

 3. CONTRACTOR IS RESPONSIBLE FOR CLEANING ALL SEDIMENT THAT
- GETS INTO EXISTING RIGHT-OF-WAY.

 4. REPAIR OF DAMAGED FACILITIES AND CLEANUP OF SEDIMENT
- ACCUMULATIONS ON ADJACENT PROPERTIES AND IN PUBLIC
- FACILITIES IS THE RESPONSIBILITY OF THE CONTRACTOR.

 5. ALL EXPOSED EARTH SURFACES MUST BE PROTECTED FROM WIND AND WATER EROSION PRIOR TO FINAL (CITY) ACCEPTANCE OF ANY

LEGEND

FLOW ARROW

SLOPE ARROW

PROJECT.

EL=11.28 PROPOSED ELEVATION

* 66.33 EXISTING ELEVATION

DMC

— 5000 — PROPOSED CONTOUR

— 5000 — EXISTING CONTOUR

PROPOSED EASEMENT
EXISTING WALL
PROPOSED WALL
SWALE / FLOW LINE

THE HENSLEY ENGINEERING GROUP 300 BRANDING IRON RD. SE

RIO RANCHO, NEW MEXICO 87124 Phone:(505) 410-1622

DEVELOPMENT MANAGEMENT CONSULTANTS

PROFESSIONAL CONSTRUCTION MANAGERS & CONSTULTING ENGINEERS

9320 Menaul Blvd. NE, ste. D

Albuquerque, NM 87112

Office: (505) 296-7100 Fax: (505) 296-7105

ALBUQUERQUE

LA CUENTIS

GRADING PLAN

-PROJECT NAME.

THE MX AT PETROGLYPH ESTATES

-PROJECT NUMBER-PROJECT PROGRESSSITE PLAN
-DRAWN BYREH

REH
CHECKED BY- / -APPROVED BYREH / REH
-DATEJULY 13, 22

JULY 13, 22

-SCALEAS NOTED
-SHEET-

C1

