CITY OF ALBUQUERQ



Richard J. Berry, Mayor

April 24, 2017

David Soule, P.E. **Rio Grande Engineering** P.O. Box 93924 Albuquerque, NM, 87199

Starbucks at Peroglyph Plaza RE: **Grading Plan** Stamp Date: 4/14/17 Hydrology File: C12D001G4

Dear Mr. Soule:

Based upon the information provided in your submittal received 4/18/2017, the Grading PO Box 1293 Plan is not approved for Building Permit. The following comments need to be addressed for approval of the above referenced project:

Albuquerque

www.cabq.gov

1. Please provide the benchmark information for the survey contour information provided.

2. After reviewing the proposed grades for the first flush pond and the existing New Mexico 87103 contours nearby, it appear the northern top of pond contour is 5109 but the southern top of pond contour appears to be 5108. Both of these contours should be regraded to the existing corresponding contour line. The proposed pond has a bottom at 5107.65 with 3:1 slope. The drawn pond appears to have a height of 1 foot, therefore the top of the pond appears to be 5108.65. Please verify the proposed pond's shape and volume. Also tie any proposed contour lines to the existing ones around the pond.

If you have any questions, please contact me at 924-3995 or rbrissette@cabq.gov.

Sincerely,

Rence C. Brissett

Reneé C. Brissette, P.E. Senior Engineer, Hydrology **Planning Department**




City of Albuquerque

Planning Department Development & Building Services Division DRAINAGE AND TRANSPORTATION INFORMATION SHEET (REV 09/2015)

Project Title:	Building Permit #:	City Drainage #:			
DRB#: EPC#:		Work Order#:			
Legal Description:					
City Address:					
Engineering Firm:		Contact:			
Address:					
Phone#: Fax#:		E-mail:			
Owner:		Contact:			
Address:					
Phone#: Fax#:		_ E-mail:			
Architect:		Contact:			
Address:					
Phone#: Fax#:		E-mail:			
Other Contact:		Contact:			
Address:					
Phone#: Fax#:		E-mail:			
TRAFFIC/ TRANSPORTATION MS4/ EROSION & SEDIMENT CONTROL		ERMIT APPROVAL TE OF OCCUPANCY			
TYPE OF SUBMITTAL:					
ENGINEER/ ARCHITECT CERTIFICATION		RY PLAT APPROVAL FOR SUB'D APPROVAL			
		FOR BLDG. PERMIT APPROVAL			
CONCEPTUAL G & D PLAN	FINAL PLAT				
GRADING PLAN		SE OF FINANCIAL GUARANTEE			
DRAINAGE MASTER PLAN	FOUNDATIO	ON PERMIT APPROVAL			
DRAINAGE REPORT	GRADING P	GRADING PERMIT APPROVAL			
CLOMR/LOMR	SO-19 APPR	SO-19 APPROVAL			
TRAFFIC CIRCUITATION LAVOUT (TOL)		RMIT APPROVAL			
TRAFFIC CIRCULATION LAYOUT (TCL) TRAFFIC IMPACT STUDY (TIS)		PAD CERTIFICATION			
EROSION & SEDIMENT CONTROL PLAN (ESC)		WORK ORDER APPROVAL			
	CLOMR/LON	/IK			
OTHER (SPECIFY)	PRE-DESIGN	MEETING			
	OTHER (SPE	ECIFY)			
IS THIS A RESUBMITTAL?: Yes No					
DATE SUBMITTED:By: _					

COA STAFF: ELECTRONIC SUBMITTAL RECEIVED: ____

	-										100-Year, 6-h	ır.	
Basin	Area	Area	Treatment		Treatmen		Treatm		Treatme	-	Weighted E	Volume	Flow
EVIOTINO	(sf)	(acres)	%	(acres)	%	(acres)	%	(acres)	%	(acres)	(ac-ft)	(ac-ft)	cfs
EXISTING PROPOSED	14166 14166	0.325	0% 0%	0	0.0% 6.0%			0.04878		0.276	1.823 1.745	0.049	1.35 1.30
uations:													
eighted E = Ea*Aa + Eb*A olume = Weighted D * Tota		J*Ad / (Total	Area)					FIRST FL	USH	317.0823			
0	Area	,	Area)					FIRST FL	USH	317.0823			
blume = Weighted D * Tota ow = Qa * Aa + Qb * Ab +	l Area Qc * Ac + Qd *	,	Area)					FIRST FL	USH	317.0823			
blume = Weighted D * Tota	l Area Qc * Ac + Qd * torm (zone 1)	,	Area)	Qa=	1.29			FIRST FL	USH	317.0823			
blume = Weighted D * Tota ow = Qa * Aa + Qb * Ab +	l Area Qc * Ac + Qd * torm (zone 1) Ea=	Ad	Area)	Qa= Qb=				FIRST FL	USH	317.0823			
blume = Weighted D * Tota ow = Qa * Aa + Qb * Ab +	I Area Qc * Ac + Qd * torm (zone 1) Ea= Eb= Ec=	Ad 0.44	Area)		2.03 2.87			FIRST FL	USH	317.0823			

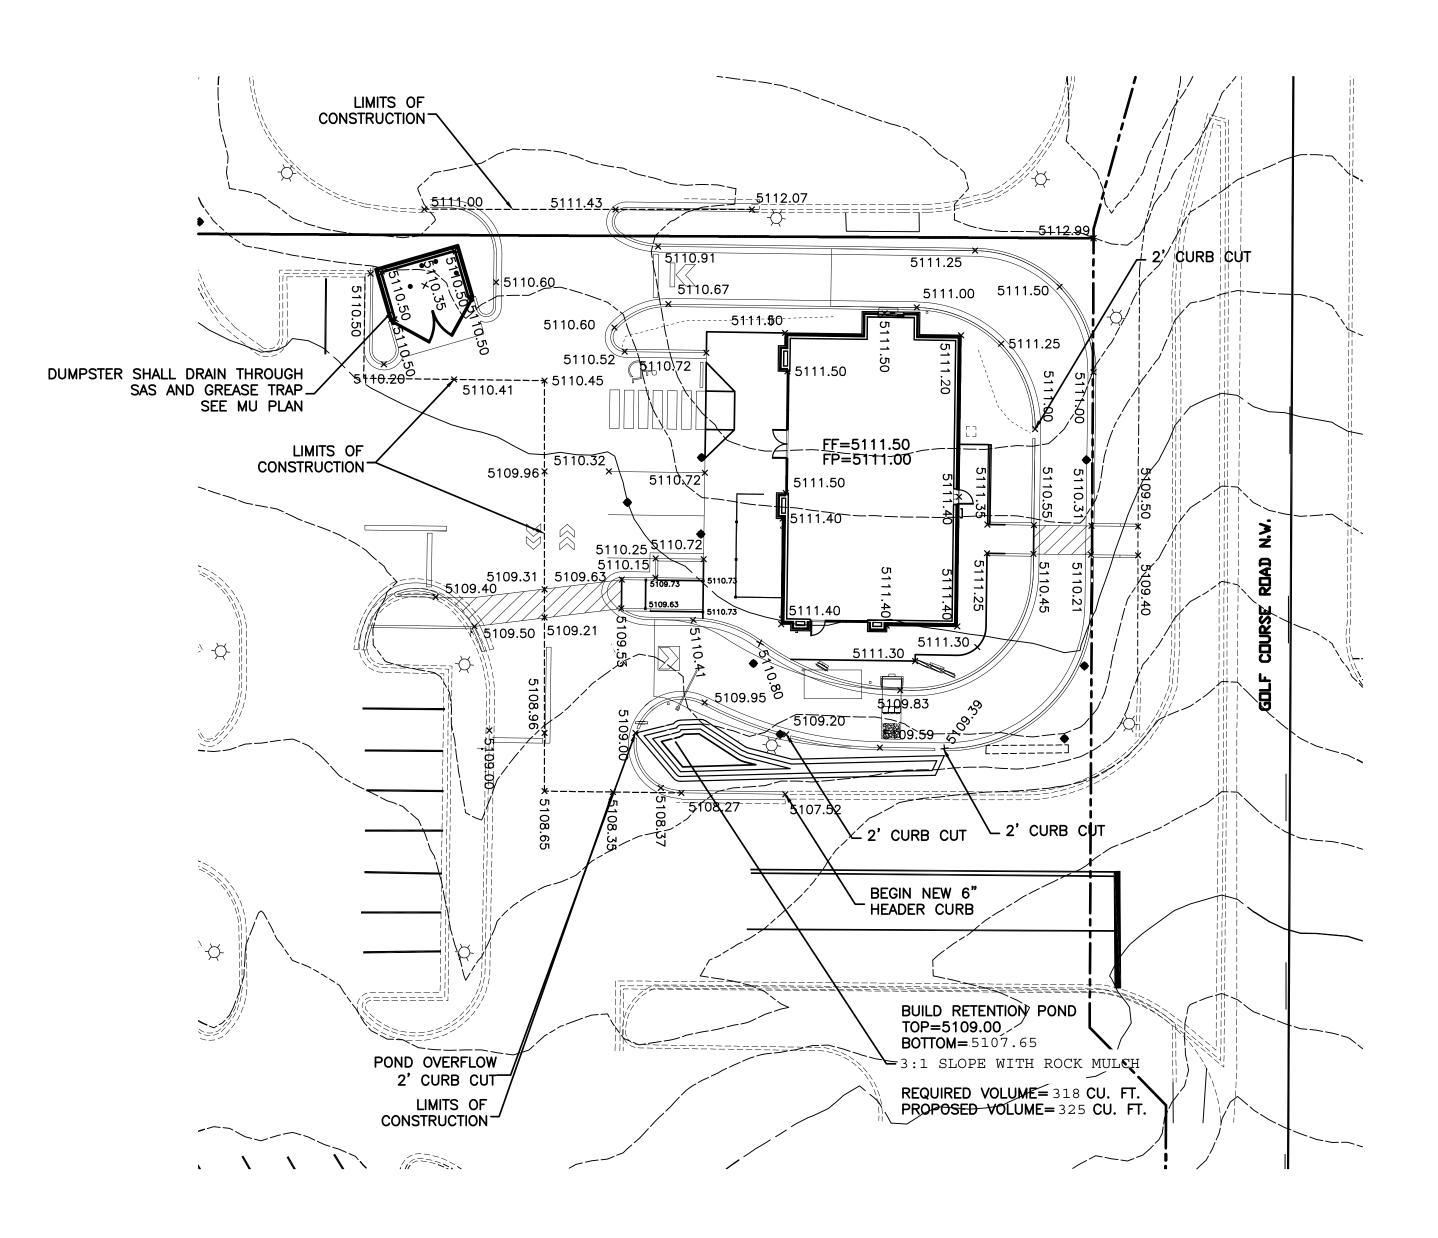

CAUTION: EXISTING UTILITIES ARE NOT SHOWN. IT SHALL BE THE SOLE RESPONSIBILITY OF THE CONTRACTOR TO CONDUCT ALL NECESSARY FIELD INVESTIGATIONS PRIOR TO ANY EXCAVATION TO DETERMINE THE ACTUAL LOCATION OF UTILITIES & OTHER IMPROVEMENTS.

EROSION CONTROL NOTES:

1. CONTRACTOR IS RESPONSIBLE FOR OBTAINING A TOPSOIL DISTURBANCE PERMIT PRIOR TO BEGINNING WORK.


2. CONTRACTOR IS RESPONSIBLE FOR MAINTAINING RUN-OFF ON SITE DURING CONSTRUCTION.

3. CONTRACTOR IS RESPONSIBLE FOR CLEANING ALL SEDIMENT THAT GETS INTO EXISTING RIGHT-OF-WAY.

4. REPAIR OF DAMAGED FACILITIES AND CLEANUP OF SEDIMENT ACCUMULATIONS ON ADJACENT PROPERTIES AND IN PUBLIC FACILITIES IS THE RESPONSIBILITY OF THE CONTRACTOR.

5. ALL EXPOSED EARTH SURFACES MUST BE PROTECTED FROM WIND AND WATER EROSION PRIOR TO FINAL ACCEPTANCE OF ANY PROJECT.

	• 	BOUNDARY CENTERLINE RIGHT-OF-W	/AΥ	
47			RB AND GUTTER SIDEWALK	
	ENGINEER'S SEAL	STARBUCKS		DRAWN BY _{WCWJ} DATE
	CAVID SOUTH	GRADING DRAINAGE		4—14—17 21719-layout-3-16-17
GRAPHIC SCALE 20 10 0 10 20	RE (14522) E		Rio Grande Engineering	SHEET #
SCALE: 1"=20'	DAVID SOULE P.E. #14522		1606 CENTRAL AVENUE SE SUITE 201 ALBUQUERQUE, NM 87106 (505) 872–0999	JOB # 21719

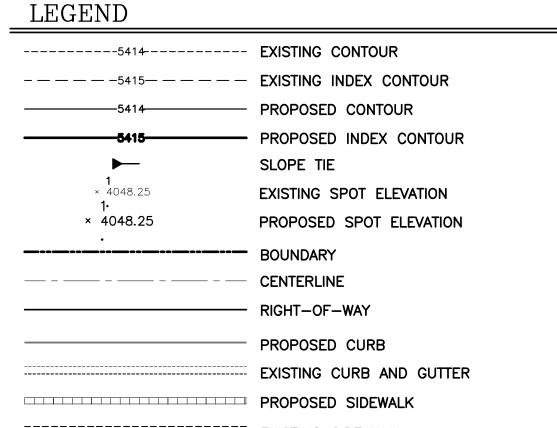

6. ALL SITE WORK SHALL CONFORM TO CITY OF ALBUQUERQUE STANDARDS FOR PUBLIC WORKS CONSTRUCTION EDITION 9

5. ANY CURBS OR PAVEMENT NEGATIVELY IMPACTED BY CONSTRUCTION ACTIVITY SHALL BE REPLACED TO MATCH EXISTING CONDITIONS.

4. ALL NEW PAVING SHALL BE 6" PCC OVER 8" SUBGRADE PREPARATION IN CONFORMANCE TO ACI 330R-08. UNLESS OTHERWISE NOTED.

3. ALL RETAINING WALL DESIGN SHALL BE BY OTHERS.

2. ALL CURB AND GUTTER TO 6" HEADER UNLESS OTHERWISE NOTED.

1. ALL SPOT ELEVATIONS REPRESENT FLOWLINE ELEVATION UNLESS OTHERWISE NOTED.

NOTES:

LEGAL DESCRIPTION: A PORTION OF TRACT H91, RIVERVIEW SUBDIVISION

