




SILT FENCE INLET PROTECTION NOT TO SCALE (OPTIONAL)

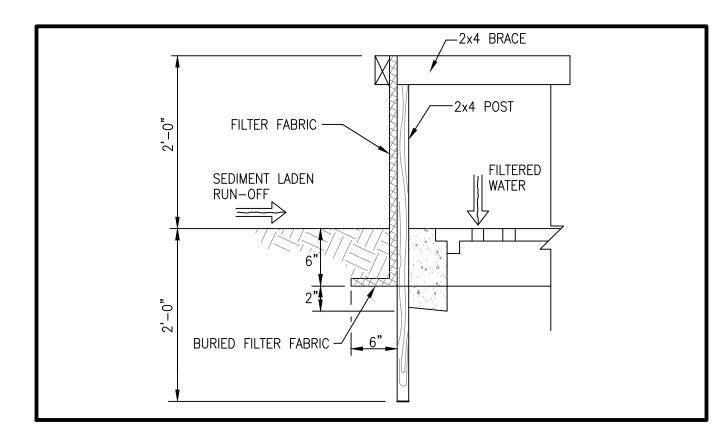


SILT FENCE INLET PROTECTION SECTION NOT TO SCALE (OPTIONAL)

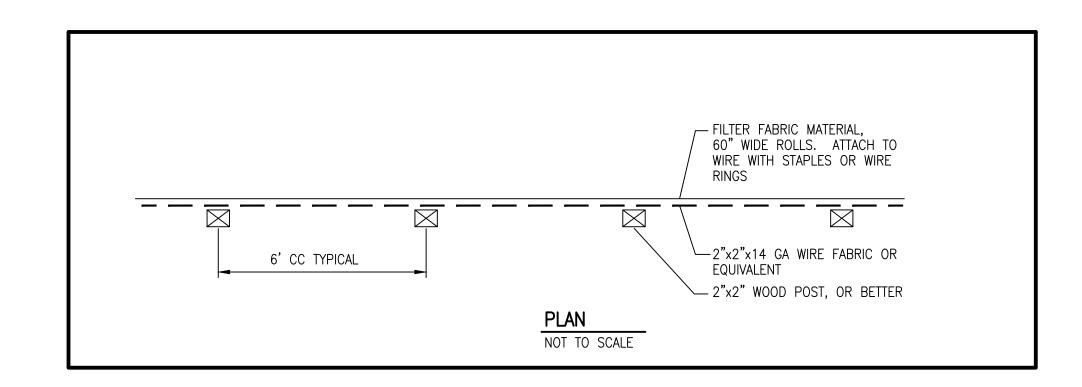

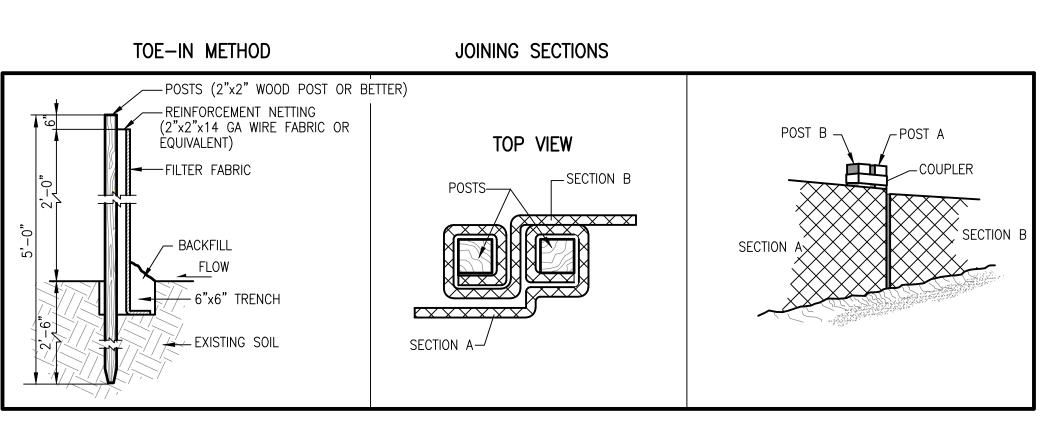

PREFABRICATED SILT FENCE DETAILS

NOT TO SCALE

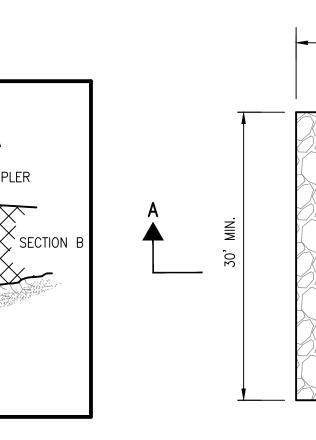

WOOD STAKE AT 8' O.C.

SCALE: 1" = 1'-0"

(OPTIONAL)


CHAINLINK

FENCE —

CONSTRUCTION

TYPICAL STRAW WADDLE INSTALLATION SECTION

-8" TO 20" DIAMETER STRAW WADDLE

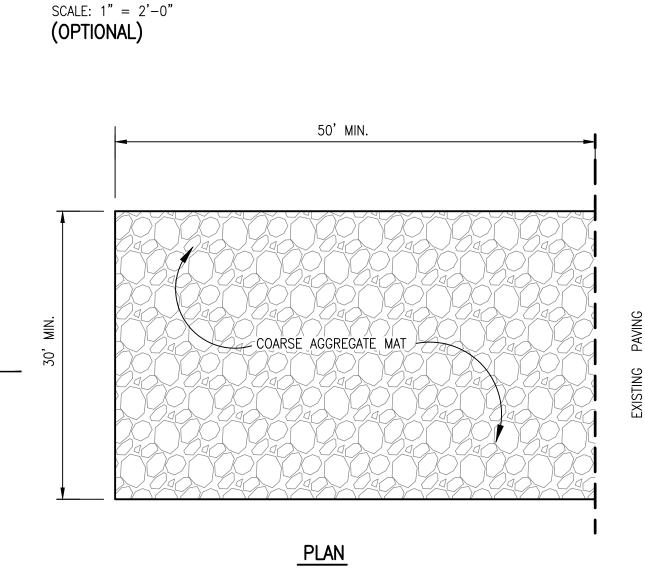

— FASTEN FABRIC


TO CHAINLINK

SILT FENCE

FILTER FABRIC

- BURIED FILTER FABRIC

CONSTRUCTION FENCE/SILT FENCE SECTION

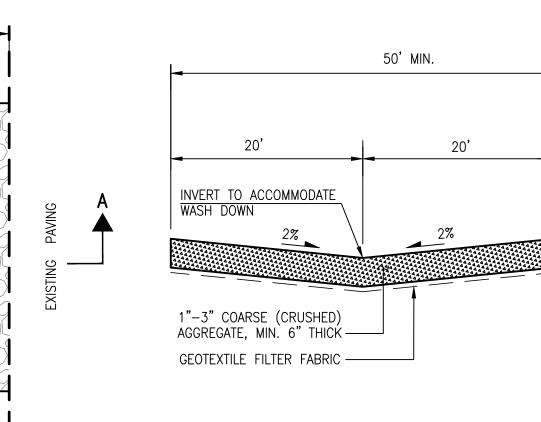

SECTION A-A CONSTRUCTION ENTRANCE STABILIZATION SCALE: 1" = 10'-0" HORIZ. 1" = 2'-0" VERT.

HIGH MESA Consulting Group

. — — — —

6010-B Midway Park Blvd. NE • Albuquerque, New Mexico 87109 Phone: 505.345.4250 • Fax: 505.345.4254 • www.highmesacg.com

DEKKER PERICH

ARCHITECTURE DESIGN **INSPIRATION**

ENGINEER

11-28-2022

SEDONA EAGLE RANC ALBUQUERQUE

PROJECT

7. THE CONTRACTOR SHALL PROMPTLY CLEAN-UP ANY MATERIAL EXCAVATED WITHIN THE PUBLIC RIGHT-OF-WAY SO THAT THE EXCAVATED

MATERIAL IS NOT SUSCEPTIBLE TO BEING WASHED DOWN THE STREET. 8. THE CONTRACTOR SHALL CLEAN AND REMOVE ALL FUGITIVE DUST, SOIL AND DEBRIS RESULTING FROM THIS PROJECT FROM THE ADJACENT

INTENDED TO COMPLEMENT THE PROJECT SPECIFIC STORM WATER POLLUTION AND PREVENTION PLAN (SWPPP) PREPARED FOR THIS PROJECT.

4. REFER TO THE ESC PLAN PREPARED BY HIGH MESA CONSULTING GROUP, DATED 11-2022 FOR PROJECT SPECIFIC PHASING AND INFORMATION.

STREETS AT THE END OF EACH DAY. 9. THE CONTRACTOR SHALL IMPLEMENT AND MAINTAIN ALL GOOD HOUSEKEEPING MEASURES OUTLINED IN THE SWPPP INCLUDING, BUT NOT

1. THIS PLAN ADDRESSES GENERAL AND SPECIFIC MEASURES FOR CONSTRUCTION PHASE EROSION, SEDIMENT AND DUST CONTROL. IT IS

THIS PROJECT SHALL BE IMPLEMENTED IN PHASES TO MINIMIZE THE EXTENT AND DURATION OF SURFACE DISTURBANCE.

6. THE CONTRACTOR SHALL ENSURE THAT NO SOIL ERODES FROM THE SITE INTO PUBLIC RIGHT-OF-WAY OR PRIVATE PROPERTY.

5. REFER TO THE GRADING AND DRAINAGE PLAN PREPARED BY HIGH MESA CONSULTING GROUP, DATED 10-19-2022.

LIMITED TO, DAILY PICKING UP TRASH, LITTER AND CONSTRUCTION DEBRIS.

10. THE CONTRACTOR SHALL PROMPTLY REMOVE SEDIMENT ACCUMULATION FROM SILT FENCES AND OTHER STRUCTURAL BMPS WITHIN 48 HOURS

11. THE CONTRACTOR SHALL IMPLEMENT ONSITE STRUCTURAL EROSION CONTROL MEASURES AS REQUIRED TO COMPLY WITH THE EROSION AND SEDIMENT CONTROL PLAN AND SWPPP. THESE MEASURES MAY INCLUDE BUT ARE NOT LIMITED TO SILT FENCES, EARTHEN DIKES, DRAINAGE DIVERSIONS, SEDIMENT TRAPS, CHECK DAMS, SUBSURFACE DRAINS, PIPE SLOPE DRAINS, LEVEL SPREADERS, STORM WATER RETENTION SYSTEMS, GABIONS AND TEMPORARY OR PERMANENT SEDIMENT DETENTION BASINS. THE FOLLOWING MEASURES ARE PROPOSED FOR THIS

a. PERIMETER SILT FENCE

EROSION AND SEDIMENT CONTROL PLAN NOTES:

b. ON-SITE SILT FENCE

WADDLES (OPTIONAL) 12. THE CONTRACTÒR SHALL MINIMIZE OFFSITE VEHICLE TRACKING OF SEDIMENT AND DUST GENERATION.

2. THE CONTRACTOR SHALL SECURE ALL REQUIRED PERMITS BEFORE BEGINNING CONSTRUCTION.

3. THE CONTRACTOR SHALL INSTALL ALL PERIMETER BMPS BEFORE BEGINNING CONSTRUCTION.

13. CONCRETE TRUCKS SHALL BE SENT BACK TO THE PLANT FOR WASHING; THE WASHING OF CONCRETE TRUCKS SHALL NOT BE PERMITTED ON THIS SITE UNLESS OTHERWISE PROVIDED FOR BY THIS PLAN. IF PROVIDED FOR BY THIS PLAN, CONCRETE TRUCKS MAY ONLY WASH OUT IN A DESIGNATED AND LINED WASHOUT FACILITY. 14. OFFSITE MATERIAL STORAGE AREAS USED BY THIS PROJECT ARE CONSIDERED PART OF THE PROJECT AND THEREFORE SUBJECT TO THE

~ WATERBLOCK

REQUIREMENTS OF THE EROSION AND SEDIMENT CONTROL PLAN AND SWPPP. 15. UPON COMPLETION OF MASS GRADING, ALL DISTURBED AREAS SHALL BE STABILIZED WITH PERMANENT CONSTRUCTION, LANDSCAPING,

VEGETATION AND/OR GRAVEL MULCH. SILT FENCING CAN BE REMOVED UPON SUCCESSFUL ESTABLISHMENT OF VEGETATION.

16. THROUGHOUT THE DURATION OF THIS PROJECT, CONTRACTOR SHALL IMPLEMENT, MAINTAIN AND INSPECT ALL BMPS, KEEPING RECORDS OF EACH INSPECTION IN ACCORDANCE WITH THE SWPPP, AND KEEP RECORDS OF THE INSTALLATION MAINTENANCE, AND REMOVAL OF EACH BMP SPECIFIED BY THIS PLAN OR OTHERWISE PROVIDED FOR THROUGHOUT THE LIFE OF THE PROJECT.

17. FINAL STABILIZATION OF THE PROJECT SITE WILL CONSIST OF THE FOLLOWING MEASURES:

PERMANENT BUILDING CONSTRUCTION b. PERMANENT PAVING

c. FORMAL LANDSCAPING

18. TOTAL SITE AREA = 7.21 AC, MORE OR LESS (PER PLAT OF RECORD) 19. TOTAL DISTURBED AREA = 7.1AC (SCALED FROM GRADING PLAN)

REVISIONS

| DRAWN BY | J.Y.R. |
|--------------|------------|
| REVIEWED BY | G.M. |
| DATE | 11/23/2022 |
| PROJECT NO. | 19-0058 |
| DRAWING NAME | |

EROSION AND SEDIMENT CONTROL PLAN **NOTES AND DETAILS**

SHEET NO.

2021.012.4

ESC501