
CITY OF ALBUQUERQUE

Planning Department Brennon Williams, Director

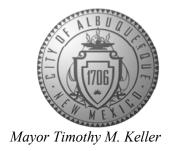

March 18, 2021

Paul Cragun, P.E. Cumulus Design 2080 N. Highway 360, Suite 240 Grand Prairie, TX 75050

RE: Chase Bank – Coors Blvd. 9261 Coors Blvd. NW Grading and Drainage Plans Engineer's Stamp Date: 03/02/21

Hydrology File: C13D035

Dear Mr. Cragun:

PO Box 1293

Albuquerque

NM 87103

www.cabq.gov

Based upon the information provided in your submittal received 03/02/2021, the Grading and Drainage Plans are approved for Building Permit and action by the DRB on Site Plan for Building Permit.

Please attach a copy of this approved plan in the construction sets for Building Permit processing along with a copy of this letter. Prior to approval in support of Permanent Release of Occupancy by Hydrology, Engineer Certification per the DPM checklist will be required.

As a reminder, if the project total area of disturbance (including the staging area and any work within the adjacent Right-of-Way) is 1 acre or more, then an Erosion and Sediment Control (ESC) Plan and Owner's certified Notice of Intent (NOI) is required to be submitted to the Stormwater Quality Engineer (Doug Hughes, PE, jhughes@cabq.gov, 924-3420) 14 days prior to any earth disturbance.

The Payment in Lieu payment of \$3,699.28 must be paid prior to Permanent Release of Occupancy approval. Please use the attached City of Albuquerque Treasury Deposit form. Once the Owner paid the fee, please provide Hydrology with a copy of the receipt.

If you have any questions, please contact me at 924-3995 or rbrissette@cabq.gov.

Sincerely,

Renée C. Brissette, P.E. CFM Senior Engineer, Hydrology Planning Department

Renée C. Brissette




City of Albuquerque

Planning Department Development & Building Services Division

DRAINAGE AND TRANSPORTATION INFORMATION SHEET (REV 11/2018)

Project Title: Chase Bank -Coors Blvd	Building Permit	#: Hydrology File #:
DRB#:	EPC#:	Work Order#:
Legal Description: Tract A1A1 Plaza at Pa	seo del Norte	
City Address: 9261 Coors Blvd NW Albuquer	que, NM 87114	
Owner: JP Morgan Chase Bank Address: 7301 North Federal Blvd. Westminste	Prairie, Texas 75050 Fax#: er, Colorado 80030	Contact: Carlos Iglesias E-mail: carlos@cumulusdesign.net Contact: Sunil Dubey E-mail:
TYPE OF SUBMITTAL: PLAT (PLA	Yes X N	o
Check all that Apply: TYPE OF SUBMITTAL: ENGINEER/ARCHITECT CERTIFICATION CONCEPTUAL G & D PLAN GRADING PLAN DRAINAGE MASTER PLAN DRAINAGE REPORT FLOODPLAIN DEVELOPMENT PERM ELEVATION CERTIFICATE CLOMR/LOMR TRAFFIC CIRCULATION LAYOUT (TRAFFIC IMPACT STUDY (TIS) OTHER (SPECIFY) PRE-DESIGN MEETING?	MIT APPLIC TCL)	TYPE OF APPROVAL/ACCEPTANCE SOUGHT: BUILDING PERMIT APPROVAL CERTIFICATE OF OCCUPANCY PRELIMINARY PLAT APPROVAL SITE PLAN FOR SUB'D APPROVAL X SITE PLAN FOR BLDG. PERMIT APPROVAL FINAL PLAT APPROVAL SIA/ RELEASE OF FINANCIAL GUARANTEE FOUNDATION PERMIT APPROVAL X GRADING PERMIT APPROVAL SO-19 APPROVAL PAVING PERMIT APPROVAL GRADING/ PAD CERTIFICATION WORK ORDER APPROVAL CLOMR/LOMR FLOODPLAIN DEVELOPMENT PERMIT OTHER (SPECIFY)
DATE SUBMITTED: February 23, 2021		
COA STAFF:		MITTAL RECEIVED:

FEE PAID:

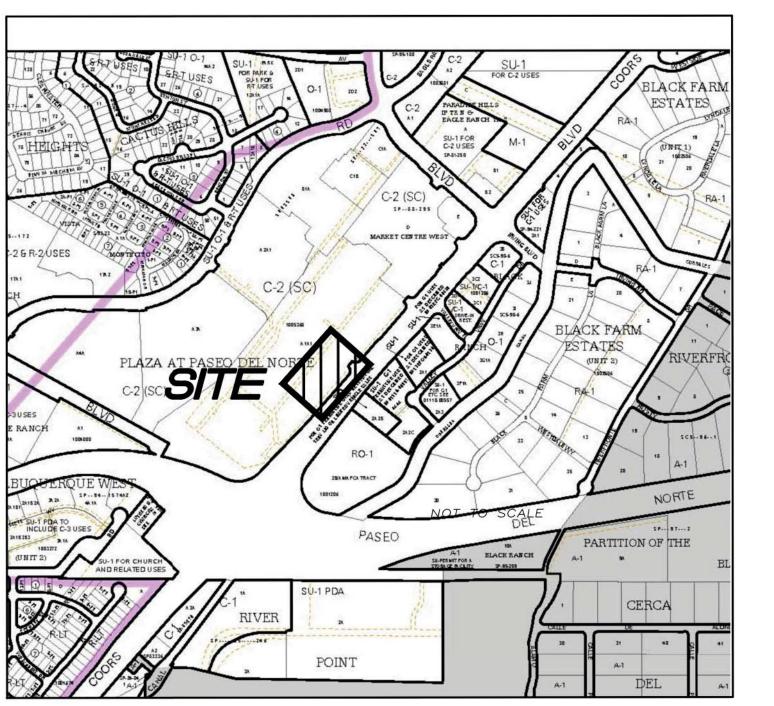

VICINITY MAP

GENERAL NOTES

- 1. Bearings are New Mexico State Plane Grid Bearings, Central Zone NAD83.
- 2. Distances are ground. (US Survey Foot).
- 3. Distances along curved lines are arc lengths.
- 4. Record plat or deed bearings and distances, where they differ from those established by this field survey, are shown in parentheses ().
- 5. Field surveys were performed during the month of December, 2020.
- 6. As noted item 11(a) of Table A of the "Minimum Standard Detail Requirements For ALTA/NSPS Land Title Surveys, Effective Date February 23, 2016, "Location of utilities existing on or serving the surveyed property as determined by observed evidence collected pursuant to Section 5.E.iv.

All utilities should be field verified and spotted by the contractor(s) prior to commencement of any construction.

- 7. The word Certify or Certification as used herein is understood to be an expression of professional opinion by the surveyor, based upon his best knowledge, information and belief, as such, and does not constitute a guarantee, nor a warranty, expressed or implied.
- 8. The surveyed property is subject to all exceptions pertaining to the surveyed property as listed in SCHEDULE B PART II of the Title Commitment prepared for this property by Fidelity National Title Insurance Company, Commitment SP000091781, commitment date November 30, 2020.
- 9. The above described Title Commitment was used in defining easements as shown hereon. Circled numbers by the easement description correspond to the Title Commitment's SCHEDULE B PART II item number. Where possible, said easements have been plotted. Only easements as provided for in said SCHEDULE B SECTION II of the Commitment described above or designated on the plat of record are shown on this survey.
- 10. There is no observable evidence of recent earth moving work, building construction or building additions within recent months.
- 11. There does not appear to be changes in the existing street right of way lines either completed or proposed as of the date of this survey.
- 12. No field delineation markers indicating wetlands were observed within the surveyed property.
- 13. The nearest intersecting streets are Paseo Del Norte and Coors Boulevard located 1009' south of the site.
- 14. Utilities shown hereon are a combination of surface evidence and the

UTILITY DISCLAIMER

SOURCE INFORMATION FROM PLANS AND MARKINGS HAVE BEEN BE COMBINED WITH OBSERVED EVIDENCE OF UTILITIES TO DEVELOP A VIEW OF THOSE UNDERGROUND UTILITIES. HOWEVER, LACKING EXCAVATION, THE EXACT LOCATION OF UNDERGROUND FEATURES CANNOT BE ACCURATELY, COMPLETELY AND RELIABLY DEPICTED. WHERE ADDITIONAL OR MORE DETAILED INFORMATION IS REQUIRED, THE CLIENT IS ADVISED THAT EXCAVATION MAY BE NECESSARY. NEW MEXICO ONE CALL (NM811) LOCATE ON-LINE REQUEST CONFIRMATION TICKET NO. 20NV110153 DATED 11/11/2020. THERE MAY BE PRIVATE UNDERGROUND UTILITY LINES NOT WITHIN DOCUMENTED EASEMENTS THAT WERE NOT MARKED OUT BY UTILITY LINE-SPOTTING COMPANIES NOTIFIED BY NM811 THIS PROJECT WAS CALLED IN TO NM811 AS A "DESIGN LOCATE". SOME UTILITY LINE-SPOTTING COMPANIES NOTIFIED BY NM811 CONSIDER "DESIGN LOCATE" CALLS AS LOW PRIORITY AND IN SOME CASES DELAY RESPONSE, PARTIALLY COMPLETE OR NOT RESPOND AT THE RETAINING OF A PRIVATE UTILITY LINE-SPOTTING COMPANY MAY BE NECESSARY FOR COMPLETE UTILITY LINE-SPOTTING OF A SUBJECT PROPERTY. PAINT MARKS AND FLAGGING SET ON THE GROUND BY UTILITY COMPANIES AND OTHERS ARE USED TO DESIGNATE UNDERGROUND UTILITIES AS SHOWN HEREON: RED FOR ELECTRIC, BLUE FOR WATER, YELLOW FOR GAS, ORANGE FOR COMMUNICATIONS, GREEN FOR SEWER. ANY PIPE SIZES OR MATERIAL TYPES SHOWN HEREON WERE DERIVED FROM ASBUILT PLANS AS PROVIDED BY THE VARIOUS UTILITY COMPANIES. SURV-TEK, INC. MAKES NO REPRESENTATION THAT SAID INFORMATION IS CURRENT OR ARCHITECT, ENGINEER, AND CONTRACTOR WILL BE RESPONSIBLE FOR VERIFICATION OF SAID INFORMATION DURING THEIR DESIGN PROCESS. QUALIFIED SUBSURFACE UTILITY ENGINEERING (SUE) SERVICES MAY BE REQUIRED FOR OBTAINING INACCESSIBLE UTILITY DATA AND MUNICIPAL AUTHORIZATION AND PERMITTING FOR TRAFFIC BLOCKADING AND BARRICADE PLANS. UTILITIES LABELED WITH AN ASTERISK (*) ARE DERIVED OR TRANSCRIBED FROM PROVIDED PLANS AND MUST BE VERIFIED BY THE APPROPRIATE UTILITY. UTILITIES LABELED WITH AN POUND SIGN (#) ARE ASSUMED UTILITY LOCATIONS AND MUST BE VERIFIED BY THE APPROPRIATE UTILITY.

NOTE: UNOPENED MANHOLES ARE LABELED ACCORDING TO THE DESIGNATION ON THE MANHOLE TOP. MANHOLES LABELED SANITARY OR STORM DRAIN MAY NOT BE SO. ONLY UPON OPENING

OF A MANHOLE CAN IT'S TRUE PURPOSE BE DETERMINED.

A.L.T.A. / N.S.P.S. LAND TITLE SURVEY OF A PORTION OF TRACT A-1-A-1 THE PLAZA AT PASEO DEL NORTE CITY OF ALBUQUERQUE, BERNALILLO COUNTY NEW MEXICO DECEMBER, 2020

EXCEPTIONS

As listed in the Title Commitment prepared for this property by Fidelity National Title Insurance Company, Commitment SP000091781, commitment date November 30, 2020.

- 9. Reservations contained in Patent from the United States of America, filed in Book 64, page 412, records of Bernalillo County, New Mexico. (subject property lies within described boundary no plottable items)
- (10.) Easement granted to the Public Service Company of New Mexico filed May 6, 1957, in Book D385, page 303, records of Bernalillo County, New Mexico. Easement Encroachment Agreement between the City of Albuquerque and Public Service Company of New Mexico, filed February 10, 2005, as Document No. 2005020108, records of Bernalillo County, New Mexico. (Does Not Affect Subject Portion of Tract A-1-A-1)
- (11.) Reservation of 1/2 of all oil, gas, uranium and other minerals as reserved with conditions in Warranty Deed filed in Book D513, page 189, records of Bernalillo County, New Mexico. Affidavit filed December 4, 1996, as Document No. 96130372; Memorandums of Existence of Oil and Gas Lease filed March 3, 2008, as Document No. 2008023956, 2008023957 and 2008023958, records of Bernalillo County, New Mexico. (Non Survey Matter)
- 12. Utility Easement filed February 10, 1992, as Document No. 9211652, records of Bernalillo County, New Mexico.
 (Does Not Affect Subject Portion of Tract A-1-A-1)
- (13.) Easement Encroachment Agreements filed as Document No. 90-5847, 93142203 and 93131552, records of Bernalillo County, New Mexico. (Does Not Affect Subject Portion of Tract A-1-A-1)
- (14.) Easement granted to the Mountain States Telephone and Telegraph Company filed July 15, 1960, in Book D552, page 151, records of Bernalillo County, New Mexico. (As Shown Hereon)
- 15.) Easement granted to Paradise Services Corporation, filed in Book D796, page 907, records of Bernalillo County, New Mexico. (As Shown Hereon)
- (16.) Easement(s), Note(s) and Disclosure(s) as to and reserved across the insured land, as shown on the recorded Plat(s), filed in Plat Book C18, page 10; Plat Book C18, page 158, Plat Book C37, page 12; Plat Book C37, page 125; Plat Book 90C, page 151; Plat Book 94C, page 113, Plat Book 97C, page 65, and in Plat Book 2011C, page 114, records of Bernalillo County, New Mexico. (As Shown Hereon)
- (17.) Construction, Operation and Reciprocal Easement Agreement between Market Center West Associates and Dayton Hudson Corporation, filed January 12, 1989, in Book Misc. 703A, page 27, as Document No. 892788, and First Amendment to Construction, Operation and Reciprocal Easement Agreement, filed July 13, 1999, as Document No. 1999092064, records of Bernalillo County, New Mexico. (Document Not Provided)
- (18.) Access Easement between Market Center West Associates and Cinemark USA, Inc., filed August 24, 1992, in Book 92–19, page 7382, as Document No. 09284341, records of Bernalillo County, New Mexico. (Easement Blanket in Nature)
- (19.) Construction, Operation and Reciprocal Easement Agreement between Paseo Del Norte Plaza Associates, L.P., and Arthur Gardenswartz, filed December 30, 1993, as Document No. 93148381, records of Bernalillo County, New Mexico. (Document Not Provided)
- 20. License and Agreement between Paseo Del Norte Plaza Associates, L.P., and A.G. Spanos Construction, Inc., filed May 11, 1994, in Book 94—15, page 2906, as Document No. 94062680, records of Bernalillo County, New Mexico. (Documents Listed in Agreement Not Provided)
- 21. Easement granted to U.S. West Communications, Inc., filed September 14, 1994, in Book 9426, page 4677, as Document No. 94112793, records of Bernalillo County, New Mexico.

 (Does Not Affect Subject Portion of Tract A-1-A-1)
- Lease as evidenced by Memorandum of Lease, executed by and between Market Center West Associates, and Ross Stores, Inc., filed February 27, 1990, in Book 90-4, page 6195, as Document No. 9018312, records of Bernalillo County, New Mexico. (Non Survey Matter)
- Lease executed by and between The Price Reit, Inc., and Hancock Fabrics, Inc., filed January 5, 2006, in Book A110, page 1668, as Document No. 2006001668, records of Bernalillo County, New Mexico. (Non Survey Matter)
- 24. Lease as evidenced by Memorandum of Lease executed by and between Market Center West Associates, and Cinemark USA, Inc., filed August 24, 1992, as Document No. 9284340, Assignment of Lease between Hollywood Cinema Inc., and Cinemark USA, filed August 24, 1992, as Document No. 9284339, records of Bernalillo County, New Mexico. (Non Survey Matter)
- Lease as evidenced by Memorandum of Lease executed by and between Paseo Del Norte Plaza Associates, L.P., and Payless Shoesource, Inc., filed June 13, 1995, in Book 9514, page 1450, as Document No. 95058356, records of Bernalillo County, New Mexico. (Non Survey Matter)
- Lease as evidenced by Memorandum of Lease executed by and between Paseo Del Norte 586, LLC, a New Mexico limited liability company and Sear Outlet Store, LLC, a Delaware limited liability company, filed December 6, 2013, as Document No. 2013130292, records of Bernalillo County, New Mexico. (Non Survey Matter)
- 27) Agreement for Granting of Easements and Construction, Maintenance, Transfer and Assumption of the Paradise Storm Drain Project filed July 27, 2010, as Document No. 2010075451, records of Bernalillo County, New Mexico. (Does Not Affect Subject Portion of Tract A-1-A-1)
- (28) Tenancy in Common Agreement by and between CPP Paseo I LLC, a Delaware limited liability company and CPP Paseo II LLC, a Delaware limited liability company, filed October 15, 2015, as Document No. 2015090473, records of Bernalillo County, New Mexico. (Non Survey Matter)

LEGAL DESCRIPTION

As listed within the Title Commitment prepared for this property by Fidelity National Title Insurance Company, Commitment SP000091781, commitment date November 30, 2020.

PARCEL 1:

a Portion of Tract A—1—A—1 of THE PLAZA AT PASEO DEL NORTE, within the Town of Alameda Grant, Projected Section 18, Township 11 North, Range 3 East, N.M.P.M., City of Albuquerque, Bernalillo County, New Mexico on October 27, 2011 in Map Book 2011C, folio 114 as Document No. 2011097886.

PARCEL 2:

Non—exclusive rights of Easement for Parking, Access, Drainage and Utilities in accord with Plats recorded in the Office of the County Clerk of Bernalillo County, New Mexico in Map Book C37, folio 125 and in Map Book 90C, folio 151 and in Map Book 94C, folio 113 and as amended in Map Book 97C, folio 65, to the extent of and only for the duration as provided for therein.

PARCEL 3:

Non-exclusive rights of Easement for Ingress and Egress and Utilities in accord with the Construction, Operation and Reciprocal Easement Agreement, recorded as Document No. 892788, and by First Amendment to Construction, Operation and Reciprocal Easement Agreement, recorded as Document No. 1999092064, in the Office of the County Clerk of Bemalillo County, New Mexico, to the extent of and only for the duration as provided for therein.

PARCEL 4:

Non—exclusive rights of Easement for Ingress and Egress and Utilities in accord with the Construction, Operation and Reciprocal Easement Agreement, recorded as Document No. 93148381, filed in the Office of the County Clerk of Bemalillo County, New Mexico, to the extent of and only for the duration as provided for therein.

FLOOD ZONE DETERMINATION

The subject property (as shown hereon) appears to lie within Zone "X" (areas determined to be outside 0.2% annual chance floodplain) in accordance with the National Flood Insurance Program Rate Map No. 35001C0116G, Effective Date 09-26-2008

DOCUMENTS USED IN THE PREPARATION OF THIS SURVEY

- A. Title Commitment prepared for this property by Fidelity National Title Insurance Company, Commitment SP000091781, commitment date November 30, 2020.
- B. Plat entitled, "Plat of Tract A-1-A-1, The Plaza at Paseo Del Norte", filed October 27, 2011 in Book 2011C, Page 114, records of Bernalillo County, New Mexico.
- C. Plat entitled,"Plat of Tracts A-1, A-2, A-3 and A-4, The Plaza at Paseo Del Norte", filed April 7, 1994 in Book 94C, Page 113, records of Bernalillo County,
- D. Plat entitled,"Plat of The Plaza at Paseo Del Norte", filed June 28, 1990, in Book 90C, Page 151, records of Bernalillo County, New Mexico.
- E. Plat entitled,"Plat for The Plaza at Paseo Del Norte, tracts A-1-A, A-2-A, A-3-A, A-4-A, B-1, C-1, D AND E" filed February 27, 1997 in Book 97C, Page 65, records of Bernalillo County, New Mexico.

SURVEYORS CERTIFICATION

To: JPMorgan Chase Bank, N.A.; CPP Paseo I LLC, a Delaware limited liability company; CPP Paseo II LLC, a Delaware limited liability company and Fidelity National Title Insurance Company;

This is to certify that this map or plat and the survey on which it is based were made in accordance with the 2016 Minimum Standard Detail Requirements for ALTA/NSPS Land Title Surveys, jointly established and adopted by ALTA and NSPS, and includes Items 2, 3, 5, 7(a), 7(b)(1), 7(c), 8, 11, 13, 14, 16, 17 and 18 of Table A thereof. The field work was completed on December 11, 2020.

David Vigil NMPS No. 8911 Date: December, 2020

200419




EXISTING SURVEY

C2.01

SHEET 1 OF 2

Consulting Surveyors
Albuquerque, New Mexico

Phone: 505-897-3366

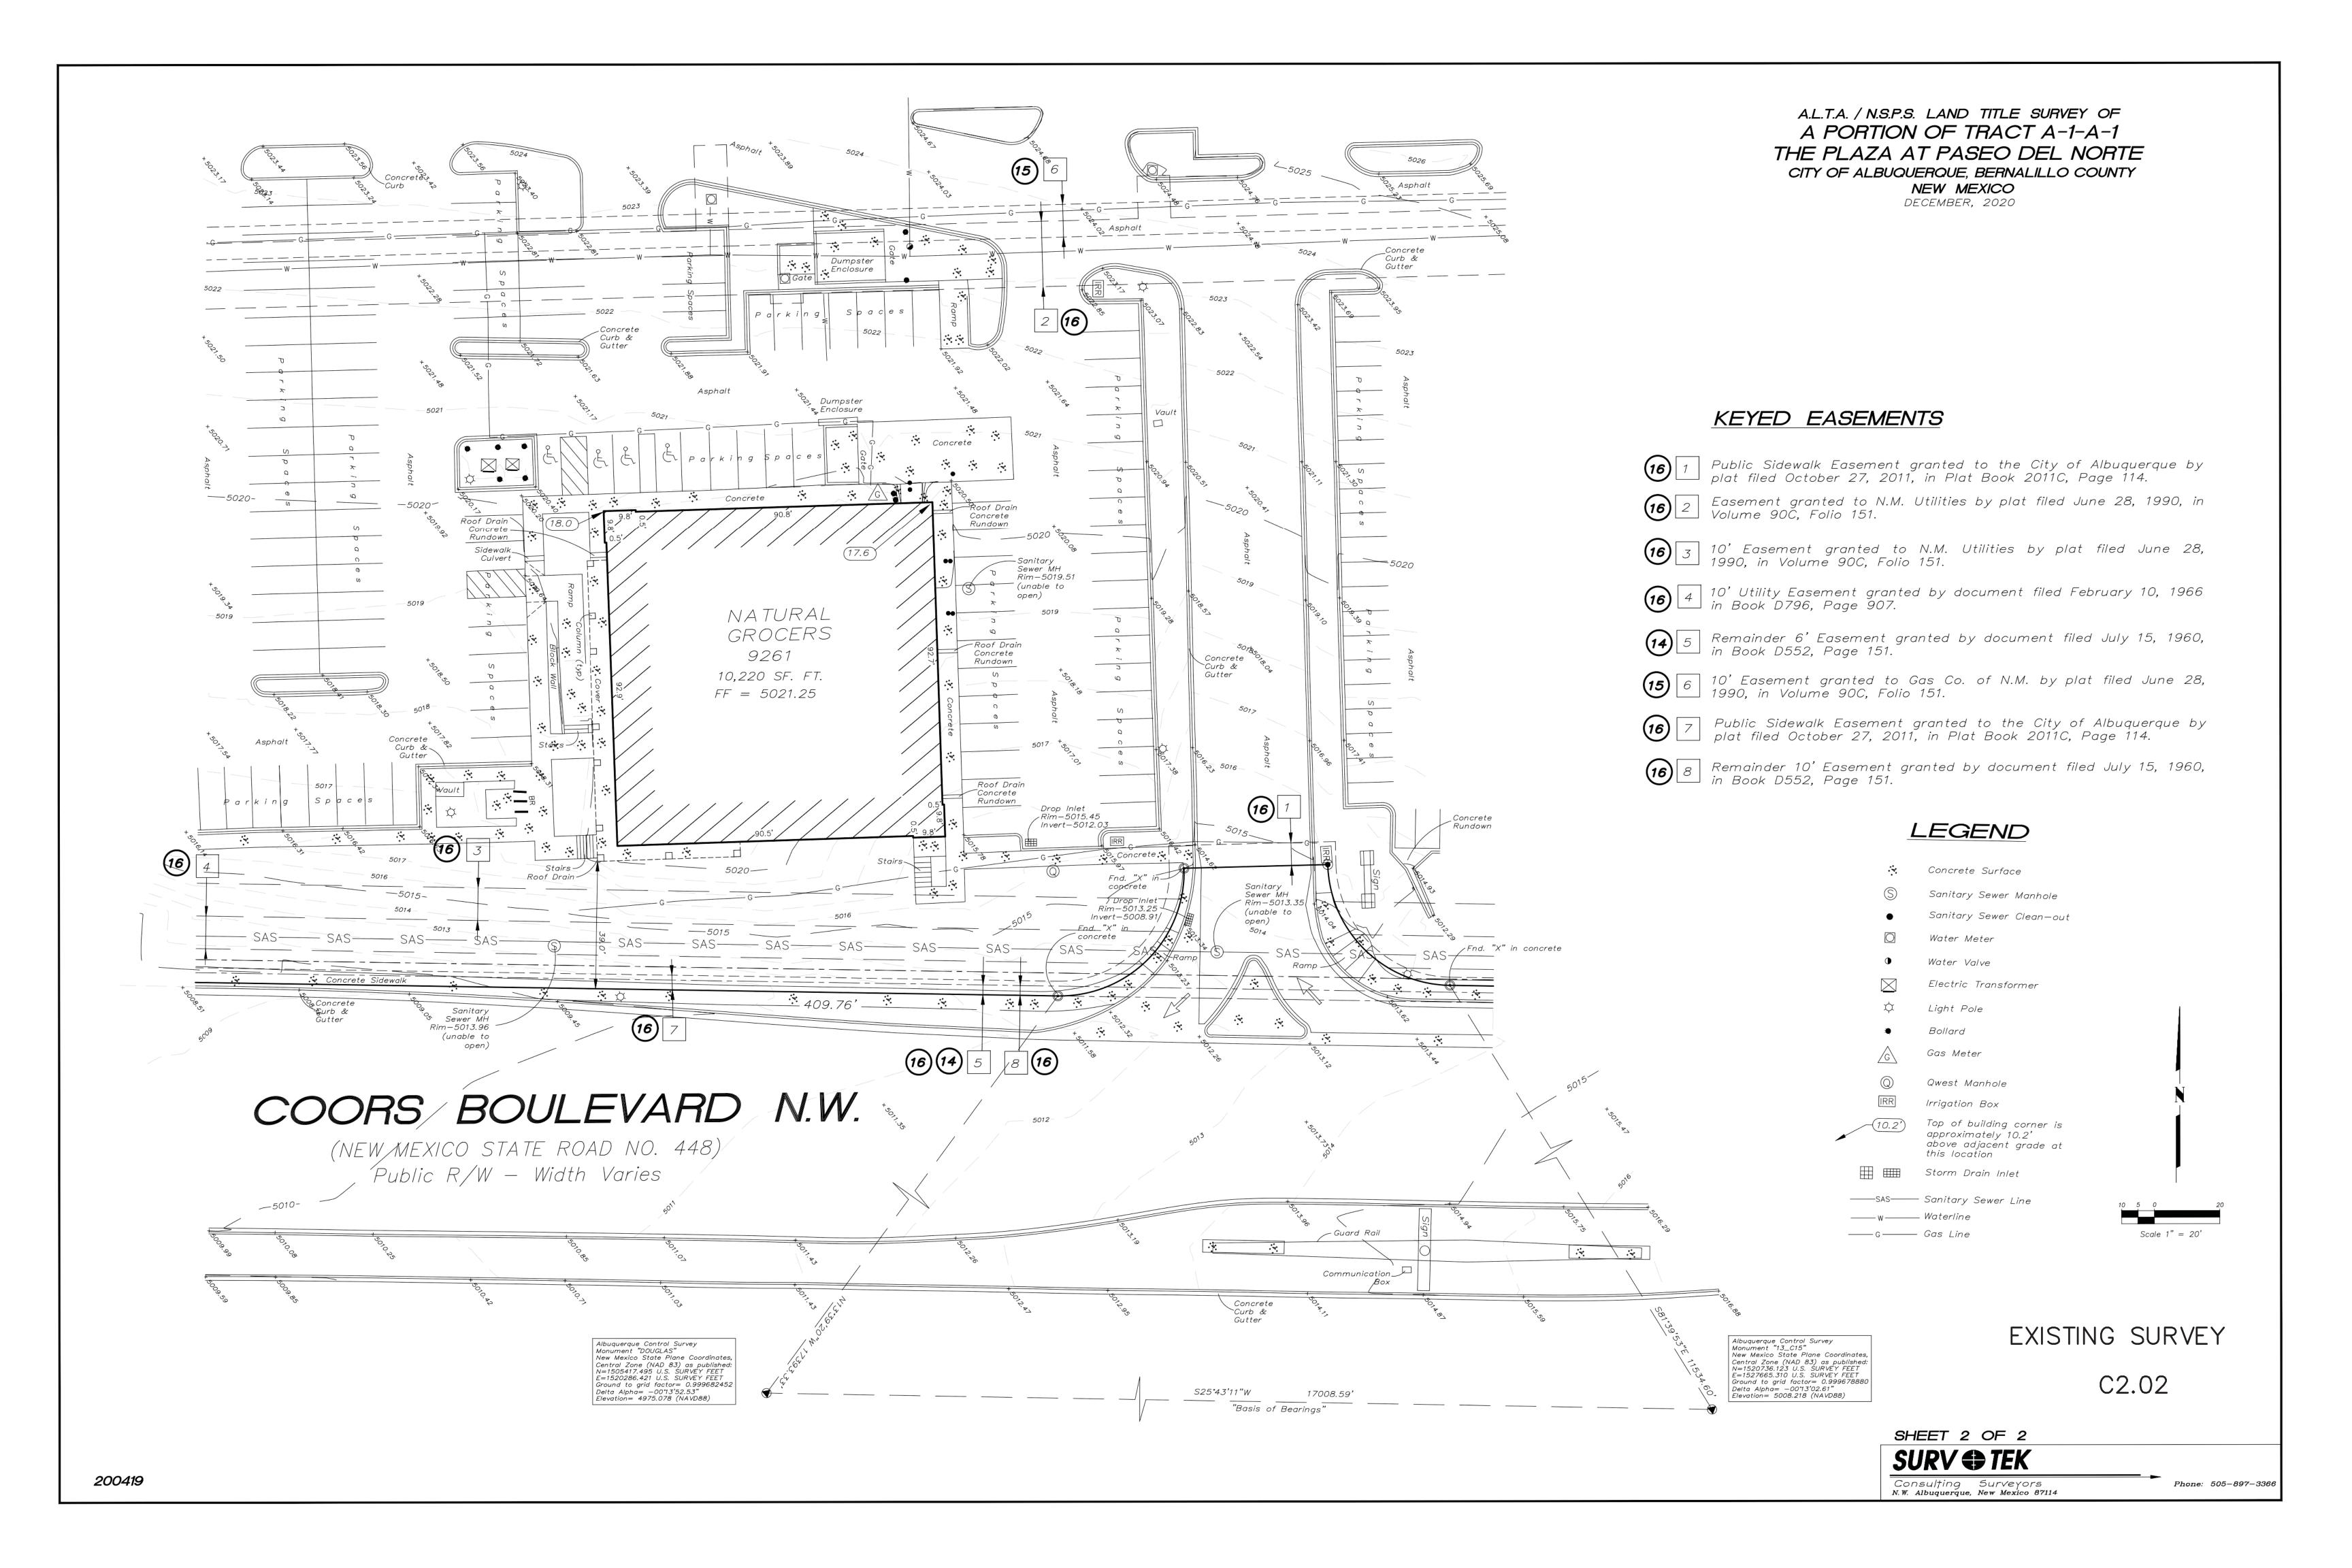

<u>LEGEND</u>

EXISTING CURB

 EXISTING CONTOUR - PROPOSED CONTOUR

- EXISTING SPOT ELEVATION

- PROPOSED SPOT ELEVATION

- DIRECTIONAL FLOW ARROW PROPOSED VALLEY

— R— — PROPOSED RIDGE



DRAWING SCALE 1"=20'

±4.3% SLOPE DOWN TOWARDS COORS BOULEVARD NW. AT APPROXIMATELY 40 FEET FROM COORS BOULEVARD RIGHT-OF-WAY THE SLOPE INCREASES TO ±26%. THE SOUTHWESTERN PORTION OF THE EXISTING DEVELOPMENT THE PAVEMENT SLOPES TOWARDS THE SOUTH-WEST TOWARDS AN

TOPOGRAPHY. THE PARKING LOT LOCATED IN THE NORTHERN PORTION OF THE PROPOSED BUILDING WILL RETAIN THE EXISTING SLOPE DOWN TO THE SOUTH-EAST. THE WESTERN PORTION WILL SLOPE TO THE SOUTH-WEST AND DRAIN TOWARDS THE EXISTING DETENTION POND LOCATED ±190 FT.

THE EXISTING SITE TOPOGRAPHY WITHIN THE PROPERTY HAS A EXISTING ±51,000 CU. FT. DETENTION POND.

THE PROPOSED DEVELOPMENT WILL UTILIZE THE EXISTING SITE

Z

AD

GR

(24234)

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COORS ALBUQUE ERNALILI ـيا|ي 0 0

THE BENCHMARKS ARE PROVIDED BASED ON THE ELEVATIONS PROVIDED BY SURVTEK CONSULTING SURVEYORS

City of Albuquerque Planning Department
Development Review Services

HYDROLOGY SECTION

APPROVED

03/18/21 C13D035

CENTRAL ZONE, NAD 83 AS PUBLISHED: N=1505417.495 E=1520286.421 GROUND TO GRID FACTOR=0.999682452, DELTA ALPHA = - 00°13'52.53" ELEVATION=4975.078 NAVD88

ALBUQUERQUE CONTROL SURVEY MONUMENT "13_C15" NEW MEXICO STATE PLANE COORDINATES, CENTRAL ZONE, NAD 83 AS PUBLISHED: N=1520736.123 E=1527665.310 GROUND TO GRID FACTOR=0.999678880, DELTA ALPHA = - 00°13'02.61"

ALBUQUERQUE CONTROL SURVEY MONUMENT "DOUGLAS" NEW MEXICO STATE PLANE COORDINATES,

ELEVATION=5008.218 NAVD88

CONTRACTOR SHALL COORDINATE WITH SURVEYOR FOR BENCHMARKS AND ELEVATIONS PRIOR TO CONSTRUCTION. ENGINEER NOT RESPONSIBLE FOR PROVIDING BENCHMARKS AND BEARINGS.

!!! CAUTION !!!

UNDERGROUND UTILITIES

NOT ASSUME THE RESPONSIBILITY FOR THE UTILITY LOCATIONS SHOWN. IT SHALL BE THE SOLE RESPONSIBILITY OF THE CONTRACTOR(S) TO VERIFY THE HORIZONTALLY AND VERTICALLY LOCATION OF ALL UTILITIES AND UNDÈRGROUND FACILITIES PRIOR TO CONSTRUCTION, TO TAKE PRECAUTIONS IN ORDER TO PROTECT ALL FACILITIES ENCOUNTERED AND NOTIFY THE ENGINEER OF ALL CONFLICTS OF THE WORK WITH EXISTING FACILITIES. THE CONTRACTOR SHALL PROTECT AND MAINTAIN ALL UTILITIES FROM DAMAGE DURING CONSTRUCTION. ANY DAMAGE BY THE CONTRACTOR TO UTILITIES SHALL BE REPAIRED OR REPLACED BY THE CONTRACTOR AT THEIR

CALL: NEW MEXICO ONE CALL @ NM 811 AT LEAST 7 DAYS PRIOR TO CONSTRUCTION.

\\SERVER-PC\SERVER\2020 CDC PROJECTS\CDC20021 - COORS BLVD AND PASEO\PLANS\GRADING PLAN CDC20021.DWG

OWN EXPENSE.

PLOT DATE 02/23/21 DRAWING SCALE

1" = 20'

PROJECT NUMBER

CDC20021

SHEET NUMBER

C5.01

EXISTING UTILITIES AND UNDERGROUND FACILITIES INDICATED ON THESE PLANS HAVE BEEN LOCATED FROM REFERENCE INFORMATION SUPPLIED BY VARIOUS PARTIES. THE ENGINEER DOES

CALL NM ONE-CALL

SYSTEM SEVEN (7) DAYS

PRIOR TO ANY EXCAVATION

CONTRACTOR'S EXPENSE. 5. CONTRACTOR SHALL VERIFY ALL EXISTING INVERTS AND RIM ELEVATIONS PRIOR TO CONSTRUCTION. IF CONFLICTS EXIST, THE CONTRACTOR IS TO CONTACT ENGINEER.

SPECIFICATIONS.

GRADING NOTES:

PERMITTING AUTHORITIES.

6. BENCHMARKS HAVE BEEN PROVIDED AS A REFERENCE. IT IS THE CONTRACTOR'S RESPONSIBILITY TO LOCATE, VERIFY, AND/OR ESTABLISH A BENCHMARKS PRIOR TO CONSTRUCTION. IT IS THE CONTRACTOR'S

. ALL CONSTRUCTION TO BE IN ACCORDANCE WITH THESE PLANS, CITY

STANDARDS, SPECIFICATIONS FOR PUBLIC WORKS CONSTRUCTION.

2. PRIOR TO STARTING CONSTRUCTION, THE CONTRACTOR SHALL MAKE

NEW MEXICO DEPARTMENT OF TRANSPORTATION RULES AND

CERTAIN THAT ALL REQUIRED PERMITS AND APPROVALS HAVE BEEN OBTAINED. NO CONSTRUCTION OR FABRICATION SHALL BEGIN UNTIL THE CONTRACTOR HAS RECEIVED AND THOROUGHLY REVIEWED ALL PLANS AND OTHER DOCUMENTS APPROVED BY ALL RESPONSIBLE PARTIES OF THE

3. BARRICADING, TRAFFIC CONTROL, AND PROJECT SIGNS SHALL CONFORM TO

4. THE LOCATION OF ALL EXISTING UTILITIES SHOWN ARE BASED ON FIELD

UTILITY COMPANIES TO LOCATE THEIR UTILITIES PRIOR TO STARTING

SURVEYS AND LOCAL UTILITY COMPANY RECORDS. IT SHALL BE THE

CONTRACTOR'S FULL AND SOLE RESPONSIBILITY TO CONTACT THE VARIOUS

CONSTRUCTION. ANY DAMAGE TO EXISTING UTILITIES IS TO BE REPAIRED AT

RESPONSIBILITY TO PRESERVE SURVEY STAKES AND MARKERS FOR THE DURATION OF THE PROJECT. IF ANY CONSTRUCTION STAKES OR MARKERS ARE LOST OR DISTURBED AND ARE NEEDED TO BE REPLACED, SUCH REPLACEMENT SHALL BE BY THE SURVEYOR AT THE EXPENSE OF THE CONTRACTOR.

7. EROSION CONTROLS SHALL BE IN PLACE PRIOR TO THE DISTURBANCE OF ANY EXISTING SURFACE.

8. CONTRACTOR SHALL BE RESPONSIBLE FOR MAINTAINING TRENCH SAFETY REQUIREMENTS IN ACCORDANCE WITH CITY STANDARDS, NEW MEXICO STATE LAW, AND O.S.H.A. STANDARDS FOR ALL EXCAVATION.

9. ALL EARTHWORK OPERATIONS SHALL CONFORM TO THE RECOMMENDATIONS PER THE GEOTECHNICAL REPORT.

10. DRAINAGE SHOULD BE MAINTAINED AWAY FROM THE FOUNDATIONS, BOTH DURING AND AFTER CONSTRUCTION.


11. ALL SIDEWALKS AND ACCESSIBLE ROUTE (INCLUDING HATCHED AREA ACROSS DRIVES) SHALL MAINTAIN A 2% MAXIMUM CROSS SLOPE AND A MAXIMUM 5% IN THE DIRECTION OF PEDESTRIAN TRAVEL.

12. SLOPE IN HANDICAP PARKING AREAS SHALL NOT EXCEED 2% IN ANY DIRECTION.

13. PROVIDE "FLAT" LANDINGS AT TOP AND BOTTOM OF ALL RAMPS. THESE "FLAT" AREAS SHALL BE 5' LONG AND THE SLOPE SHALL NOT EXCEED 2% IN ANY DIRECTION.

14. IT IS THE RESPONSIBILITY OF THE CONTRACTOR TO PROVIDE POSITIVE DRAINAGE AWAY FROM BUILDING AND PARKING AT ALL TIMES.

15. SITE GRADING SHALL BE PERFORMED IN A MANNER TO DIRECT WATER AS INDICATED. SURFACE WATER SHALL NOT BE RELEASED ONTO ADJACENT PRIVATE PROPERTY.

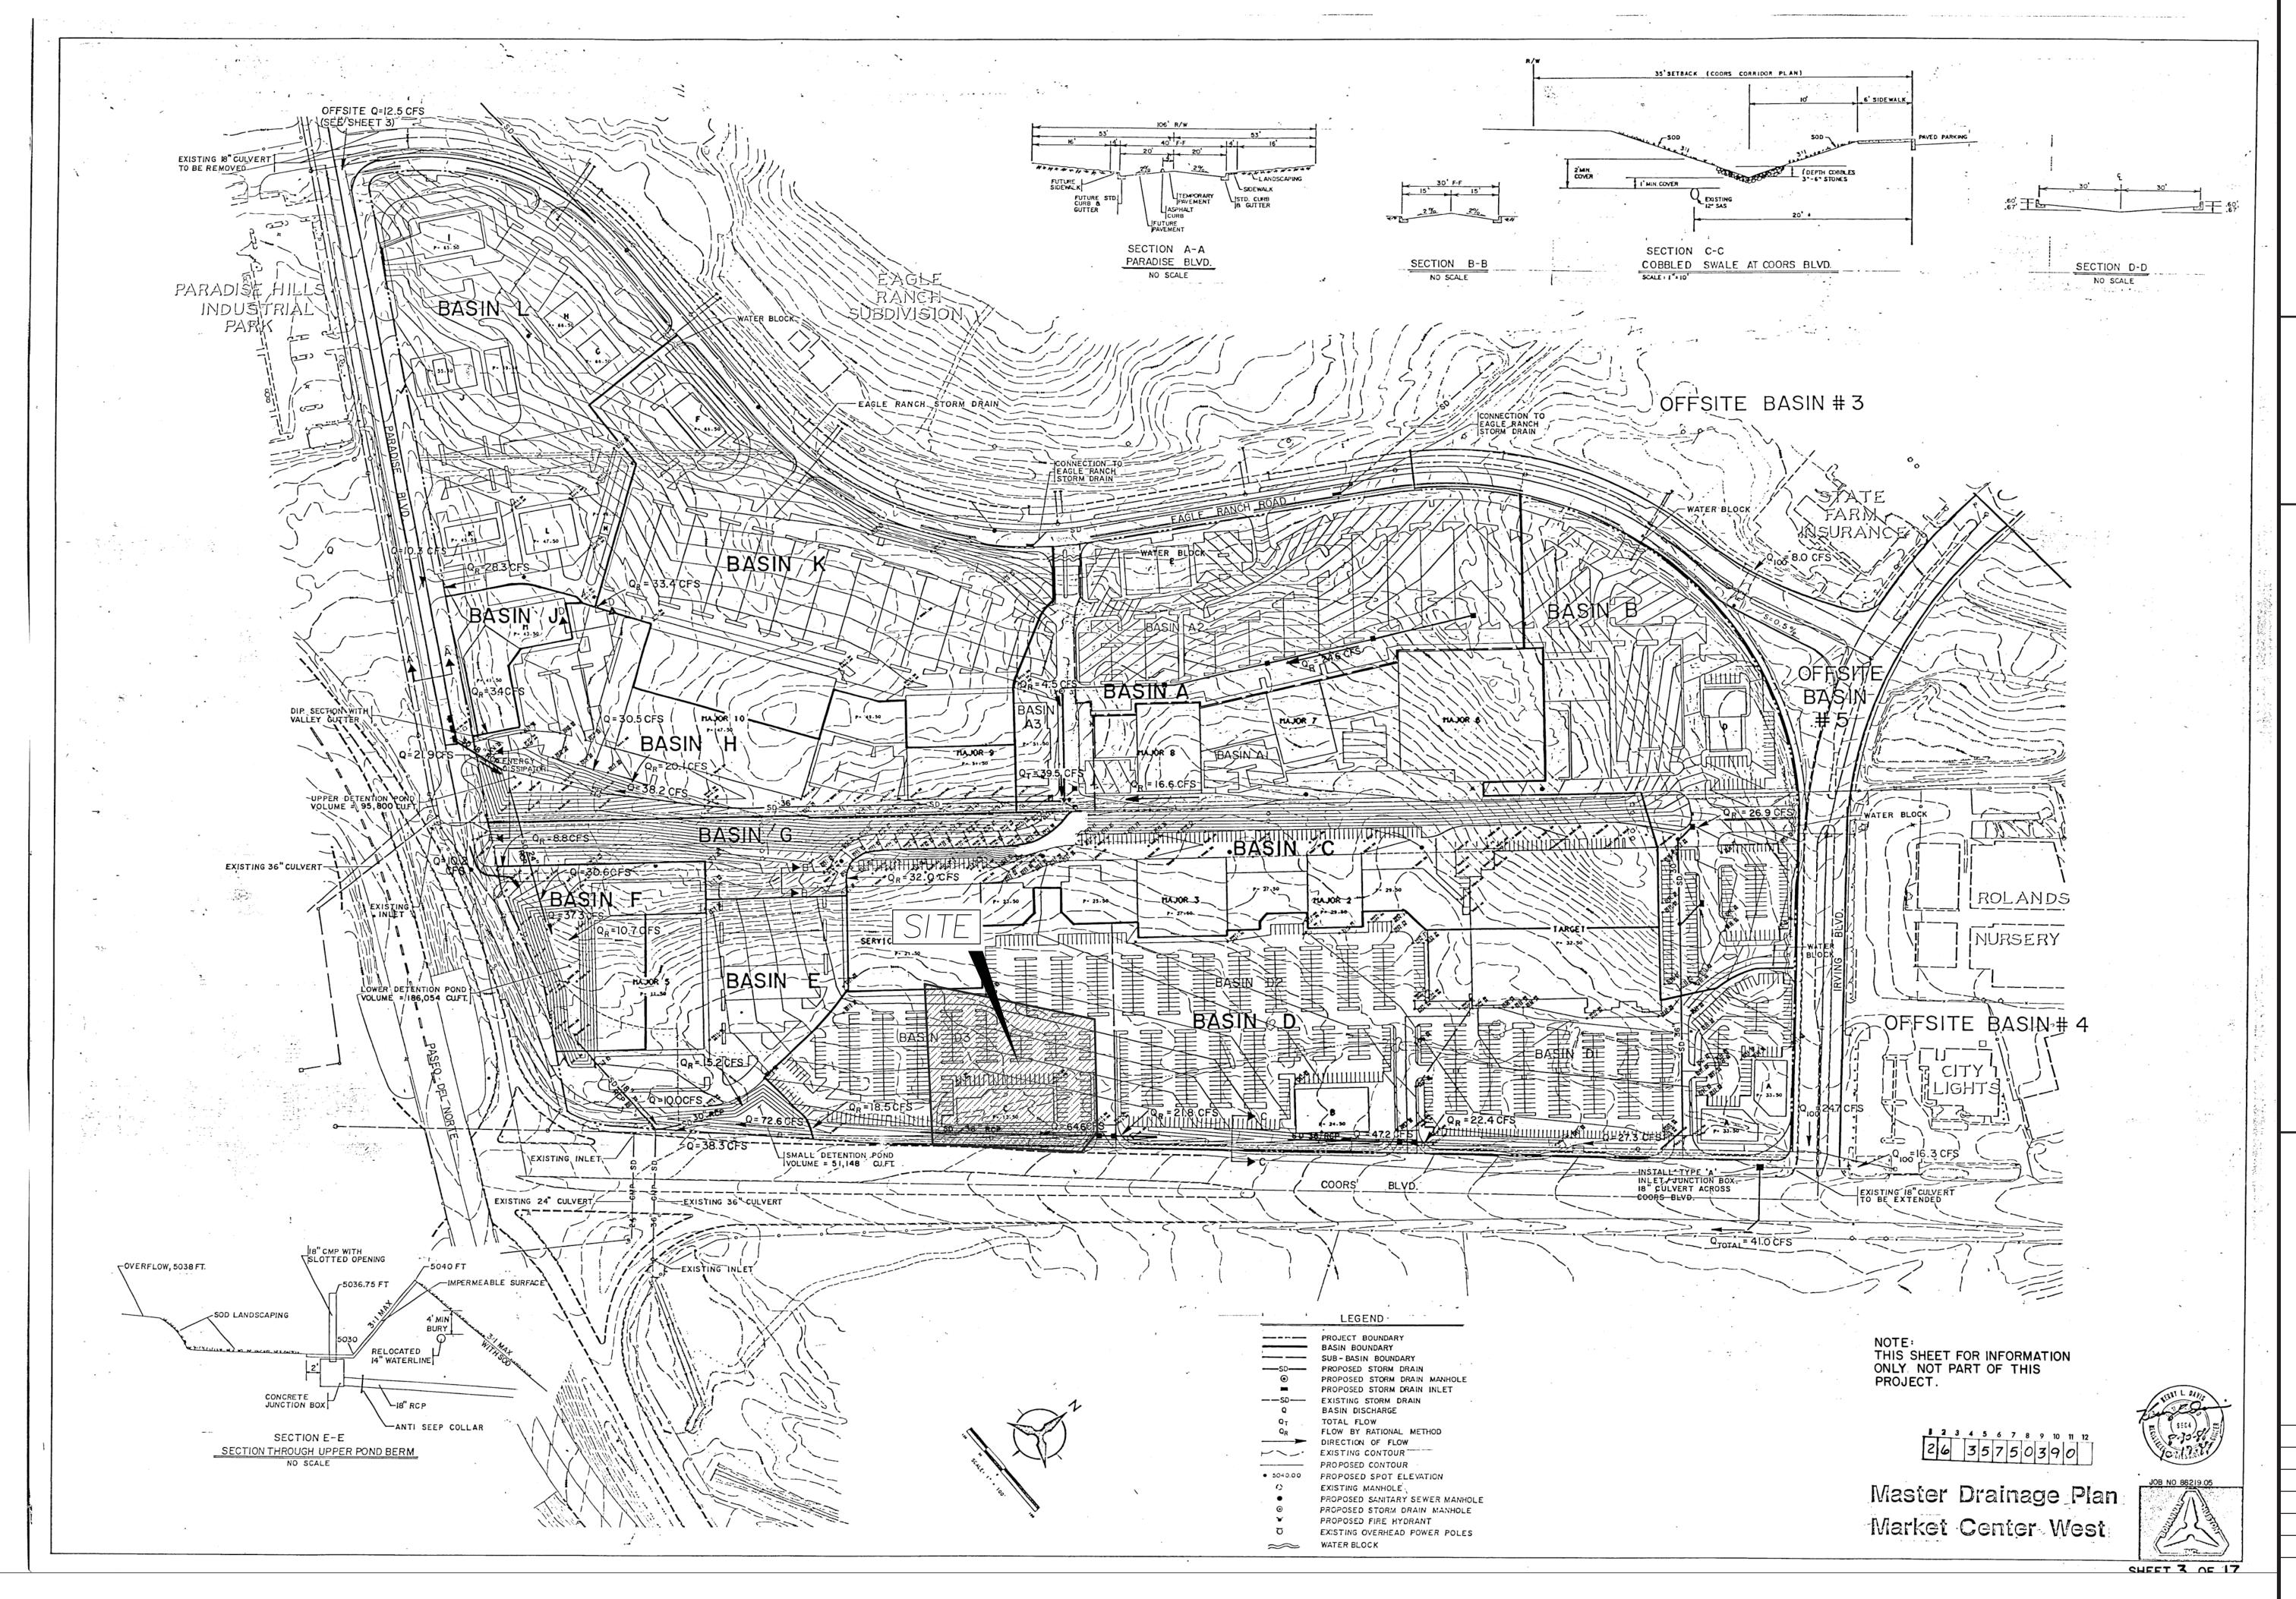

\\SERVER-PC\\SERVER\\2020 CDC PROJECTS\\CDC20021 - COORS BLVD AND PASEO\\PLANS\\EXISTING DRAINAGE AREA MAP CDC20021.DWG

lus Design Bersh

Cumulus Design 10 2080 N. Highway 360, Suite Grand Prairie, Texas 75050

XISTING DRAINAGE AREA MA
9261 COORS BOULEVARD NW
CITY OF ALBUQUERQUE, NEW MEXIC
BERNALILLO COUNTY

PLOT DATE
02/23/21
DRAWING SCALE

1" = 20' PROJECT NUMBER

CDC20021
SHEET NUMBER

C7.01

<u>LEGEND</u>

EXISTING CURB

- PROPOSED CURB

- PROPOSED CONTOUR

PROPOSED VALLEY


— R— — PROPOSED RIDGE

EXTREME EVENT (100-YEAR) SHEET FLOW DIRECTIONS ARROW

- DRAINAGE AREA DIVIDE

- AREA DESCRIPTION

REFER TO SHEET C8.02 FOR DRAINAGE CALCULATIONS

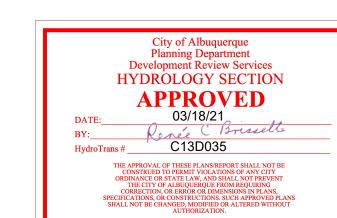

THE BENCHMARKS ARE PROVIDED BASED ON THE ELEVATIONS PROVIDED BY SURVTEK CONSULTING SURVEYORS

ALBUQUERQUE CONTROL SURVEY MONUMENT "DOUGLAS" NEW MEXICO STATE PLANE COORDINATES, CENTRAL ZONE, NAD 83 AS PUBLISHED: N=1505417.495 E=1520286.421 GROUND TO GRID FACTOR=0.999682452, DELTA ALPHA = - 00°13'52.53" ELEVATION=4975.078 NAVD88

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CALL NM ONE-CALL PRIOR TO ANY EXCAVATION

SYSTEM SEVEN (7) DAYS

CONTRACTOR SHALL COORDINATE WITH SURVEYOR FOR BENCHMARKS AND ELEVATIONS PRIOR TO CONSTRUCTION. ENGINEER NOT RESPONSIBLE FOR PROVIDING BENCHMARKS AND BEARINGS.

DRAWING SCALE

MAP

Z Z

DR

COORS E ALBUQUEI SERNALILL

26 OF

PLOT DATE 02/23/21

PROJECT NUMBER CDC20021

SHEET NUMBER

C8.01

OWN EXPENSE.

CALL: NEW MEXICO ONE CALL @ NM 811 AT LEAST 7 DAYS PRIOR TO CONSTRUCTION. \\SERVER-PC\SERVER\2020 CDC PROJECTS\CDC20021 - COORS BLVD AND PASEO\PLANS\PROPOSED DRAINAGE AREA MAP CDC20021.DWG

!!! CAUTION !!!

UNDERGROUND UTILITIES

RESPONSIBILITY OF THE CONTRACTOR(S) TO VERIFY THE HORIZONTALLY AND VERTICALLY

EXISTING UTILITIES AND UNDERGROUND FACILITIES INDICATED ON THESE PLANS HAVE BEEN

LOCATED FROM REFERENCE INFORMATION SUPPLIED BY VARIOUS PARTIES. THE ENGINEER DOES NOT ASSUME THE RESPONSIBILITY FOR THE UTILITY LOCATIONS SHOWN. IT SHALL BE THE SOLE

LOCATION OF ALL UTILITIES AND UNDERGROUND FACILITIES PRIOR TO CONSTRUCTION, TO TAKE

OF ALL CONFLICTS OF THE WORK WITH EXISTING FACILITIES. THE CONTRACTOR SHALL PROTECT

AND MAINTAIN ALL UTILITIES FROM DAMAGE DURING CONSTRUCTION. ANY DAMAGE BY THE CONTRACTOR TO UTILITIES SHALL BE REPAIRED OR REPLACED BY THE CONTRACTOR AT THEIR

PRECAUTIONS IN ORDER TO PROTECT ALL FACILITIES ENCOUNTERED AND NOTIFY THE ENGINEER

DRAINAGE CRITERIA ZONE 1 Q=C*I*A l₂=1.76 in/hr l₁₀=2.85 in/hr l₁₀₀=4.58 in/hr tc=12 min.

	PROPOSED DRAINAGE DATA CHART												
DRAINAGE ID	AREA (SQ. FT.)	AREA (AC.)	C2	C10	C100	T _c (min)	2 (in/hr)	110 (in/hr)	1100 (in/hr)	Q2 (cfs)	Q10 (cfs)	Q100 (cfs)	COMMENT
А	2574.5	0.06	0.89	0.54	0.91	12.0	1.76	2.85	4.58	0.09	0.09	0.25	DRAINS TO AREA "E"
В	716.0	0.02	0.89	0.54	0.91	12.0	1.76	2.85	4.58	0.03	0.03	0.07	DRAINS TO AREA "E"
С	23436.8	0.54	0.75	50.00	0.50	12.0	1.76	2.85	4.58	0.71	76.67	1.23	DRAINS TO SOUTHWEST TOWARDS EXISTING DETENTION AREA
D	15852.9	0.36	0.76	0.51	0.84	12.0	1.76	2.85	4.58	0.49	0.53	1.40	DRAINS TO COORS BOULEVARD NW
E	12613.0	0.29	0.28	0.39	0.60	12.0	1.76	2.85	4.58	0.14	0.32	0.80	DRAINS TO INLET "1"
TOTAL	55193.1	1.27								1.46	77.64	3.74	

CALCULATIONS ARE BASED ON THE RATIONAL METHOD FROM CITY OF ALBUQUERQUE DEVELOPMENT PROCESS MANUAL CHAPTER 6 - DRAINAGE, FLOOD CONTROL AND EROSION CONTROL DATED 06/08/2020

	COMPOSITE ANALYSIS FOR RUNOFF COEFFICIENT										
DRAINAGE ID	PERCENT IMPERVIOUS	PERCENT PERVIOUS	C IMPERVIOUS (2 year)	C PERVIOUS (2 year)	C IMPERVIOUS (10 year)	C PERVIOUS (10 year)	C IMPERVIOUS (100 year)	C PERVIOUS (100 year)	COMPOSITE C (2 year)	COMPOSITE C (10 year)	COMPOSITE C (100 year)
А	100.0	0.0	0.89	0.08	0.54	0.34	0.91	.50	0.89	0.54	0.91
В	100.0	0.0	0.89	0.08	0.54	0.34	0.91	.50	0.89	0.54	0.91
С	82.2	17.8	0.89	0.08	0.54	0.34	0.91	.50	0.75	0.50	0.84
D	83.7	16.3	0.89	0.08	0.54	0.34	0.91	.50	0.76	0.51	0.84
E	25.0	75.0	0.89	0.08	0.54	0.34	0.91	.50	0.28	0.39	0.60

SWQV= 0.26 x NEW IMPERVIOUS AREA x 1/12 SWQV= $0.26 \times 21,342 \text{ SQ. FT. } \times 1/12$ SWQV=462.41 CU. FT. PAYMENT-IN-LIEU= SWQV x \$8.00/CU. FT. PAYMENT-IN-LIEU=462.41 CU. FT. x \$8.00/CU. FT. PAYMENT-IN-LIEU= \$3699.28 REQUEST PAYMENT-IN-LIEU FOR PUBLIC OFF-SITE MITIGATION

WEIG	WEIGHTED ANALYSIS FOR 6-HOUR EXCESS PRECIPITATION, 'E'									
DRAINAGE ID	LAND TREATMENT B	LAND TREATMENT D	AREA LAND TREATMENT B	AREA LAND TREATMENT D	WEIGHTED E (100 year) (IN)	VOLUME (100 year) (ACRE-FT)				
А	0.86	2.58	0.000	0.060	2.580	0.045				
В	0.86	2.58	0.000	0.020	2.580	0.009				
С	0.86	2.58	0.076	0.462	2.338	0.055				
D	0.86	2.58	0.028	0.3363	2.449	0.016				
E	0.86	2.58	0.249	0.0405	1.101	0.007				
				TOTAL \	0.132					

Planning Department
Development Review Services **HYDROLOGY SECTION APPROVED** DATE: 03/18/21
BY: Brisselte
HydroTrans # C13D035

!!! CAUTION !!!

UNDERGROUND UTILITIES

EXISTING UTILITIES AND UNDERGROUND FACILITIES INDICATED ON THESE PLANS HAVE BEEN LOCATED FROM REFERENCE INFORMATION SUPPLIED BY VARIOUS PARTIES. THE ENGINEER DOES NOT ASSUME THE RESPONSIBILITY FOR THE UTILITY LOCATIONS SHOWN. IT SHALL BE THE SOLE RESPONSIBILITY OF THE CONTRACTOR(S) TO VERIFY THE HORIZONTALLY AND VERTICALLY LOCATION OF ALL UTILITIES AND UNDERGROUND FACILITIES PRIOR TO CONSTRUCTION, TO TAKE PRECAUTIONS IN ORDER TO PROTECT ALL FACILITIES ENCOUNTERED AND NOTIFY THE ENGINEER OF ALL CONFLICTS OF THE WORK WITH EXISTING FACILITIES. THE CONTRACTOR SHALL PROTECT AND MAINTAIN ALL UTILITIES FROM DAMAGE DURING CONSTRUCTION. ANY DAMAGE BY THE CONTRACTOR TO UTILITIES SHALL BE REPAIRED OR REPLACED BY THE CONTRACTOR AT THEIR OWN EXPENSE.

CALL: NEW MEXICO ONE CALL @ NM 811 AT LEAST 7 DAYS PRIOR TO CONSTRUCTION.

THE BENCHMARKS ARE PROVIDED BASED ON THE ELEVATIONS PROVIDED BY SURVTEK CONSULTING SURVEYORS

ALBUQUERQUE CONTROL SURVEY MONUMENT "DOUGLAS" NEW MEXICO STATE PLANE COORDINATES, CENTRAL ZONE, NAD 83 AS PUBLISHED: N=1505417.495 E=1520286.421 GROUND TO GRID FACTOR=0.999682452, DELTA ALPHA = - 00°13'52.53" ELEVATION=4975.078 NAVD88

ALBUQUERQUE CONTROL SURVEY MONUMENT "13_C15" NEW MEXICO STATE PLANE COORDINATES, CENTRAL ZONE, NAD 83 AS PUBLISHED: N=1520736.123 E=1527665.310 GROUND TO GRID FACTOR=0.999678880, DELTA ALPHA = - 00°13'02.61"

CONTRACTOR SHALL COORDINATE WITH SURVEYOR FOR BENCHMARKS AND ELEVATIONS PRIOR TO CONSTRUCTION. ENGINEER NOT RESPONSIBLE FOR PROVIDING BENCHMARKS AND BEARINGS.

CALL NM ONE-CALL SYSTEM SEVEN (7) DAYS PRIOR TO ANY EXCAVATION

ELEVATION=5008.218 NAVD88

C8.02

PLOT DATE

03/18/21

DRAWING SCALE

PROJECT NUMBER

CDC20021

SHEET NUMBER

Cumulus

MAP

ARE,


AGE


DRAIN,

26 0F

<u></u> ≻L

\\SERVER-PC\SERVER\2020 CDC PROJECTS\CDC20021 - COORS BLVD AND PASEO\PLANS\PROPOSED DRAINAGE AREA MAP CDC20021.DWG

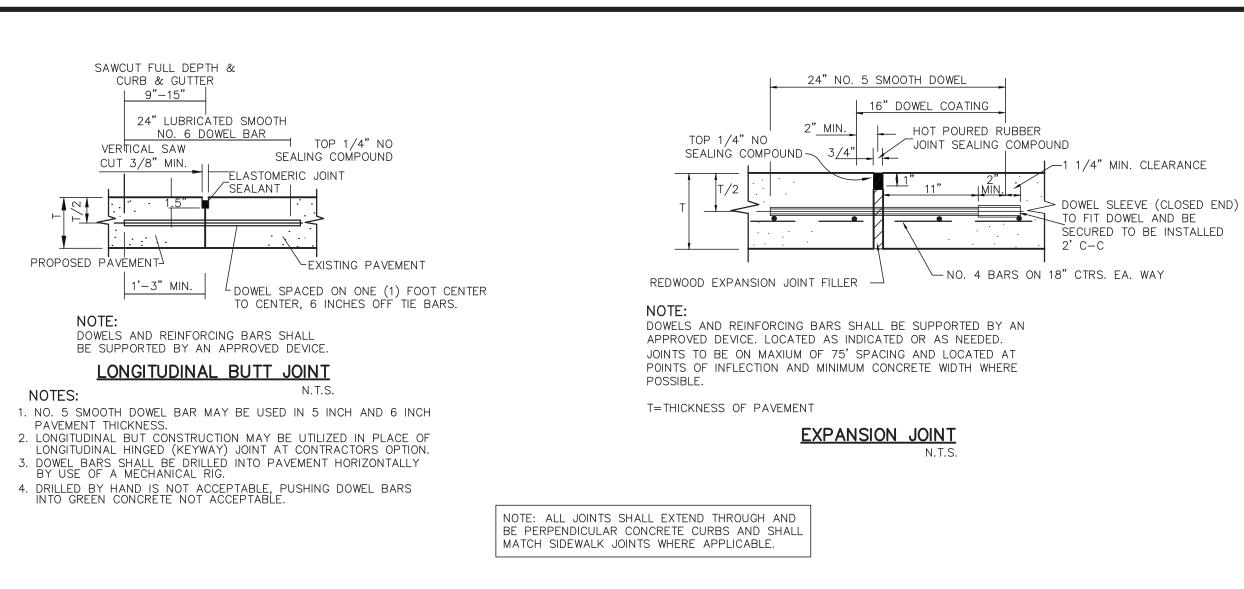

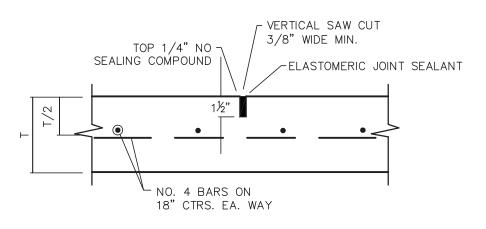

SAWED DUMMY (CONTROL) JOINT

PROPOSED—XYW 4-#4

GRADE

A-#4

#4 @ 16" OC


TURN DOWN CURB DETAIL


PROPOSED PAVEMENT

PAVEMENT DETAILS

MAXIMUM SPACING IS 15' CENTERS

NOTE:

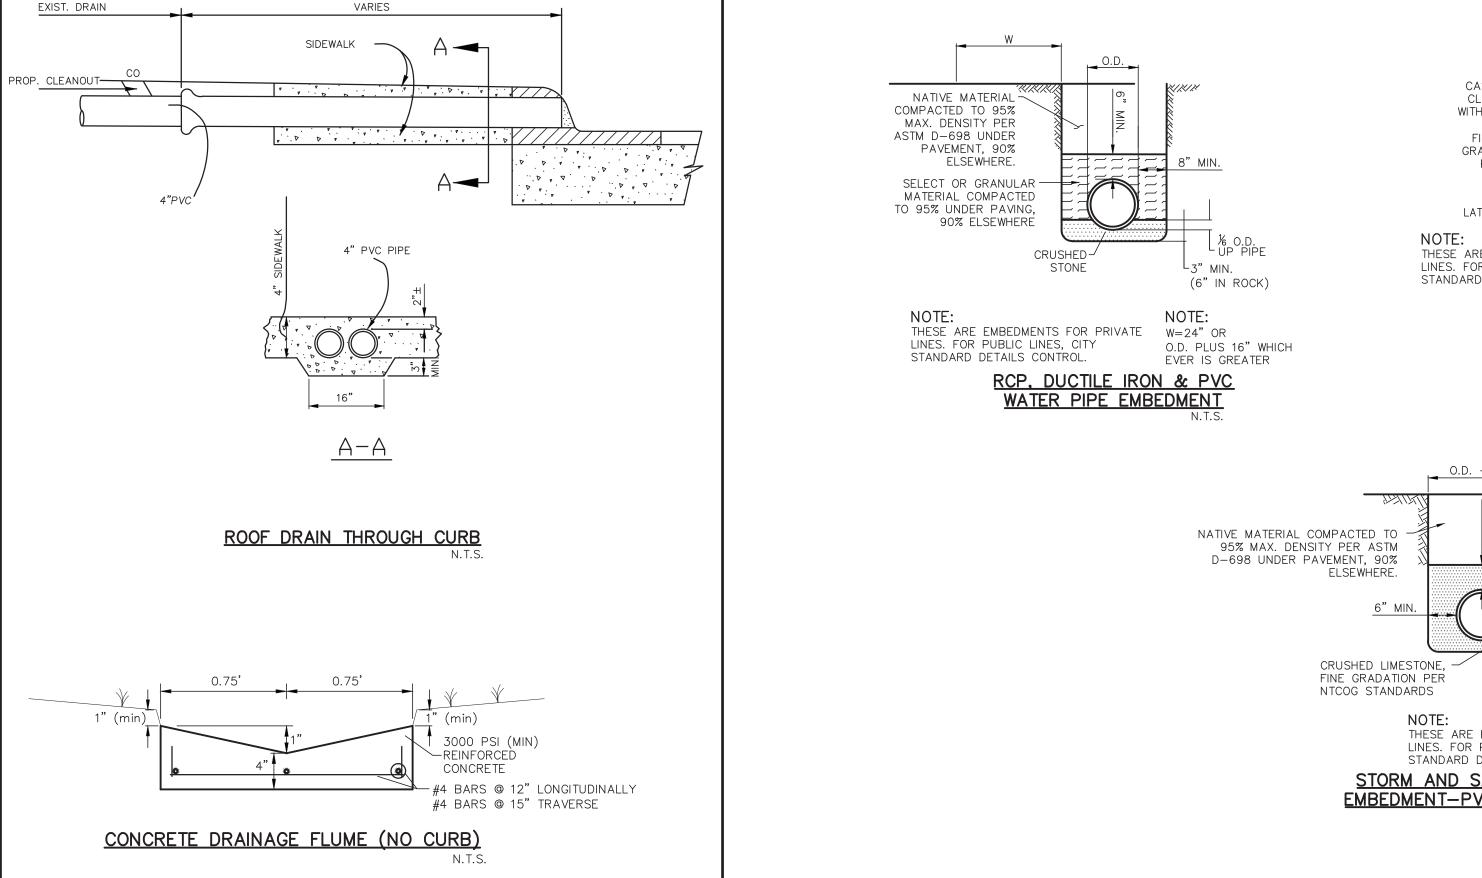

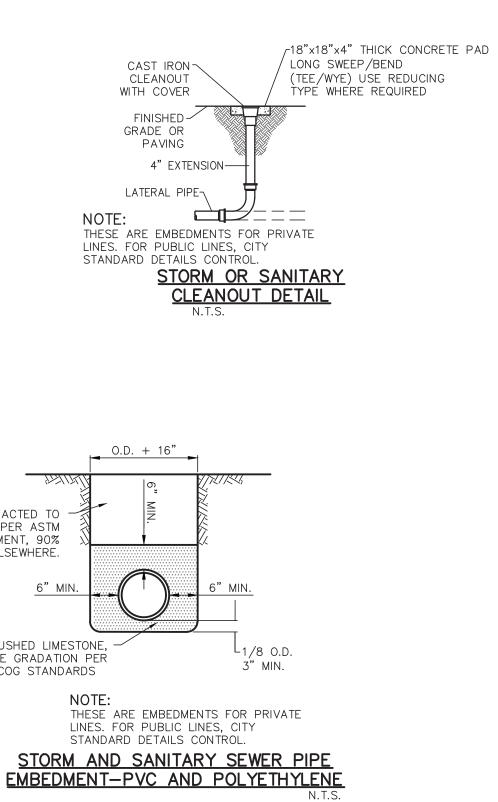

UTILITY DETAILS

GRADE TO PREVENT RUNOFF
FROM LEAVING SITE

PAVED SURFACE

PAVED SURFACE

EXISTING
GRADE

GRADE

PAVED

PAVE

PROFILE VIEW

CONSTRUCTION NOTES — INLET PROTECTION

1. THE CONTRACTOR SHALL PROVIDE ANY ADDITIONAL EROSION OR POLLUTION DEVICES AS REQUIRED DURING THE CONSTRUCTION PHASE IN ORDER TO COMPLETELY CONFORM TO THE UNITED STATES ENVIRONMENTAL PROTECTION AGENCY AND ALL OTHER AGENCIES HAVING JURISDICTION.

2. CONTRACTOR AND OWNER SHALL FILE N.O.I. PER EPA REQUIREMENTS.

TRANSITION TO PAVED SURFACE

3. ONSITE CURB INLET PROTECTION SHALL BE CONSTRUCTED UPON INSTALLATION OF APPLICABLE ON SITE STORM SEWER.


INSTALLATION OF APPLICABLE ON SITE STORM SEWER.

WIRE SCREEN

GRAVEL FILTER

CONCRETE BLOCK

DROP INLET PROTECTION

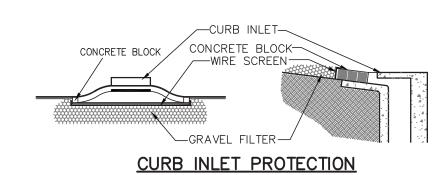

FABRIC

DRAINAGE MUST FLOW AWAY FROM ENTRANCE

PLAN VIEW

1. STONE SHALL BE 3 TO 5 INCH DIAMETER CRUSHED ROCK OR

2. WHEN NECESSARY, VEHICLES SHALL BE CLEANED TO REMOVE SEDIMENT PRIOR TO ENTRANCE ONTO A PUBLIC ROADWAY.

WHEN WASHING IS REQUIRED, IT SHALL BE DONE ON A AREA STABILIZED WITH CRUSHED STONE WITH DRAINAGE FLOWING AWAY

FORM BOTH THE STREET AND THE STABILIZED ENTRANCE. ALL

WILL PREVENT TRACKING OR FLOWING OF SEDIMENT ONTO PAVED

SPILLED, DROPPED, WASHED OR TRACKED ONTO PAVED SURFACES,

4. THE ENTRANCE MUST BE PROPERLY GRADED OR INCORPORATE A

DRAINAGE SWALE TO PREVENT RUNOFF FROM LEAVING THE

STABILIZED CONSTRUCTION ENTRANCE

SURFACES. THIS MAY REQUIRE PERIODIC TOP DRESSING WITH

ADDITIONAL STONE A CONDITIONS DEMAND. ALL SEDIMENT

MUST BE REMOVED IMMEDIATELY.


CONSTRUCTION SITE.

SEDIMENT SHALL BE PREVENTED FROM ENTERING ANY STORM

DRAIN, DITCH OR WATERCOURSE USING APPROVED METHODS.

3. THE ENTRANCE SHALL MAINTAINED IN A CONDITION WHICH

ACCEPTABLE CRUSHED PORTLAND CEMENT CONCRETE.

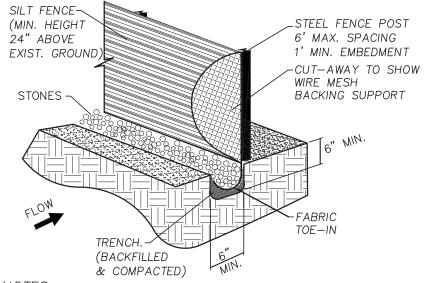

NOTES:

1. STEEL POSTS WHICH SUPPORT THE SILT FENCE SHALL BE INSTALLED ON A SLIGHT ANGLE TOWARD THE ANTICIPATED RUNOFF SOURCE.THE POST MUST BE EMBEDDED A MINIMUM OF ONE FOOT.

2. THE TOE OF THE SILT FENCE SHALL BE TRENCHED IN WITH A SPADE OR MECHANICAL TRENCHER, SO THAT THE DOWNSLOPE FACE OF THE TRENCH IS FLAT AND PERPENDICULAR TO THE LINE OF FLOW. WHERE FENCE CANNOT BE TRENCHED IN (E.G. PAVEMENT), WEIGHT FABRIC FLAP WITH WASHED GRAVEL ON THE UPHILL SIDE TO PREVENT FLOW UNDER FENCE.

3. THE TRENCH MUST BE A MINIMUM OF 6 INCHES DEEP AND 6 INCHES WIDE TO ALLOW FOR THE SILT FENCE FABRIC TO BE LAID IN THE GROUND AND BACKFILLED WITH COMPACTED MATERIAL.


4. SILT FENCE SHALL BE SECURELY FASTENED TO EACH STEEL SUPPORT POST OR TO WOVEN WIRE, WHICH IS IN TURN ATTACHED TO THE STEEL SUPPORT POST.THERE SHALL BE A 6 INCH DOUBLE OVERLAP, SECURELY FASTENED WHERE ENDS OF FABRIC MEET.


5. INSPECTION SHALL BE MADE WEEKLY OR AFTER EACH RAINFALL.REPAIR OR REPLACEMENT SHALL BE MADE PROMPTLY AS NEEDED.


6. SILT FENCE SHALL BE REMOVED WHEN THE SITE IS COMPLETELY STABILIZED SO AS NOT TO BLOCK OR IMPEDE STORM FLOW OR DRAINAGE.

7. ACCUMULATED SILT SHALL BE REMOVED WHEN IT REACHED A DEPTH OF 6 INCHES.THE SILT SHALL BE DISPOSED OF AT AN APPROVED SITE AND IN SUCH A MANNER AS TO NOT CONTRIBUTE TO ADDITIONAL SILTATION.

SILT FENCE

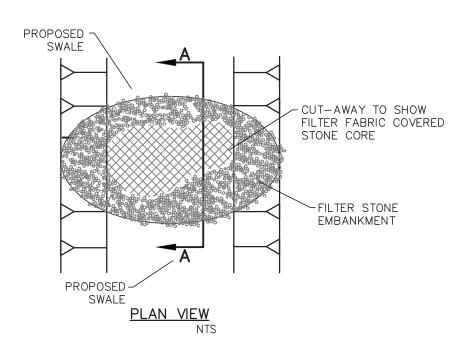

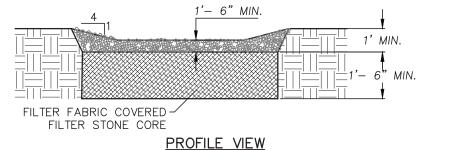

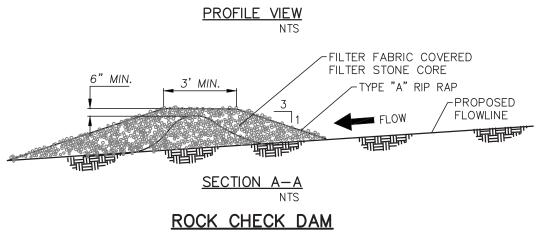


EROSION CONTROL

NOTE

DETAILS ON THIS SHEET ARE PRIVATE. ALL WORK WITHIN PUBLIC EASEMENTS OR RIGHT—OF—WAY SHALL BE PER CITY (OR STATE, IF APPLICABLE) STANDARD DETAILS. THE CONTRACTOR IS REQUIRED TO HAVE ON—SITE, AT ALL TIMES, A COPY OF THE CITY'S CONSTRUCTION DETAILS.

2080 N. Hig Grand Prairi Tel. 214.235

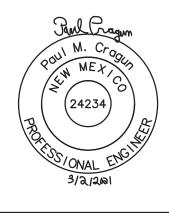

70 INDIAN SCHOOL R F ALBUQUERQUE, NEV BERNALILLO COUNTY

AIL

DE 6670 CITY OF AL



PLOT DATE

02/23/21

DRAWING SCALE

PROJECT NUMBER
CDC20013

SHEET NUMBER

C12.01


DRAINAGE DETAILS











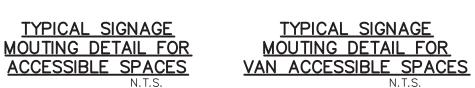

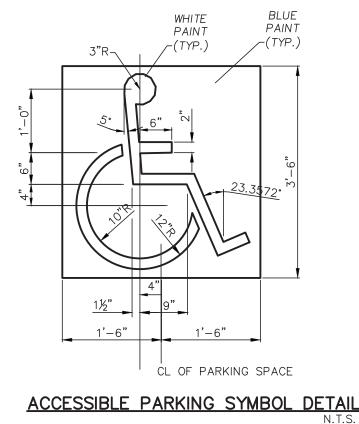

46.0' @ 2.0% MAX

ADA PARKING STALLS AND AISLE DETAIL

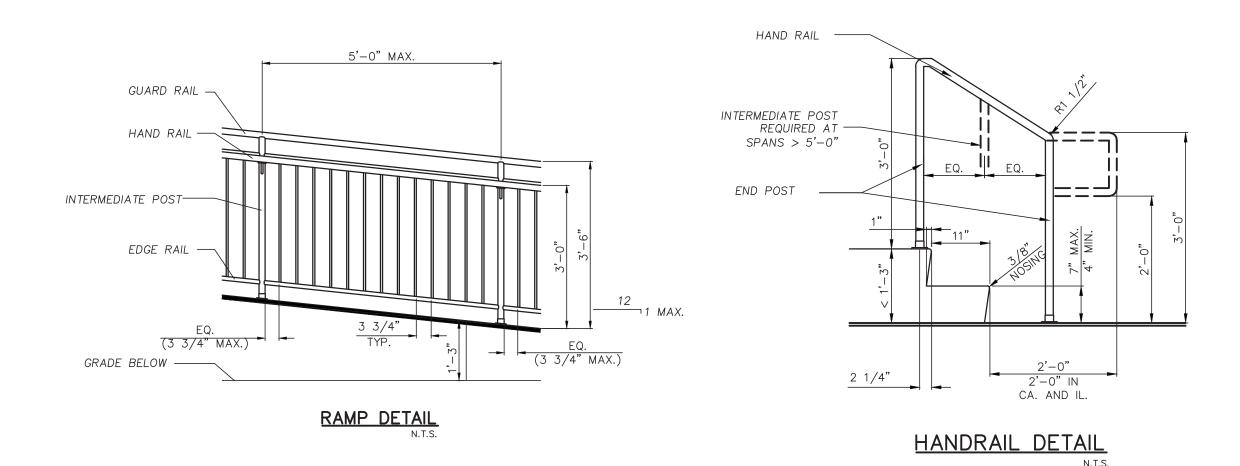




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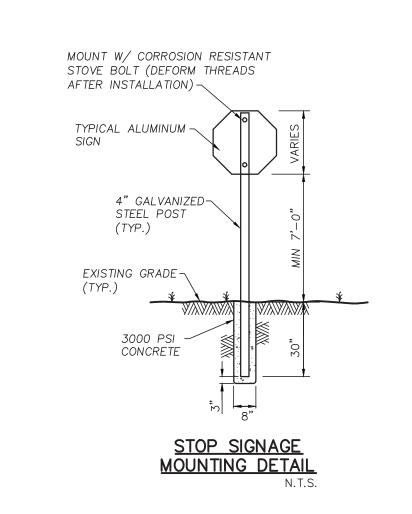






R5 - 1(SIZE: 30"x30")

DO NOT ENTER SIGN




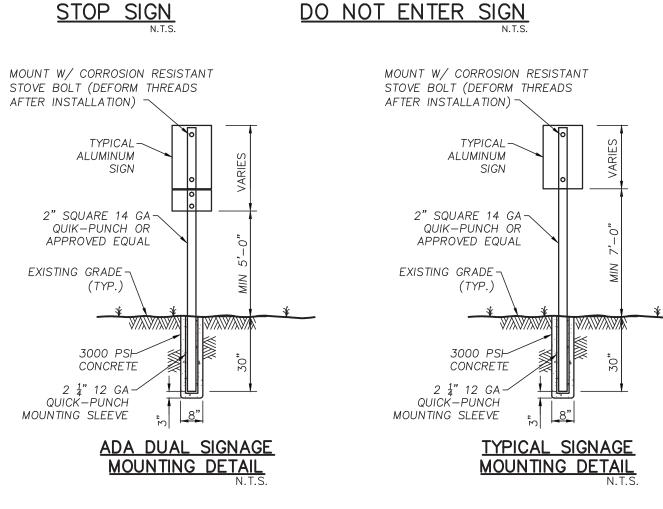


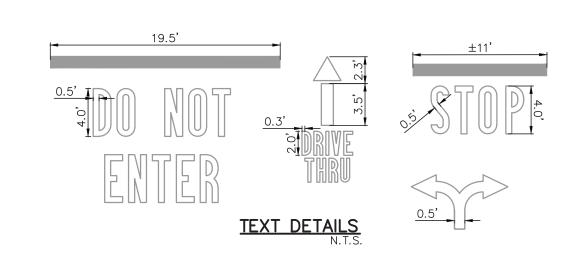


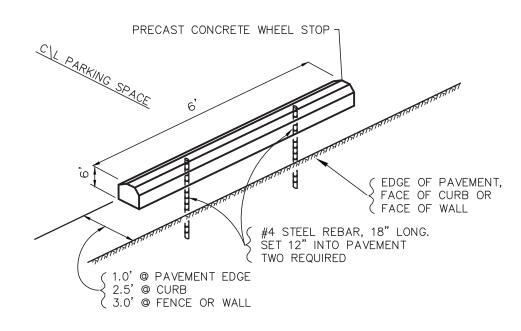



WHEEL STOP DETAIL

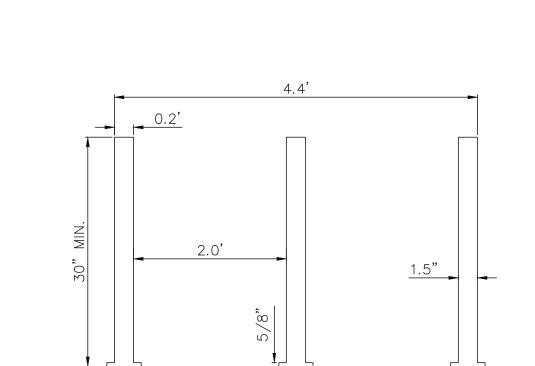

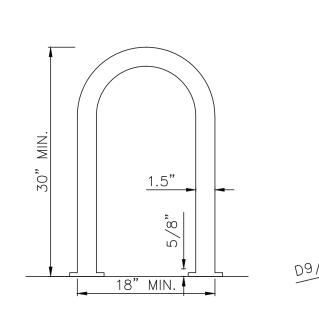


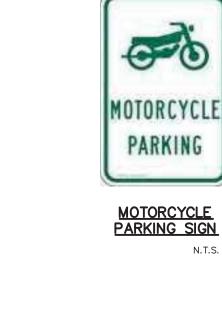

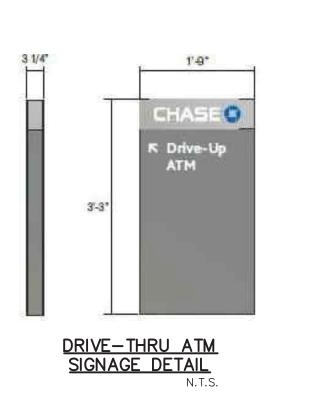

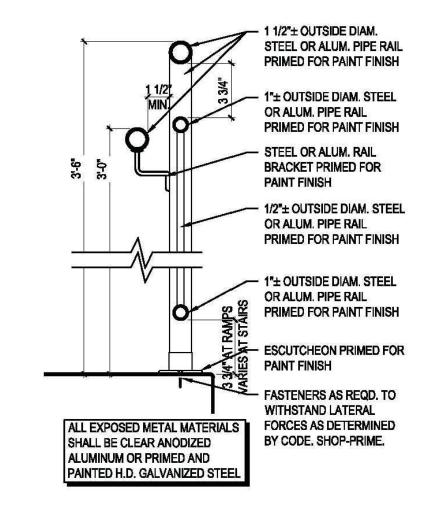

ADA RAMP HAND RAIL DETAIL

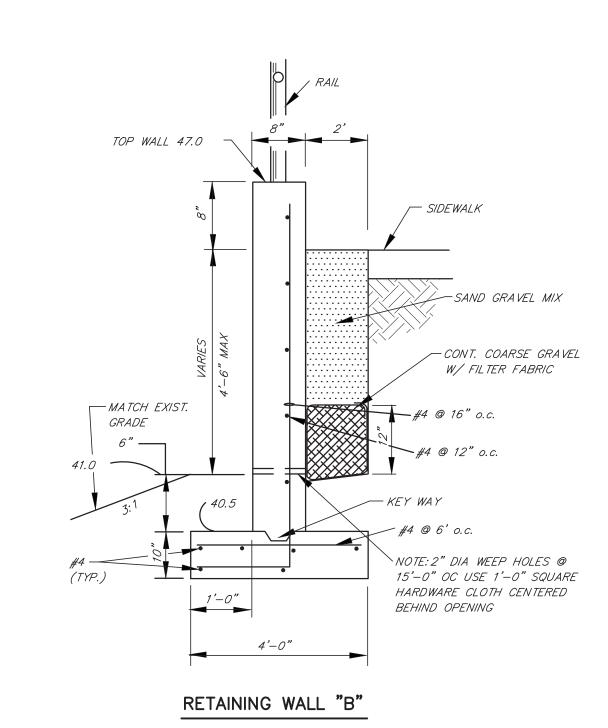

esign

AD MEXICO

70 INDIAN F ALBUQU BERNALIL

PLOT DATE

02/23/21

DRAWING SCALE

PROJECT NUMBER

CDC20013

SHEET NUMBER



BICYCLE RACK DETAIL

MISCELLANEOUS DETAILS

