# CITY OF ALBUQUERQUE

*Planning Department* Alan Varela, Director



Mayor Timothy M. Keller

April 8, 2022

Carlos Iglesias Cumulus Design 2080 N. Highway 360 #240 Grand Prairie, Tx 75050

RE: Chase Bank – Coors 9261 Coors Blvd. NW Grading and Drainage Plan Stamp Date: 3/2/21 Certification Date: 4/4/22 Hydrology File: C13D035

Dear Mr. Iglesias:

PO Box 1293 Based on the resubmittal received on 4/5/22 and site visit on 4/7/22, this certification is approved in support of Release of Permanent Certificate Occupancy by Hydrology.

Albuquerque If you have any questions, please contact me at 924-3986 or earmijo@cabq.gov.

Sincerely,

NM 87103

www.cabq.gov

Ernest Armijo, P.E. Principal Engineer, Planning Dept. Development Review Services



## City of Albuquerque


Planning Department Development & Building Services Division DRAINAGE AND TRANSPORTATION INFORMATION SHEET (REV 11/2018)

Project Title: Chase Bank -Coors Blvd	Building Pe	rmit #: Hydrology File #: C13D035
		Work Order#:
Legal Description: Tract A1A1 Plaza at Pase	eo del Norte	
City Address: 9261 Coors Blvd NW Albuquerq	ue, NM 87114	
Applicant: Cumulus Design		Contact: Carlos Iglesias
Address: 2080 N. Highway 360 #240, Grand Pra	airie, Texas 75050	
Phone#: 214-235-0367	Fax#:	E-mail: carlos@cumulusdesign.net
Owner: JP Morgan Chase Bank		Contact: Sunil Dubey
Address: 7301 North Federal Blvd. Westminster	, Colorado 80030	
Phone#: 720-275-0480	Fax#:	E-mail:
IS THIS A RESUBMITTAL?:Yes X DEPARTMENT:TRAFFIC/ TRANSPORTATION Check all that Apply: TYPE OF SUBMITTAL: X ENGINEER/ARCHITECT CERTIFICATION PAD CERTIFICATION	ORTATION <u>X</u>	
<ul> <li>CONCEPTUAL G &amp; D PLAN</li> <li>GRADING PLAN</li> <li>DRAINAGE MASTER PLAN</li> <li>DRAINAGE REPORT</li> <li>FLOODPLAIN DEVELOPMENT PERMIT APPLIC</li> <li>ELEVATION CERTIFICATE</li> <li>CLOMR/LOMR</li> <li>TRAFFIC CIRCULATION LAYOUT (TCL)</li> <li>TRAFFIC IMPACT STUDY (TIS)</li> <li>OTHER (SPECIFY)</li> <li>PRE-DESIGN MEETING?</li> </ul>		<ul> <li></li></ul>

DATE SUBMITTED: April 04, 2022 By: Carlos Iglesias

ELECTRONIC SUBMITTAL RECEIVED:

FEE PAID:

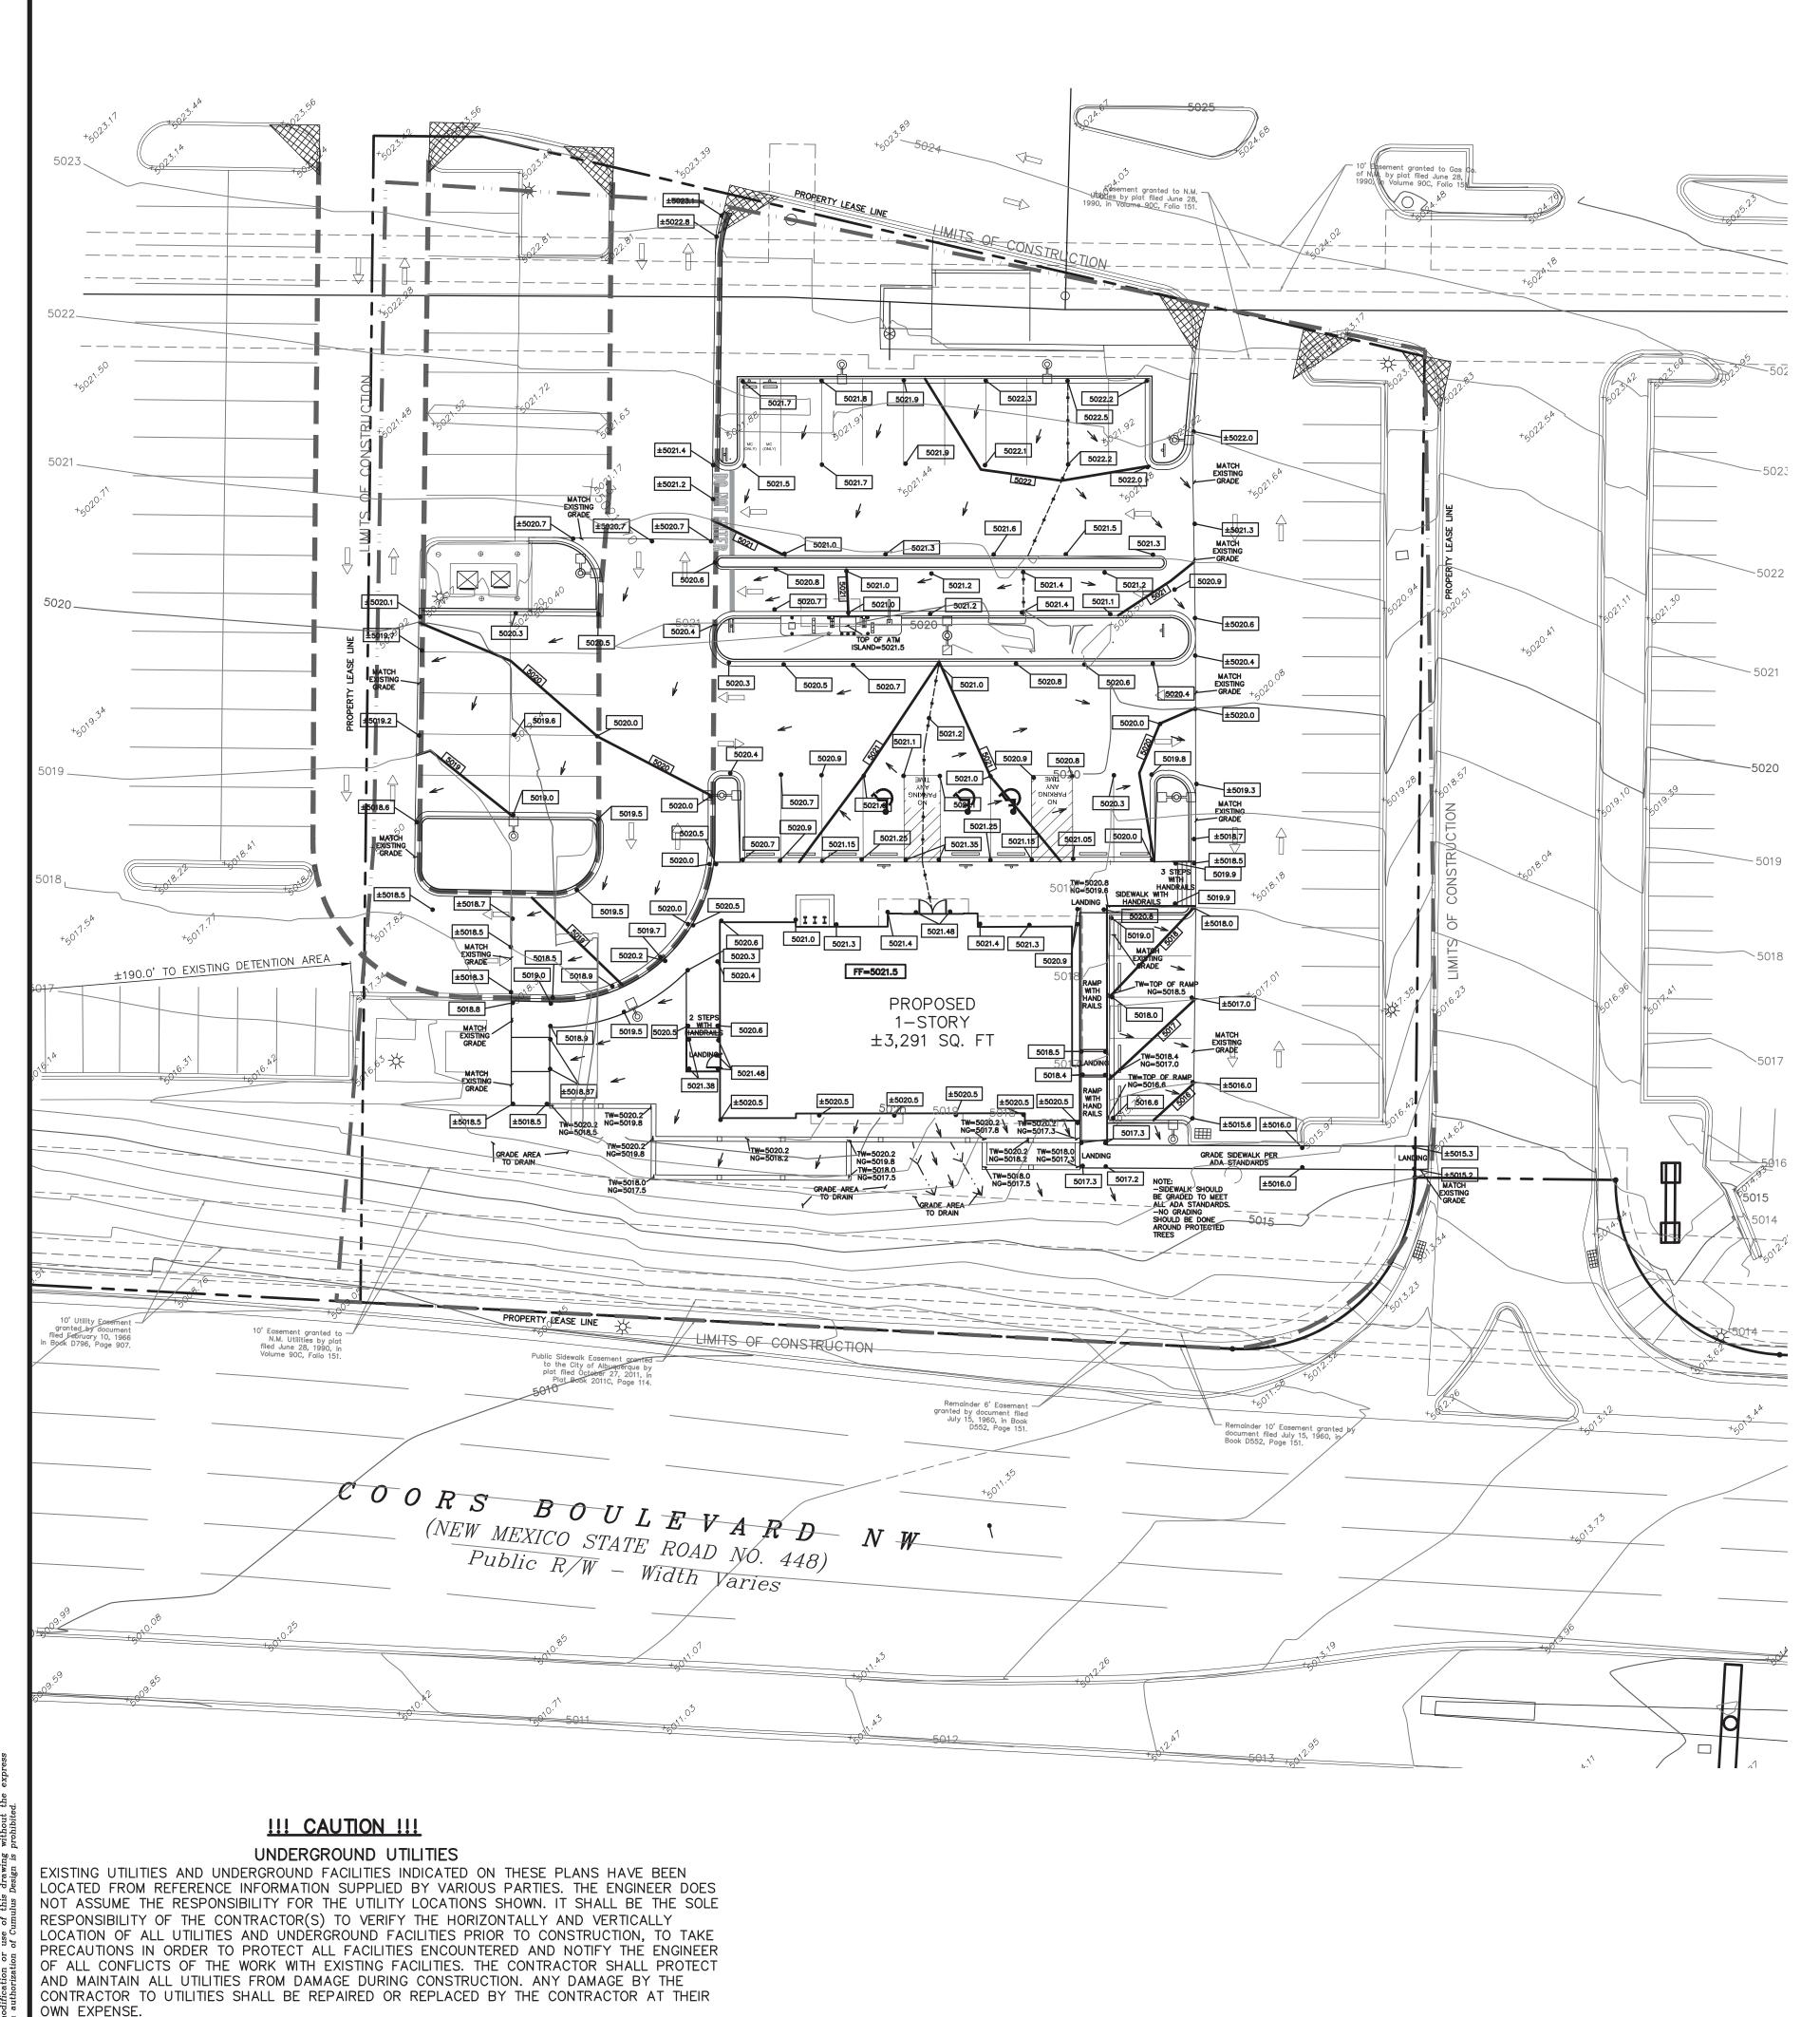

CALL: NEW MEXICO ONE CALL @ NM 811 AT LEAST 7 DAYS PRIOR TO CONSTRUCTION.

\\SERVER-PC\SERVER\2020 CDC PROJECTS\CDC20021 - COORS BLVD AND PASEO\PLANS\GRADING PLAN CDC20021.DWG

### **GRADING NOTES:** . ALL CONSTRUCTION TO BE IN ACCORDANCE WITH THESE PLANS, CITY


- STANDARDS, SPECIFICATIONS FOR PUBLIC WORKS CONSTRUCTION.
- 2. PRIOR TO STARTING CONSTRUCTION, THE CONTRACTOR SHALL MAKE CERTAIN THAT ALL REQUIRED PERMITS AND APPROVALS HAVE BEEN OBTAINED. NO CONSTRUCTION OR FABRICATION SHALL BEGIN UNTIL THE CONTRACTOR HAS RECEIVED AND THOROUGHLY REVIEWED ALL PLANS AND OTHER DOCUMENTS APPROVED BY ALL RESPONSIBLE PARTIES OF THE PERMITTING AUTHORITIES.
- 3. BARRICADING, TRAFFIC CONTROL, AND PROJECT SIGNS SHALL CONFORM TO NEW MEXICO DEPARTMENT OF TRANSPORTATION RULES AND SPECIFICATIONS.
- 4. THE LOCATION OF ALL EXISTING UTILITIES SHOWN ARE BASED ON FIELD SURVEYS AND LOCAL UTILITY COMPANY RECORDS. IT SHALL BE THE CONTRACTOR'S FULL AND SOLE RESPONSIBILITY TO CONTACT THE VARIOUS UTILITY COMPANIES TO LOCATE THEIR UTILITIES PRIOR TO STARTING CONSTRUCTION. ANY DAMAGE TO EXISTING UTILITIES IS TO BE REPAIRED AT CONTRACTOR'S EXPENSE.
- 5. CONTRACTOR SHALL VERIFY ALL EXISTING INVERTS AND RIM ELEVATIONS PRIOR TO CONSTRUCTION. IF CONFLICTS EXIST, THE CONTRACTOR IS TO CONTACT ENGINEER.
- BENCHMARKS HAVE BEEN PROVIDED AS A REFERENCE. IT IS THE CONTRACTOR'S RESPONSIBILITY TO LOCATE, VERIFY, AND/OR ESTABLISH A BENCHMARKS PRIOR TO CONSTRUCTION. IT IS THE CONTRACTOR'S RESPONSIBILITY TO PRESERVE SURVEY STAKES AND MARKERS FOR THE DURATION OF THE PROJECT. IF ANY CONSTRUCTION STAKES OR MARKERS ARE LOST OR DISTURBED AND ARE NEEDED TO BE REPLACED, SUCH REPLACEMENT SHALL BE BY THE SURVEYOR AT THE EXPENSE OF THE CONTRACTOR.
- 7. EROSION CONTROLS SHALL BE IN PLACE PRIOR TO THE DISTURBANCE OF ANY EXISTING SURFACE.
- 8. CONTRACTOR SHALL BE RESPONSIBLE FOR MAINTAINING TRENCH SAFETY REQUIREMENTS IN ACCORDANCE WITH CITY STANDARDS, NEW MEXICO STATE LAW, AND O.S.H.A. STANDARDS FOR ALL EXCAVATION.
- 9. ALL EARTHWORK OPERATIONS SHALL CONFORM TO THE RECOMMENDATIONS PER THE GEOTECHNICAL REPORT.
- 10. DRAINAGE SHOULD BE MAINTAINED AWAY FROM THE FOUNDATIONS, BOTH DURING AND AFTER CONSTRUCTION.
- 11. ALL SIDEWALKS AND ACCESSIBLE ROUTE (INCLUDING HATCHED AREA ACROSS DRIVES) SHALL MAINTAIN A 2% MAXIMUM CROSS SLOPE AND A MAXIMUM 5% IN THE DIRECTION OF PEDESTRIAN TRAVEL.
- 12. SLOPE IN HANDICAP PARKING AREAS SHALL NOT EXCEED 2% IN ANY DIRECTION.
- 13. PROVIDE "FLAT" LANDINGS AT TOP AND BOTTOM OF ALL RAMPS. THESE "FLAT" AREAS SHALL BE 5' LONG AND THE SLOPE SHALL NOT EXCEED 2% IN ANY DIRECTION.
- 14. IT IS THE RESPONSIBILITY OF THE CONTRACTOR TO PROVIDE POSITIVE DRAINAGE AWAY FROM BUILDING AND PARKING AT ALL TIMES.
- 15. SITE GRADING SHALL BE PERFORMED IN A MANNER TO DIRECT WATER AS INDICATED. SURFACE WATER SHALL NOT BE RELEASED ONTO ADJACENT PRIVATE PROPERTY.



SYSTEM SEVEN (7) DAYS PRIOR TO ANY EXCAVATION

— — 671— — <b>[671]</b>
×61 <sup>1.1</sup>
671.76
$\rightarrow$


- <u>LEGEND</u>
- EXISTING CURB - EXISTING CONTOUR
- PROPOSED CONTOUR
- EXISTING SPOT ELEVATION
- PROPOSED SPOT ELEVATION
- DIRECTIONAL FLOW ARROW
- PROPOSED VALLEY

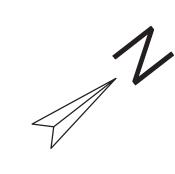




THE EXISTING SITE TOPOGRAPHY WITHIN THE PROPERTY HAS A ±4.3% SLOPE DOWN TOWARDS COORS BOULEVARD NW. AT APPROXIMATELY 40 FEET FROM COORS BOULEVARD RIGHT-OF-WAY THE SLOPE INCREASES TO ±26%. THE SOUTHWESTERN PORTION OF THE EXISTING DEVELOPMENT THE PAVEMENT SLOPES TOWARDS THE SOUTH-WEST TOWARDS AN EXISTING  $\pm 51,000$  CU. FT. DETENTION POND.

THE PROPOSED DEVELOPMENT WILL UTILIZE THE EXISTING SITE TOPOGRAPHY. THE PARKING LOT LOCATED IN THE NORTHERN PORTION OF THE PROPOSED BUILDING WILL RETAIN THE EXISTING SLOPE DOWN TO THE SOUTH-EAST. THE WESTERN PORTION WILL SLOPE TO THE SOUTH-WEST AND DRAIN TOWARDS THE EXISTING DETENTION POND LOCATED  $\pm 190$  FT.

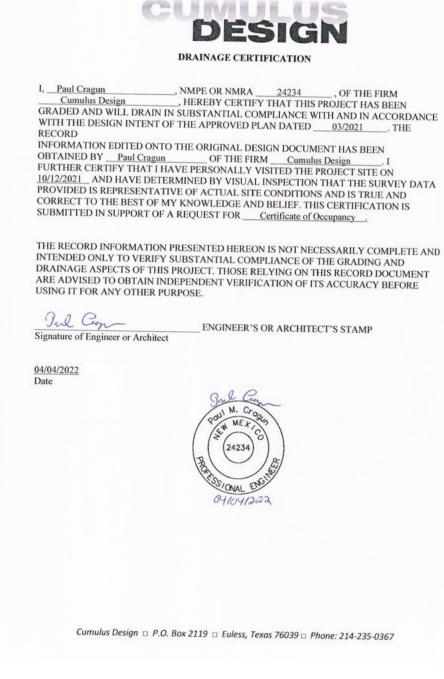

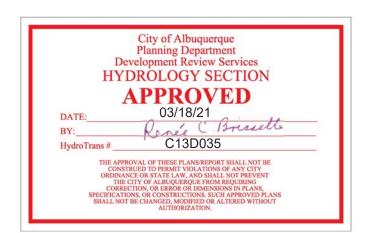

THE BENCHMARKS ARE PROVIDED BASED ON THE ELEVATIONS PROVIDED BY SURVTEK CONSULTING SURVEYORS

# BENCHMARK

ALBUQUERQUE CONTROL SURVEY MONUMENT "DOUGLAS" NEW MEXICO STATE PLANE COORDINATES, CENTRAL ZONE, NAD 83 AS PUBLISHED: N=1505417.495 E=1520286.421 GROUND TO GRID FACTOR=0.999682452, DELTA ALPHA =  $-00^{\circ}13'52.53''$ ELEVATION=4975.078 NAVD88

ALBUQUERQUE CONTROL SURVEY MONUMENT "13\_C15" NEW MEXICO STATE PLANE COORDINATES, CENTRAL ZONE, NAD 83 AS PUBLISHED: N=1520736.123 E=1527665.310 GROUND TO GRID FACTOR=0.999678880, DELTA ALPHA = - 00°13'02.61" ELEVATION=5008.218 NAVD88

CONTRACTOR SHALL COORDINATE WITH SURVEYOR FOR BENCHMARKS AND ELEVATIONS PRIOR TO CONSTRUCTION. ENGINEER NOT RESPONSIBLE FOR PROVIDING BENCHMARKS AND BEARINGS.

PZ Pu -)-С П С Suite 5050 sign \$60, `≏ 7 0 <u>м</u> – м S Ъ S С umulu Ī U 4  $\mathbf{O}$ ⊐ Gr Paul Cragun M. Cro MEX (24234) NW MEXICO  $\Box \ge$ /ARI NE/ AN Z \_\_\_\_ OO Ω 0  $\bigcirc$  $\mathbb{O}$ M  $|\mathsf{O}|$ Ζ COORS ALBUQUE SERNALILL AD GR m \_با ص 0 N S  $\overline{O}$ PLOT DATE 02/23/21 DRAWING SCALE 1" = 20' PROJECT NUMBER CDC20021 SHEET NUMBER C5.01