CITY OF ALBUQUERQUE

Planning Department Alan Varela, Director



Mayor Timothy M. Keller

May 12, 2025

Shawn Biazar, P.E. SBS Construction and Engineering, LLC 7632 William Moyers Avenue, NE Albuquerque, NM 87114

RE: Townhomes 9368 Valley View Dr. NW Grading and Drainage Plan Engineer's Stamp Date: 05-2-2025 Hydrology File: C13D036

Dear Mr. Biazar,

Based upon the information provided in your submittal received 05/06/2025, the Grading & Drainage Plan is approved for Building Permit. Please attach a copy of this approved plan in the construction sets for Building Permit processing along with a copy of this letter.

PO Box 1293 PRIOR TO CERTIFICATE OF OCCUPANCY:

- 1. Engineer's Certification, per the DPM Part 6-14 (F): *Engineer's Certification Checklist For Non-Subdivision* is required.
- 2. Please provide the executed paper Drainage Covenant (latest revision) printed on oneside only with Exhibit A and a check for **\$25.00** made out to "**Bernalillo County**" for the detention ponds per Article 6-15(C) of the DPM to Hydrology for review at Plaza de Sol.

As a reminder, if the project total area of disturbance (including the staging area and any work within the adjacent Right-of-Way) is 1 acre or more, then an Erosion and Sediment Control (ESC) Plan and Owner's certified Notice of Intent (NOI) is required to be submitted to the Stormwater Quality Engineer (Doug Hughes, PE, <u>jhughes@cabq.gov</u>, 924-3420) 14 days prior to any earth disturbance.

If you have any questions, please contact me at 505-924-3314 or amontoya@cabq.gov.

Sincerely,

Albuquerque

NM 87103

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Anthony Montoya, Jr., P.E. Senior Engineer, Hydrology Planning Department, Development Review Services



City of Albuquerque

Planning Department Development & Building Services Division

DRAINAGE AND TRANSPORTATION INFORMATION SHEET (DTIS)

Project Title: 9368 VALLEY VIEW DR., NW	Hydrology File # C13-D036		
Legal Description: TRACT 3F-1-A, BLCK RANCH			
City Address, UPC, OR Parcel: 9368 VALLEY VIEW DR	R., NW		
Applicant/Agent: SBS CONSTRUCTION AND ENG., LLC			
Address: 7632 WILLIAM MOYERS AVE., NE, ALBUQERQUE, NM 8	⁸⁷²² Phone: <u>505-804-5013</u>		
Email: AECLLC@AOL.COM			
Applicant/Owner:	Contact:		
Address:	Phone:		
Email:			
(Please note that a DFT SITE is one that needs Site Plan Ap	pproval & ADMIN SITE is one that does not need it.)		
TYPE OF DEVELOPMENT: PLAT (#of lots)	RESIDENCE		
DFT SITE	ADMIN SITE		
RE-SUBMITTAL: 🖌 YES 🔄 NO			
DEPARTMENT: TRANSPORTATION	HYDROLOGY/DRAINAGE		
Check all that apply under Both the Type of Submittal	and the Type of Approval Sought:		
TYPE OF SUBMITTAL:	TYPE OF APPROVAL SOUGHT:		
ENGINEER/ARCHITECT CERTIFICATION	BUILDING PERMIT APPROVAL		
PAD CERTIFICATION	CERTIFICATE OF OCCUPANCY		
CONCEPTUAL G&D PLAN	CONCEPTUAL TCL DFT APPROVAL		
✔ GRADING & DRAINAGE PLAN	PRELIMINARY PLAT APPROVAL		
DRAINAGE REPORT	FINAL PLAT APPROVAL		
DRAINAGE MASTER PLAN	SITE PLAN FOR BLDG PERMIT DFT		
CLOMR/LOMR	APPROVAL		
TRAFFIC CIRCULATION LAYOUT (TCL) ADMINISTRATIVE	SIA/RELEASE OF FINANCIAL GUARANTEE		
TRAFFIC CIRCULATION LAYOUT FOR DFT	FOUNDATION PERMIT APPROVAL		
APPROVAL	SO-19 APPROVAL		
TRAFFIC IMPACT STUDY (TIS)	PAVING PERMIT APPROVAL		
STREET LIGHT LAYOUT			
OTHER (SPECIFY)	GRADING PAD CERTIFICATION		
	WORK ORDER APPROVAL		
	CLOMR/LOMR		
	OTHER (SPECIFY)		

DATE SUBMITTED: 5-3-2025

Location


This project is located at 9368 Valley View Dr., NW and contains 0.8834 acre. See attached portion of Vicinity Map C-10-Z for exact location.

Purpose and Existing Condition

The purpose of this grading plan is to resolve the drainage issues for the townhouses in the back of property. These buildings have a bedroom window below the finish floor elevation. the windows are about 14" below finish floor of the building.

Proposed Conditions and On-Site Drainage Management Plan

To manage the drainage issus for the windows that are below grade, we propose to provide ponding with riprap by the windows. The bottom of the ponds will be minimum of 10" below the windows with a 4" pipe draining into the proposed pond on site. In addition, we are proposing to install rain gutters in all the buildings that are open and have storm drain pipe installed. For the windows that do not have possibility to install storm drain pipe, we propose to install a roof cover for these buildingS. Please see the notes on each building.

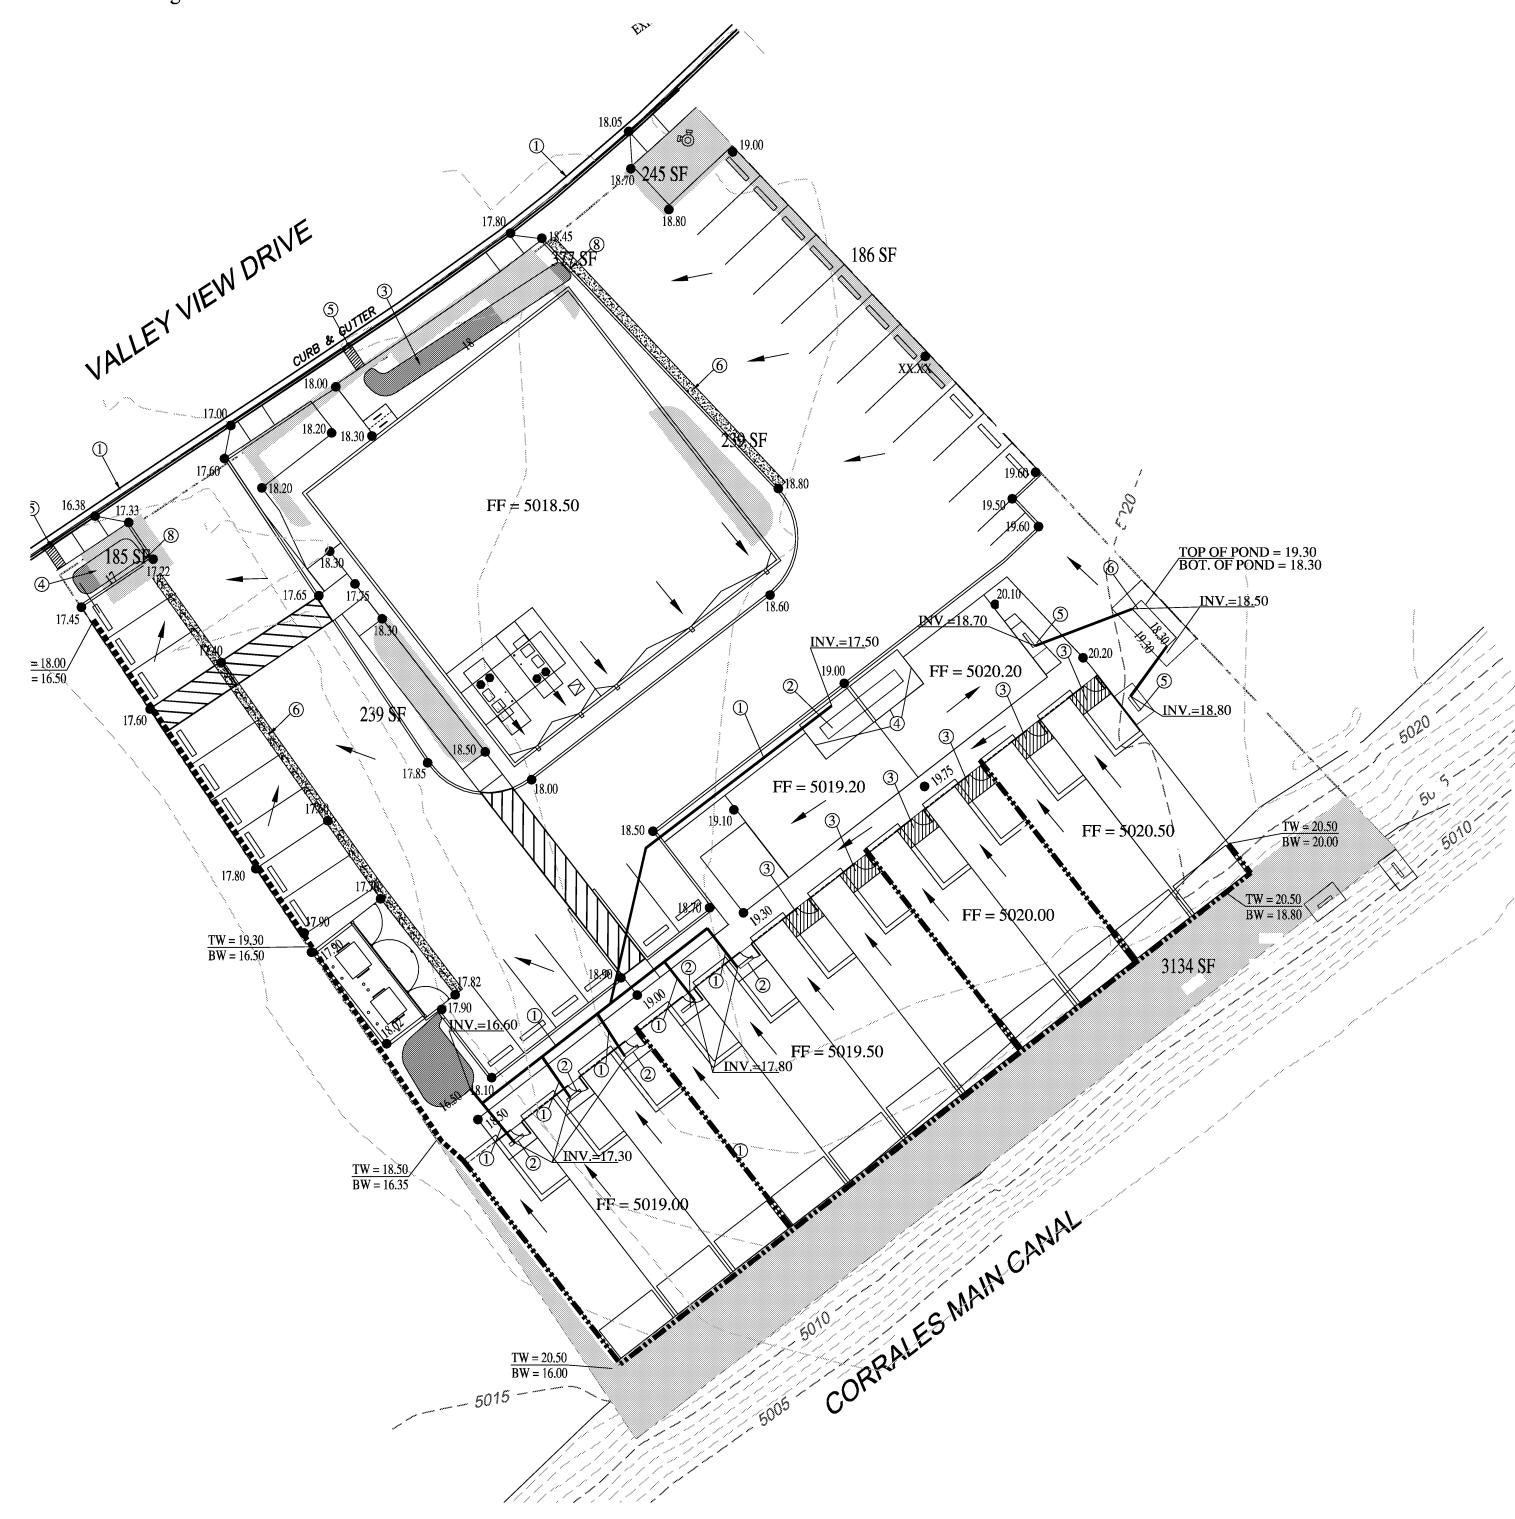

LEGEND

	EXISTING CO
	EXISTING CO
	BOUNDARY L
¥ 28.50	PROPOSED S
∑ 5029.16	EXISTING GRA
× 5075.65 FL	EXISTING FLC
	PROPOSED R
BC=89.08	BOTTOM OF
TF=28.50	TOP OF FOO
TRW=28.00	TOP OF RET
HP	HIGH POINT
86.65 85.47	AS-BUILT GF
x 5325.64 - FF=5326.60 FP=5325.90	AS-BUILT SF

KEYED NOTES:

City of Albuquerque Planning Department Development Review Services

HYDROLOGY SECTION

APPROVED 5/12/2025

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C13D036

THE APPROVAL OF THESE PLANS/REPORTS SHALL NOT BE CONSTRUED TO PERMIT VIOLATIONS OF ANY CITY ORDINANCE OR STATE LAW, AND SHALL NOT PREVENT THE CITY OF ALBUQUERQUE FROM REQUIRING CORRECTIONS FOR ERRORS OR DIMENSIONS IN PLANS, SPECIFICATIONS, OR CONSTRUCTION DOCUMENTS. SUCH APPROVED PLANS/REPORTS SHALL NOT BE CHANGED, MODIFIED OR ALTERED WITHOUT AUTHORIZATION.

THE APPROVAL OF THESE PLANS/REPORTS SHALL EXPIRE TWO (2) YEARS AFTER THE APPROVAL DATE IF NO BUILDING PERMIT HAS BEEN PULLED ON THE DEVELOPMENT.

DATE:

HydroTrans #

- PROVIDE PONDING WITH RIPRAP. BOTTOM OF PONDTO BE MIN. 10" BELOW THE WINDOW. PROVIDE RAIN GUTTERS AT EDGE OF BUILDING.
- (2) INSTALL 4" PVC STORM DRAIN PIPE.
- ③ INSTALL ROOF COVER IN THIS AREA.
- (4) INSTALL RAIN GUTTER AT THE EDGE.
- (5) INSTALL RAIN GUTTER AT THE EDGE. OF PONDTO BE MIN. 10" BELOW THE WINDOW.
- 6 INSTALL A NEW POND.

KISTING CONTOUR (MAJOR) KISTING CONTOUR (MINOR) OUNDARY LINE ROPOSED SPOT ELEVATION KISTING GRADE

KISTING FLOWLINE ELEVATION

ROPOSED RETAINING WALL


OTTOM OF CHANEL

OP OF FOOTING

OP OF RETAINING WALL

S-BUILT GRADES

S-BUILT SPOT ELEVATIONS

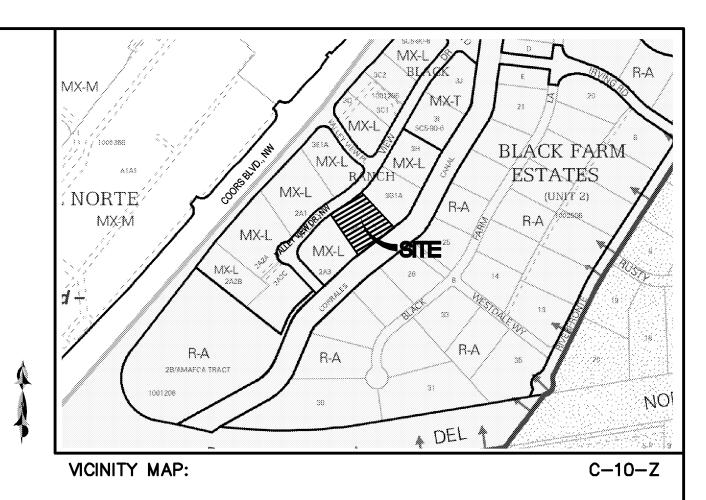

LEGAL DESCRIPTION: TRACT 3F-1-A, BLACK RANCH

ADDRESS: 9836 VALLEY VIEW DR., NW

BENCHMARK

CITY BNCHMARK 10_D10, ELEVATION OF 5322.212 FEET ABOVE SEA LEVEL.

EROSION CONTROL PLAN

AND POLLUTION PREVENTION NOTES 1. CONTRACTOR IS RESPONSIBLE FOR OBTAINING A TOPSOIL

- DISTURBANCE PERMIT PRIOR TO BEGINNING WORK. 2. CONTRACTOR IS RESPONSIBLE FOR CLEANING ALL SEDIMENT
- OUT OF EXISTING RIGHT-OF-WAY. 3. CONTRACTOR IS RESPONSIBLE FOR MAINTAINING ALL STORM
- RUNOFF ON SITE. 4. REPAIR OF DAMAGED FACILITIES AND CLEAN-UP OF SEDIMENT ACCUMULATION ON ADJACENT PROPERTIES AND IN PUBLIC
- FACILITIES IS THE RESPONSIBILITY OF THE CONTRACTOR. 5. ALL EXPOSED EARTH SURFACES MUST BE PROTECTED FROM WIND AND WATER EROSION PRIOR TO FINAL ACCEPTANCE OF ANY PROJECT.



LAST REVIS

GRAPHIC SCALE

SCALE: 1"=20'

SBS CONSTRUCTION AND ENGINEERING, LLC

7632 WILLIAM MOYERS AVE., NE ALBUQUERQUE, NEW MEXICO 87122 (505)804-5013

9368 VALLEY VIEW DR, N.W. GRADING PLAN

	DRAWING:	DRAWN BY:	DATE:	SHEET #			
	202402-GD.DWG	SH-B	2-28-2024	1			
ON: 03-01-2024							
511. 05-01-2024							