
CITY OF ALBUQUERQUE

Planning Department Alan Varela, Director

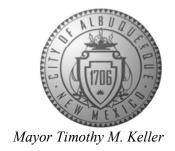

July 14, 2025

Shawn Biazar, P.E. SBS Construction and Engineering, LLC 7632 William Moyers Avenue, NE Albuquerque, NM 87114

RE: Valley View Townhomes

9368 Valley View Drive NW – Phase 2 Temporary Certificate of Occupancy Engineer's Certification Date: 07/5/2025 Engineer's Stamp Date: 05/2/2025

Hydrology File: C13D036 Case # HYDR-2025-00245

Dear Mr. Biazar:

PO Box 1293

Based on the Engineer's Grading and Drainage Certification for Phase 2 received 7/10/2025 and site visit on 7/14/2025, this letter serves as a conditional approval from the Hydrology Section for a 30-day Temporary Certificate of Occupancy for (Phase 2 only) the Valley View Townhomes located at 9368 Valley View NW to be issued by the Building and Safety Division. The following comment needs to be addressed prior to acceptance for Permanent C.O. of the above referenced project:

Albuquerque

NM 87103

www.cabq.gov

 Please provide the Drainage Covenant with Exhibit A for the stormwater quality ponds per Article 6-15(C) of the DPM prior to Permanent Release of Occupancy. Please submit the original copies along with the \$ 25.00 recording fee check made payable to Bernalillo County to Hydrology. The Drainage Covenant and Exhibit will also be required to be uploaded to the ABQ-PLAN system.

Please resubmit for a request for permanent release of Certificate of Occupancy once the above items are complete.

If you have any questions, please contact me at 505-924-3314 or <u>amontoya@cabq.gov</u>.

Sincerely,

Anthony Montoya, Jr., P.E., CFM Senior Engineer, Hydrology

anth Mars

Planning Department, Development Review Services



City of Albuquerque

Planning Department
Development & Building Services Division

DRAINAGE AND TRANSPORTATION INFORMATION SHEET (DTIS)

Project Title:			Hydrology File #	
Legal Description:				
City Address, UPC, OR	R Parcel:			
Applicant/Agent:			Contact:	
Address:			Phone:	
Email:				
Applicant/Owner:			Contact:	
			Phone:	
Email:				
(Please note that a DFT S	ITE is on	e that needs Site Plan A	Approval & ADMIN SITE is one that does not need i	t.)
TYPE OF DEVELOPM	ENT:	PLAT (#of lots)	RESIDENCE	
		DFT SITE	ADMIN SITE	
RE-SUBMITTAL:	YES	NO		
DEPARTMENT:	TRANS	SPORTATION	HYDROLOGY/DRAINAGE	
Check all that apply und	ler Both	the Type of Submitta	l and the Type of Approval Sought:	—
TYPE OF SUBMITTA	AL:		TYPE OF APPROVAL SOUGHT:	
ENGINEER/ARCHITECT CERTIFICATION			BUILDING PERMIT APPROVAL	
PAD CERTIFICATION			CERTIFICATE OF OCCUPANCY	
CONCEPTUAL G&D PLAN			CONCEPTUAL TCL DFT APPROVAL	
GRADING & DRAINAGE PLAN			PRELIMINARY PLAT APPROVAL	
DRAINAGE REPORT			FINAL PLAT APPROVAL	
DRAINAGE MASTER PLAN			SITE PLAN FOR BLDG PERMIT DFT	
CLOMR/LOMR			APPROVAL	
TRAFFIC CIRCULATION LAYOUT (TCL) ADMINISTRATIVE		YOUT (TCL)	SIA/RELEASE OF FINANCIAL GUARAN	ГЕЕ
			FOUNDATION PERMIT APPROVAL	
TRAFFIC CIRCULATION LAYOUT FOR DFT APPROVAL TRAFFIC IMPACT STUDY (TIS)			GRADING PERMIT APPROVAL	
			SO-19 APPROVAL	
STREET LIGHT LAYOUT			PAVING PERMIT APPROVAL	
OTHER (SPECIFY)			GRADING PAD CERTIFICATION	
(WORK ORDER APPROVAL	
			CLOMR/LOMR	
			OTHER (SPECIFY)	
ATE CHIDMITTED.				

Location

This project is located at 9368 Valley View Dr., NW and contains 0.8834 acre. See attached portion of Vicinity Map C-10-Z for exact location.

Purpose and Existing Condition

DRAINAGE CERTIFICATION


REZA AFAGHPOUR, NMPE 11814

DATE

The purpose of this grading plan is to resolve the drainage issues for the townhouses in the back of property. These buildings have a bedroom window below the finish floor elevation. the windows are about 14" below finish floor of the building.

Proposed Conditions and On-Site Drainage Management Plan

To manage the drainage issus for the windows that are below grade, we propose to provide ponding with riprap by the windows. The bottom of the ponds will be minimum of 10" below the windows with a 4" pipe draining into the proposed pond on site. In addition, we are proposing to install rain gutters in all the buildings that are open and have storm drain pipe installed. For the windows that do not have possibility to install storm drain pipe, we propose to install a roof cover for these buildingS. Please see the notes on each building.

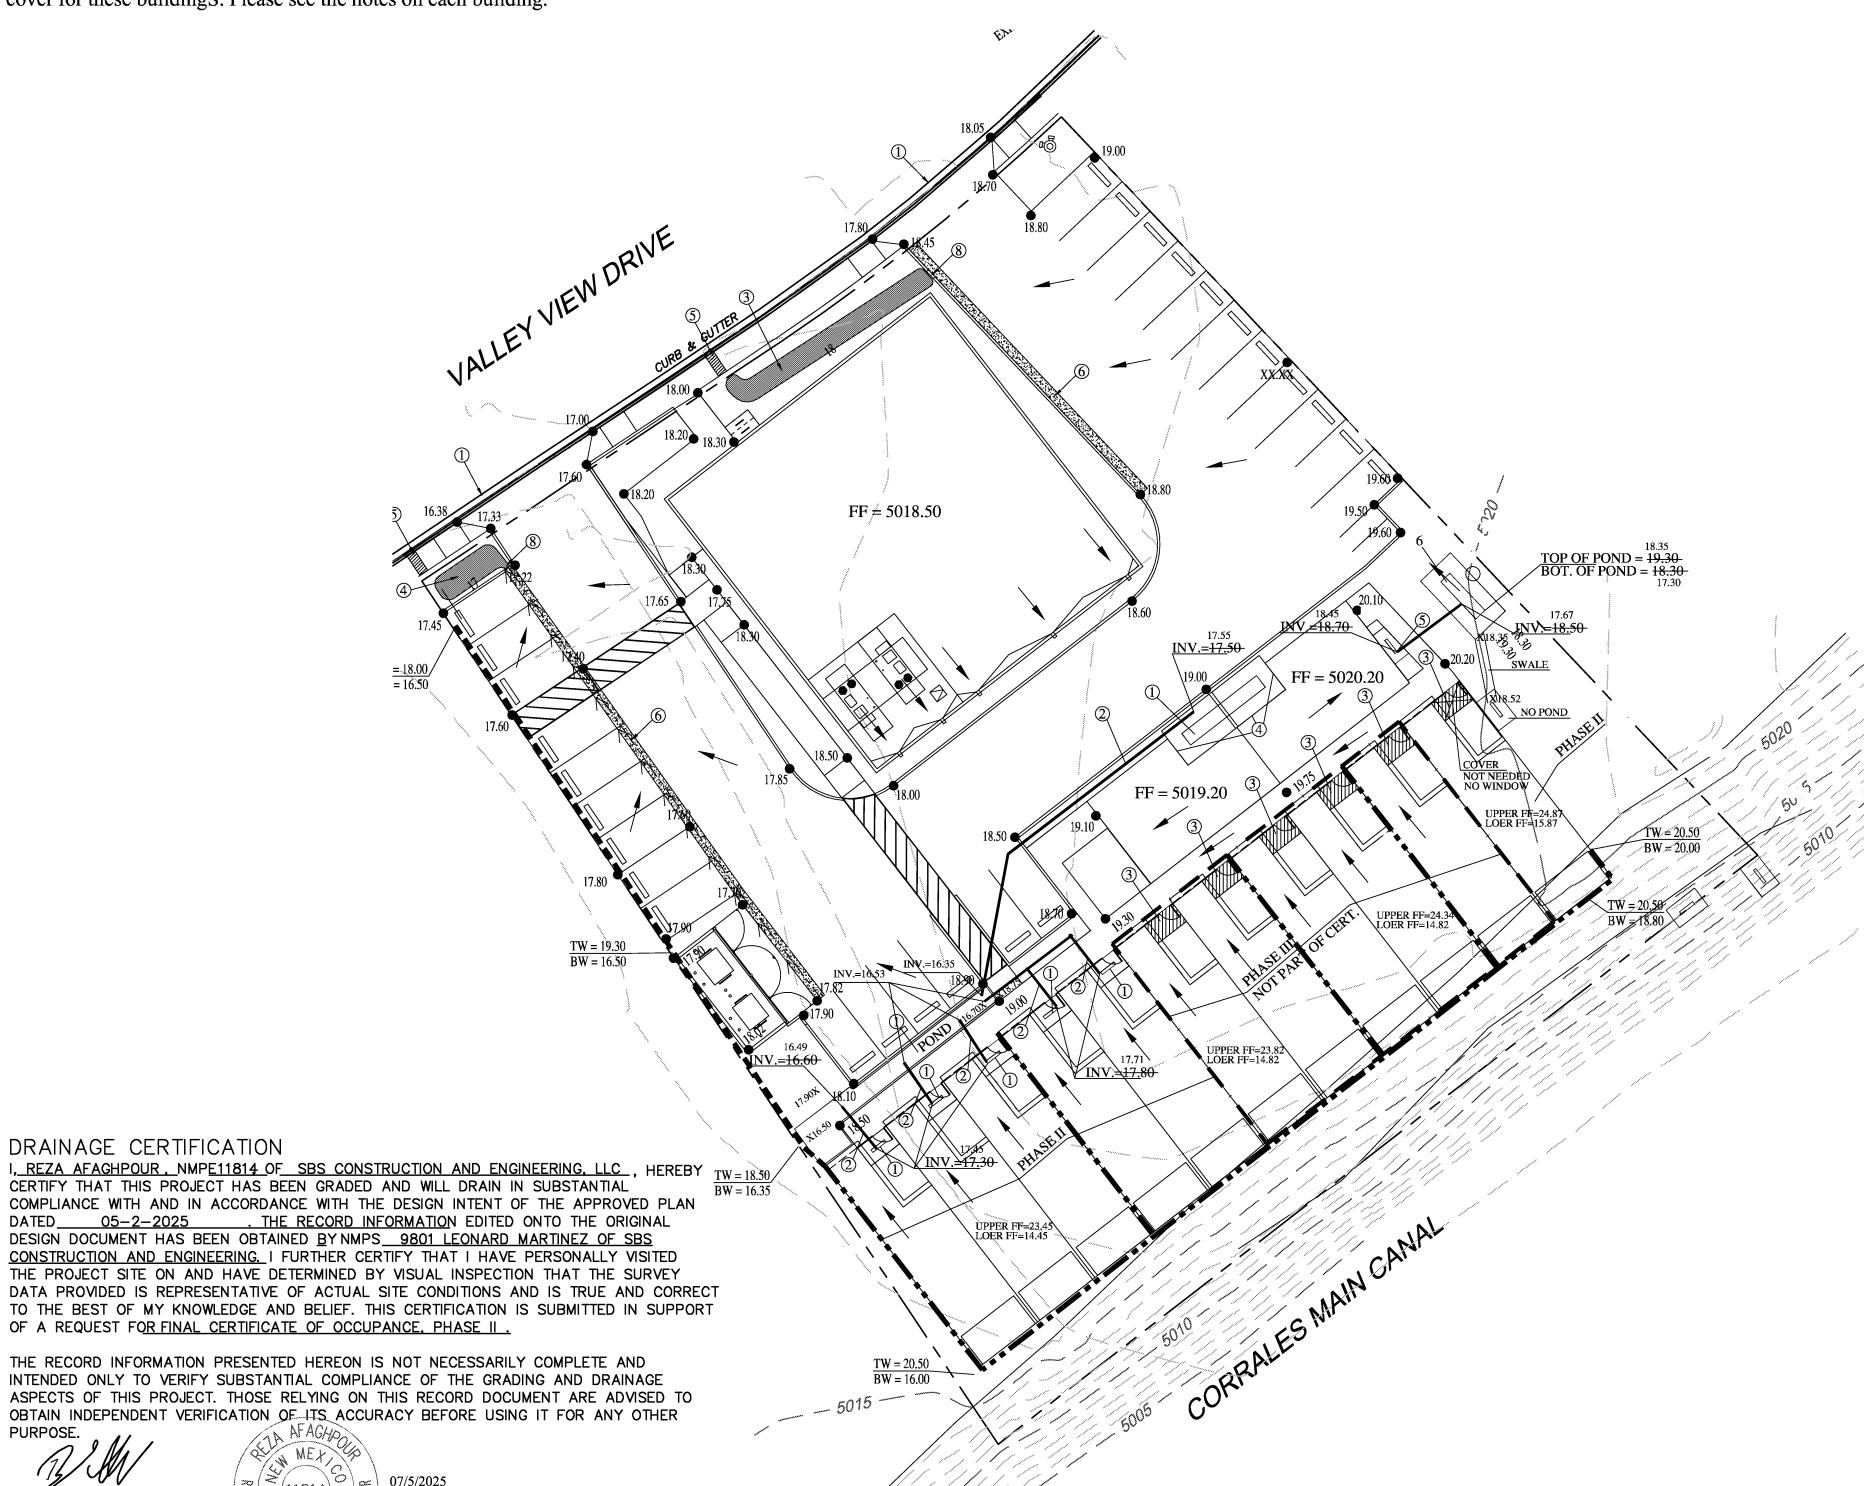

LEGEND

KEYED NOTES:

① PROVIDE PONDING WITH RIPRAP. BOTTOM OF PONDTO BE MIN. 10" BELOW THE WINDOW. PROVIDE RAIN GUTTERS AT EDGE OF BUILDING.

(5) INSTALL RAIN GUTTER AT THE EDGE. OF PONDTO BE MIN. 10" BELOW THE WINDOW.

② INSTALL 4" PVC STORM DRAIN PIPE.

③ INSTALL ROOF COVER IN THIS AREA.

(4) INSTALL RAIN GUTTER AT THE EDGE.

⑥ INSTALL A NEW POND.

— 5030— EXISTING CONTOUR (MAJOR) EXISTING CONTOUR (MINOR) BOUNDARY LINE PROPOSED SPOT ELEVATION X 28.50 EXISTING GRADE × 5075.65 EXISTING FLOWLINE ELEVATION PROPOSED RETAINING WALL BC = 89.08BOTTOM OF CHANEL

TF=28.50 TOP OF FOOTING TRW=28.00 TOP OF RETAINING WALL

HIGH POINT AS-BUILT GRADES

x 5325.64 AS-BUILT SPOT ELEVATIONS FF=5326.60 FP=5325.90

BLACK FARM NORTE DEL 1

VICINITY MAP:

C-10-Z

LEGAL DESCRIPTION:

TRACT 3F-1-A, BLACK RANCH ADDRESS: 9836 VALLEY VIEW DR., NW

BENCHMARK

CITY BNCHMARK 10_D10, ELEVATION OF 5322.212 FEET ABOVE SEA LEVEL.

EROSION CONTROL PLAN AND POLLUTION PREVENTION NOTES

- 1. CONTRACTOR IS RESPONSIBLE FOR OBTAINING A TOPSOIL
- DISTURBANCE PERMIT PRIOR TO BEGINNING WORK. 2. CONTRACTOR IS RESPONSIBLE FOR CLEANING ALL SEDIMENT
- OUT OF EXISTING RIGHT-OF-WAY. 3. CONTRACTOR IS RESPONSIBLE FOR MAINTAINING ALL STORM
- RUNOFF ON SITE. 4. REPAIR OF DAMAGED FACILITIES AND CLEAN-UP OF SEDIMENT ACCUMULATION ON ADJACENT PROPERTIES AND IN PUBLIC
- FACILITIES IS THE RESPONSIBILITY OF THE CONTRACTOR. 5. ALL EXPOSED EARTH SURFACES MUST BE PROTECTED FROM WIND AND WATER EROSION PRIOR TO FINAL ACCEPTANCE OF ANY PROJECT.





7632 WILLIAM MOYERS AVE., NE ALBUQUERQUE, NEW MEXICO 87122 (505)804-5013

GRAPHIC SCALE SCALE: 1"=20'

9368 VALLEY VIEW DR, N.W. **GRADING PLAN**

DRAWN BY: DRAWING: DATE: SHEET# 202402-GD.DWG SH-B 2-28-2024