
C-16-Z

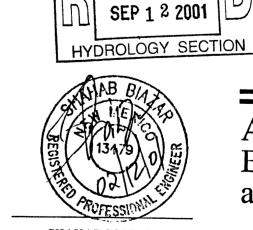

VICINITY MAP:

LEGAL DESCRIPTION:

LOT 47, ALAMEDA BUSINESS PARK

LEGEND

TC — <u>70.90</u> *FL* — <u>70.40</u>

X *70.28*

× 5265.16

EXISTING SAS MANHOLE

EXISTING VALVE W/BOX

EXISTING FIRE HYDRANT

EXISTING AIR RELEASE VALVE

EXISTING METER

EXISTING REDUCER

EXISTING CURB & GUTTER

— EXISTING CONTOUR (MINOR)

PROPOSED SPOT ELEVATION

.005 EXISTING CONTOUR (MAJOR)

PROPOSED GRADE


EXISTING GRADE

----EX. 8" SAS---- EXISTING SANITARY SEWER LINE


---- EX. 16" WL--- EXISTING WATER LINE


======== EXISTING CURB & GUTTER

BOUNDARY LINE

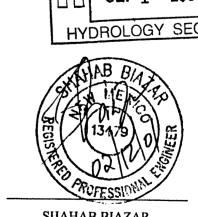




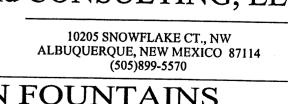


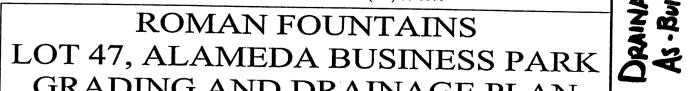

GRADING AND DRAINAGE PLAN DRAWN BY: DATE:

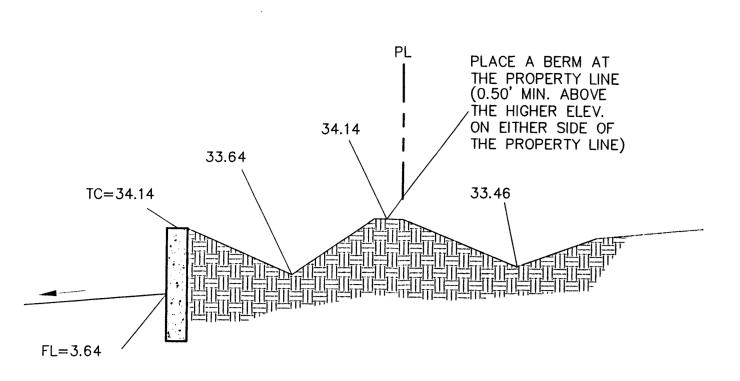

SECTION A-A

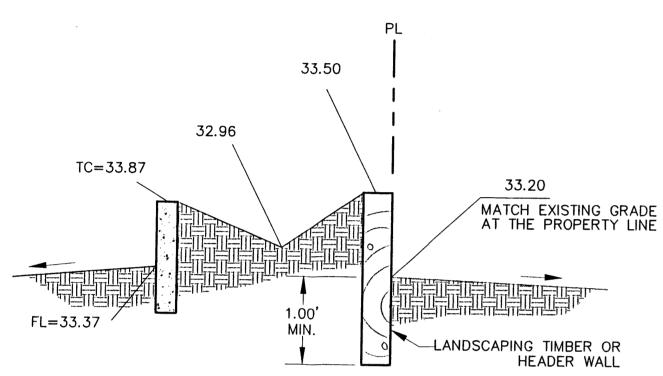

NOTICE TO CONTRACTORS

1. AN EXCAVATION/CONSTRUCTION PERMIT WILL BE REQUIRED BEFORE BEGINNING ANY WORK WITHIN CITY RIGHT-OF-WAY.

2. ALL WORK DETAILED ON THESE PLANS TO BE PERFORMED, EXCEPT AS OTHERWISE STATED OR PROVIDED HEREON, SHALL BE CONSTRUCTED IN ACCORDANCE WITH CITY OF ALBUQUERQUE INTERIM STANDARD SPECIFICATIONS FOR PUBLIC WORKS CONSTRUCTION


3. TWO WORKING DAYS PRIOR TO ANY EXCAVATION, CONTRACTOR MUST CONTACT LINE LOCATING SERVICE, 765-1234, FOR LOCATION OF EXISTING UTILITIES.

4. PRIOR TO CONSTRUCTION, THE CONTRACTOR SHALL EXCAVATE AND VERIFY THE HORIZONTAL AND VERTICAL LOCATIONS OF ALL CONSTRUCTIONS. SHOULD A CONFLICT EXIST, THE CONTRACTOR SHALL NOTIFY THE ENGINEER SO THAT THE CONFLICT CAN BE RESOLVED WITH A MINIMUM AMOUNT OF DELAY.

5. BACKFILL COMPACTION SHALL BE ACCORDING TO TRAFFIC/STREET USE. 6. MAINTENANCE OF THESE FACILITIES SHALL BE THE RESPONSIBILITY OF THE OWNER OF THE PROPERTY SERVED.

7. WORK ON ARTERIAL STREETS SHALL BE PERFORMED ON A 24-HOUR BASIS.

APPROVALS	NAME,	DATE
INSPECTOR	COASD MASS PILL	9/4/01

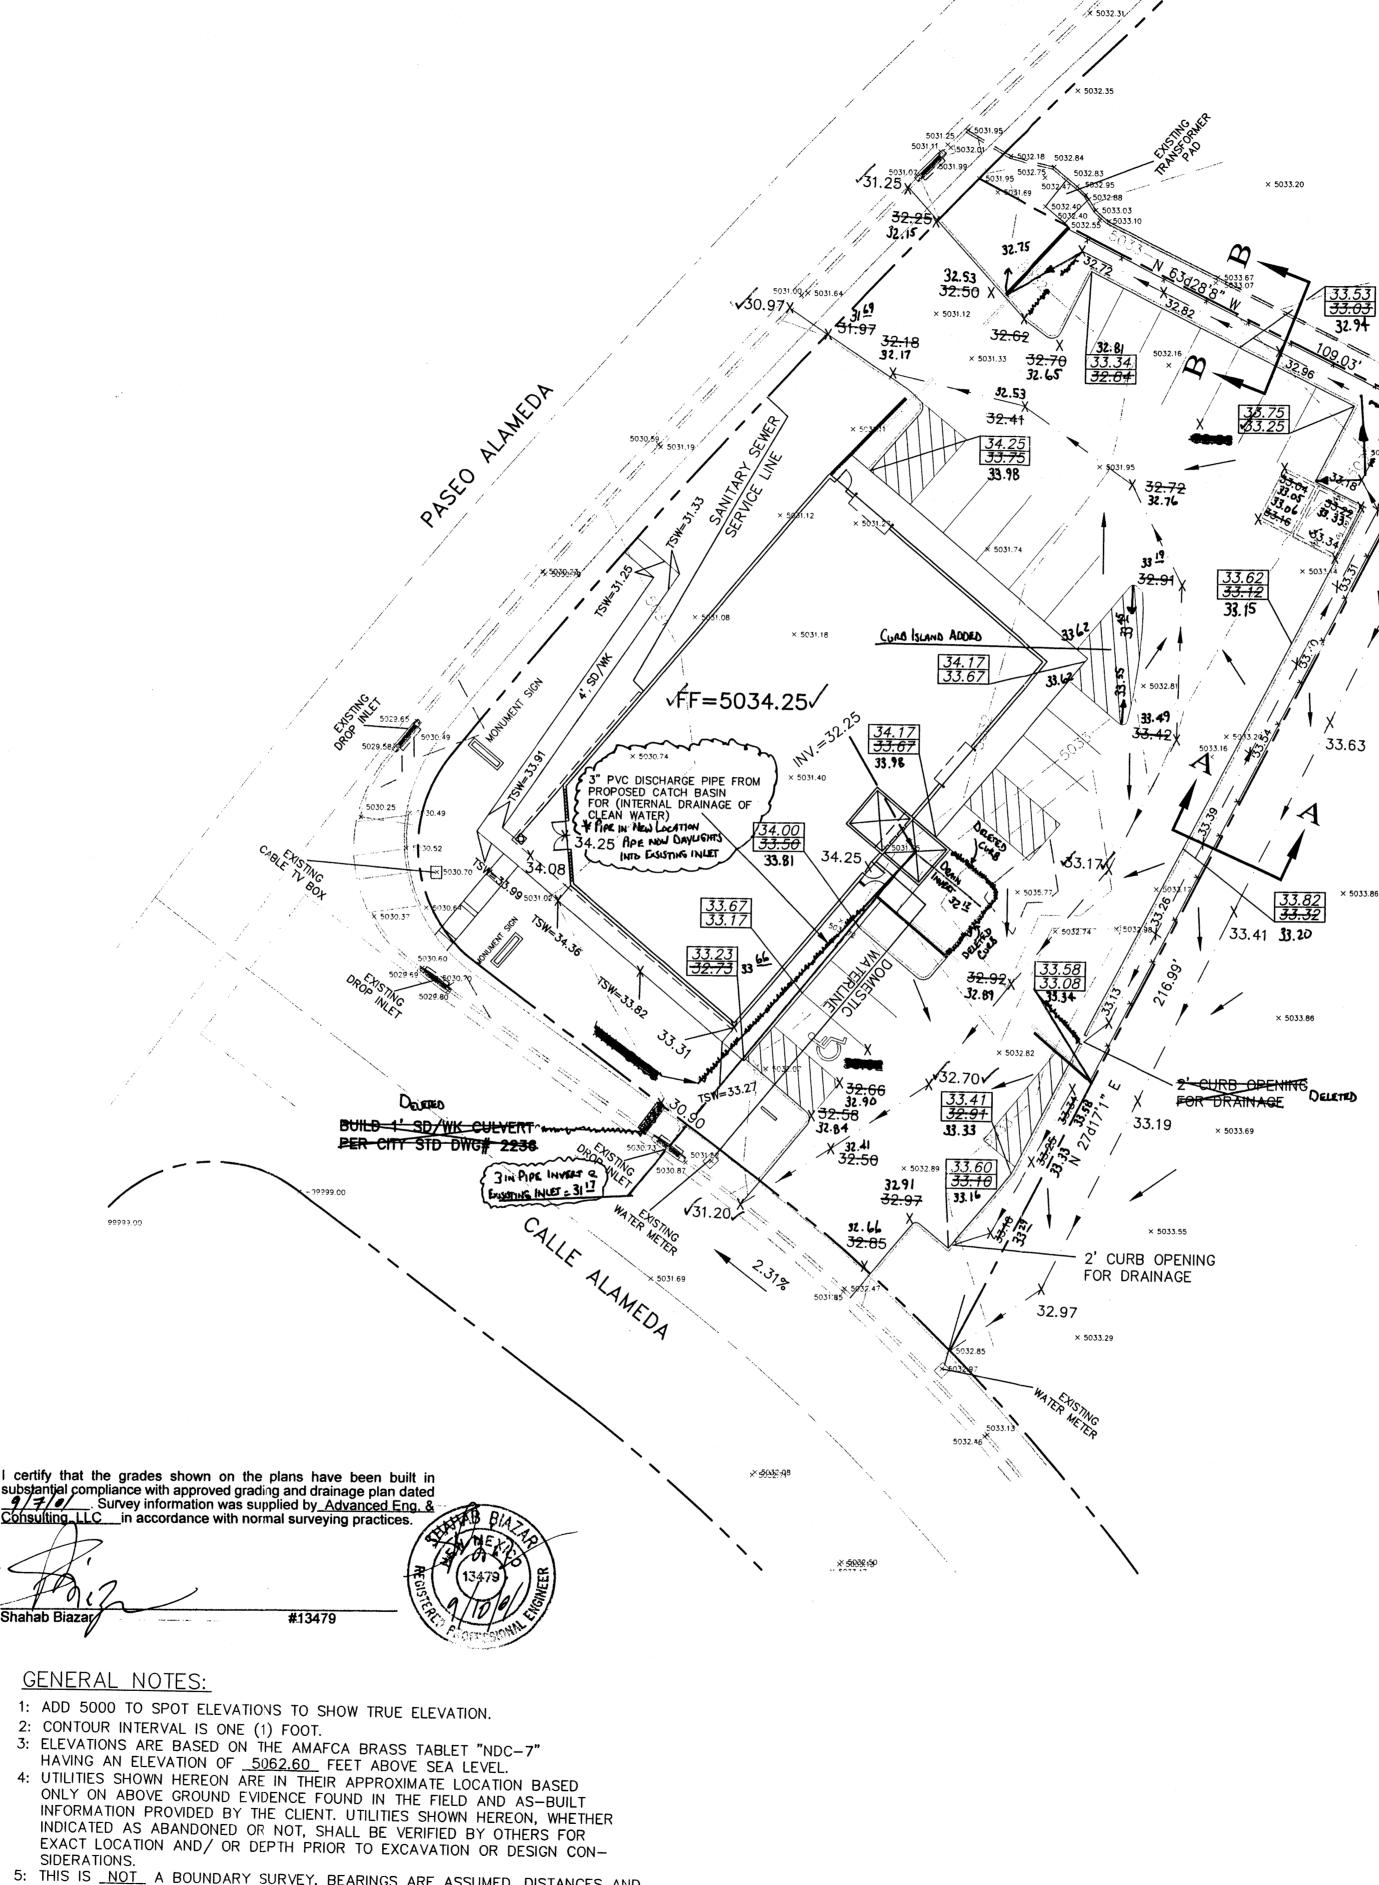

× 5034.30

2: CONTOUR INTERVAL IS ONE (1) FOOT.

ONLY ON ABOVE GROUND EVIDENCE FOUND IN THE FIELD AND AS-BUILT INFORMATION PROVIDED BY THE CLIENT. UTILITIES SHOWN HEREON, WHETHER INDICATED AS ABANDONED OR NOT, SHALL BE VERIFIED BY OTHERS FOR EXACT LOCATION AND/ OR DEPTH PRIOR TO EXCAVATION OR DESIGN CON-

5: THIS IS <u>NOT</u> A BOUNDARY SURVEY, BEARINGS ARE ASSUMED, DISTANCES AND FOUND PROPERTY CORNERS ARE FOR <u>INFORMATIONAL PURPOSES ONLY.</u>

6: SLOPES ARE AT 3:1 MAXIMUM.

ROUGH GRADING APPROVAL DATE GRAPHIC SCALE

SCALE: 1"=20'

EROSION CONTROL PLAN

OF EXISTING RIGHT-OF-WAY.

RUNOFF ON SITE.

PROJECT.

AND POLLUTION PREVENTION NOTES

2. CONTRACTOR IS RESPONSIBLE FOR CLEANING ALL SEDIMENT OUT

1. CONTRACTOR IS RESPONSIBLE FOR OBTAINING A TOPSOIL DISTURBANCE PERMIT PRIOR TO BEGINNING WORK.

3. CONTRACTOR IS RESPONSIBLE FOR MAINTAINING ALL STORM

4. REPAIR OF DAMAGED FACILITIES AND CLEAN—UP OF SEDIMENT ACCUMULATION ON ADJACENT PROPERTIES AND IN PUBLIC FACILITIES IS THE RESPONSIBILITY OF THE CONTRACTOR.

5. AND WATER EROSION PRIOR TO FINAL ACCEPTANCE OF ANY

2039-GR.DWG

SBB 01-05-01