## CITY OF ALBUQUERQUE



April 3, 2007

Tate Fishburn, R.A. P.O. Box 2941 Corrales, NM 87048

Re:

Office / Warehouse, 3711 Paseo del Norte Blvd NE, Traffic Circulation Layout

Architect's Stamp dated 4-3-07 (C17-D19)

Dear Mr. Fishburn,

The TCL submittal received 3-16-07 is approved for Building Permit. The plan is stamped and signed as approved. A copy of this plan will be needed for each of the building permit plans. Please keep the original to be used for certification of the site for final C.O. for Transportation. Public infrastructure or work done within City Right-of-Way shown on these plans is for information only and is not part of approval. A separate DRC and/or other appropriate permits are required to construct these items.

P.O. Box 1293

If a temporary CO is needed, a copy of the original TCL that was stamped as approved by the City will be needed. This plan must include a statement that identifies the outstanding items that need to be constructed or the items that have not been built in "substantial compliance," as well as the signed and dated stamp of a NM registered architect or engineer. Submit this TCL with a completed <u>Drainage and Transportation Information Sheet</u> to Hydrology at the Development Services Center of Plaza Del Sol Building.

Albuquerque

When the site is completed and a final C.O. is requested, use the original City stamped approved TCL for certification. A NM registered architect or engineer must stamp, sign, and date the certification TCL along with indicating that the development was built in "substantial compliance" with the TCL. Submit this certification TCL with a completed <u>Drainage and Transportation Information Sheet</u> to Hydrology at the Development Services Center of Plaza Del Sol Building.

www.cabq.gov

New Mexico 87103

Once verification of certification is completed and approved, notification will be made to Building Safety to issue Final C.O. To confirm that a final C.O. has been issued, call Building Safety at 924-3306.

Sincerely,

Kristal D. Metro, P.E.

Senior Engineer, Planning Dept. Development and Building Services

C: File

## CITY OF ALBUQUERQUE



April 2, 2007

Tate Fishburn, R.A. **Tate Fishburn Architect**P.O. Box 2941
Corrales, NM 87048

Re: 3711 Paseo Del Norte NE, Lot F-1-A Lands of Springer, Traffic Circulation Layout, Architect's Stamp dated XXXXXX (C17-D19)

4-3-07

Dear Mr. Fishburn,

Based upon the information provided in your submittal received 03-16-06, the above referenced plan cannot be approved for Building Permit until the following comments are addressed:

P.O. Box 1293

1. Sign and date the plans.

If you have any questions, you can contact me at 924-3981.

Albuquerque

Sincerely,

New Mexico 87103

Kristal Metro, P.E. Senior Engineer

Development and Building Services

C: file

## DRAINAGE AND TRANSPORTATION INFORMATION SHEET OFFICE IN ARE House (Rev. 12/05)

PROJECT TITLE: OGB OFFICE ADDA)  DRB#: EPC#:	ZONE MAP/DRG. FILE # C - 17/D-19
DRB#: EPC#:	WORK ORDER#:
LEGAL DESCRIPTION: F-1-A CANDS CITY ADDRESS: 371/ P45E0 DEL NOR	OF SPRINGER.
CITY ADDRESS: 3111 PASEO DEL NOR	TE, NE 87113
ENGINEERING FIRM: J. AUTHUR BUESSEN	CONTACT:
ADDRESS:	PHONE:ZIP CODE:
OWNER: OGB ARCH TECTURAL MILLWORK	CONTACT: BICK THATED
ADDRESS:	PHONE: 998-6000
ADDRESS:CITY, STATE:	ZIP CODE:
ARCHITECT: TATE FISHRIPH ARCHITECT  ADDRESS: BOX 2941  CITY, STATE: CONACES NM	
CLIDATESTOD	
SURVEYOR:	CONTACT:
ADDRESS:	PHONE:
CITY, STATE:	ZIP CODE:
CONTRACTOR: HART CONSTRUCTION	CONTACT:
ADDRESS:CITY, STATE:	PHONE:
CITT, STATE.	ZIP CODE:
	K TYPE OF APPROVAL SOUGHT:
	_ SIA/FINANCIAL GUARANTEE RELEASE
	PRELIMINARY PLAT APPROVAL
DRAINAGE PLAN RESUBMITTAL	S. DEV. PLAN FOR SUB'D APPROVAL S. DEV. FOR BLDG PERMIT APPROVAL
	S. DEV. FOR BLDG. PERMIT APPROVAL
	_ SECTOR PLAN APPROVAL  >  🤿 🕜
	FINIAL DI AT ADDDOVAY
ENGINEER'S CERT (HYDROLOGY)	FOUNDATION PERMIT APPROVAL.   Innii   175
CLOMR/LOMRX	RITIDING DEDMIT ADDDONAT
TRAFFIC CIRCULATION LAYOUT	CERTIFICATE OF OCCUPANCY (PERM)
	_ CERTIFICATION OF COLUMN (TEMP)
ENGINEER/ARCHITECT CERT (DRB S.P.)	_ GRADING PERMIT APPROVAL
ENGINEER/ARCHITECT CERT (AA)	_ PAVING PERMIT APPROVAL
OTHER (SPECIFY)	_ WORK ORDER APPROVAL
	_ OTHER (SPECIFY)
WAGA PRE DEGICAL GOVERNMENT A TOTAL TOTAL	3.034
WAS A PRE-DESIGN CONFERENCE ATTENDED:	and the second
YES PLE	AJE CALL WHEN READY.
NO	1 462-6928 = R
COPY PROVIDED	Cel - 16, ELD MENT DOC.
SUBMITTED BY: TAKE FISHBURN	Cel - 463-6928 WENT DUER DATE: 3/16/07 W/WILL FRED
Requests for approvals of Site Development Plans and/or Subdivision	Plats shall be accompanied by a drainage submitted. The

particular nature, location and scope to the proposed development define the degree of drainage detail. One or more of the following levels of submittal may be required based on the following:

- 1. Conceptual Grading and Drainage Plan: Required for approval of Site Development Plans greater than five (5) acres and Sector Plans.
- 2. Drainage Plans: Required for building permits, grading permits, paving permits and site plans less than five (5) acres.
- 3. **Drainage Report**: Required for subdivision containing more than ten (10) lots or constituting five (5) acres or more.

## TATE FISHBURN ARCHITECT

March 16, 2007

Traffic Engineer City of Albuquerque Planning Department Plaza Del Sol Building Albuquerque, NM


Ref: Traffic Circulation Layout


We are submitting a Traffic Circulation Layout for review. The project is an office addition to an existing building that produces architectural millwork. The site is existing and the new addition will have minimal impact on the existing conditions. We have added parking to accommodate the new addition including handicap parking spaces with striped accessible walkway to entrances and motorcycle parking with signage. All existing parking is to remain undisturbed. Please contact me with any questions or comments. We appreciate you assistance with this project.

Sincerely,

Tate Fishburn Architect

BOX 2941 CORRALES N M 87048 505 899 9338 FAX 899 9328

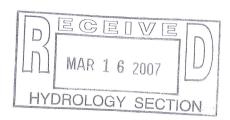

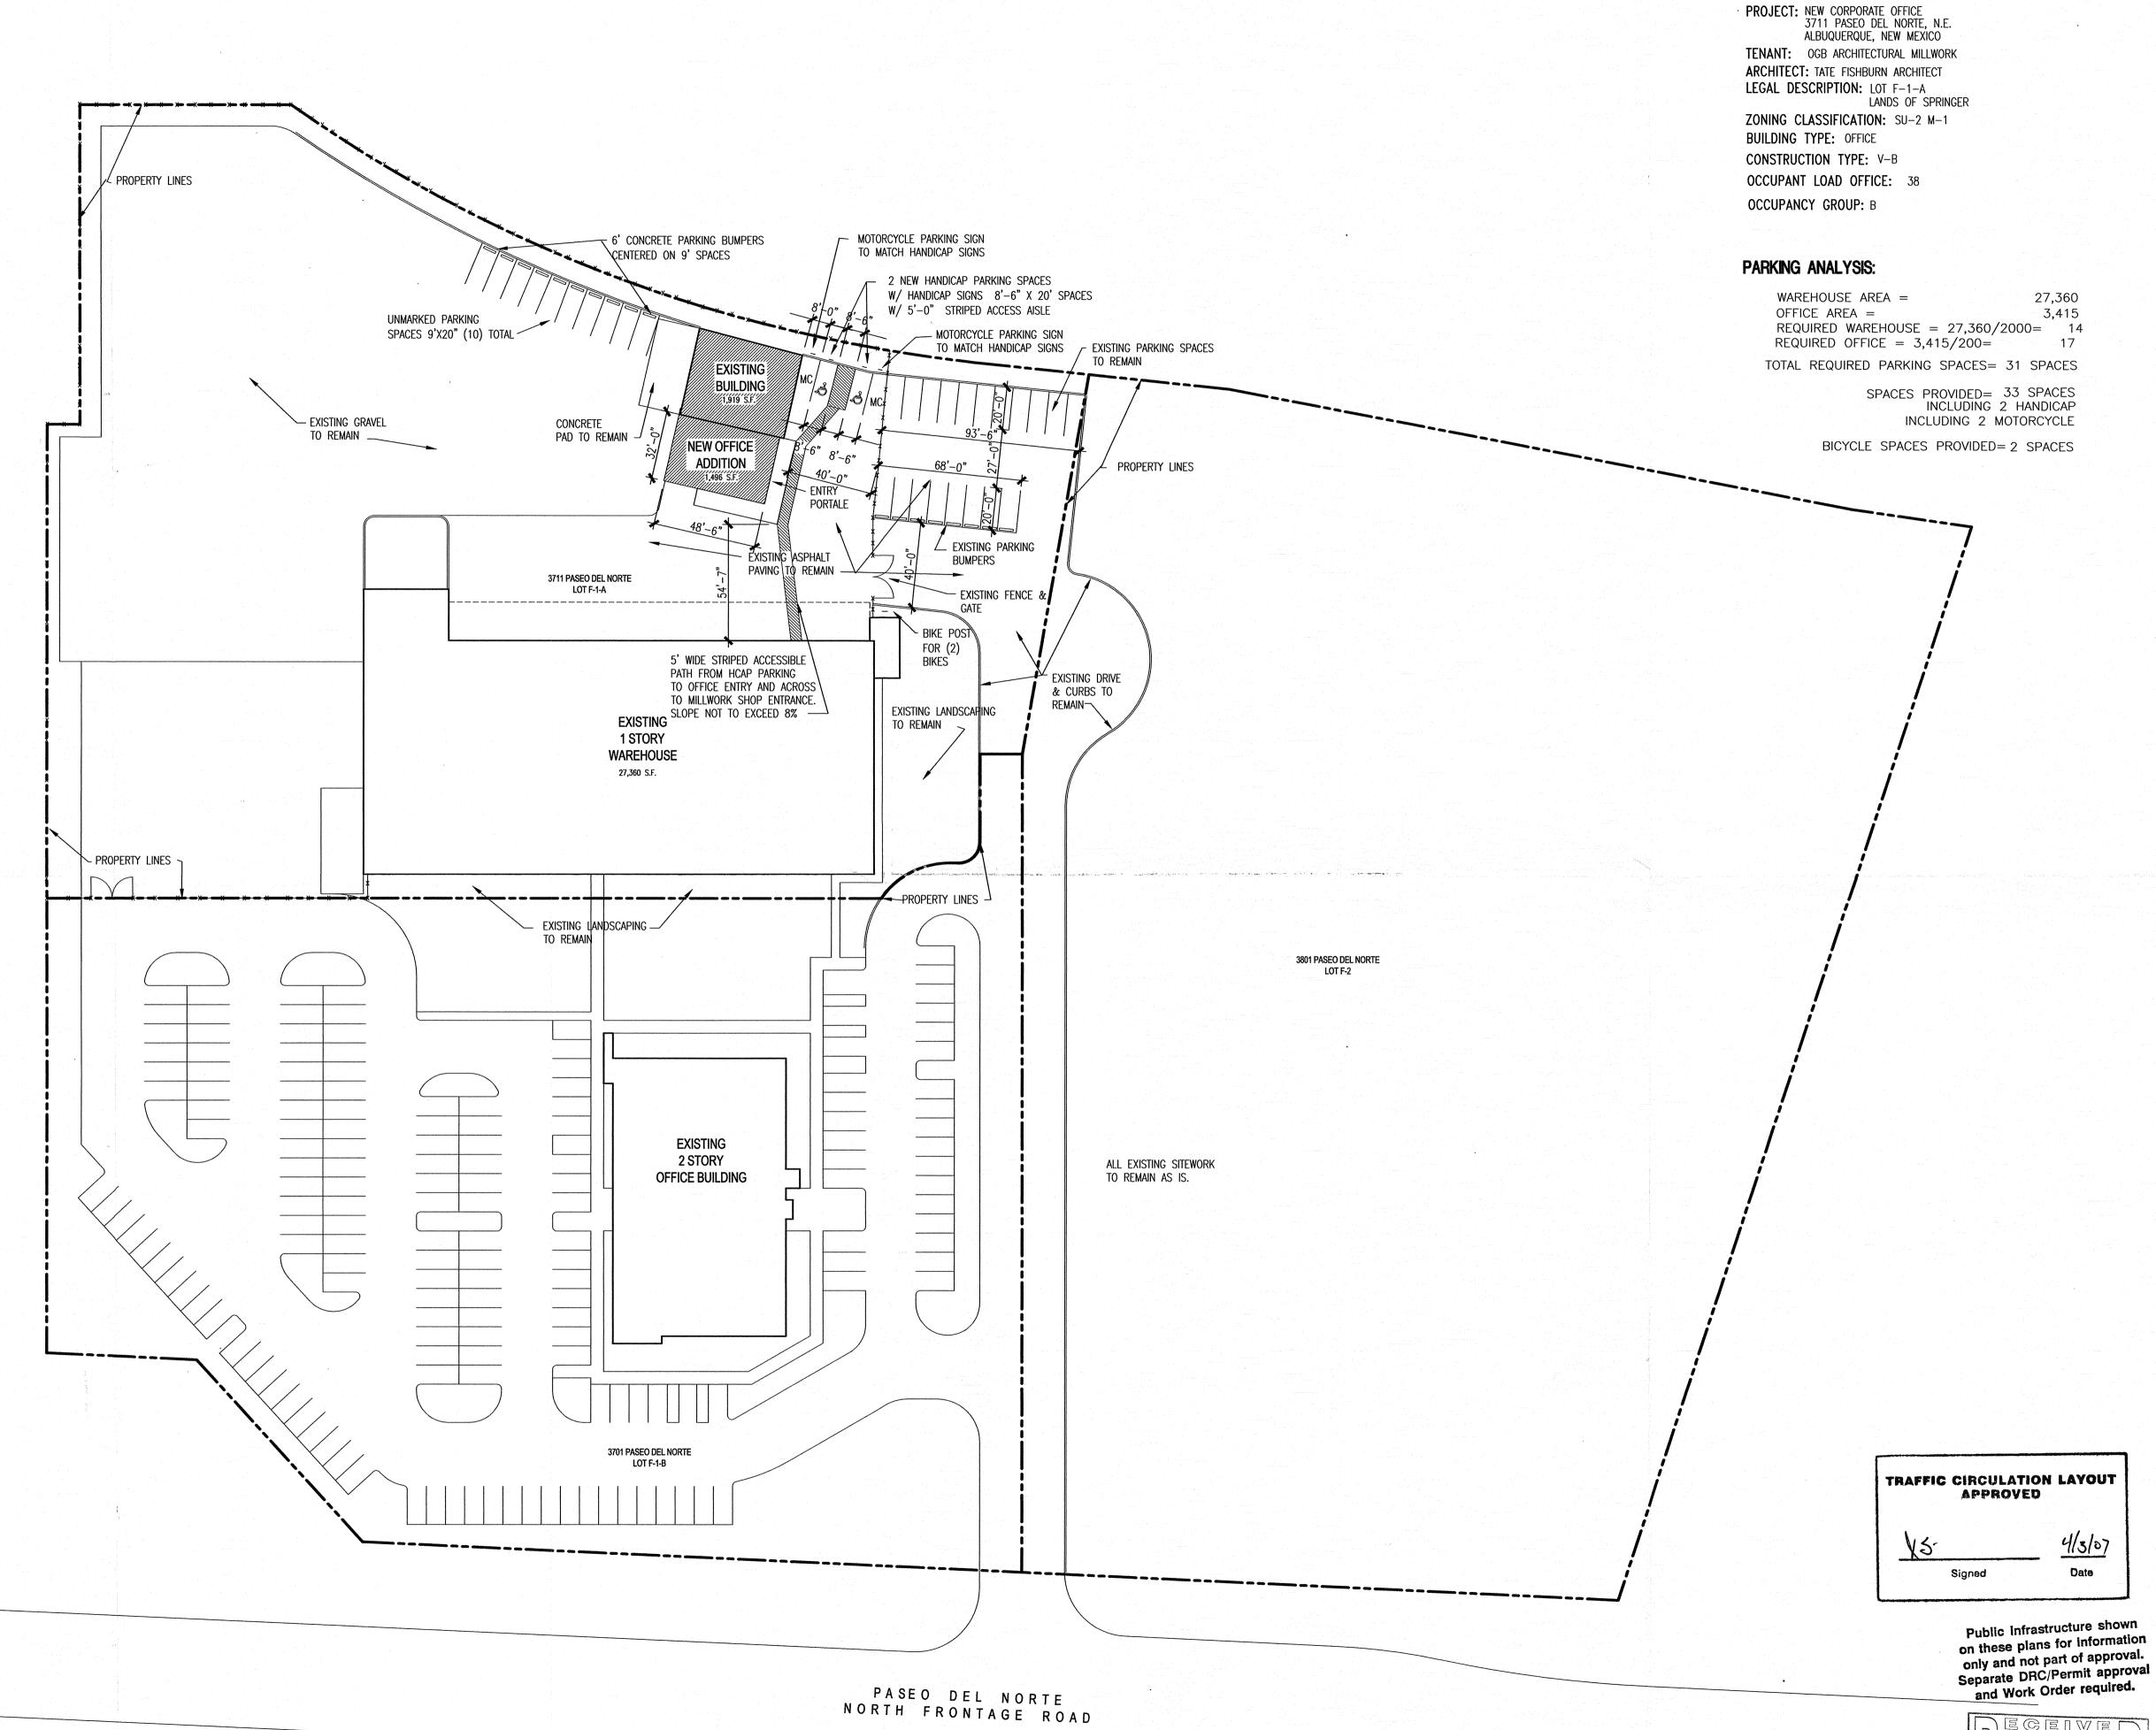

Z ⊢ ≅ O

BUILDING CRITERIA

Т <sub>-</sub>

\_ A □ O □ T

ARCHITECT SEAL

TATE FISHBURN
No 3550
No 3550
No 3550

ENGINEERSEAL

PROJECT

FOR OGB ARCHITECTURAL MILLWORK
3711 PASEO DEL NORTE, NE

REVISIONS

MARCH 16, 2007

NORTH SCALE

1"=40'-0"

DRAWING NAME

SITE PLAN

SHEET NUMBER

MAR 1 6 2007

HYDROLOGY SECTION

TCL-1