



PROJECTED -

GRADE

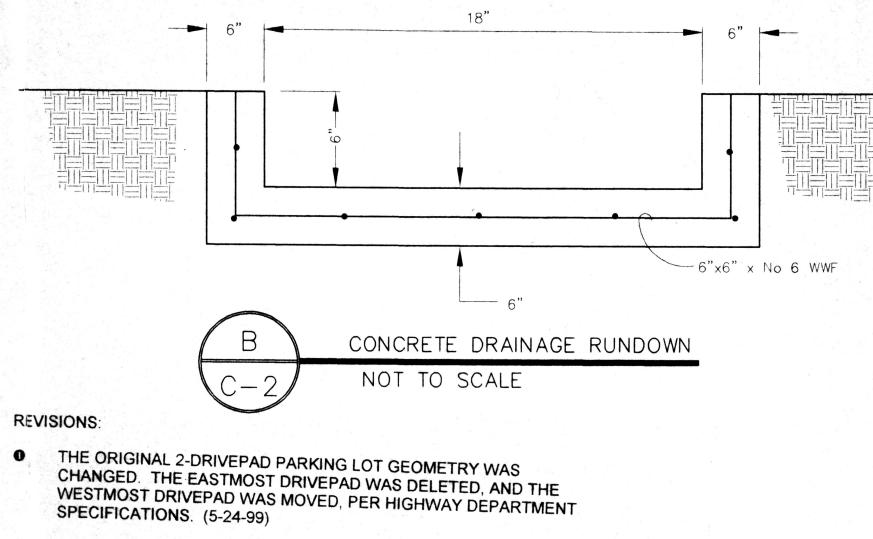

THE BOUNDARY WAS REVISED TO REFLECT THE RESULTS OF A RECENT SURVEY BY CHARLES G. CALA, JR., P.S. OF JEFF MORTENSEN AND ASSOCIATES, INC. (5-24-99)

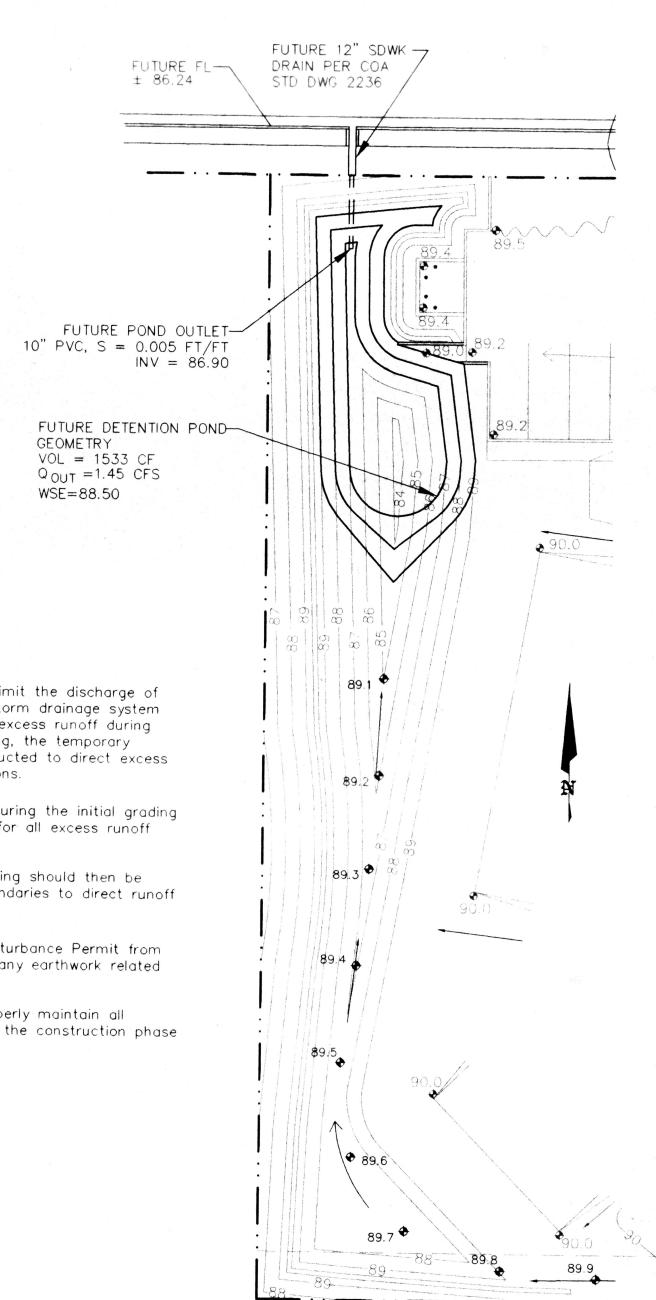

TEMPORARY EROSION CONTROL PLAN

FUTURE TC 93.25

93,38

EAGLE ROCK AVENUE

S 89'26'51"

SARATOGAS 1/1/428 SF /2

(INCL.\171 SF PORCH)

140/10'

10' PNM ELEC .-

60' ROW

₹₩.

30,

S 89**'28'00**"

I, the undersigned, being a Professional Engineer in the State of New Mexico, do hereby certify that the as-built information shown hereon is based on actual field measurements and visual inspections performed by Brasher &

compliance with the approved Grading and Drainage Plan prepared by Brasher & Lorenz, Inc., dated March 15,

1. The on-site temporary retention pond does not provide the 100 year 10 day volume as recommended by

This certification is limited to on-site grading and drainage improvements and does not extend to the structural

integrity of the materials used or the workmanship of the contractor. Any future modifications to the site

the approved Plan. As shown by the supplemental calculations, the as-build pond volume is 4529 cubic feet, which is equivalent to the 100 year 6 hour volume. Per the Plan, future downstream storm drainage improvements (presently under construction) will allow a controlled discharge from the site of 1.45 cfs,

routed through a 1533 cubic foot detention pond. Conversion from a retention to detention pond will require

Lorenz, Inc. I further certify that the as-built condition of the site as of December 27, 1999 is in substantial

- 1. Temporary Erosion Control is required to limit the discharge of sediment into the public street and/or storm drainage system and to protect adjacent properties from excess runoff during construction. After the initial site clearing, the temporary erosion control facilities should be constructed to direct excess runoff and sediment to the outfall locations.
- 2. The retention pond shall be constructed during the initial grading operations to provide a storage location for all excess runoff generated by the site.
- 3. Earthen erosion control berms or silt fencing should then be placed along the downstream project boundaries to direct runoff to the retention pond.
- 4. The Contractor shall obtain a Top Soil Disturbance Permit from Environmental Health prior to performing any earthwork related operations.
- 5. It is the Contractor's responsibility to properly maintain all temporary erosion control facilities during the construction phase of the project.

1 inch = 20 ft

FUTURE DETENTION POND DETAIL 1"=20'

Dennis A. Lorenz, NMPE 9647

ENGINEER'S CERTIFICATION

1999, revised May 24, 1999, with the following exception:

an update to the approved plan and certification.

improvements shall render this certification null and void.

FUTURE FL-

± 86.24 81.03

RETENTION POND-

@ WSE = 89.0 ✓

VOL = 17668 CF

AB VOL= 4529 CF

LOT 8


DRAWN BY: C.D.D., T.P.H. CHECKED BY: D.A.L. FILE: 8051-GDP.DWG

SHEET C+2

DATE: MAY, 1999

2201 San Pedro NE Building 1 Suite 210

Albuquerque, New Mexico 87110 Ph: 505-888-6088 Fax: 505-888-6188 U

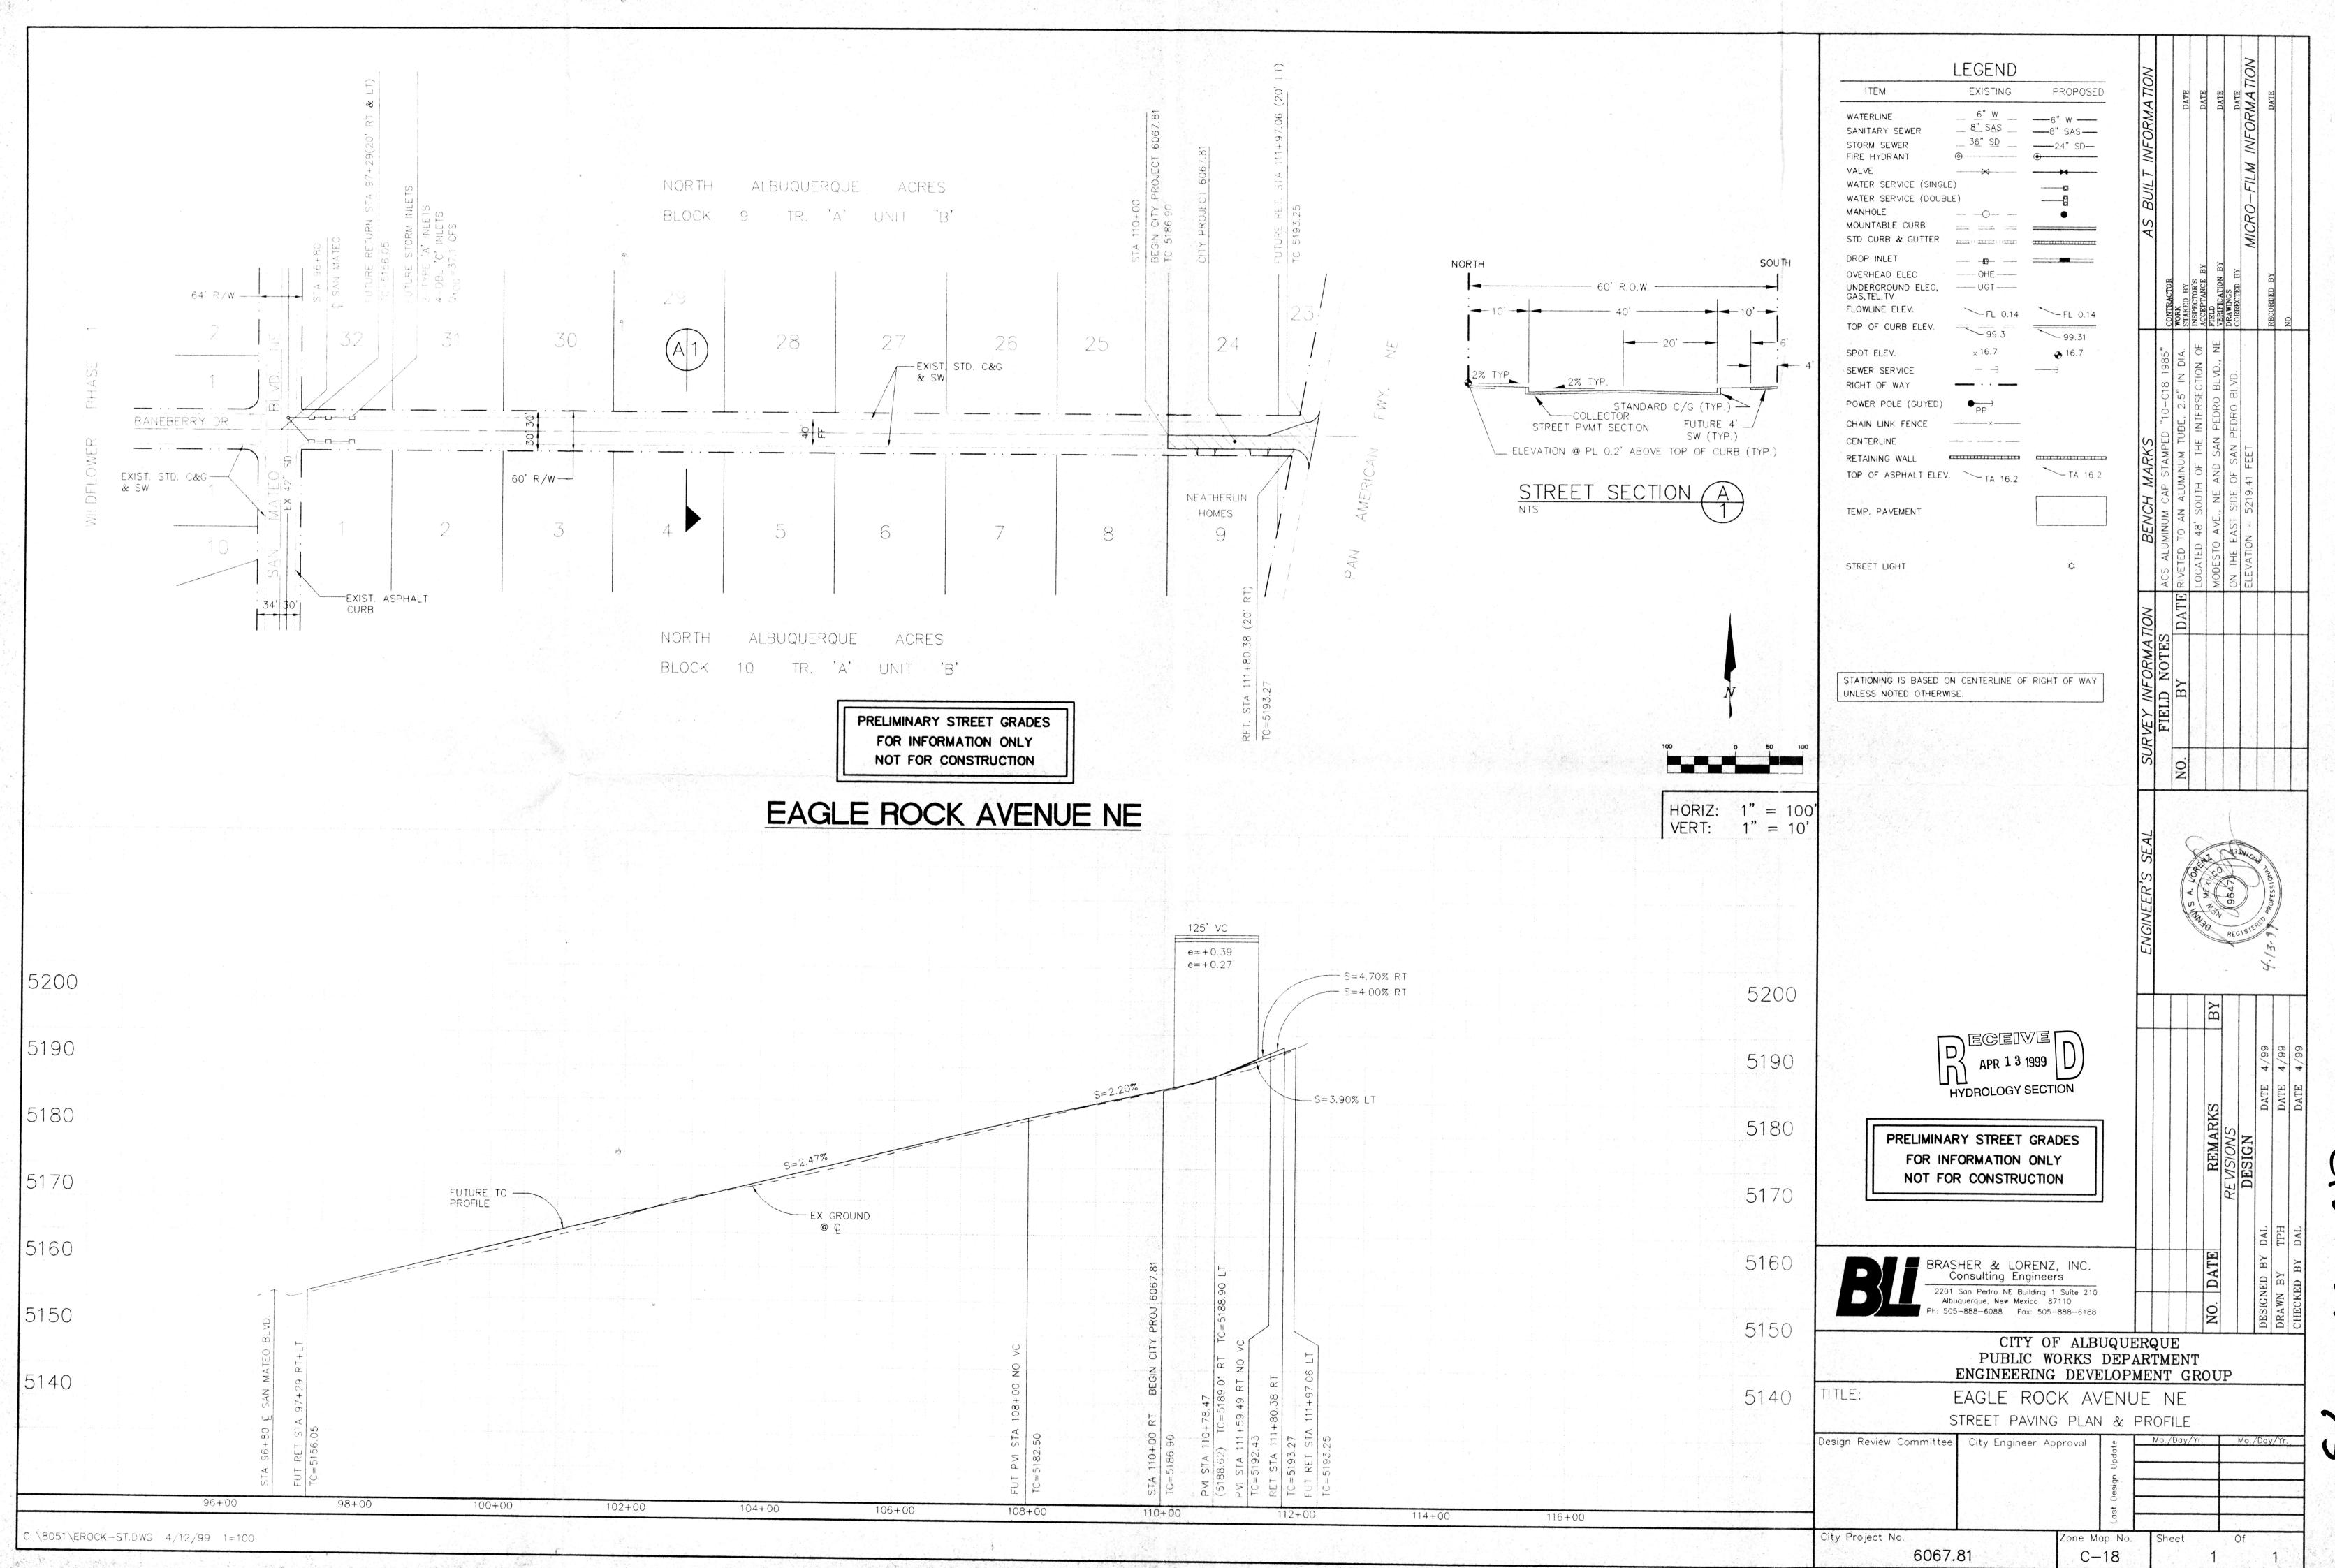

C(2 -3 51

3

LEGAL DESCRIPTION: Lot 9, Block 10, Tract A, Unit B, North Albuquerque

PROPERTY ADDRESS: 8921 West Pan American Freeway NE

CURRENT ZONING: SU-2 FOR M-1

PARKING:

SITE AREA: 0.8865 acres (38,616 sf)

BUILDING AREAS: Office 2,304 sf Canton 1,292 sf

1,631 sf Galveston 1.252 sf Jefferson Saratoga 1,428 sf 7,907 sf

NET SITE AREA: Site Area — Building Area = 30,709 SF

LANDSCAPING: Area Recommended: 15% Net Site Area = 4,606 sf

Area Provided: 15.682 sf

Spaces Required: 1 space per 200 sf office 1 Van Accessible Space Accessible Spaces Required:

> 11 Regular Spaces 1 Van Accessible Space 12 Total Spaces

BUILDING SETBACKS: Setbacks per 0-1 Zone as follows:

Spaces Provided:

Front: 5 feet Side: 5 feet Rear: None

BUILDING HEIGHT: Structure height up to 36 feet is allowed in any legal

SIGNAGE: Signage is per C-2 Zone as follows:

> NUMBER: One free standing or projecting sign for each street frontage of at least 100 feet or one per each 300 feet of

> > total frontage

NUMBER PROPOSED: One

75 sf on a local street 100 sf on a collector street 250 sf on an arterial or freeway

300 sf within 200 ft of a moving lane of a freeway

### GENERAL NOTES

1. THIS SITE PLAN HAS BEEN APPROVED AND ACCEPTED BY ALL PARTIES. ANY FIELD CHANGES NOT APPROVED BY THE TRAFFIC ENGINEER WILL

A. UTIMELY DELAY OF THE INITIAL INSPECTION FOR TEMPORARY CERTIFICATE OF OCCUPANCY AND,

B. POSSIBLE INCREASED CONSTRUCTION COST TO RESPONSIBLE

2. THE RESPONSIBLE PARTIES MUST RECTIFY ALL UNAPPROVED CONSTRUCTION WHICH IS NOT IN COMPLIANCE WITH THIS SITE PLAN.

3. ALL ASPHALT AND CONCRETE CONSTRUCTION MUST BE 100% COMPLETE BEFORE INITIAL INSPECTION FOR TEMPORARY CERTIFICATE OF OCCUPANCY WILL BE SCHEDULED.


4. ALL WORK BEING DON IN CITY RIGHT OF WAY (CPN 606781) AS A PART OF THIS DEVELOPMENT MUST BE COMPLETE BEFORE ISSUANCE OF CERTIFICATE OF OCCUPANCY, OR A FINANCIAL GUARANTEE MUST BE ON FILE WITH THE DESIGN REVIEW SECTION.


5. ALL SIDEWALK AND CURB AND GUTTER IN DISREPAIR WILL BE REMOVED AND REPLACED AT THE DIRECTION OF THE PROJECT ENGINEER.

6. ALL FIRE HYDRANTS WILL BE PROVIDED BY CITY PROJECT NO. 606781.

## REVISIONS:

- THE ORIGINAL 2-DRIVEPAD PARKING LOT GEOMETRY WAS CHANGED. THE EASTMOST DRIVEPAD WAS DELETED, AND THE WESTMOST DRIVEPAD WAS MOVED, PER HIGHWAY DEPARTMENT SPECIFICATIONS. (5-24-99)
  - THE BOUNDARY WAS REVISED TO REFLECT THE RESULTS OF A RECENT SURVEY BY CHARLES G. CALA, JR., P.S. OF JEFF MORTENSEN AND ASSOCIATES, INC. (5-24-99)

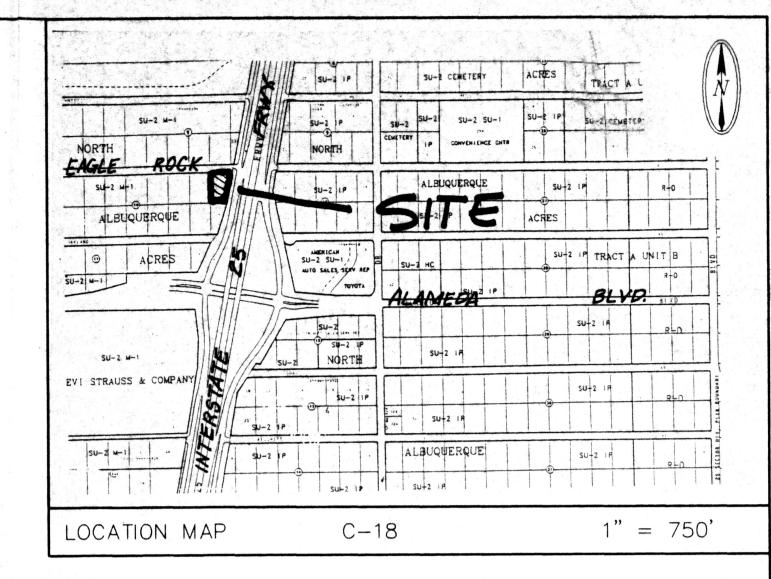

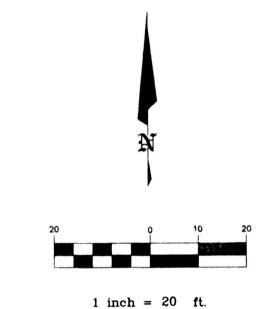


- PROPOSED 6" CONCRETE CURB-SEE DETAIL 6, SHEET C-4
- EXISTING STD. CURB & GUTTER
- PROPOSED 4' CONCRETE SIDEWALK
- EXISTING ASPHALT TO REMAIN
- 8. PROJECT SIGN-SEE DETAILS, SHEET C-4
- CONSTRUCT DRAINAGE RUNDOWN-SEE SHEET C-2
- 10. HANDICAP SIGN ASSEMBLY-SEE DETAIL 4, SHEET C-4
- 11. LANDSCAPING-SEE SHEET L-1
- 13. PROPOSED 1" WATER SERVICE BY COA PROJECT NO. 606781
- 15. STREET PAVING BY COA PROJECT NO. 606781
- 16. FUTURE 4' SIDEWALK
- 17. FUTURE HANDICAP ACCESS RAMP


## **ENGINEER'S CERTIFICATION**

New Mexico, do hereby certify that the as-built information shown hereon is based on visual site inspections performed by Brasher & Lorenz, Inc. I further certify that the as-built condition of the site as of December 27, 1999 is in substantial compliance with the approved Site Plan prepared by Brasher & Lorenz, Inc., dated March 15, 1999, revised May 24, 1999.

extend to the structural integrity of the materials used or the workmanship of the contractor. Any future modifications to the site improvements shall render this certification null and void.

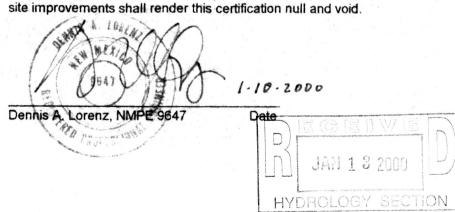

# NEATHERLIN HOMES SITE PLAN

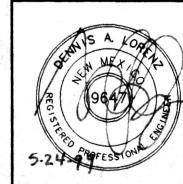



DRAWN BY: C.D.D., T.P.H. DATE: MAY, 1999 CHECKED BY: D.A.L. SHEET C-1

LOT 24 LOT 23 LOT 25

EAGLE ROCK AVENUE PROPOSED DOUBLE YELLOW SRIPE 60' ROW (CPN 606781)

SIGN R1-1-(STOP)

4 4 4 4 TEMPORARY RETENTION SARATOGA POND 1/1428 SF % -57.0'-

(INCL. 171 SF PORCH) 5

LOT 8

S 89°28'00" E 140.10' 10' PNM ELEC .-

LOT 24 LOT 25

EX. SIGN

FILE: 8051-ST1.DWG