CITY OF ALBUQUERQUE

September 25, 2015



Fred C. Arfman, P.E. Isaacson & Arfman, PA 128 Monroe St NE Albuquerque, NM 87108

Re: Alameda Self-Storage Storm Drain Improvements

6800 Oakland Ave NE Grading and Drainage Plan Permanent CO – Accepted

Engineer's Stamp dated: 1-22-15 (C18D064A)

Certification dated: 9-16-15

Dear Mr. Arfman,

Based upon the information provided in your submittal received 9/17/2015, the above referenced Certification received is acceptable for the release of Certificate of Occupancy by Hydrology.

If you have any questions, you can contact me at 924-3695 or Totten Elliott at 924-3982.

Albuquerque

PO Box 1293

New Mexico 87103

www.cabq.gov


Sincerely,

Rita Harmon, P.E. Senior Engineer, Planning Department

TE/RH

C:

email

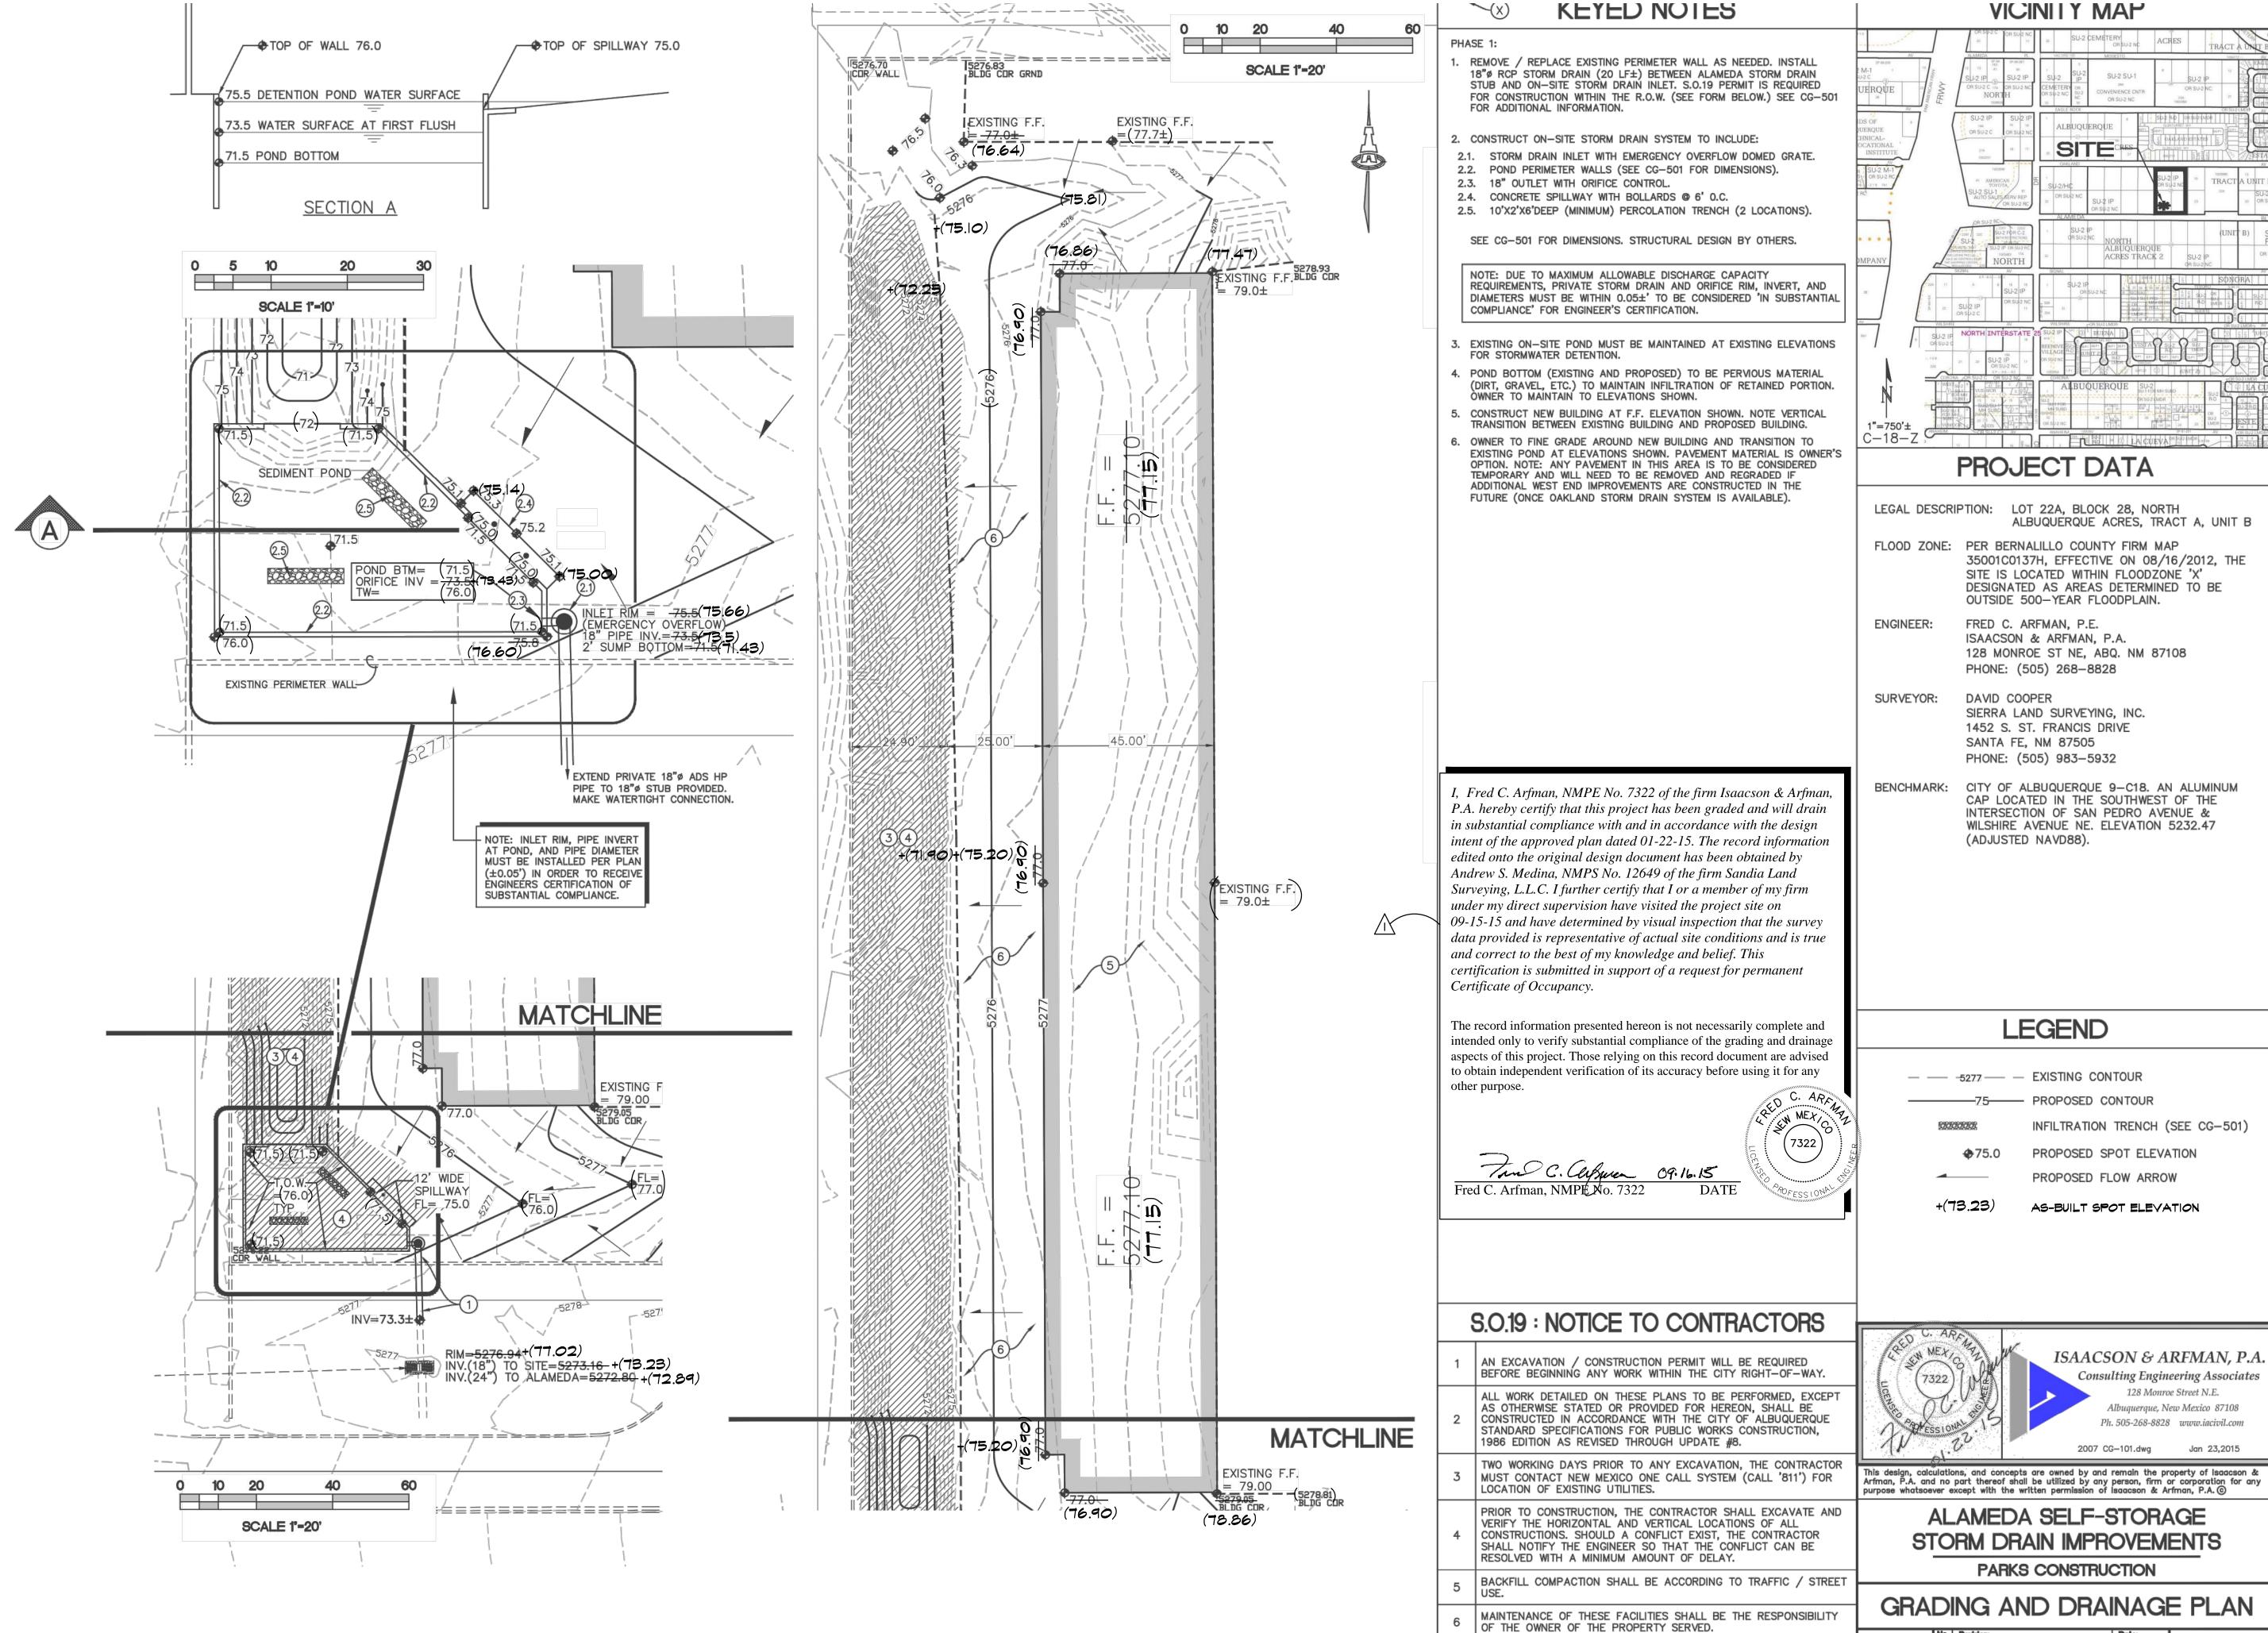



STORM DRAIN IMPROVEMENTS

128 Monroe Street N.E.

Albuquerque, New Mexico 87108 Ph. 505-268-8828 www.iacivil.com


PARKS CONSTRUCTION

GRADING AND DRAINAGE PLAN

				Date:	NO.	Hevision	Date:	Job No.	
,		WORK ON ARTERIAL STREETS SHALL BE PERFORMED ON A				ENGR. CERTIFICATION	09-16-15	20.07	
	24-HOUR BASIS.			Drawn By:	\vdash			CC_101	
PROVAL		NAME	DATE	BJB	_			CG-101	
				Ckd By:	$\vdash \vdash$		 		
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APPROVAL


INSPECTOR

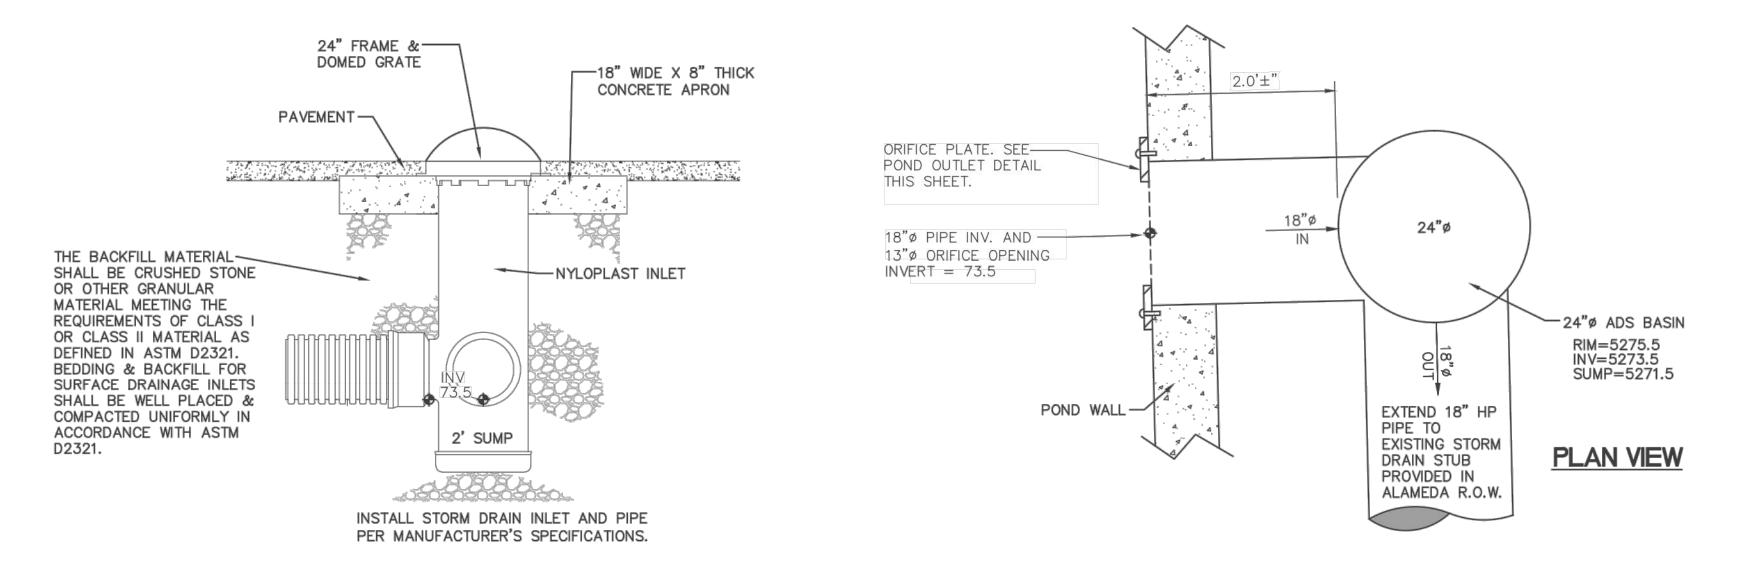

SEE ADS DETAIL DRAWING STD-603: DISSIMILAR PIPE CONNECTIONS FOR RCP FOR CONNECTION REQUIREMENTS.

DRAINAGE INLET

SCALE: N.T.S.

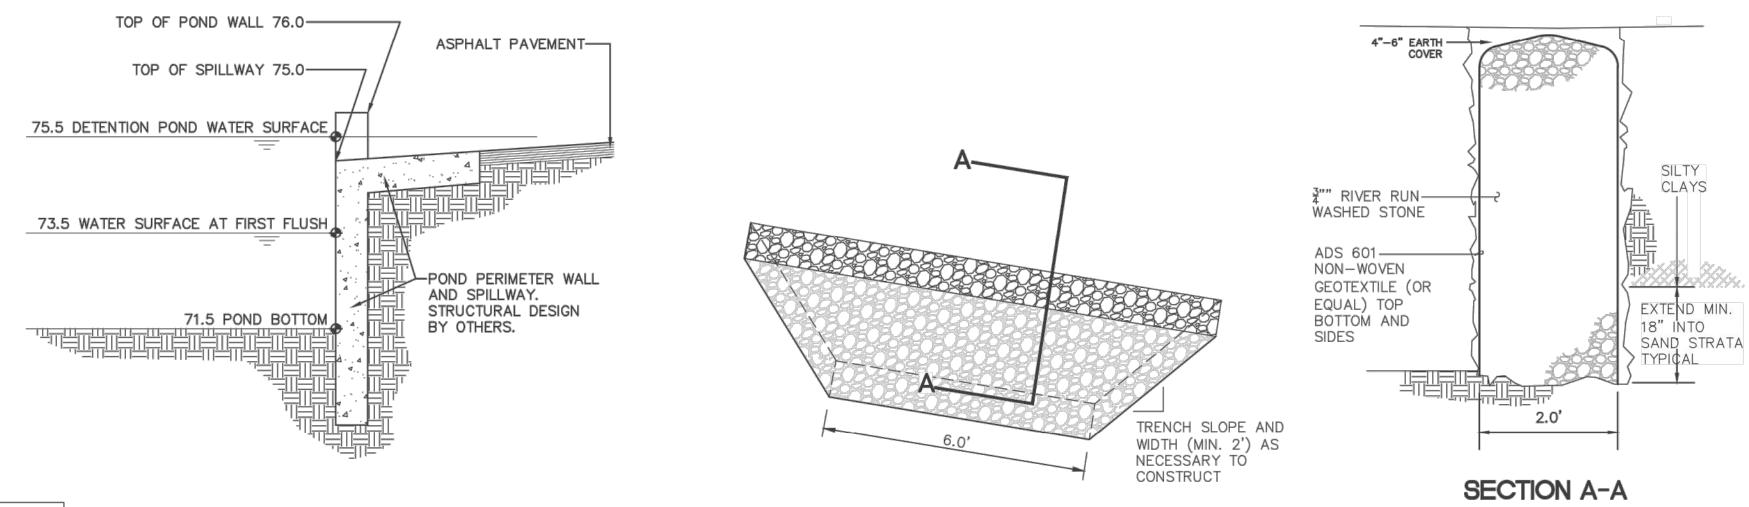



SECTION THROUGH POND SPILLWAY

SCALE: N.T.S

PERCOLATION TRENCH

SCALE: N.T.S.

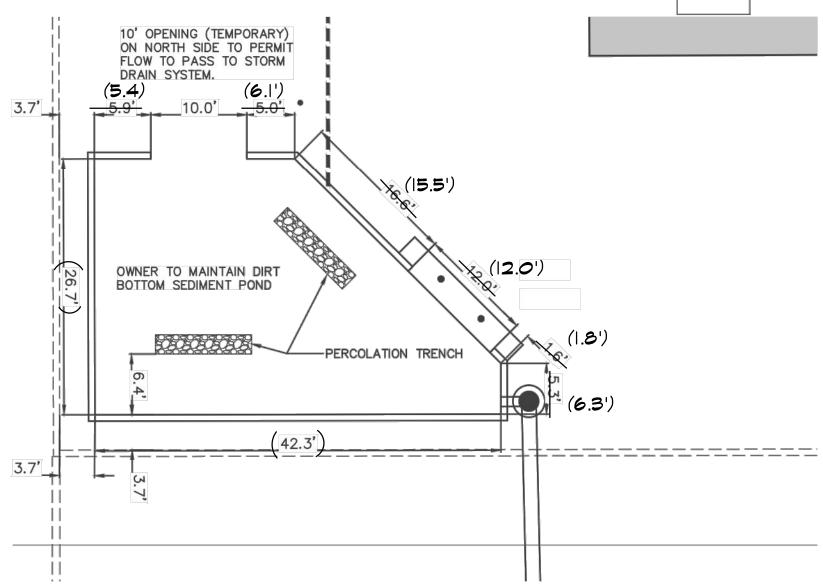

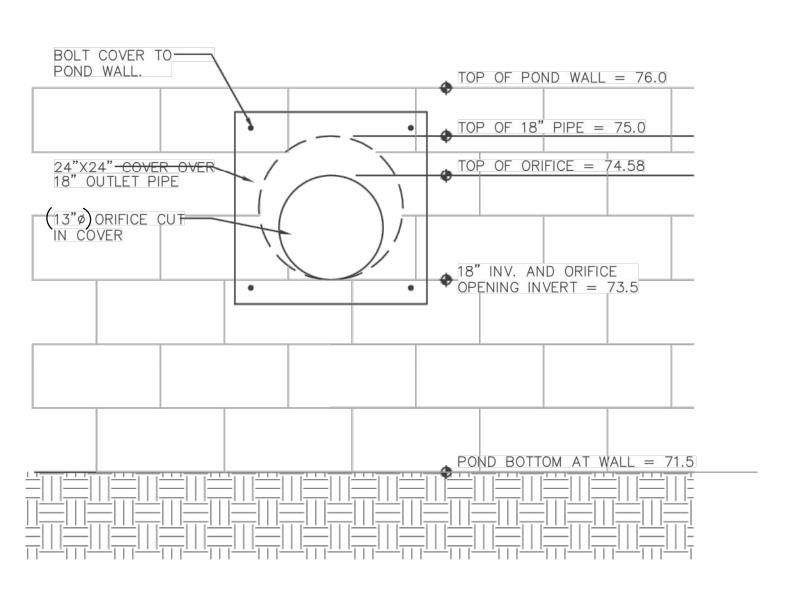



POND WALL DIMENSIONS

SCALE: 1"=10'

POND ORIFICE OUTLET

SCALE: 1"=10'


GENERAL NOTES

- A. THE CONTRACTOR SHALL ABIDE BY ALL STATE, LOCAL, AND FEDERAL LAWS, CODES, RULES AND REGULATIONS WHICH APPLY TO THE CONSTRUCTION OF THESE IMPROVEMENTS, INCLUDING EPA AND ADA REQUIREMENTS.
- B. ALL SUBGRADE, OVEREXCAVATION, BACKFILL, AND FILL SHALL BE PLACED AND / OR COMPACTED PER THE GEOTECHNICAL REPORT AND CITY OF ALBUQUEROUE SPECIFICATIONS
- C. THE CONTRACTOR SHALL OBTAIN ALL REQUIRED PERMITS FOR THE PROJECT PRIOR TO COMMENCING CONSTRUCTION, OR PRIOR TO OCCUPANCY, AS APPROPRIATE.
- D. COORDINATE WORK WITH SITE PLAN.
- E. IT IS THE CONTRACTOR'S RESPONSIBILITY TO FIELD VERIFY HORIZONTAL AND VERTICAL LOCATIONS OF ALL EXISTING OBSTRUCTIONS, AND THE CONDITION OF ALL EXISTING INFRASTRUCTURE PRIOR TO CONSTRUCTION. REPORT ALL DISCREPANCIES TO THE ENGINEER AND VERIFY THE ENGINEER'S INTENT BEFORE PROCEEDING.
- F. THE CONTRACTOR SHALL NOT SCALE DRAWINGS. ONLY WRITTEN DIMENSIONS OR KEYED NOTES SHALL BE USED.
- G. CONTRACTOR SHALL OBTAIN ALL REQUIRED INSPECTIONS OF THE WORK.
- H. CONSTRUCTION ACTIVITY SHALL BE LIMITED TO THE PROPERTY AND/OR PROJECT LIMITS. ANY DAMAGE TO ADJACENT STRUCTURES RESULTING FROM THE CONSTRUCTION PROCESS SHALL BE REPAIRED OR REPLACED AT THE CONTRACTOR'S EXPENSE. CONTRACTOR SHALL BE RESPONSIBLE FOR DOCUMENTING EXISTING CONDITIONS PRIOR TO CONSTRUCTION.
- THE CONTRACTOR SHALL OBTAIN BARRICADING PERMITS FROM THE APPROPRIATE AUTHORITIES PRIOR TO ANY CONSTRUCTION WORK ON OR ADJACENT TO EXISTING STREETS.
- J. ALL TRASH, DEBRIS, & SURFACE VEGETATION SHALL BE LEGALLY DISPOSED OF.
- K. PROPOSED SPOT AND CONTOUR ELEVATIONS SHOWN REPRESENT TOP OF FINISH MATERIAL (I.E. TOP OF CONCRETE, TOP OF CONCRETE BUILDING PAD, TOP OF PAVEMENT MATERIAL, TOP OF LANDSCAPING MATERIAL, ETC.). CONTRACTOR SHALL GRADE, COMPACT SUBGRADE AND DETERMINE EARTHWORK ESTIMATES BASED ON ELEVATIONS SHOWN MINUS FINISH MATERIAL THICKNESSES.
- L. IF FIELD GRADE ADJUSTMENTS ARE REQUIRED, THE CONTRACTOR SHALL NOTIFY THE ENGINEER.
- M. EXISTING UTILITY LINES ARE SHOWN IN AN APPROXIMATE MANNER ONLY AND MAY BE INCOMPLETE OR OBSOLETE. SUCH LINES MAY OR MAY NOT EXIST WHERE SHOWN OR NOT SHOWN. CONTRACTOR SHALL CONTACT NM—811 FOR UTILITY LINE SPOTS TWO WORKING DAYS PRIOR TO CONDUCTING SITE FIELD WORK. CONTRACTOR SHALL FIELD VERIFY AND LOCATE ALL UTILITIES PRIOR TO COMMENCEMENT OF ANY CONSTRUCTION. CONTRACTOR IS FULLY RESPONSIBLE FOR ANY AND ALL DAMAGE CAUSED BY ITS FAILURE TO LOCATE, IDENTIFY AND PRESERVE ANY AND ALL EXISTING UTILITIES, PIPELINES, AND UNDERGROUND UTILITY LINES. THE CONTRACTOR SHALL BE RESPONSIBLE FOR COORDINATION OF NECESSARY DRY UTILITY ADJUSTMENTS.
- N. CONTRACTOR SHALL PROVIDE ALL OTHER CONSTRUCTION STAKING.
 CONTRACTOR SHALL LOCATE AND PRESERVE ALL BOUNDARY CORNERS
 AND REPLACE ANY LOST OR DISTURBED CORNERS AT CONTRACTOR'S
 SOLE EXPENSE. PROPERTY CORNERS SHALL ONLY BE RESET BY A
 REGISTERED LAND SURVEYOR.
- O. A CURRENT STORMWATER CONTROL PERMIT, INCLUDING AN EROSION SEDIMENT CONTROL PLAN (E.S.C.) FOR EROSION AND SEDIMENT CONTROL IS REQUIRED FOR ALL CONSTRUCTION, DEMOLITION CLEARING, AND GRADING OPERATIONS THAT DISTURB THE SOIL ON ONE ACRE OR MORE OF LAND. OWNER WILL COORDINATE.
- P. POST—CONSTRUCTION MAINTENANCE FOR PRIVATE STORMWATER FACILITIES WILL BE THE RESPONSIBILITY OF THE FACILITIES OWNER. PERIODIC INSPECTION AND CERTIFICATIONS OF THE FACILITIES MAY BE REQUIRED BY THE CITY ENGINEER.
- Q. ADJUST ANY RIMS OF EXISTING UTILITY FEATURES AS NECESSARY TO MATCH NEW GRADES. UTILITIES IN PAVED AREAS SHALL BE HS-25 TRAFFIC RATED.
 R. ALL NEW PAVEMENT SURFACES SHALL BE CONSTRUCTED WITH POSITIVE
- SLOPE AWAY FROM BUILDINGS AND POSITIVE SLOPE TOWARD EXISTING AND/OR PROPOSED DRAINAGE PATHS. PAVING AND ROADWAY GRADES SHALL BE ±0.1' FROM PLAN ELEVATIONS. BUILDING PAD ELEVATION SHALL BE ±0.05' FROM PLAN ELEVATION.
- S. WHERE GRADES BETWEEN NEW AND EXISTING ARE SHOWN AS 'MATCH' OR '±'. TRANSITIONS SHALL BE SMOOTH.
- T. ENGINEER RECOMMENDS THAT OWNER INSPECT SITE YEARLY AND AFTER EACH RAINFALL TO IDENTIFY AREAS OF EROSION AND INSTALL EROSION PROTECTION AS NEEDED.
- U. ALL SITE PREPARATION, GRADING OPERATIONS, FOUNDATION CONSTRUCTION, AND PAVEMENT INSTALLATION WORK SHALL BE CONSTRUCTED IN ACCORDANCE WITH THE GEOTECHNICAL REPORT, WHICH WILL BE PROVIDED BY THE OWNER.
- // ENGINEER'S CERTIFICATION CANNOT BE PROVIDED UNTIL ALL SITE DRAINAGE IMPROVEMENT WORK IS COMPLETE AND PERMANENT EROSION PROTECTION IS INSTALLED PER PLAN. LANDSCAPING IS NOT REQUIRED FOR CERTIFICATION.

STORM DRAIN NOTES

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- INSTALL ALL STORM DRAIN INLETS AND PIPE PER ADS MANUFACTURER'S SPECIFICATIONS.
- ON-SITE PIPE SHALL BE ADS N-12 (WATERTIGHT) OR ENGINEER APPROVED EQUIVALENT. PIPE SHALL BE INSTALLED PER MANUFACTURER'S RECOMMENDATIONS.
- PIPE WITHIN ALAMEDA R.O.W. SHALL BE RCP OR ADS HP AS APPROVED BY C.O.A. HYDROLOGY. PIPE SHALL BE INSTALLED PER MANUFACTURER'S RECOMMENDATIONS.
- STORM DRAINS SHALL BE INSTALLED AT INVERTS AND SLOPES SPECIFIED ON THE PLANS. THE PIPE SHALL DRAIN AT A CONSTANT SLOPE BETWEEN FITTINGS AND MANHOLES. THE PIPE SHALL DRAIN TOWARD THE OUTLET AT ALL LOCATIONS.
- STORM DRAIN SYSTEM WILL REQUIRE REGULAR MAINTENANCE TO ENSURE PROPER FUNCTIONING DURING STORM EVENTS. ENGINEER RECOMMENDS THAT PROPERTY OWNER PUT IN PLACE INSPECTION AND MAINTENANCE CRITERIA SCHEDULED TO OCCUR MONTHLY AND AFTER EACH STORM EVENT.
- VIBRATORY COMPACTION SHALL NOT BE USED OVER IN-PLACE UTILITIES.
- ALL BACKFILL SHALL BE COMPACTED TO A MINIMUM 95% DENSITY PER ASTM D-1557.

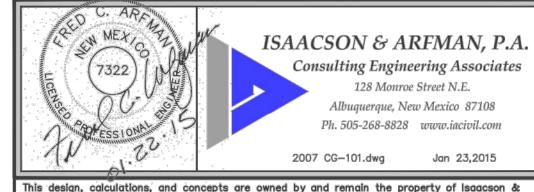

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ALAMEDA SELF-STORAGE STORM DRAIN IMPROVEMENTS

PARKS CONSTRUCTION

DRAINAGE DETAILS

Date:	No.	Revision	Date:	Job No.				
01.23.15				2007				
Drawn By:	Ш			00 501				
BJB				CG-501				
Ckd By:				SH. OF				
FCA				7 3H. OF				