

PREVIOUSLY GRADED PROPERTY, THAT IS PART OF THE MASTER

PROJECT. PASEO DEL NORTE IS TO THE SOUTH. THERE ARE

THERE IS AN EXISTING MASTER DRAINAGE PLAN FOR THE SITE.

A RETENTION POND TO THE EAST THAT CAPTURES FLOWS FROM

DEVELOPMENTS TO THE EAST AND NORTHEAST. MINOR OFFSITE

STORM WATER FLOWS IN THE ACCESS ROAD ON THE NORTH

PLANNED HOLLY PLACE (AKA PASEO PLACE) COMMERCIAL

EXISTING DEVELOPMENTS TO THE EAST AND WEST, WITH

UNDEVELOPED COMMERCIAL TRACTS TO THE NORTH.

BASIN 5 IS AN EXISITNG PARKING AREA THAT IS BEING

CORNER OF THE BASIN.

SEE CALCULATIONS ON SHEET CG-501

INCORPORATED INTO THE APPLEBEE'S PROPERTY. THE BASIN

FLOWS TO THE EXISTING RETENTION POND ON THE NORTHEAST

ACRES SITE **GENERAL NOTES**

VICINITY MAP

<u>+</u>

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iverall layout, form, arrangement, and composition of space: ind elements portraved, constitute the original, unpublished

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VERIFY ACTUAL CONDITIONS and dimensions prior to construction.

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DIMENSIONS SHOWN are to finish face of a material unless otherwise indicated

CALCULATE & MEASURE dimensions - DO NOT SCALE drawings unless otherwise directed.

project title

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project number

commencement of work constitutes verification and acceptance of all existing conditions. Application of a material or equipment item to Work installed by others constitutes acceptance of that Work, and assumption

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COORDINATE WORK WITH SITE PLAN, UTILITY PLAN, DEMOLITION PLAN, AND LANDSCAPE PLAN.

B. ALL TRASH, DEBRIS, & SURFACE VEGETATION SHALL BE CLEARED AND LEGALLY DISPOSED OF OFFSITE.

ALL SUBGRADE, OVEREXCAVATION, AND FILL SHALL BE PLACED AND / OR COMPACTED PER THE GEOTECHNICAL REPORT AND CITY OF ALBUQUERQUE SPECIFICATIONS.

FINAL GRADES SHOWN REPRESENT TOP OF FINISH MATERIAL (I.E. TOP OF CONCRETE, TOP OF CONCRETE BUILDING PAD, TOP OF PAVEMENT MATERIAL, TOP OF LANDSCAPING MATERIAL, ETC.). CONTRACTOR SHALL GRADE, COMPACT SUBGRADE AND DETERMINE EARTHWORK ESTIMATES BASED ON ELEVATIONS SHOWN MINUS FINISH MATERIAL THICKNESSES.

UNIFORMLY GRADE AREAS WITHIN LIMITS OF GRADING AS SHOWN ON PLAN. COMPACT WITH UNIFORM SLOPES BETWEEN POINTS WHERE ELEVATIONS ARE INDICATED.

EXISTING UTILITY LINES ARE SHOWN IN AN APPROXIMATE MANNER ONLY AND MAY BE INCOMPLETE OR OBSOLETE. SUCH LINES MAY OR MAY NOT EXIST WHERE SHOWN OR NOT SHOWN. CONTRACTOR SHALL CONTACT NM-811 FOR UTILITY LINE SPOTS TWO WORKING DAYS PRIOR TO CONDUCTING SITE FIELD WORK. CONTRACTOR SHALL FIELD VERIFY AND LOCATE ALL UTILITIES PRIOR TO COMMENCEMENT OF ANY CONSTRUCTION. CONTRACTOR IS FULLY RESPONSIBLE FOR ANY AND ALL DAMAGE CAUSED BY ITS FAILURE TO LOCATE, IDENTIFY AND PRESERVE ANY AND ALL EXISTING UTILITIES, PIPELINES, AND UNDERGROUND UTILITY LINES.

OWNER WILL PROVIDE SOIL TESTING AND INSPECTION SERVICES DURING EARTHWORK OPERATIONS, CONTRACTOR SHALL ALLOW TESTING LABS TO INSPECT AND APPROVE COMPACTED SUBGRADES AND FILL LAYERS BEFORE FURTHER CONSTRUCTION WORK IS DONE. SHOULD COMPACTION TESTS INDICATE INADEQUATE DENSITY, CONTRACTOR SHALL PROVIDE ADDITIONAL COMPACTION AND TESTING AT THE CONTRACTOR'S SOLE

OWNER HAS ESTABLISHED PROPERTY BOUNDARY CORNERS. CONTRACTOR SHALL PROVIDE ALL OTHER CONSTRUCTION STAKING. CONTRACTOR SHALL LOCATE AND PRESERVE ALL BOUNDARY CORNERS AND REPLACE ANY LOST OR DISTURBED CORNERS AT CONTRACTOR'S SOLE EXPENSE.

THE ENVIRONMENTAL PROTECTION AGENCY (EPA) AND THE CITY OF ALBUQUERQUE REQUIRE A STORM WATER POLLUTION PREVENTION PLAN (SWPPP), AN NDPES PERMIT, AND AN EROSION AND SEDIMENT CONTROL (ESC) PERMIT FOR PROJECTS WHERE CONSTRUCTION ACTIVITIES MEET THE EPA THRESHOLD. (SWPPP, NPDES PERMIT, AND ESC PLAN BY OTHERS.) A CITY-APPROVED ESC PERMIT MUST BE INCLUDED WITH THE CONTRACTOR'S SUBMITTAL FOR A ROUGH GRADING, GRADING, PAVING, BUILDING, OR WORK ORDER PERMIT.

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ALL FRACTURED FACE ROCK (F.F. ROCK) TO BE 6" AVG. DIA. ANGULAR FACED ROCK PLACED OVER GÉOTEX 501 NON-WOVEN

ENGINEER RECOMMENDS THAT OWNER MAINTAIN EROSION PROTECTION ELEMENTS. ENGINEER RECOMMENDS THAT OWNER INSPECT SITE YEARLY AND AFTER EACH RAINFALL TO IDENTIFY NEW AREAS OF EROSION AND INSTALL ADDITIONAL EROSION PROTECTION AS NEEDED BASED ON

13024.016 drawing issuance

drawing revisions No. Description: Date:

LEGEND

FLOW ARROW

ISAACSON & ARFMAN, P.A. 128 Monroe Street N.E.

Consulting Engineering Associates Albuquerque, New Mexico 87108

drawing title **GRADING &** DRAINAGE PLAN **drawing** number

professionalseal

CG-101 MUNCEPTUAL

15. DEPRESS ALL LANDSCAPING MIN. 6" TO PROVIDE WATER

THEM TO THE WESTERN PARKING AREA. SEE DETAIL ON CG-501. CUT GRATE AS NEEDED TO ALLOW ROOF DRAIN FLOWS TO ENTER TRENCH DRAIN.

HARVESTING EXCEPT FOR ALL AREAS WITHIN 10' OF BLDG.

CUT GRATE AS NEEDED TO ALLOW ROOF DRAIN FLOWS TO ENTER TRENCH DRAIN.

16. TRENCH DRAIN THROUGH SIDEWALK. SEE DETAIL ON CG-501.

17. TRENCH DRAIN TO CAPTURE ROOF DRAIN FLOWS, AND DIRECT

EXISTING CONTOUR EXISTING SPOT ELEVATION PROPOSED CONTOUR

PROPOSED SPOT ELEVATION

FINISH FLOOR ELEVATION



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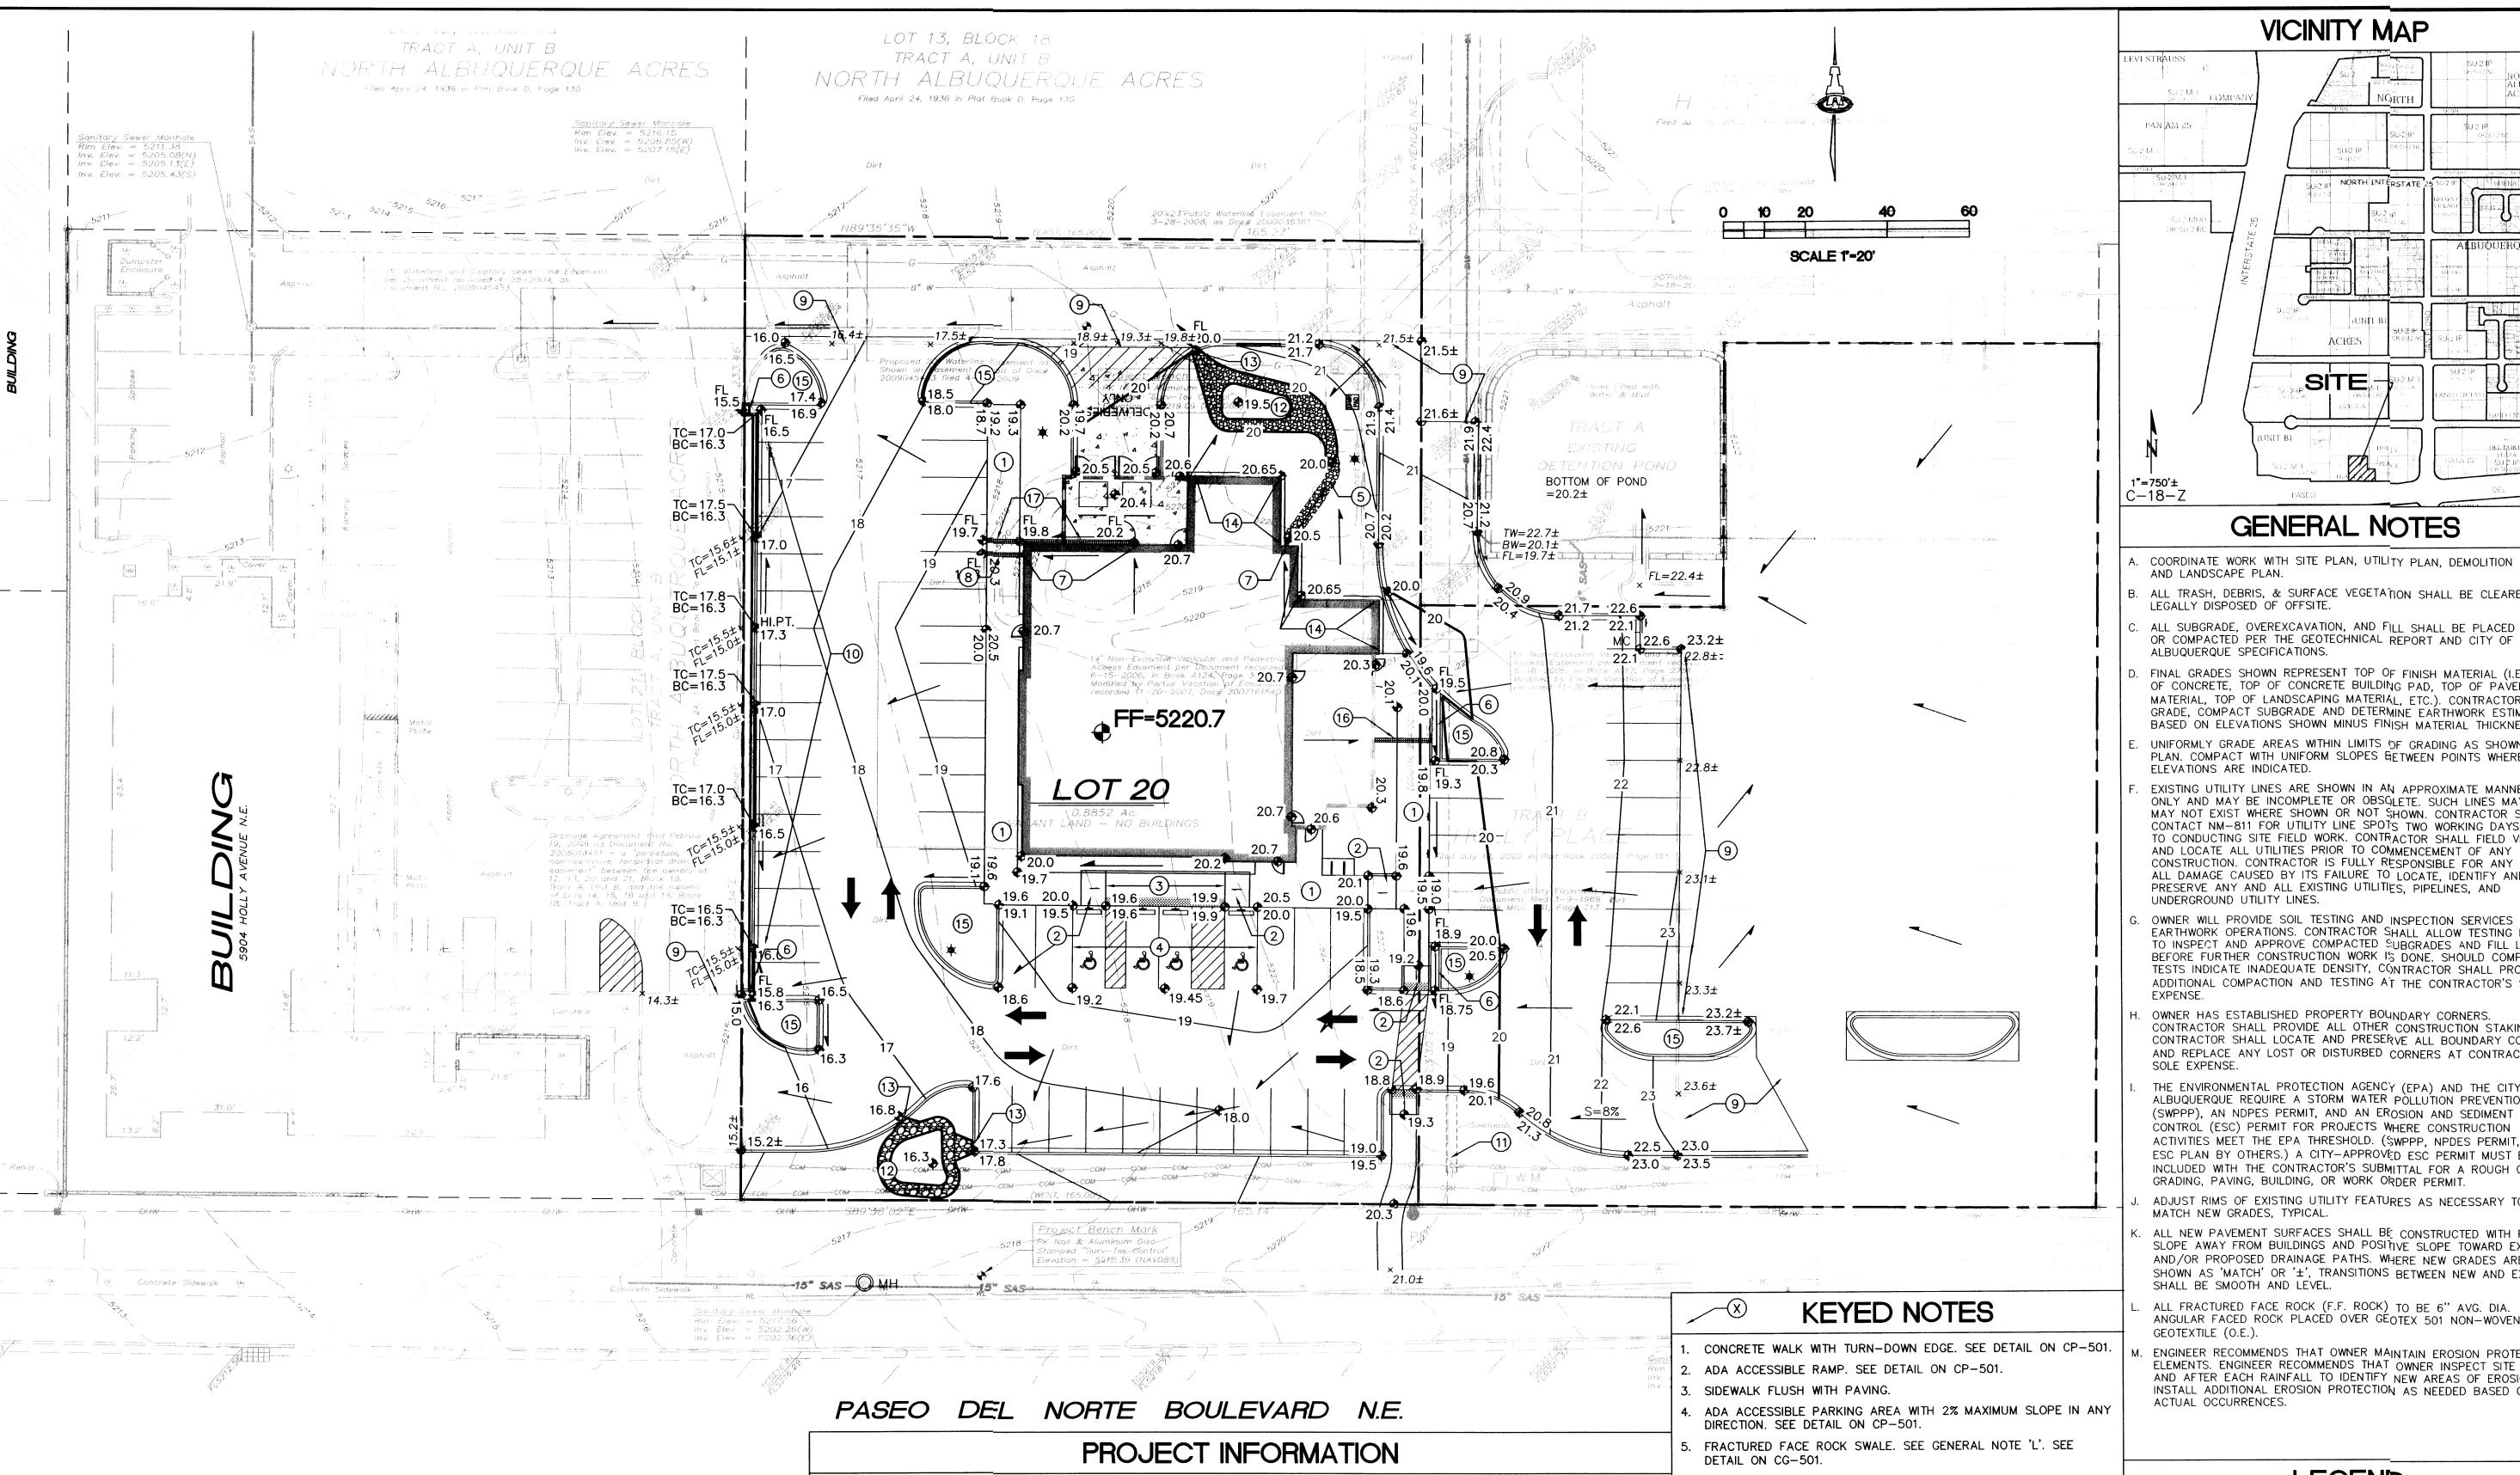
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LAND DEVELOPMENT SECTION



LEGAL DESCRIPTION: LOT 20, BLOCK 18, TRACT A, UNIT B, NORTH ALBUQUERQUE ACRES, TOGETHER WITH PORTIONS OF TRACT B, HOLLY PLACE.

1.16 ACRES

BENCHMARK: VERTICAL DATUM IS BASED ON THE ALBUQUERQUE CONTROL SURVEY BENCHMARK "9-C18" HAVING A PUBLISHED ELEVATION OF 5232.470' (NAVD 1988)

<u>SURVEYOR:</u> SURV-TEK, INC. 9384 VALLEY VIEW DR NW ALBUQUERQUE, NM 87114 RUSS T. HUGG, PLS (505) 897-3366

FLOOD HAZARD: THIS SITE IS OUTSIDE OF THE 100-YEAR FLOOD PLAIN, PER FEMA FIRM PANEL 35001C0137H DATED

AUGUST 16, 2012 EXISTING CONDITIONS: THIS SITE IS AN UNDEVELOPED.

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THERE IS AN EXISTING MASTER DRAINAGE PLAN FOR THE SITE. A RETENTION POND TO THE EAST THAT CAPTURES FLOWS FROM DEVELOPMENTS TO THE EAST AND NORTHEAST. MINOR OFFSITE STORM WATER FLOWS IN THE ACCESS ROAD ON THE NORTH

SIDE OF THE PROJECT. FLOWS FROM THE EXISTING PARKING LOT TO THE EAST ARE DIVERTED NORTH, AND DON'T ENTER

THE PROPERTY SLOPES TO THE WEST, AND HAS HAD PREVIOUS GRADING ACTIVITIES.

PROPOSED CONDITIONS: PER THE MASTER DRAINAGE PLAN, THIS SITE IS ALLOWED FREE DISCHARGE FOR UP TO 85% TYPE D LAND TREATMENT. STORM WATER FROM THE THIS SITE WILL BE DIRECTED TO THE WEST.

BASINS 1, 2, & 3 ARE DIRECTED TO THE SE CORNER OF THE PROPERTY, WHERE THEY ARE SURFACE DISCHARGED TO THE ADJACENT PARKING LOT THROUGH CONCRETE RUNDOWNS AND A DRIVE PATH CONNECTION.

BASIN 4, WHICH INCLUDES THE ROOF RUNOFF, IS DIRECTED NORTH, WHERE IT DISCHARGES THE SITE EITHER TO THE ADJACENT PARKING LOT THROUGH A CONCRETE RUNDOWN, OR NORTH TO THE EXISTING ACCESS ROAD.


BASIN 5 IS AN EXISITNG PARKING AREA THAT IS BEING INCORPORATED INTO THE APPLEBEE'S PROPERTY. THE BASIN FLOWS TO THE EXISTING RETENTION POND ON THE NORTHEAST CORNER OF THE BASIN.

SEE CALCULATIONS ON SHEET CG-501

- 6. 2' WIDE CONCRETE RUNDOWN. SEE DETAIL ON CP-501. '. ROOF DRAIN LOCATION. SEE ARCHITECTURAL PLANS.
- 8. EXTEND 4" ROOF DRAIN THROUGH FACE OF WALK. SEE DETAIL ON
- . TIE NEW PAVING TO EXISTING PAVING. PROVIDE SMOOTH TRANSITION.

CG-501.

- 10. EXTENDED DEPTH HEADER CURB WITH GUTTER TO ACHIEVE GRADE DIFFERENCE SHOWN. SEE DETAIL ON CG-501.
- 1. EXISTING SIGN. CONTRACTOR TO PROTECT DURING CONSTRUCTION.
- 12. 6" DEEP WATER HARVESTING AREA WITH FRACTURED FACE ROCK SIDE SLOPES AT 6:1. MUST BE AT LEAST 10' AWAY FROM BUILDING FOOTPRINT. SEE GENERAL NOTE 'L'.
- 13. 2' WIDE CURB OPENING. SEE DETAIL ON CG-501.
- 14. CONSTRUCT 8" WIDE CONCRETE MOW CURB ADJACENT TO BUILDING THIS AREA TO ACHIEVE GRADES SHOWN. SEE DETAIL ON CG-501.
- 15. DEPRESS ALL LANDSCAPING MIN. 6" TO PROVIDE WATER HARVESTING EXCEPT FOR ALL AREAS WITHIN 10' OF BLDG.
- 16. TRENCH DRAIN THROUGH SIDEWALK. SEE DETAIL ON CG-501. CUT GRATE AS NEEDED TO ALLOW ROOF DRAIN FLOWS TO ENTER TRENCH DRAIN.
- 17. TRENCH DRAIN TO CAPTURE ROOF DRAIN FLOWS, AND DIRECT THEM TO THE WESTERN PARKING AREA. SEE DETAIL ON CG-501. CUT GRATE AS NEEDED TO ALLOW ROOF DRAIN FLOWS TO ENTER TRENCH DRAIN.

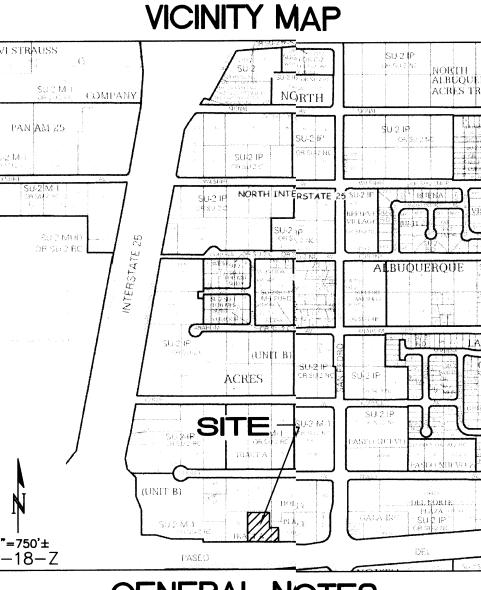

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LEGEND

EXISTING CONTOUR EXISTING SPOT ELEVATION

PROPOSED CONTOUR PROPOSED SPOT ELEVATION

FLOW ARROW

FINISH FLOOR ELEVATION



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project number

13024.016 **drawing**issuance

drawing revisions Description: Date:



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d rawingtitle GRADING & DRAINAGE PLAN Qdyr_□qaryw ing number



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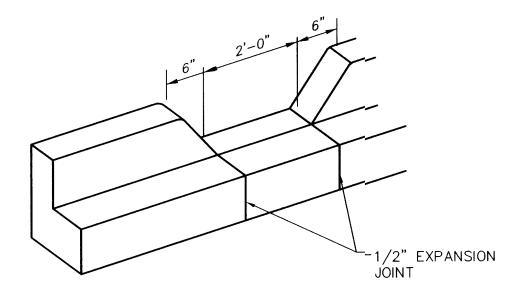
CG-101

Sub-basin Peak Discharge Rate: (see formula above)

5.6 CFS | Developed Q = 7.7 CFS

---- WATERPROOF SEALANT LANDSCAPE MATERIAL

 EDGE EXPOSED CORNERS WITH A 3/8" EDGING TOOL CONSTRUCTION CONTROL JOINTS AT 6' O.C. MAX. • 1/2" EXPANSION JOINTS AT CORNERS SLOPE TOP AT 2% AWAY FROM BLDG.



1. EDGES NOT SPECIFICALLY DIMENSIONED SHALL BE SHAPED WITH A 3/8" EDGING TOOL.

CONCRETE MOW CURB

FACE OF CURB

SCALE: N.T.S.

CURB OPENING

CONSTRUCT ALL SWALES BELOW ADJACENT GRADE TO

2'-0"

- CONTROL


• VARY ANGULAR FACE ROCK SIZE BETWEEN 4" AND 8"

• PLACE GEOTEX 501 NON-WOVEN GEOTEXTILE (O.E.)

BENEATH ALL EROSION PROTECTION

ENSURE RUNOFF CAN BE CAPTURED AND CONVEYED

SCALE: N.T.S.

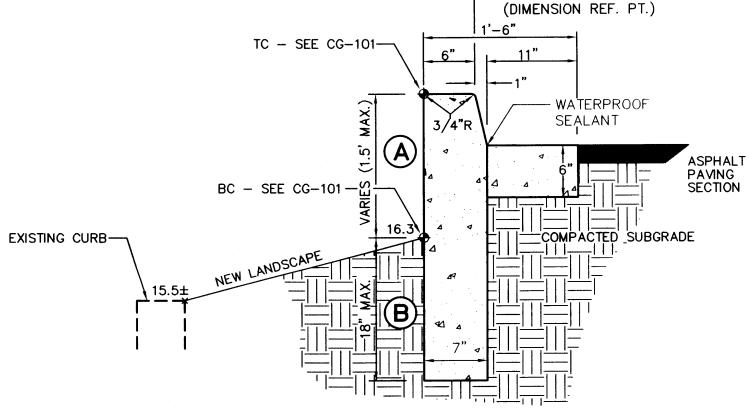

GENERAL NOTES


- PROVIDE CONST. CONTROL JOINTS @ 6' O.C. MAX. AND 1/2" EXPANSION JOINTS @ 48' O.C. MAX
- 2. EDGES SHOULD BE REMOVED WITH 3/8" EDGING TOOL
- 3. FULL FORM ON ALL FACES

< 1/2" EXPANSION JOINT</pre>

GRATES (1/4" HOLES)

- CURB HEIGHT ABOVE GRADE (TC-BC)
- B DEPTH BELOW GRADE A MUST BE = OR >

EXTENDED HEADER CURB SCALE: N.T.S.

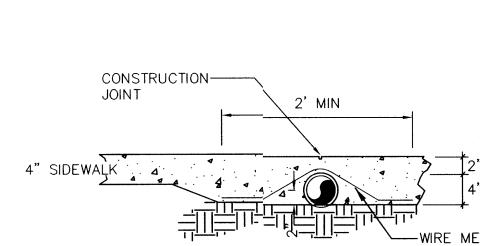

ROCK SWALE

PROPERLY

DIA. (AVG.=6")

SCALE: N.T.S.

SCALE: N.T.S.

PIPE THROUGH WALK

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project number **drawing**issuance

drawing revisions



drawing title **GRADING DETAILS** & CALCUATIONS **drawing** number CG 501 SEP 2 3 2013

LAND DEVELOPMENT SECTION

Historic =

PRE-CAST TRENCH-

DRAIN W/ BUILT-IN 0.6% FLÓOR SLOPE

AND PERFORATED

GALVANIZED STEEL

NOTE: TRENCH DRAIN SYSTEM

BY ACO POLYMER PRODUCTS,

OR APPROVED EQUAL.

TRENCH DRAIN DETAIL

SCALE: N.T.S.


TG (TOP OF GRATE)

SHOWN ON PLANS

4" CONCRETE

- INVERT ELEVATIONS AS SHOWN ON PLANS

ELEVATION AS

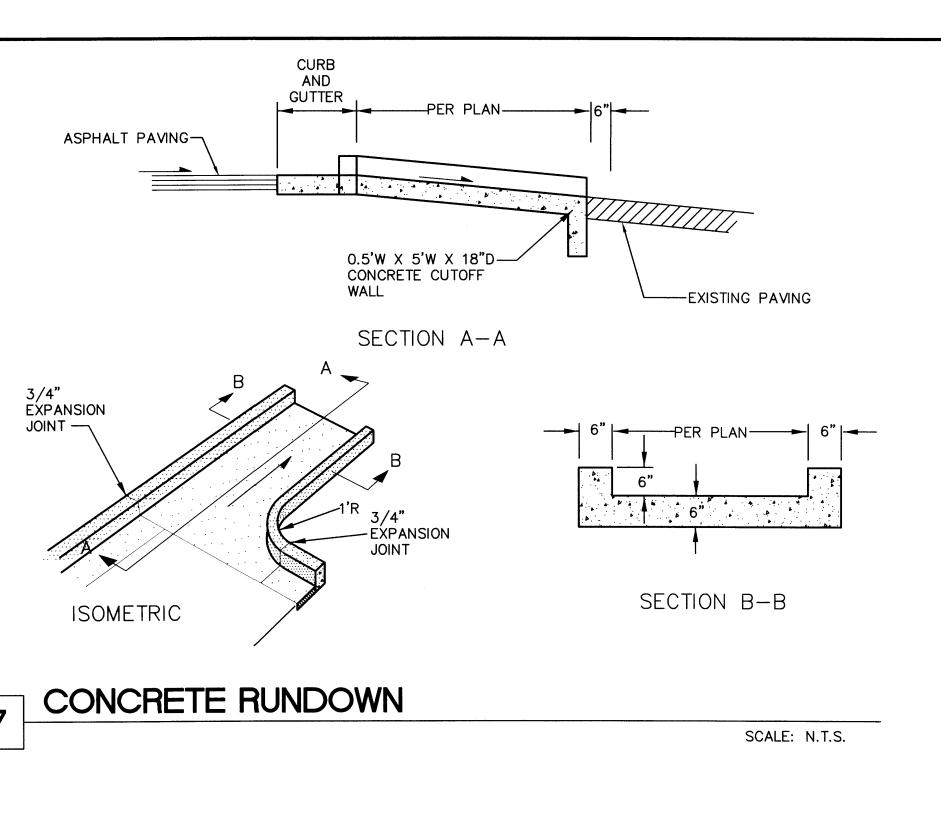

-INSERT ADS INTERNAL END PLUG

(#0633AA) WITH 3" DIA HOLE

CUT IN THE CENTER INTO THE

EX 6" SD

-USE WATERPROOF

SILICONE CAULKING TO

SCALE: N.T.S.

SEAL PLUG IN PLACE,

EXISTING 6" STORM DRAIN PIPE.

EXISTING GRATE IN BOTTOM OF POND-

EXISTING OIL & GRIT "SNOUT".—

REMOVE & RE—INSTALL

SNOUT AS NEEDED TO GAIN

ACCESS TO THE PIPE.

EXISTING NYLOPLAST

RESTORE FUNCTION.

REMOVE & DISPOSE OF DEBRIS — FROM INLET SUMP. CLEAN OUT

STORM DRAIN AS NEEDED TO

BASIN INLET


POND OUTLET REDUCTION DETAIL

— WATERPROOF SEALANT LANDSCAPE FOUNDATION MATERIAL

 EDGE EXPOSED CORNERS WITH A 3/8" EDGING TOOL. CONSTRUCTION CONTROL JOINTS AT 6' O.C. MAX.

CONCRETE MOW CURB

 1/2" EXPANSION JOINTS AT CORNERS SLOPE TOP AT 2% AWAY FROM BLDG.

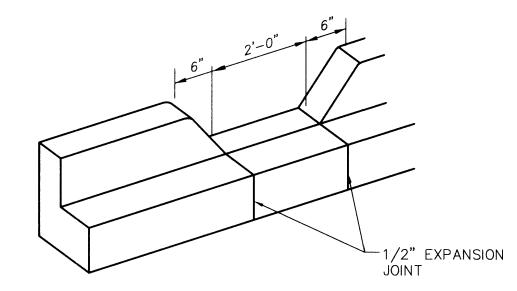


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CURB OPENING


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-CONSTRUCT ALL SWALES BELOW ADJACENT GRADE TO ENSURE RUNOFF CAN BE CAPTURED AND CONVEYED PROPERLY



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PIPE THROUGH WALK


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> Albuquerque, New Mexico 87108 Ph. 505-268-8828 www.iacivil.com

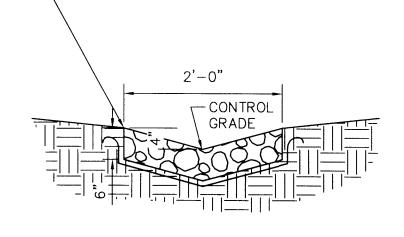SCALE: N.T.S.

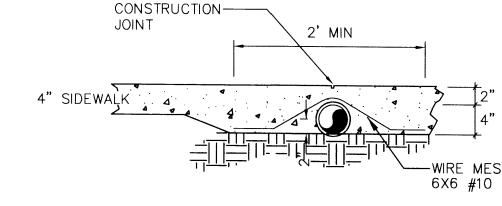drawing title **GRADING DETAILS** & CALCUATIONS **drawing** number

CG-501

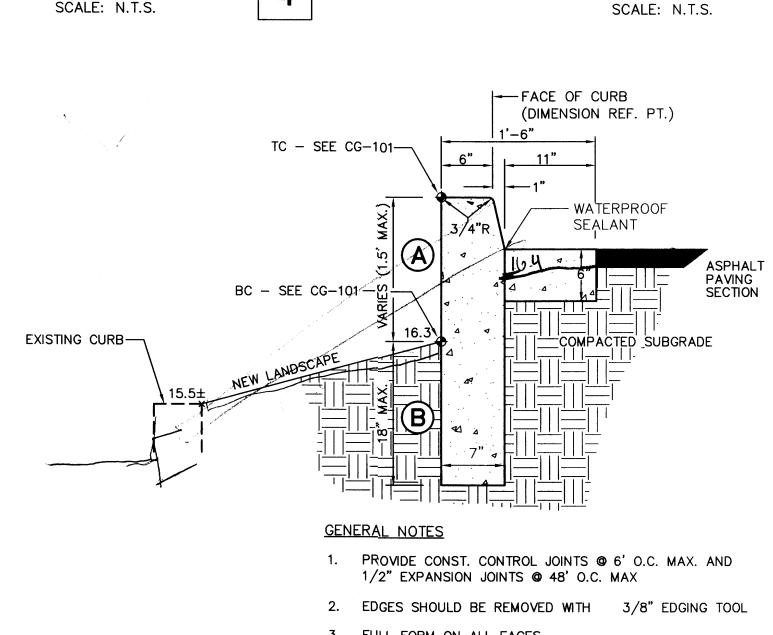


3. FULL FORM ON ALL FACES

CURB HEIGHT ABOVE GRADE (TC-BC)

B DEPTH BELOW GRADE A MUST BE = OR >

EXTENDED HEADER CURB SCALE: N.T.S.

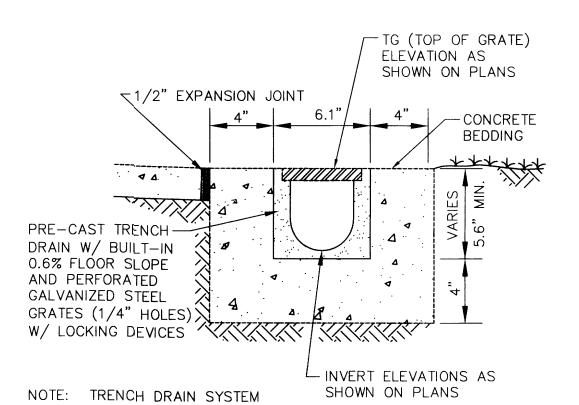

BY ACO POLYMER PRODUCTS, OR APPROVED EQUAL.

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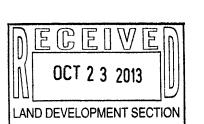
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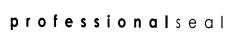
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project number

drawing issuance BID / PERMIT drawing revisions No. Description: Date:

ADD EAST
PARKING LOT 09-20-13







PROJECT INFORMATION

<u>LEGAL DESCRIPTION:</u> LOT 20, BLOCK 18, TRACT A, UNIT B, NORTH ALBUQUERQUE ACRES, TOGETHER WITH PORTIONS OF TRACT B, HOLLY PLACE.

1.16 ACRES AREA:

BENCHMARK: VERTICAL DATUM IS BASED ON THE ALBUQUERQUE CONTROL SURVEY BENCHMARK "9-C18" HAVING A PUBLISHED ELEVATION OF 5232.470' (NAVD 1988)

SURV-TEK, INC. SURVEYOR:

9384 VALLEY VIEW DR NW ALBUQUERQUE, NM 87114 RUSS T. HUGG, PLS (505) 897-3366

FLOOD HAZARD: THIS SITE IS OUTSIDE OF THE 100-YEAR FLOOD PLAIN, PER FEMA FIRM PANEL 35001C0137H DATED AUGUST 16, 2012

EXISTING CONDITIONS: THIS SITE IS AN UNDEVELOPED. PREVIOUSLY GRADED PROPERTY, THAT IS PART OF THE MASTER PLANNED HOLLY PLACE (AKA PASEO PLACE) COMMERCIAL PROJECT. PASEO DEL NORTE IS TO THE SOUTH. THERE ARE EXISTING DEVELOPMENTS TO THE EAST AND WEST, WITH UNDEVELOPED COMMERCIAL TRACTS TO THE NORTH.

THERE IS AN EXISTING MASTER DRAINAGE PLAN FOR THE SITE THAT RESTRICTS DISCHARGE FROM THE MAJORITY OF THE PROJECT TO 4.629 CFS/AC (BASINS 1-4 CAN DISCHARGE 4.7 CFS MAX). A RETENTION POND TO THE EAST THAT CAPTURES

FLOWS FROM DEVELOPMENTS TO THE EAST, NORTHEAST, AND A PORTION OF THE EASTERN SIDE OF THE PROPOSED SITE. THE POND DISCHARGES 0.8 CFS TO A PRIVATE STORM DRAIN.

MINOR OFFSITE STORM WATER FLOWS IN THE ACCESS ROAD ON THE NORTH SIDE OF THE PROJECT CONTINUE WEST IN THE ROAD. FLOWS FROM THE EXISTING PARKING LOT TO THE EAST ARE DIVERTED NORTH, AND DON'T ENTER THIS SITE.

THE PROPERTY SLOPES TO THE WEST, AND HAS HAD PREVIOUS GRADING ACTIVITIES.

PROPOSED CONDITIONS: PER THE MASTER DRAINAGE PLAN, MOST OF THIS SITE IS ALLOWED FREE DISCHARGE FOR UP TO 85% TYPE D LAND TREATMENT. SUB-BASINS 1a, 2a, & 3a WERE ORIGINALLY INTENDED TO BE CAPTURED BY THE EXISTING DETENTION POND. THESE STORM FLOWS, ALONG WITH OTHER STORM WATER FROM THIS SITE WILL BE DIRECTED TO THE WEST. AN FOUIVALENT AMOUNT OF STORM WATER FROM SUB-BASINS 1a, 2a, & 3a WILL BE CAPTURED.

TO MAINTAIN THE MAXIMUM DISCHARGE OF FROM THE OVERALL PASEO/HOLLY PLACE DEVELOPMENT, THE OUTPUT FROM THE EXISTING DETENTION POND IS REDUCED FROM 0.8 CFS TO 0.45 CFS, BY CONSTRICTING THE OUTLET DIAMETER TO 3". THE PEAK 100-YEAR FLOW DISCHARGED FROM THE REMAINDER OF THE SITE MAY BE INCREASED BY 0.35 CFS. THIS INCREASES THE TOTAL ALLOWED DISCHARGE FOR BASINS 1-4 TO 5.1 CFS. THIS MEANS 611 CF OF ADDITIONAL STORM WATER MUST BE

DETAINED/RETAINED ONSITE.

BASINS 1, 2, & 3, WHICH INCLUDE SUB-BASINS 1a, 2a, & 3a, ARE DIRECTED TO THE PARKING LOT ON THE EAST SIDE OF THE PROPERTY, WHERE 461 CF OF STORM WATER PONDS UNTIL IT DISCHARGES THROUGH 2-1' WIDE CONCRETE RUNDOWNS AND 3-4" DIA. PVC PIPES THROUGH THE CURB. THE FLOWS PASS THROUGH THE ADJACENT PARKING LOT, AND EVENTUALLY REACH HOLLY DRIVE TO THE NORTH.

BASIN 4 DISCHARGES THE SITE NORTH TO THE EXISTING ACCESS ROAD. A 186 CF RETENTION POND IN THE LANDSCAPING AREA WILL CAPTURE STORM WATER FROM A PORTION OF THE ROOF AND LANDSCAPING.

BASIN 5 IS AN EXISITNG PARKING AREA THAT IS BEING INCORPORATED INTO THE APPLEBEE'S PROPERTY. THE BASIN FLOWS TO THE EXISTING RETENTION POND ON THE NORTHEAST CORNER OF THE BASIN.

SEE CALCULATIONS SEPARATELY.

KEYED NOTES CONCRETE WALK WITH TURN-DOWN EDGE. SEE DETAIL ON

ADA ACCESSIBLE RAMP. SEE DETAIL ON CP-501.

- SIDEWALK FLUSH WITH PAVING.
- ADA ACCESSIBLE PARKING AREA WITH 2% MAXIMUM SLOPE IN ANY DIRECTION. SEE DETAIL ON CP-501.
- FRACTURED FACE ROCK SWALE. SEE GENERAL NOTE 'L'. SEE DETAIL ON CG-501.
- 5. 2' WIDE CONCRETE RUNDOWN. SEE DETAIL ON CG-501. . ROOF DRAIN LOCATION. SEE ARCHITECTURAL PLANS.
- TIE NEW PAVING TO EXISTING PAVING. PROVIDE SMOOTH TRANSITION.

ON CG-501.

- 10. EXTENDED DEPTH HEADER CURB WITH GUTTER TO ACHIEVE GRADE DIFFERENCE SHOWN. SEE DETAIL ON CG-501. I. EXISTING SIGN. CONTRACTOR TO PROTECT DURING CONSTRUCTION.
- 12. 8" DEEP POND WITH FRACTURED FACE ROCK SIDE SLOPES AT 4:1. MUST BE AT LEAST 10' AWAY FROM BUILDING FOOTPRINT. SEE GENERAL NOTE 'L'.
- 13. 2' WIDE CURB OPENING. SEE DETAIL ON CG-501.

14. CONSTRUCT 8" WIDE CONCRETE MOW CURB ADJACENT TO BUILDING THIS AREA TO ACHIEVE GRADES SHOWN. SEE DETAIL ON CG-501.

15. DEPRESS ALL LANDSCAPING MIN. 6" TO PROVIDE WATER

- HARVESTING EXCEPT FOR ALL AREAS WITHIN 10' OF BLDG.
- 16. TRENCH DRAIN THROUGH SIDEWALK. SEE DETAIL ON CG-501. CUT GRATE AS NEEDED TO ALLOW ROOF DRAIN FLOWS TO ENTER TRENCH DRAIN.
- 17. TRENCH DRAIN TO CAPTURE ROOF DRAIN FLOWS, AND DIRECT THEM TO THE WESTERN PARKING AREA. SEE DETAIL ON CG-501. CUT GRATE AS NEEDED TO ALLOW ROOF DRAIN FLOWS TO ENTER TRENCH DRAIN.
- . EXTEND 4" ROOF DRAIN THROUGH FACE OF WALK. SEE DETAIL 18. 1' WIDE CONCRETE RUNDOWN. SEE DETAIL ON CG-501
 - 19. 4" DIA DRAIN LINE THROUGH CURB PER COA STD DWG #2235.
 - 20. RESTRICT FLOW FROM EXISTING POND OUTLET BY INSERTING A PLUG INTO THE EXISTING 6" OUTLET STORM DRAIN. CUT A 3" DIA HOLE CUT INTO THE PLUG. SEE POND OUTLET REDUCTION DETAIL ON CG-501.
 - 21. 2' WIDE SIDEWALK CULVERT PER COA STD DWG #2235.

LEGEND

EXISTING CONTOUR

EXISTING SPOT ELEVATION

VICINITY MAP

ACRES


GENERAL NOTES

PROPOSED CONTOUR

PROPOSED SPOT ELEVATION FLOW ARROW

FF = 5220.7 FINISH FLOOR ELEVATION

ISAACSON & ARFMAN, P.A Consulting Engineering Associates 128 Monroe Street N.E. Albuquerque, New Mexico 87108 Ph. 505-268-8828 www.iacivil.com Oct 23,2013

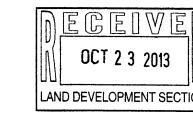



drawing title GRADING & DRAINAGE PLAN drawing number

CG-101

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HE ARCHITECT DISCLAIMS responsibility for the existing building

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project title


project number 13024.016 drawing issuance

drawing revisions Description: Date: ADD EAST

/1\ PARKING LOT 09-20-13

LAND DEVELOPMENT SECTION

professionalseal

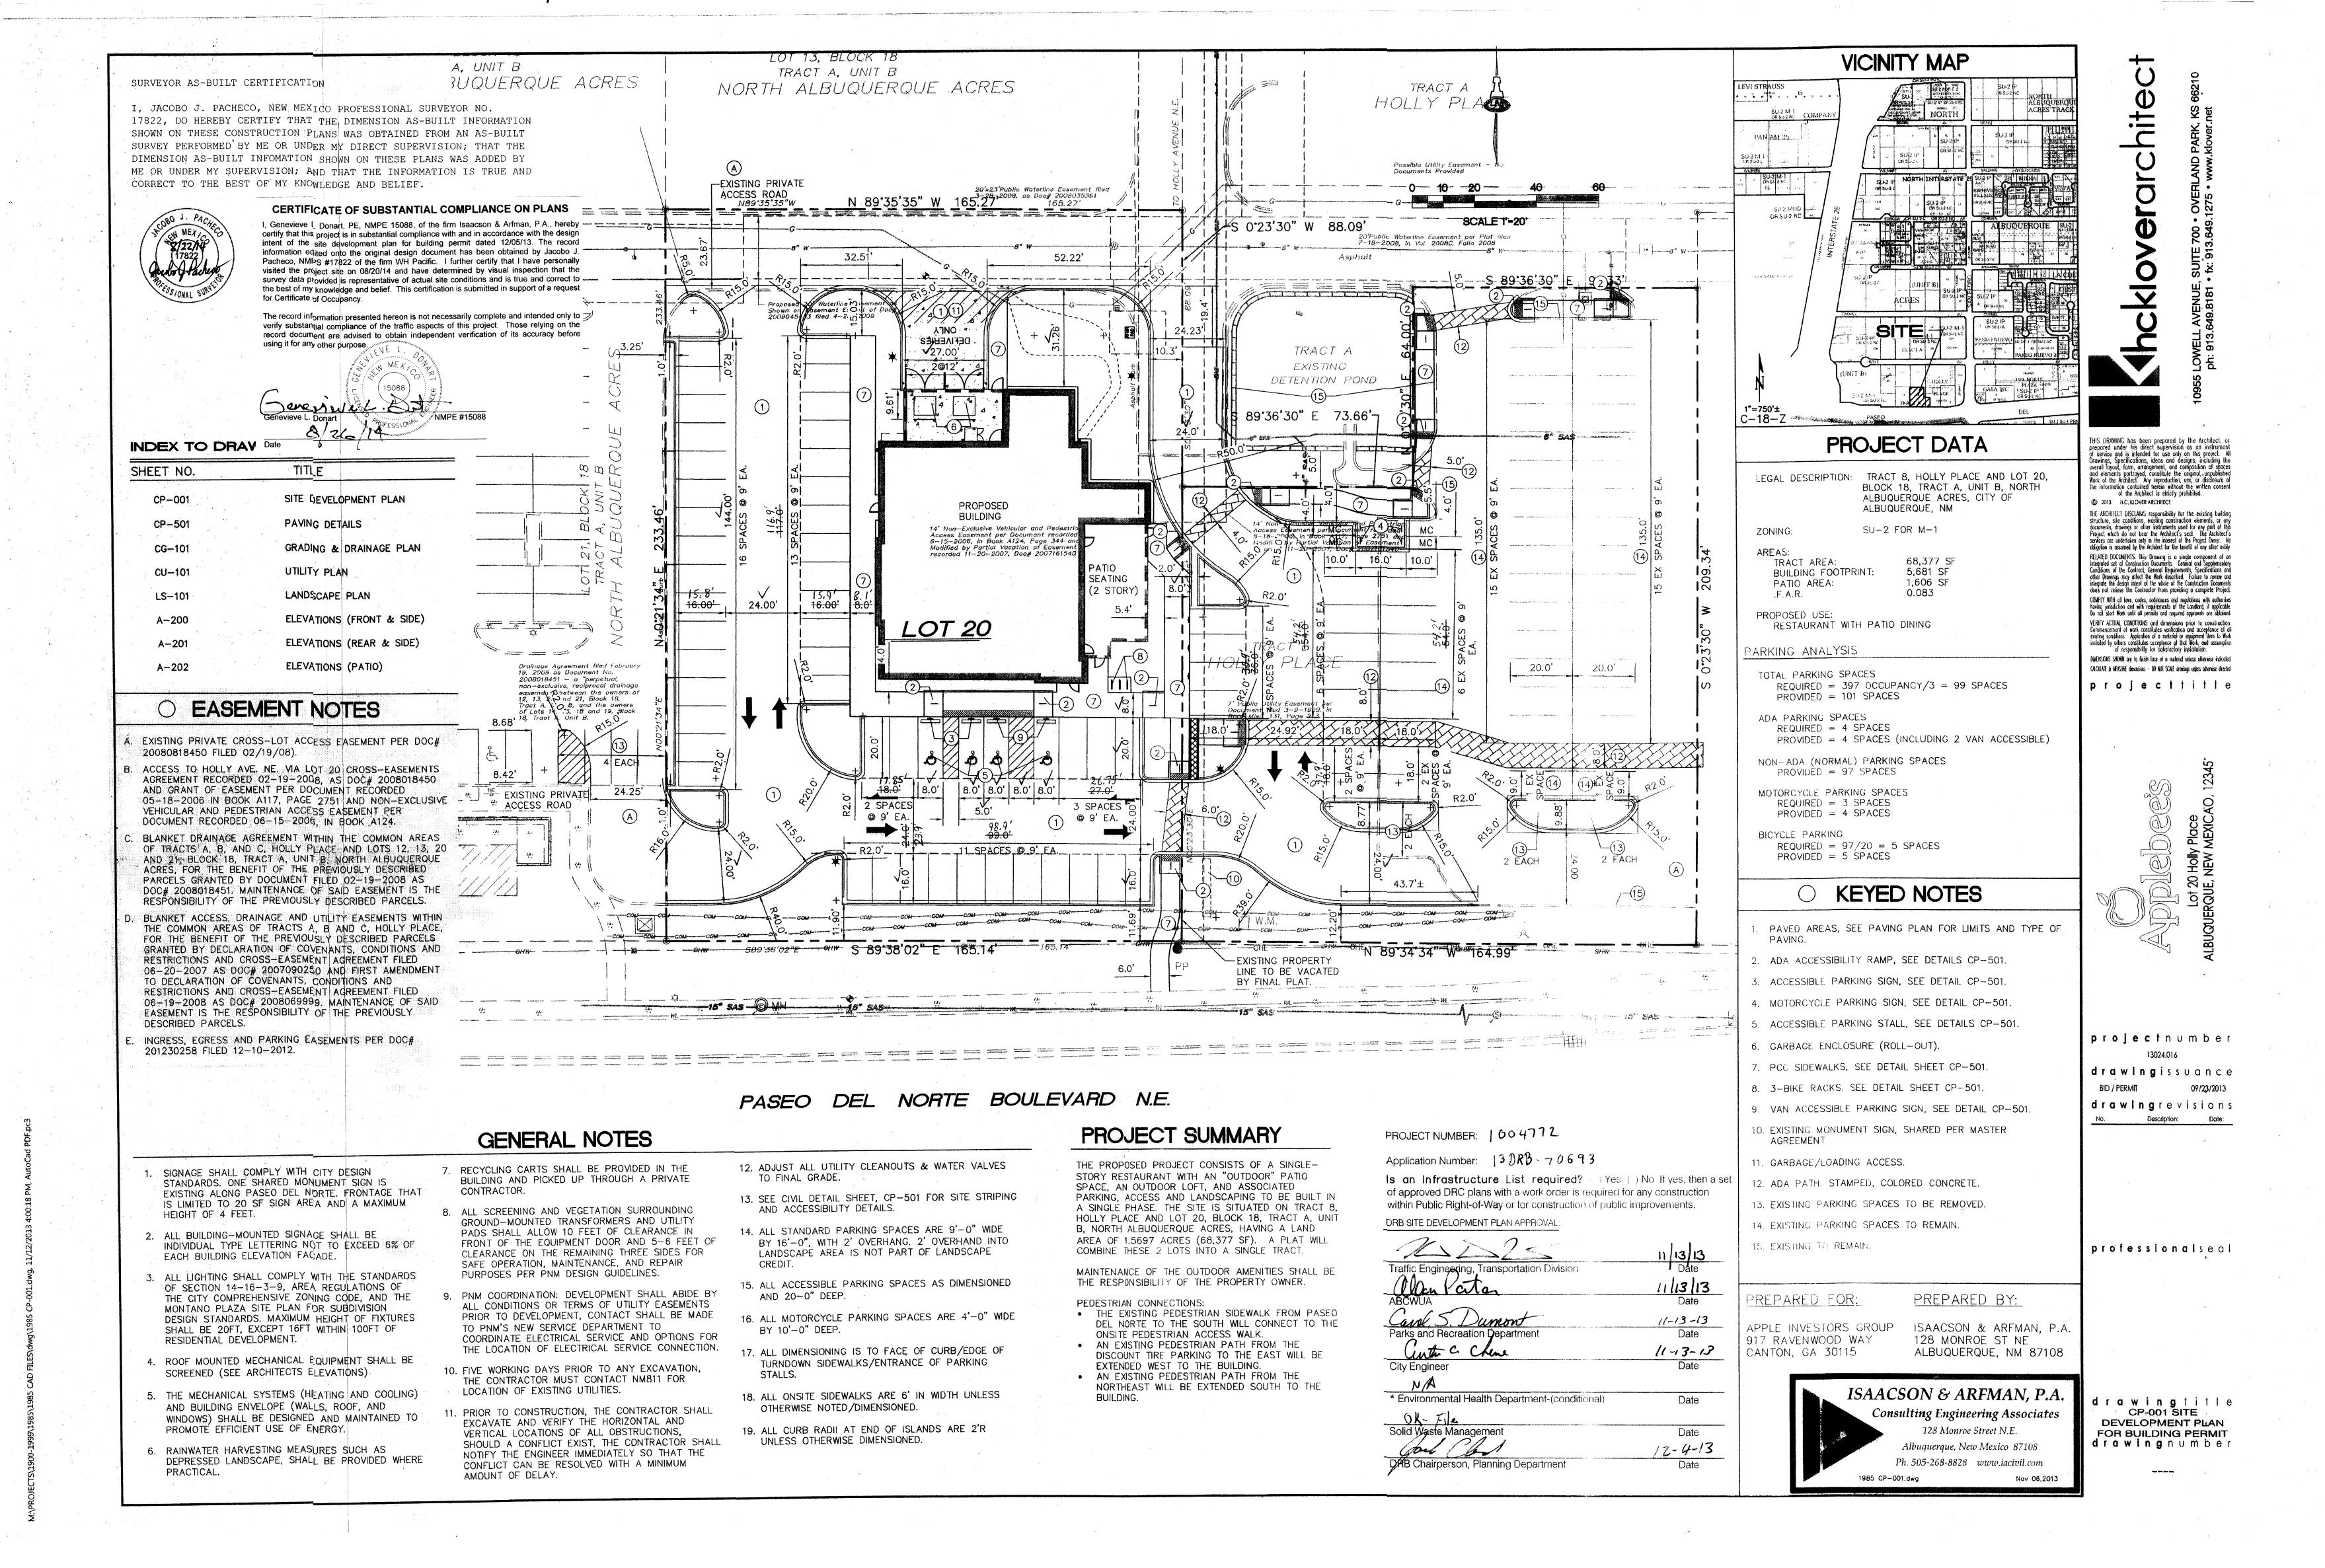

NORTE BOULEVARD N.E.

PROJECT INFORMATION

LEGAL DESCRIPTION: LOT 20, BLOCK 18, TRACT A, UNIT B, NORTH ALBUQUERQUE ACRES, TOGETHER WITH PORTIONS OF TRACT B, HOLLY PLACE.

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BASIN 4 DISCHARGES THE SITE NORTH TO THE EXISTING ACCESS ROAD. A 535 CF RETENTION POND IN THE LANDSCAPING AREA WILL CAPTURE STORM WATER FROM A PORTION OF THE ROOF AND LANDSCAPING. SMALL WATER HARVESTING PONDS CAPTURE AN ADDITIONAL 59 CF.

THE 2 PRIMARY NEW PONDS REDUCE THE TOTAL DISCHARGE BY 0.6 CFS BETWEEN THEM. BY ADDING THE WATER HARVESTING PONDS, THE TOTAL NEW PONDING REDUCTION IS 0.8 CFS.

BASIN 5 IS AN EXISITNG PARKING AREA THAT IS BEING INCORPORATED INTO THE APPLEBEE'S PROPERTY. THE BASIN FLOWS TO THE EXISTING RETENTION POND ON THE NORTHEAST CORNER OF THE BASIN.

SEE CALCULATIONS SEPARATELY.

CONCRETE WALK WITH TURN-DOWN EDGE. SEE DETAIL ON

2. ADA ACCESSIBLE RAMP. SEE DETAIL ON CP-501.

3. SIDEWALK FLUSH WITH PAVING. . ADA ACCESSIBLE PARKING AREA WITH 2% MAXIMUM SLOPE IN

ANY DIRECTION. SEE DETAIL ON CP-501. FRACTURED FACE ROCK SWALE. SEE GENERAL NOTE 'L'. SEE DETAIL ON CG-501.

2' WIDE CONCRETE RUNDOWN, SEE DETAIL ON CG-501. . ROOF DRAIN LOCATION. SEE ARCHITECTURAL PLANS.

8. EXTEND 4" ROOF DRAIN THROUGH FACE OF WALK. SEE DETAIL ON CG-501.

). TIE NEW PAVING TO EXISTING PAVING. PROVIDE SMOOTH TRANSITION. 10. EXTENDED DEPTH HEADER CURB WITH GUTTER TO ACHIEVE

GRADE DIFFERENCE SHOWN. SEE DETAIL ON CG-501. 1. EXISTING SIGN. CONTRACTOR TO PROTECT DURING CONSTRUCTION. 12. 8" DEEP POND WITH FRACTURED FACE ROCK SIDE SLOPES AT 4:1. MUST BE AT LEAST 10' AWAY FROM BUILDING FOOTPRINT.

SEE GENERAL NOTE 'L'. 13. 2' WIDE CURB OPENING. SEE DETAIL ON CG-501. 14. CONSTRUCT 8" WIDE CONCRETE MOW CURB ADJACENT TO BUILDING THIS AREA TO ACHIEVE GRADES SHOWN. SEE DETAIL ON CG-501.

Inv. Elev. = 5211.25(W)Inv. Elev. = 5211.35(E)

KEYED NOTES

15. DEPRESS ALL LANDSCAPING MIN. 6" TO PROVIDE WATER HARVESTING EXCEPT FOR ALL AREAS WITHIN 10' OF BLDG.

16. TRENCH DRAIN THROUGH SIDEWALK. SEE DETAIL ON CG-501. CUT GRATE AS NEEDED TO ALLOW ROOF DRAIN FLOWS TO ENTER TRENCH DRAIN.

17. TRENCH DRAIN TO CAPTURE ROOF DRAIN FLOWS, AND DIRECT THEM TO THE WESTERN PARKING AREA. SEE DETAIL ON CG-501. CUT GRATE AS NEEDED TO ALLOW ROOF DRAIN FLOWS TO ENTER TRENCH DRAIN.

18. 1' WIDE CONCRETE RUNDOWN. SEE DETAIL ON CG-501

19. 4" DIA DRAIN LINE THROUGH CURB PER COA STD DWG #2235. PLACE ROCK SWALE IN LANSCAPE AREA DOWNSTREAM OF PIPE.

20. RESTRICT FLOW FROM EXISTING POND OUTLET BY INSERTING A PLUG INTO THE EXISTING 6" OUTLET STORM DRAIN. CUT A 3" DIA HOLE CUT INTO THE PLUG. SEE POND OUTLET REDUCTION DETAIL ON CG-501.

21. 2' WIDE SIDEWALK CULVERT PER COA STD DWG #2235.

EXISTING CONTOUR *TC=15.5±*×

PROPOSED SPOT ELEVATION

FLOW ARROW

FINISH FLOOR ELEVATION



CONSTRUCTION, CONTRACTOR IS FULLY RESPONSIBLE FOR ANY AND ALL DAMAGE CAUSED BY ITS FAILURE TO LOCATE, IDENTIFY AND PRESERVE ANY AND ALL EXISTING UTILITIES, PIPELINES, AND

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overall layout, form, arrangement, and composition of spaces and elements portrayed, constitute the original, unpublished

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services are undertaken only in the interest of the Project Owner. No

bligation is assumed by the Architect for the benefit of any other entity.

RELATED DOCUMENTS: This Drawing is a single component of an

integrated set of Construction Documents. General and Supplementary

Conditions of the Contract. General Requirements, Specifications and other Drawings may affect the Work described. Failure to review and

integrate the design intent of the whole of the Construction Documents does not relieve the Contractor from providing a complete Project.

COMPLY WITH all laws, codes, ordinances and regulations with authorities

having jurisdiction and with requirements of the Landlord, if applicable Do not start Work until all permits and required approvals are obtained

VERIFY ACTUAL CONDITIONS and dimensions prior to construction

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projectitle

OWNER WILL PROVIDE SOIL TESTING AND INSPECTION SERVICES DURING EARTHWORK OPERATIONS CONTRACTOR SHALL ALLOW TESTING LABS TO INSPECT AND APPROVE COMPACTED SUBGRADES AND FILL LAYERS BFFORE FURTHER CONSTRUCTION WORK IS DONE. SHOULD COMPACTION TESTS INDICATE INADEQUATE DENSITY, CONTRACTOR SHALL PROVIDE ADDITIONAL COMPACTION AND TESTING AT THE CONTRACTOR'S SOLE

GENERAL NOTES

VICINITY MAP

OWNER HAS ESTABLISHED PROPERTY BOUNDARY CORNERS. CONTRACTOR SHALL PROVIDE ALL OTHER CONSTRUCTION STAKING. CONTRACTOR SHALL LOCATE AND PRESERVE ALL BOUNDARY CORNERS AND REPLACE ANY LOST OR DISTURBED CORNERS AT CONTRACTOR'S SOLE EXPENSE.

THE ENVIRONMENTAL PROTECTION AGENCY (EPA) AND THE CITY OF ALBUQUERQUE REQUIRE A STORM WATER POLLUTION PREVENTION PLAN (SWPPP), AN NDPES PERMIT, AND AN EROSION AND SEDIMENT CONTROL (ESC) PERMIT FOR PROJECTS WHERE CONSTRUCTION ACTIVITIES MEET THE EPA THRESHOLD. (SWPPP, NPDES PERMIT, AND ESC PLAN BY OTHERS.) A CITY-APPROVED ESC PERMIT MUST BE INCLUDED WITH THE CONTRACTOR'S SUBMITTAL FOR A ROUGH GRADING, GRADING, PAVING, BUILDING, OR WORK ORDER PERMIT.

ADJUST RIMS OF EXISTING UTILITY FEATURES AS NECESSARY TO MATCH NEW GRADES, TYPICAL.

ALL NEW PAVEMENT SURFACES SHALL BE CONSTRUCTED WITH POSITIVE SLOPE AWAY FROM BUILDINGS AND POSITIVE SLOPE TOWARD EXISTING AND/OR PROPOSED DRAINAGE PATHS. WHERE NEW GRADES ARE SHOWN AS 'MATCH' OR '±', TRANSITIONS BETWEEN NEW AND EXISTING SHALL BE SMOOTH AND LEVEL.

ALL FRACTURED FACE ROCK (F.F. ROCK) TO BE 6" AVG. DIA. ANGULAR FACED ROCK PLACED OVER GEOTEX 501 NON-WOVEN GEOTEXTILE (O.E.).

ENGINEER RECOMMENDS THAT OWNER MAINTAIN EROSION PROTECTION FLEMENTS. ENGINEER RECOMMENDS THAT OWNER INSPECT SITE YEARLY AND AFTER EACH RAINFALL TO IDENTIFY NEW AREAS OF EROSION AND INSTALL ADDITIONAL EROSION PROTECTION AS NEEDED BASED ON ACTUAL OCCURRENCES.

LEGEND

AUG 27 2014 EXISTING SPOT ELEVATION LAND DEVELOPMENT SECT. PROPOSED CONTOUR



professional seal

project number

13024.016

drawing issuance

drawing revisions

Description: Date:



drawing title **GRADING &** DRAINAGE PLAN drawing number

CG-101

PASEO DEL NORTE BOULEVARD N.E.

LEGAL DESCRIPTION: LOT 20, BLOCK 18, TRACT A, UNIT B, NORTH ALBUQUERQUE ACRES, TOGETHER WITH ACRES, TOGETHER WITH PORTIONS OF TRACT B, HOLLY PLACE.

1.16 ACRES

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8. EXTEND 4" ROOF DRAIN THROUGH FACE OF WALK. SEE DETAIL

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LEGEND

EXISTING CONTOUR

EXISTING SPOT ELEVATION

VICINITY MAP

SITE

GENERAL NOTES

ACRES TRA

PROPOSED CONTOUR

PROPOSED SPOT ELEVATION FLOW ARROW

FF = 5220.7 FINISH FLOOR ELEVATION



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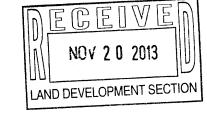
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project title

project number

13024.016 drawing issuance

drawing revisions Description: Date:





drawing title **GRADING &** DRAINAGE PLAN drawing number

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PROJECT TO 4.629 CFS/AC (BASINS 1-4 CAN DISCHARGE 4.7

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BASINS 1, 2, & 3, WHICH INCLUDE SUB-BASINS 1a, 2a, & 3a, ARE DIRECTED TO THE PARKING LOT ON THE EAST SIDE OF THE PROPERTY, WHERE 461 CF OF STORM WATER PONDS UNTIL IT DISCHARGES THROUGH 2-1' WIDE CONCRETE RUNDOWNS AND

HARVESTING PONDS CAPTURE AN ADDITIONAL 316 CF.

THE 2 PRIMARY NEW PONDS REDUCE THE TOTAL DISCHARGE BY

14. CONSTRUCT 8" WIDE CONCRETE MOW CURB ADJACENT TO

ON CG-501. 15. DEPRESS ALL LANDSCAPING MIN. 6" TO PROVIDE WATER

CUT GRATE AS NEEDED TO ALLOW ROOF DRAIN FLOWS TO ENTER TRENCH DRAIN. 17. TRENCH DRAIN TO CAPTURE ROOF DRAIN FLOWS, AND DIRECT

FLOWS TO ENTER TRENCH DRAIN.

18. 1' WIDE CONCRETE RUNDOWN. SEE DETAIL ON CG-501

mos.livisni.www 8288-882-202 .Aq Albuquerque, New Mexico 87108 128 Monroe Street N.E. Consulting Engineering Associates ISAACSON & ARFMAN, P.A.

SCALE: N.T.S.

PIPE THROUGH WALK

SCALE: N.T.S.

BEDDING

SCALE: N.T.S.

SHOWN ON PLANS

 \neg TG (TOP OF GRATE)

ELEVATION AS

TRENCH DRAIN DETAIL

SHOWN ON PLANS L INVERT ELEVATIONS AS

4" 6.1" CONCRETE

NOTE: TRENCH DRAIN SYSTEM BY ACO POLYMER PRODUCTS, OR APPROVED EQUAL.

/ XXXX

B DEPTH BELOW GRADE A

3. FULL FORM ON ALL FACES

CURB HEIGHT ABOVE (TC-BC)

 $\leq 1/2$ " EXPANSION JOINT

EXTENDED HEADER CURB

5. EDGES SHOULD BE REMOVED WITH 3/8" EDGING TOOL

1. PROVIDE CONST. CONTROL JOINTS @ 6' O.C. MAX. AND

_SEALANT

(DIMENSION REF. PT.)

SCALE: N.T.S.

-- FACE OF CURB

WATERPROOF

1/5" EXPANSION JOINTS @ 48' O.C. MAX

. 7 A . .

M\ FOCKING DEAICES

DRAIN W/ BUILT—IN

O.6% FLOOR SLOPE

CALVANIZED STEEL

GRATES (1/4" HOLES)


W/ LOOKING PERVICES

PRE-CAST TRENCH -

4" SIDEWALK ... 4". S, WIN JOINT CONSTRUCTION-

SCALE: N.T.S. S BOCK SMALE


BENEATH ALL EROSION PROTECTION • PLACE GEOTEX 501 NON-WOVEN GEOTEXTILE (O.E.) DIA. (AVG.=6")• VARY ANGULAR FACE ROCK SIZE BETWEEN 4" AND 8"

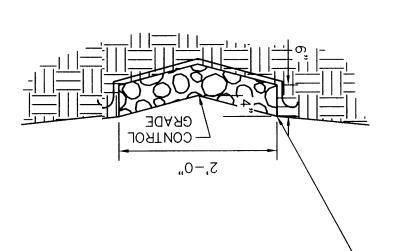


PROPERLY ENSURE RUNOFF CAN BE CAPTURED AND CONVEYED CONSTRUCT ALL SWALES BELOW ADJACENT GRADE TO

 SLOPE TOP AT 2% AWAY FROM BLDG. • 1/2" EXPANSION JOINTS AT CORNERS CONSTRUCTION CONTROL JOINTS AT 6' O.C. MAX.

CONCRETE MOW CURB

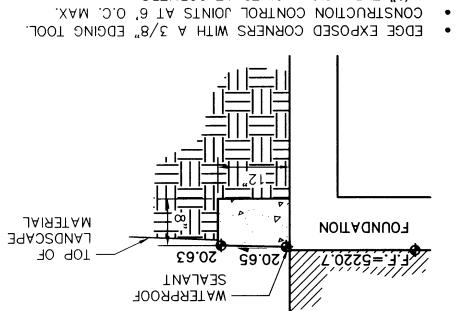

CURB OPENING

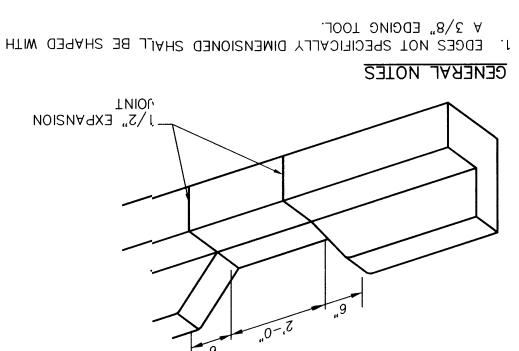

乙 0

SCALE: N.T.S.

drawingnumber GRADING DETAILS arawingtitle 📕

professionalseal

CG-501


& CALCUATIONS

drawingrevisions 5102.15.20 BID / PERMIT **drawing**issuance 13024.016 **b r o j e c t** n n m b e r

projecttite CALCULATE & WEASURE dimensions - 00 NOT SCALE drowings unless obhemise directed. DIMENSIONS SHOWN are to finish face of a material unless otherwise indicated. Commencement of work constitutes verification and acceptance of all existing conditions. Application of a material or equipment item to Work installed by others constitutes acceptance of that Work, and assumption of responsibility for satisfactory installation. VERIFY ACTUAL CONDITIONS and dimensions prior to construction. COMPLY WITH all lows, codes, ordinances and regulations with authorities having jurisdiction and with requirements of the Landlord, if applicable. Do not start Work until all permits and required approvals are obtained. REATED DOCUMENTS: This Drawing is a single component of an integrated set of Construction Documents. General and Supplementing Conditions of the Contract, General Requirements, Specifications and other Drawings may affect the Work described. Follure to review and integrate the Construction Documents integrate the Contractor from providing a complete Project. documents, drowings or other instruments used for any port of this Project which do not bear the Architect's seal. The Architect's seal. The Architect's sear, care undertaken only in the interest of the Project Owner. No obligation is assumed by the Architect for the benefit of any other entity. THE ARCHITECT DISCLAIMS responsibility for the existing building structure, site conditions, existing construction elements, or any actual structures are conditions, existing construction elements, or any © 2013 H.C. KLOVER ARCHITECT

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□

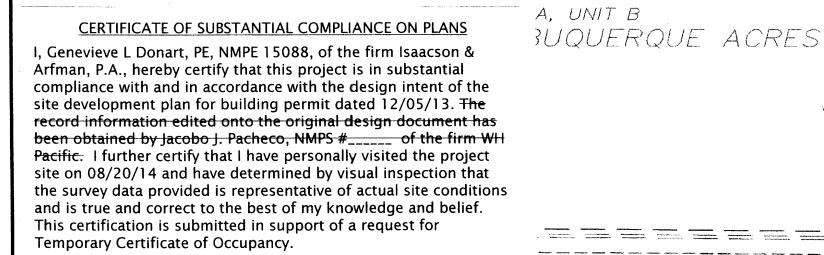

The record information presented hereon is not necessarily complete and intended only to verify substantial compliance of the traffic aspects of this project. Those relying on the record document are advised to obtain independent verification of its accuracy before using it for any other purpose

INDEX TO DRAWINGS

SHEET NO.	TITLE
CP-001	SITE DEVELOPMENT PLAN
CP-501	PAVING DETAILS
CG-101	GRADING & DRAINAGE PLAN
CU-101	UTILITY PLAN
LS-101	LANDSCAPE PLAN
A-200	ELEVATIONS (FRONT & SIDE)
A-201	ELEVATIONS (REAR & SIDE)
A-202	ELEVATIONS (PATIO)

EASEMENT NOTES

- EXISTING PRIVATE CROSS-LOT ACCESS EASEMENT PER DOC# 20080818450 FILED 02/19/08).
- ACCESS TO HOLLY AVE. NE. VIA LOT 20 CROSS-EASEMENTS AGREEMENT RECORDED 02-19-2008. AS DOC# 2008018450 AND GRANT OF EASEMENT PER DOCUMENT RECORDED 05-18-2006 IN BOOK A117, PAGE 2751 AND NON-EXCLUSIVE VEHICULAR AND PEDESTRIAN ACCESS EASEMENT PER DOCUMENT RECORDED 06-15-2006, IN BOOK A124.
- BLANKET DRAINAGE AGREEMENT WITHIN THE COMMON AREAS OF TRACTS A, B, AND C, HOLLY PLACE AND LOTS 12, 13, 20 AND 21, BLOCK 18, TRACT A, UNIT B, NORTH ALBUQUERQUE ACRES, FOR THE BENEFIT OF THE PREVIOUSLY DESCRIBED PARCELS GRANTED BY DOCUMENT FILED 02-19-2008 AS DOC# 2008018451. MAINTENANCE OF SAID EASEMENT IS THE RESPONSIBILITY OF THE PREVIOUSLY DESCRIBED PARCELS.
- BLANKET ACCESS, DRAINAGE AND UTILITY EASEMENTS WITHIN THE COMMON AREAS OF TRACTS A, B AND C, HOLLY PLACE, FOR THE BENEFIT OF THE PREVIOUSLY DESCRIBED PARCELS GRANTED BY DECLARATION OF COVENANTS, CONDITIONS AND RESTRICTIONS AND CROSS-EASEMENT AGREEMENT FILED 06-20-2007 AS DOC# 2007090250 AND FIRST AMENDMENT TO DECLARATION OF COVENANTS, CONDITIONS AND RESTRICTIONS AND CROSS-EASEMENT AGREEMENT FILED 06-19-2008 AS DOC# 2008069999. MAINTENANCE OF SAID EASEMENT IS THE RESPONSIBILITY OF THE PREVIOUSLY DESCRIBED PARCELS.
- INGRESS, EGRESS AND PARKING EASEMENTS PER DOC# 201230258 FILED 12-10-2012.

569 38'02"E 9"" \$ 89'38'02" E 165.14 Commence of the second THE RELATION OF THE PROPERTY O PASEO DEL NORTE BOULEVARD N.E.

LOT 13, BLOCK 18

-EXISTING PRIVATE

ACCESS ROAD

TRACT A, UNIT B

NORTH ALBUQUERQUE ACRES

32.51

YJNO . DEFINEBIES

27.00

PROPOSED

14' Non-Exclusive Vehlcular and Ped

6-15-2006, in Book A124, Page 344 Modified by Partial Vacation of Easen

recorded 11-20-2007, Doc# 2007

8.0' 8.0' 8.0' 8.0' 8.0'

,11_SPACES_@_9'_EA.

BUILDING

LOT 20

20'x23'Public Waterline Easement filed 3–28–2008, as Doc# 2008035361 165.27'

52.22'

SEATING

27.0

3 SPACES &

@ 9'EA.

(2 STORY)

GENERAL NOTES

Sanitory Sewer Line Easemen orded 4—28—2009, as

3.25

16.00

24.00'

16.00'

- SIGNAGE SHALL COMPLY WITH CITY DESIGN STANDARDS, ONE SHARED MONUMENT SIGN IS EXISTING ALONG PASEO DEL NORTE. FRONTAGE THAT IS LIMITED TO 20 SF SIGN AREA AND A MAXIMUM HEIGHT OF 4 FEET.
- 2. ALL BUILDING-MOUNTER S NAGE SHALL BE INDIVIDUAL TYPE LETTERIN NOT TO EXCEED 6% OF EACH BUILDING ELEVATION FACADE.
- 3. ALL LIGHTING SHALL COMPLY WITH THE STANDARDS OF SECTION 14-16-3-9, AREA REGULATIONS OF THE CITY COMPREHENSIVE ZONING CODE, AND THE MONTANO PLAZA SITE PLAN FOR SUBDIVISION DESIGN STANDARDS. MAXIMUM HEIGHT OF FIXTURES SHALL BE 20FT, EXCEPT 16FT WITHIN 100FT OF RESIDENTIAL DEVELOPMENT.
- 4. ROOF MOUNTED MECHANICAL EQUIPMENT SHALL BE SCREENED (SEE ARCHITECTS ELEVATIONS)
- 5. THE MECHANICAL SYSTEMS (HEATING AND COOLING) AND BUILDING ENVELOPE (WALLS, ROOF, AND WINDOWS) SHALL BE DESIGNED AND MAINTAINED TO PROMOTÉ EFFICIENT USE OF ENERGY.
- 6. RAINWATER HARVESTING MEASURES SUCH AS DEPRESSED LANDSCAPE, SHALL BE PROVIDED WHERE PRACTICAL.

7. RECYCLING CARTS SHALL BE PROVIDED IN THE BUILDING AND PICKED UP THROUGH A PRIVATE CONTRACTOR.

2008018451 — a "pernetual

EXISTING PRIVATE 2

ACCESS ROAD

8.42'

The second secon

4 EACH

24.25'

- 8. ALL SCREENING AND VEGETATION SURROUNDING GROUND-MOUNTED TRANSFORMERS AND UTILITY PADS SHALL ALLOW 10 FEET OF CLEARANCE IN FRONT OF THE EQUIPMENT DOOR AND 5-6 FEET OF CLEARANCE ON THE REMAINING THREE SIDES FOR SAFE OPERATION, MAINTENANCE, AND REPAIR PURPOSES PER PNM DESIGN GUIDELINES.
- 9. PNM COORDINATION: DEVELOPMENT SHALL ABIDE BY ALL CONDITIONS OR TERMS OF UTILITY EASEMENTS PRIOR TO DEVELOPMENT, CONTACT SHALL BE MADE TO PNM'S NEW SERVICE DEPARTMENT TO COORDINATE ELECTRICAL SERVICE AND OPTIONS FOR THE LOCATION OF ELECTRICAL SERVICE CONNECTION.
- 10. FIVE WORKING DAYS PRIOR TO ANY EXCAVATION, THE CONTRACTOR MUST CONTACT NM811 FOR LOCATION OF EXISTING UTILITIES.
- 11. PRIOR TO CONSTRUCTION, THE CONTRACTOR SHALL EXCAVATE AND VERIFY THE HORIZONTAL AND VERTICAL LOCATIONS OF ALL OBSTRUCTIONS, SHOULD A CONFLICT EXIST, THE CONTRACTOR SHALL NOTIFY THE ENGINEER IMMEDIATELY SO THAT THE CONFLICT CAN BE RESOLVED WITH A MINIMUM AMOUNT OF DELAY.

12. ADJUST ALL UTILITY CLEANOUTS & WATER VALVES TO FINAL GRADE.

13. SEE CIVIL DETAIL SHEET, CP-501 FOR SITE STRIPING

2 SPACES

- AND ACCESSIBILITY DETAILS. 14. ALL STANDARD PARKING SPACES ARE 9'-0" WIDE
- BY 16'-0", WITH 2' OVERHANG, 2' OVERHAND INTO LANDSCAPE AREA IS NOT PART OF LANDSCAPE
- 15. ALL ACCESSIBLE PARKING SPACES AS DIMENSIONED AND 20-0" DEEP.
- 16. ALL MOTORCYCLE PARKING SPACES ARE 4'-0" WIDE BY 10'-0" DEEP.
- 17. ALL DIMENSIONING IS TO FACE OF CURB/EDGE OF TURNDOWN SIDEWALKS/ENTRANCE OF PARKING
- 19. ALL CURB RADII AT END OF ISLANDS ARE 2'R UNLESS OTHERWISE DIMENSIONED.

18. ALL ONSITE SIDEWALKS ARE 6' IN WIDTH UNLESS

OTHERWISE NOTED/DIMENSIONED.

PROJECT SUMMARY

THE PROPOSED PROJECT CONSISTS OF A SINGLE-STORY RESTAURANT WITH AN "OUTDOOR" PATIO SPACE, AN OUTDOOR LOFT, AND ASSOCIATED PARKING, ACCESS AND LANDSCAPING TO BE BUILT IN A SINGLE PHASE. THE SITE IS SITUATED ON TRACT 8, HOLLY PLACE AND LOT 20, BLOCK 18, TRACT A, UNIT B, NORTH ALBUQUERQUE ACRES, HAVING A LAND AREA OF 1.5697 ACRES (68,377 SF). A PLAT WILL COMBINE THESE 2 LOTS INTO A SINGLE TRACT.

-EXISTING PROPERTY

BY FINAL PLAT.

LINE TO BE VACATED

MAINTENANCE OF THE OUTDOOR AMENITIES SHALL BE THE RESPONSIBILITY OF THE PROPERTY OWNER.

- PEDESTRIAN CONNECTIONS: THE EXISTING PEDESTRIAN SIDEWALK FROM PASEO DEL NORTE TO THE SOUTH WILL CONNECT TO THE ONSITE PEDESTRIAN ACCESS WALK.
- DISCOUNT TIRE PARKING TO THE EAST WILL BE EXTENDED WEST TO THE BUILDING. AN EXISTING PEDESTRIAN PATH FROM THE NORTHEAST WILL BE EXTENDED SOUTH TO THE BUILDING.

AN EXISTING PEDESTRIAN PATH FROM THE

PROJECT NUMBER: 1004772

Solid Waste Management

B Chairperson, Planning Department

43.7°±

N 89'34'34" W""164.99'

TRACT A

EXISTING DETENTION PONU

89'36'30" E 73.66'

Application Number: 3 DRB 7 0 6 9 4 Is an Infrastructure List required to the to No It yes, then a set of approved DRC plans with a work order is a correct for any construction. within Public Right-of-Way or for construction appublic improvements. DRB SITE DEVELOPMENT PLAN APPROVAL:

EACH

(A)

-4-13

- All Land	11/13/13
Traffic Engineering, Transportation Division	Date
Allan Cata	11/13/13
ABCWUA	Date
Carol S. Dumont	11-13-13
Parks and Recreation Department	Date
Center c Chene	11-13-13
City Engineer	Date
NA	
* Environmental Health Department-(conditional)	Date
OK- File	

1"=750'± C-18-2 PROJECT DATA

VICINITY MAP

LEGAL DESCRIPTION: TRACT 8, HGLLY PLACE AND LOT 20 BLOCK 18, TRACT A, UNIT B, NORTH ALBUQUERQUE ACRES, CITY OF ALBUQUERQUE, NM

SU-2 FOR M-1 ZONING

68,377 SF TRACT AREA: BUILDING FOOTPRINT: 5,681 SF 1,606 SF PATIO AREA: 0.083 .F.A.R.

PROPOSED USE: RESTAURANT WITH PATIO DINING

Parking analysis

TOTAL PARKING SPACES REQUIRED = 397 OCCUPANCY/3 = 99 SPACESPROVIDED = 101 SPACES

ADA PARKING SPACES PROVIDED = 4 SPACES (INCLUDING 2 VAN ACCESSIBLE)

NON-ADA (NORMAL) PARKING SPACES PROVIDED = 97 SPACES

MOTORCYCLE PARKING SPACES REQUIRED = 3 SPACESPROVIDED = 4 SPACES

BICYCLE PARKING REQUIRED = 97/20 = 5 SPACES PROVIDED = 5 SPACES

KEYED NOTES

- PAVED AREAS, SEE PAVING PLAN FOR LIMITS AND TYPE OF
- ADA ACCESSIBILITY RAMP, SEE DETAILS CP-501.
- 3. ACCESSIBLE PARKING SIGN, SEE DETAIL CP-501.
- 4. MOTORCYCLE PARKING SIGN, SEE DETAIL CP-501. 5. ACCESSIBLE PARKING STALL, SEE DETAILS CP-501.
- 6. GARBAGE ENCLOSURE (ROLL-OUT).
- 7. PCC SIDEWALKS, SEE DETAIL SHEET CP-501.
- 8. 3-BIKE RACKS. SEE DETAIL SHEET CP-501.
- 9. VAN ACCESSIBLE PARKING SIGN, SEE DETAIL CP-501. 10. EXISTING MONUMENT SIGN, SHARED PER MASTER AGREEMENT.
- 11. GARBAGE/LOADING ACCESS.
- 2. ADA PATH. STAMPED, COLORED CONCRETE.
- D. EXISTING PARKING SPACES TO BE REMOVED.
- 14. EXISTING PARKING SPACES TO REMAIN.
- 15. EXISTING TO REMAIN.

<u> Prepared For:</u>

917 RAVENWOOD WAY

APPLE INVESTORS GROUP ISAACSON & ARFMAN, P.A. 128 MONROE ST NE CANTON, GA 30115 ALBUQUERQUE, NM 87108

> ISAACSON & ARFMAN, P.A. Consulting Engineering Associates 128 Monroe Street N.E. Albuquerque, New Mexico 87108 Ph. 505-268-8828 www.iacivil.com

PREPARED BY:

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DXMENSIONS SHOWN are to finish tace of a material unless otherwise indicate CALCULATE & MEASURE dimensions - DO NOT SCALE drawings unless otherwise direct

projec<u>tti</u>tle AUG 2 2 2014 LAND DEVELOPMENT SECTION (N)

project numbe:

13024.016 drawing issuance BID / PERMIT 09/23/2013 drawing revisions

Description: Date:

professional seal

drawing title CP-001 SITE DEVELOPMENT PLAN FOR BUILDING PERMIT

drawing number ---