
WB Alameda and San Pedro

6100 Alameda NE Boulevard, Albuquerque, NM 87113

TEMPORARY EROSION AND SEDIMENT CONTROL PLAN

PAGE INDEX		
1	TITLE PAGE	
2	SWPPP INFO & NOTES	
3	DETAILS	
TEMPORARY EROSION		
	CONTROL PLAN	
	SCHEDULE & SWPPP TEAM	

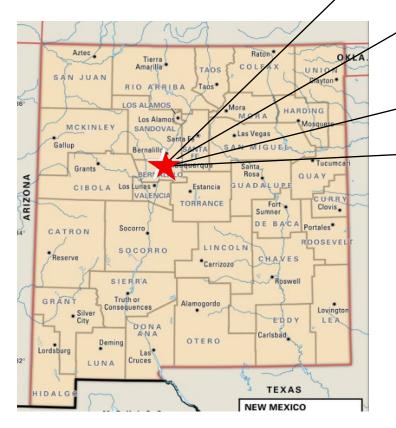


Page 1 of 8



GPS COORDINATES:

35.184184 -106.577120

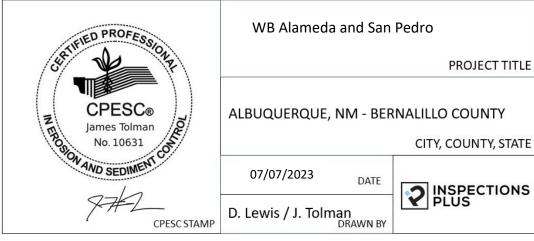

PERMIT NUMBER: NMR

NMR100000 STATE OF NEW MEXICO, EXCEPT INDIAN COUNTRY NMR101000 INDIAN COUNTRY WITHIN THE STATE OF NEW MEXICO, EXCEPT NAVAJO RESERVATION LANDS THAT ARE COVERED UNDER ARIZONA PERMIT AZR101000 AND UTE MOUNTAIN RESERVATION LANDS THAT ARE COVERED UNDER COLORADO PERMIT COR101000.

OPERATOR NAME: Green Jean West LLC		
OPERATOR POINT OF CONTACT Roy Solomon 505-401-1000) roy@roysolomon.org	
NOI PREPARED BY: Inspections Plus		
PROJECT/SITE NAME: WB Alameda and San Pedro		
PROJECT/SITE ADDRESS: 6100 Alameda NE Boulevard, A	lbuquerque, NM 87113	
LATITUDE	35.184184	
LONGITUDE	-106.577120	
ESTIMATED PROJECT START DATE	07/17/2023	
ESTIMATED PROJECT COMPLETION DATE	01/31/2024	
ESTIMATED AREA TO BE DISTURBED	.08 acres LOD	
TYPE OF CONSTRUCTION	Commercial	
DEMOLITION OF ANY STRUCTURES, 10,000 SQ FT OF GREATER BUILT OR RENOVATED BEFORE JANUARY 1, 1980?	No	
WAS THE PREDEVELOPMENT LAND USED FOR AGRICULTURE?	No	
COMMENCED EARTH DISTURBING ACTIVITIES?	No	
DISCHARGE TO MS4? MS4 NAME?	Bernalillo County	
SURFACE WATERS WITHIN 50FT?	No	
RECEIVING WATER?	Rio Grande River	
IS RECEIVING WATER IMPAIRED? TIER DESIGNATION	Yes	
WHAT ARE THE IMPAIRMENTS, IF ANY? Dissolved Oxygen, E. Coli, Merc	ury - Fish Consumption Advisory, Temperat	
SWPPP CONTACT INFORMATION: Roy Solomon 505-401-1000 roy@roysolomon.org		
ENDANGERED SPECIES CRITERIA: CRITERION "A"; NO CRITICAL HABITATS CRITERION "A"		


PREEXISTING DEVELOPMENT

Page 2 of 8

HISTORIC PRESERVATION CRITERIA:

EROSION CONTOL NOTES ESC Plan Standard Notes (2022-08-23)

- 1. All Erosion and Sediment Control (ESC) work on these plans, except as otherwise stated or provided hereon shall be permitted, constructed, inspected, and maintained in accordance with:
- a. The City Ordinance § 14-5-2-11, the ESC Ordinance,
- b. The EPA's 2017 Construction General Permit (CGP), and
- c. The City of Albuquerque Construction BMP Manual.
- 2. All BMP's must be installed prior to beginning any earth moving activities except as specified hereon in the Phasing Plan. Construction of earthen BMP's such as sediment traps, sediment basins, and diversion berms shall be completed and inspected prior to any other construction or earthwork. Self-inspection is required after installation of the BMPs and prior to beginning construction.
- 3. Self-inspections At a minimum a routine compliance self-inspection is required to review the project for compliance with the Construction General Permit once every 14 days and after any precipitation event of 1/4 inch or greater until the site construction has been completed and the site determined as stabilized by the city. Reports of these inspections shall be kept by the person or entity authorized to direct the construction activities on the site and made available upon request.
- 4. Corrective action reports must be kept by the person or entity authorized to direct the construction activities on the site and made available upon request.
- 5. Stabilization reports must be kept by the person or entity authorized to direct the construction activities on the site and made available upon request. Reports should include records of weed removal per City Ordinance (§ 9-8-1), sterilization, soil test results and recommendation, materials, and manufacturer's specifications for application rates, estimated functional longevity, methods of application, inspection and maintenance. The reduced self-inspection schedule in CGP 4.4.1 applies to stabilized area and any damaged or worn stabilization must be identified in the reports along with weed problems. Corrective actions for stabilization shall be documented in a stabilization report including actual rates and dates of stabilization, and the materials and manufacturer's specifications used.
- 6.BMPs shall be inspected and maintained until all disturbed areas are stabilized in accordance with the Final Stabilization Criteria (CGP 2.2.14.b). Generally, all disturbed areas, other than structures and impervious surfaces, must have uniform perennial vegetation that provides 70 percent or more of the cover provided by native vegetation or seed the disturbed area and provide non-vegetative mulch that provides cover for at least three years without active maintenance. Final stabilization must be approved by the City of Albuquerque prior to removal of BMPs and discontinuation of inspections.

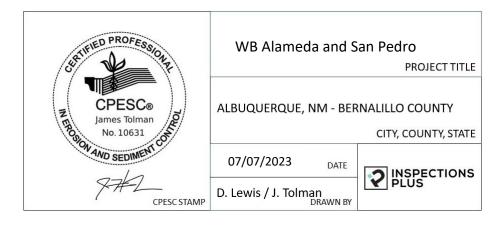

INLET PROTECTION







BMP Objectives

- Sediment Control
- Sheet Flow Runoff Control
- Wind Erosion Control



BMP Objectives

Sediment Control





BMP Objectives

- Runoff Control
- Run-on Diversion

BMP Objectives


- Sediment Control
- Sheet Flow Runoff Control
- Wind Erosion Control



BMP Objectives Sediment Control

MULCH SOCK/STRAW WATTLE

- Reduce Runoff Velocity
- **Inlet Protection**

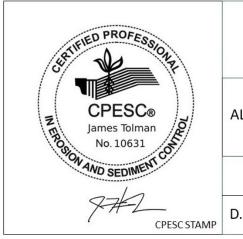

WB Alameda and San Pedro

PROJECT TITLE

ALBUQUERQUE, NM - BERNALILLO COUNTY

CITY, COUNTY, STATE

07/07/2023


DATE

D. Lewis / J. Tolman DRAWN BY



WHATABURGER TOPOGRAPHIC SURVEY & REMOVAL PLAN

6100 NE ALAMEDA BLVD, ALBUQUERQUE, NM A PORTION OF SECTION 13, TOWNSHIP 11 NORTH, RANGE 3 EAST BERNALILLO COUNTY, NEW MEXICO.

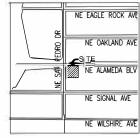




VICINITY MAP SCALE 1:800

REMOVAL CONSTRUCTION KEY NOTES

- \$\ \tag{1} \) SAWCUT EXISTING PAVEMENT TO PROVIDE STRAIGHT VERTICAL EDGES, FREE FROM IRREGULARITIES. MIN 2' FROM GUTTER.
- 2) CLEAR SITE, REMOVE VEGETATION AND DEBRIS WITHIN LIMITS OF
- 3 PROTECT EXISTING SIDEWALK.
- 3A REMOVE AND REPLACE EXISTING SIDEWALK.
- 4 PROTECT EXISTING VERTICAL CURB AND GUTTER.
- 5 REMOVE EXISTING VERTICAL CURB AND GUTTER.
- 5A REMOVE AND REPLACE EXISTING VERTICAL CURB AND GUTTER.
- 6 REMOVE EXISTING VERTICAL CURB.
- 7 REMOVE EXISTING LIGHT POLE.
- 8 PROTECT EXISTING CATCH BASIN.
- 9 REMOVE EXISTING FENCE.
- 10 REMOVE EXISTING STORAGE CONTAINER.
- 11) PROTECT EXISTING MANHOLE.
- 12 REMOVE & RELOCATE EXISTING FIRE HYDRANT.
- 13 PROTECT EXISTING TREE.
- 14 REMOVE EXISTING TREE.
- 15 PROTECT EXISTING WATER VALVE.
- 16 PROTECT EXISTING CURB INLET.
- 17> PROTECT TRAFFIC SIGNAL BOX.
- 18 PROTECT TRAFFIC LIGHT.
- 19 PROTECT EXISTING STORM LINE.
- 20) PROTECT EXISTING WATER METER.
- 21) PROTECT EXISTING SIGN.
- 22 EXISTING PULL BOX TO BE REMAINED.
- 23 REMOVE EXISTING WATER LINE. LENGTH PER PLAN.

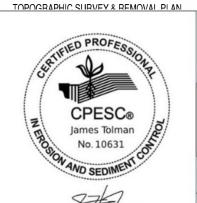

CPESC STAMP

Whataburger

PROJECT TITLE

ALBUQUERQUE, NM - BERNALILLO COUNTY

CITY, COUNTY, STATE

07/07/2023

D. Lewis / J. Tolman DRAWN BY ? INSPECTIONS

REFER TO SHEET CO.10 FOR GENERAL REMOVAL NOTES



SUSTAINABILITY ENGINEERING GROUP







NM BLVD AVE N BLVD 6100 ALAMEDA E ALBUQUERQUE, I

06/30/2023 PROJ. MGR. — AF 06/30/2023


07/04/2023 ISSUED FOR: PERMITS

210907

TOPOGRAPHIC SURVEY & REMOVAL PLAN

4 OF 15

C1.00

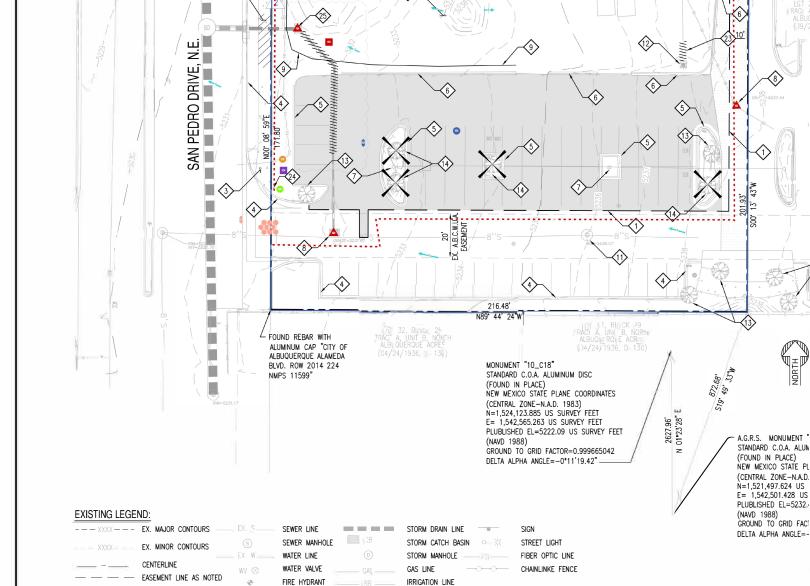

4 of 8

L=47.07', R=29.99'

ALAMEDA BOULEVARD, N.E.


S89° 46' 17"E

WB Alameda and San Pedro Inspections Plus, LLC Demolition SWPPP Map-Final

LEGEND




- 7
 - Pre Construction Water Flow (10)
- Silt Fence (2)
- Property Boundary (1)
- ERTEC Inlet Protection (3)
- Stabilized Construction Exit (1)
- SWPPP Sign (1)
- Portable Toilet (1)
- Debris Stockpiles (1)
- Dumpster (1)
- Spill Kit (1)
- Street Sweeping (1)
- Water Truck (1)

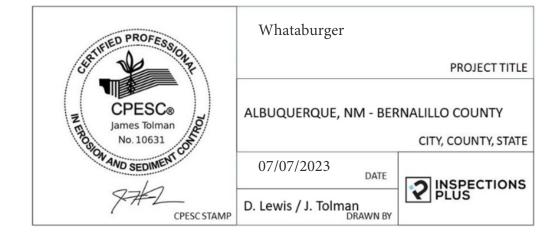

WHATABURGER GRADING AND DRAINAGE PLAN

6100 ALAMEDA BLVD NE, ALBUQUERQUE, NM A PORTION OF SECTION 13, TOWNSHIP 11 NORTH, RANGE 3 EAST

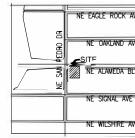

(24006

EXPIRATION DATE: 12-31-2024

SIGNATURE DATE: 07-20-2023

<u>₹</u>9

SUSTAINAB I ENG NEER I GROUP

DRAWN BY

CPESC STAMP

GRADING AND DRAINAGE PLAN

210907

CALL NM ONE-CALL SYSTEM SEVE

7) DAYS PRIOR TO ANY EXCAVATION

07/04/2023

P FRMIT S

NN BLVI AVE

ISSUED FOR


BE N

ALAMEDA QUERQUE,

6100 ALBU

06/30/2023

C3.00 8 OF 15

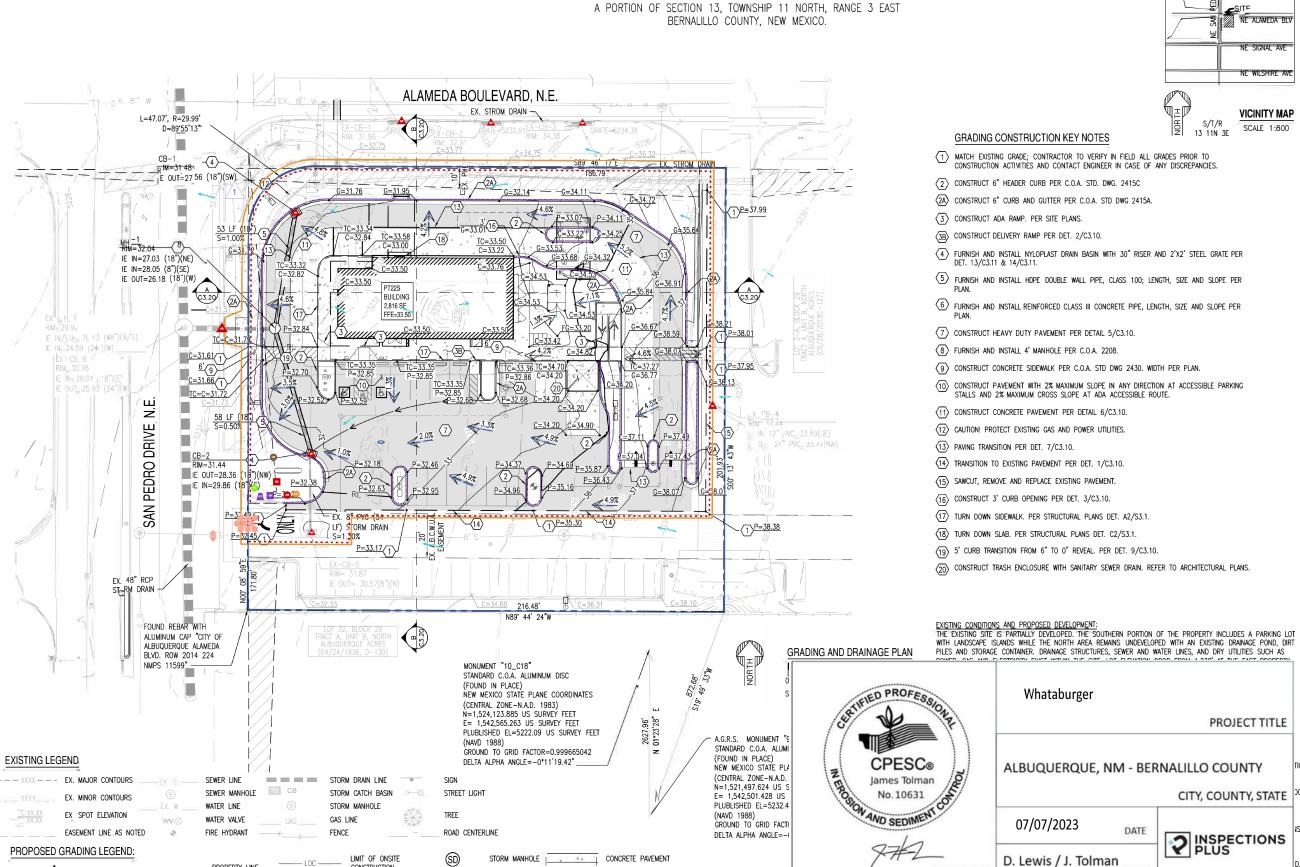

HEAVY DUTY PAVEMENT

STORM INLET

INVERT ELEVATIONS TO DE VERIFIED IN FIELD

PROPERTY LINE

VERTICAL CURB

CLITTER FLEVATION

PAVEMENT ELEVATION

CONCRETE ELEVATION _____ RL ____ RIDGELINE

TC = G+0.5'

P=XX.XX

C=XX XX-

CONSTRUCTION

FLOW ARROW

CATCH BASIN

STORM PIPE

WM


GATE VALVE

FIRE HYDRAN

LEGEND



- Silt Fence (2)
- Pre Construction Water Flow (14)
- Post Construction Water Flow (17)
- ---- Cutback Curb / Sidewalk (10)
- Property Boundary (1)
- Limit of Disturbance (1)
- ERTEC Inlet Protection (8)
- SWPPP Sign (1)
- Water Truck (1)
- Street Sweeping (1)
- Stabilized Construction Exit (1)
- Portable Concrete Washout Bin (1)
- Dumpster (1)
- Portable Toilet (1)
- Materials Storage (1)
- Spill Kit (1)
- Stockpiles (1)

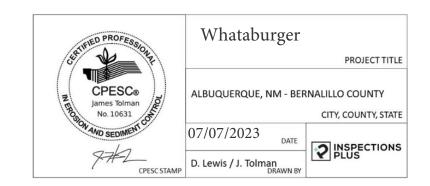

OPERATOR:

CKP Construction 4600 I-40 West, Suite 302 Amarillo, TX 79106 806-420-0696

Todd Barbour Project Manager 806-420-0696 tbarbour@ckpconstruction.com

OWNER:

Whataburger 300 Concord Plaza Drive San Antonio, TX 78216

Talal Medlej Construction Project Manager 210-209-3908 tmedlej@wbhq.com

