### CITY OF ALBUQUERQUE

[776]

July 7, 2016

Richard J. Berry, Mayor

J. Graeme Means, P.E. High Mesa Consulting Group 4715 Moon St NE Albuquerque, NM, 87111

RE: APS La Cueva ISP & Weight Room Additions

**Drainage Plan** 

Engineer's Stamp Date 5-23-2016 (File: C19D004)

Replacement Submittal Dated 6-28-2016

Revised Stamp Date 7-1-2016 (Minor changes do not affect Hydrology). AC 10-27-2016

Dear Mr. Means:

Based upon the information provided in your submittal received 5-24-2016 & 6-28-2016, the above referenced Grading and Drainage Plan is approved for Building Permit.

Please attach a copy of this approved plan in the construction sets when submitting for the building permit. Prior to Certificate of Occupancy (CO) release, Engineer Certification per the DPM checklist will be required.

PO Box 1293

If you have any questions, you can contact me at 924-3986.

Albuquerque

New Mexico 87103

Abiel Carrillo, P.E.

Sincerely,

Principal Engineer, Planning Department

**Development Review Services** 

www.cabq.gov

Orig: Drainage file



### City of Albuquerque


### Planning Department


#### Development & Building Services Division

#### DRAINAGE AND TRANSPORTATION INFORMATION SHEET (REV 09/2015)

Project Title:	Building Permit #:		
DRB#: EPC	t:	Work Order#:	
Legal Description:			
City Address:			
Engineering Firm:		Contact:	
Address:			
Phone#: Fax	. <u> </u>	_ E-mail:	
Owner:		Contact:	
Address:			
Phone#: Fax		E-mail:	
Architect:		Contact:	
Address:			
Phone#: Fax		E-mail:	
Other Contact:		Contact:	
Address:			
Phone#: Fax		E-mail:	
DEPARTMENT:  HYDROLOGY/ DRAINAGE  TRAFFIC/ TRANSPORTATION  MS4/ EROSION & SEDIMENT CONTROL	BUILDING I	F APPROVAL/ACCEPTANCE SOUGHT: PERMIT APPROVAL TE OF OCCUPANCY	
	<del></del>		
TYPE OF SUBMITTAL:	PRELIMINA	PRELIMINARY PLAT APPROVAL	
ENGINEER/ ARCHITECT CERTIFICATION		SITE PLAN FOR SUB'D APPROVAL	
CONCEPTUAL G & D PLAN	<del></del>	FOR BLDG. PERMIT APPROVAL	
GRADING PLAN		T APPROVAL ASE OF FINANCIAL GUARANTEE	
DRAINAGE MASTER PLAN		ON PERMIT APPROVAL	
DRAINAGE REPORT		GRADING PERMIT APPROVAL	
CLOMR/LOMR		SO-19 APPROVAL	
	PAVING PE	ERMIT APPROVAL	
TRAFFIC CIRCULATION LAYOUT (TCL)	GRADING/ I	GRADING/ PAD CERTIFICATION	
TRAFFIC IMPACT STUDY (TIS)		WORK ORDER APPROVAL	
EROSION & SEDIMENT CONTROL PLAN (F	CLOMR/LOI	MR	
OTHER (SPECIFY)	— PRE-DESIGN	I MEETING	
	· · · · · · · · · · · · · · · · · · ·	ECIFY)	
	OTHER (BI	Ech 1)	
IS THIS A RESUBMITTAL?: Yes No	OTTER (61)		
IS THIS A RESUBMITTAL?: Yes No  DATE SUBMITTED:			

COA STAFF: ELECTRONIC SUBMITTAL RECEIVED: \_\_\_\_

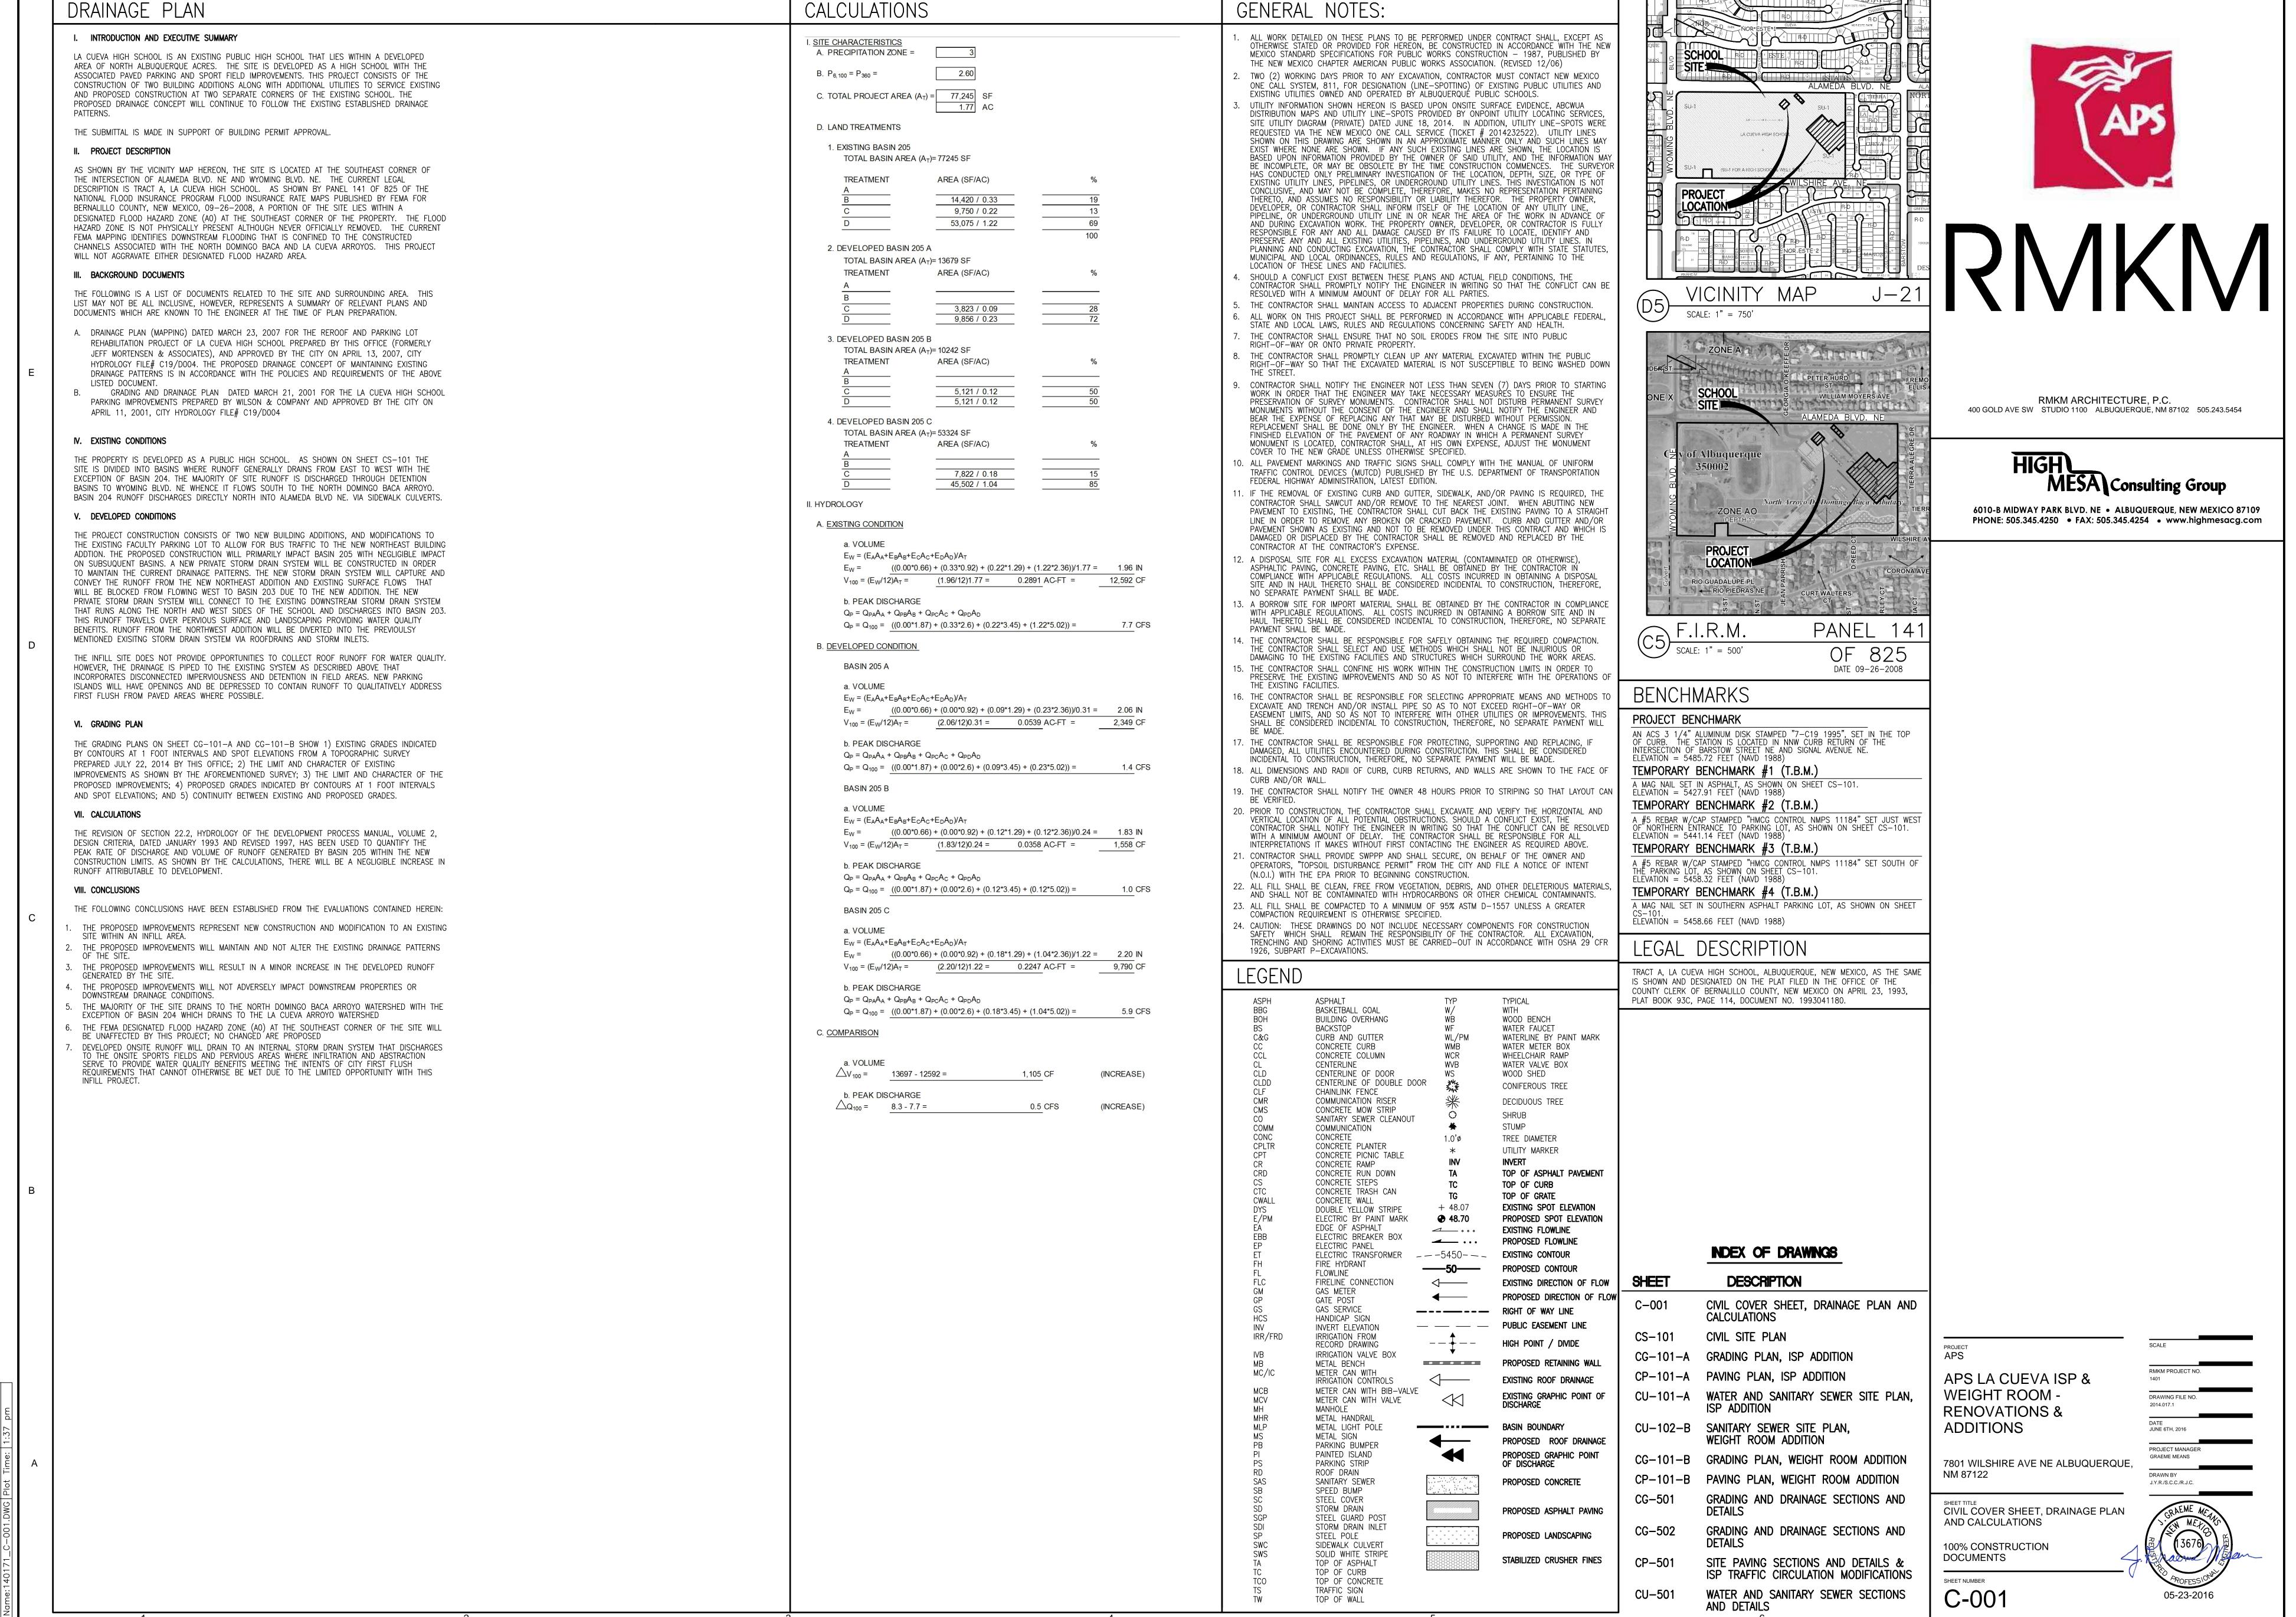

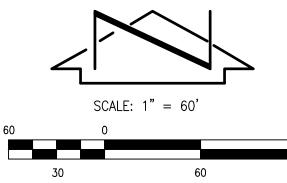




RMKM ARCHITECTURE, P.C.
400 GOLD AVE SW STUDIO 1100 ALBUQUERQUE, NM 87102 505.243.5454

HIGH MESA Consulting Group

6010-B MIDWAY PARK BLVD. NE • ALBUQUERQUE, NEW MEXICO 87109 PHONE: 505.345.4250 • FAX: 505.345.4254 • www.highmesacg.com

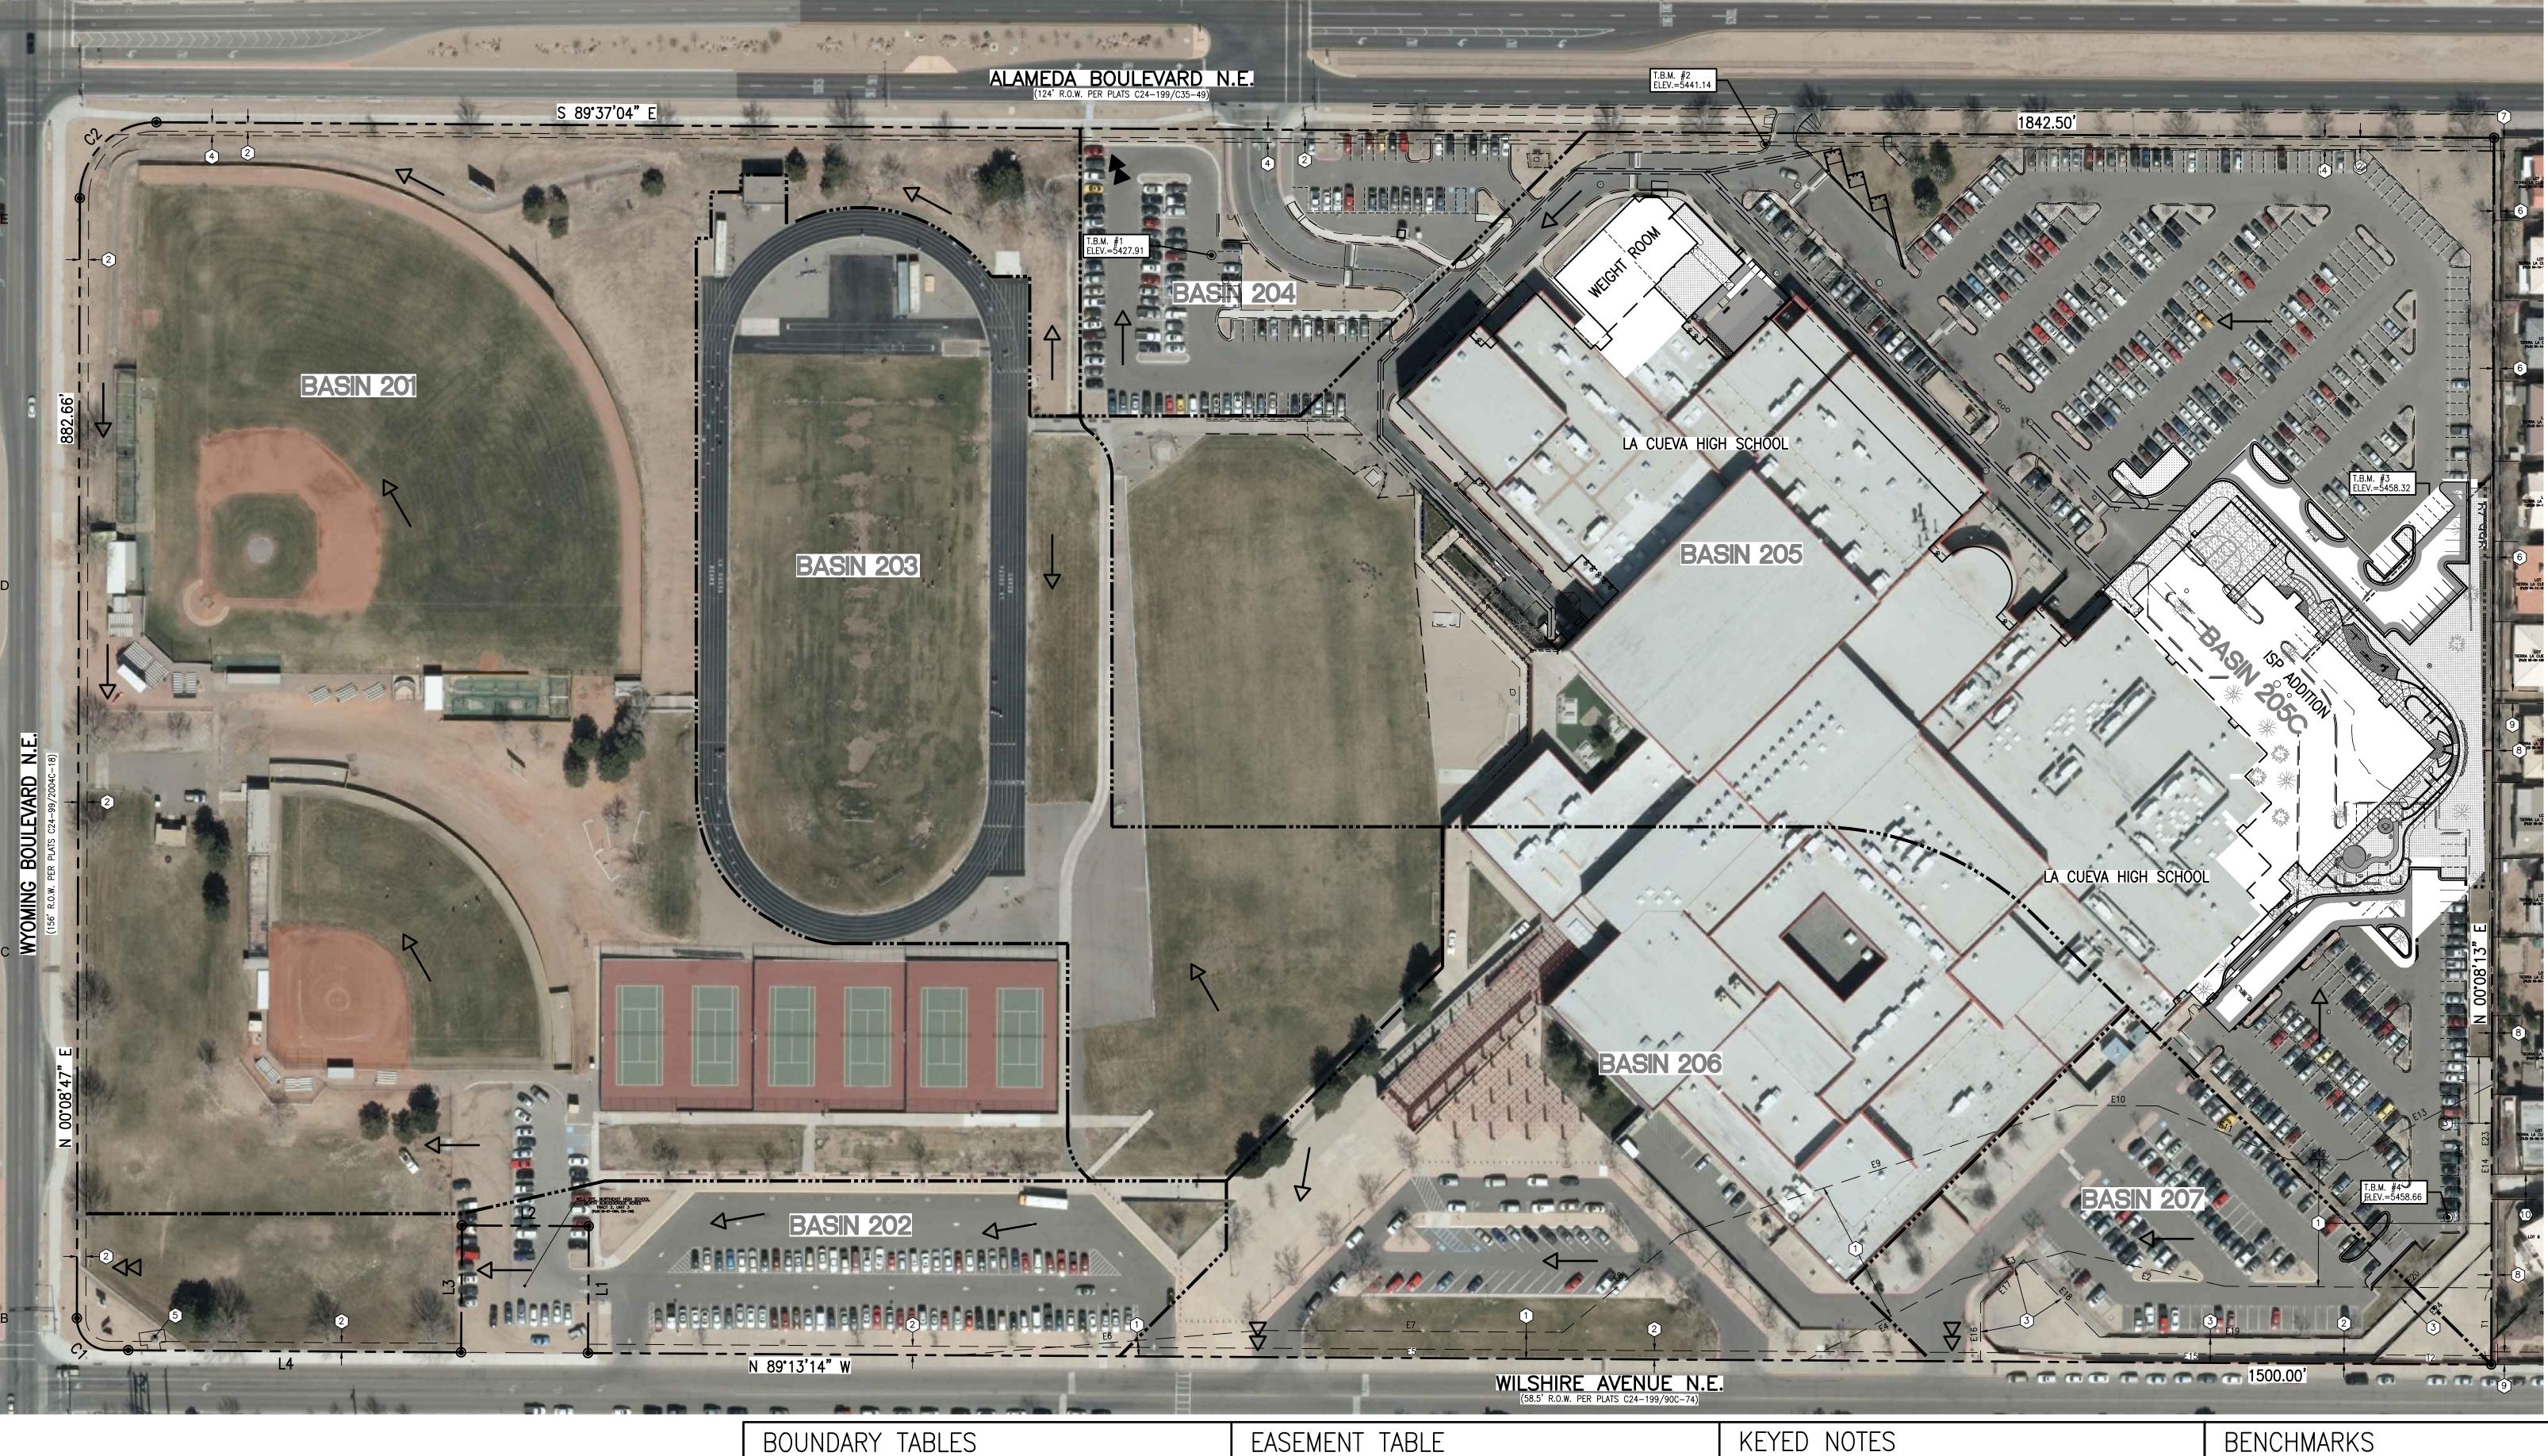

SURVEY NOTE

THIS IS NOT A BOUNDARY SURVEY; DATA IS SHOWN FOR ORIENTATION ONLY. THE BOUNDARY INFORMATION DEPICTED BY THIS PLAN IS BASED UPON AN UNRECORDED BOUNDARY SURVEY PREPARED BY HIGH MESA CONSULTING GROUP, NMPS 11184, DATED 07-22-2014 (2013.186.1). EXCEPT AS NOTED OTHERWISE THE TOPOGRAPHIC INFORMATION DEPICTED HEREON IS BASED UPON THE "PARTIAL TOPOGRAPHIC AND UTILITY SURVEY" PREPARED BY HIGH MESA CONSULTING GROUP, NMPS NO. 11184, DATED 07-22-2014 (2013.186.1).

BOUNDARY TABLES	EASEMENT TABLE
LINE DIRECTION DISTANCE  L1 N 00°20′46″ E 100.00′  L2 N 89°39′14″ W 100.00′  L3 S 00°20′46″ W 100.00′  L4 N 89°39′14″ W 277.99′   CURVE RADIUS LENGTH CHORD CHORD BEARING DELTA  C1 25.00′ 39.35′ 35.41′ N 44°33′35″ W 90°11′08″  C2 60.00′ 94.50′ 85.03′ N 45°15′51″ E 90°14′22″   TRACT A, LA CUEVA HIGH SCHOOL, ALBUQUERQUE, NEW MEXICO, FILED APRIL 23, 1993, PLAT BOOK 93C, PAGE 114, DOCUMENT NO. 1993041180.	LINE DIRECTION DISTANCE E1 N 89°39'03" W 210.50' E2 N 77°20'00" W 126.00' E3 S 75°21'00" W 87.00' E4 S 62°21'00" W 138.00' E5 N 89°39'03" W 670.00' E6 N 85°20'00" E 240.00' E7 S 89°39'03" E 238.00' E8 N 50°21'00" E 120.00' E9 N 71°50'00" E 328.00' E10 S 89°39'03" E 65.00' E11 S 67°39'00" E 111.00' E12 S 89°39'03" E 46.46'  T1 S 00°08'24" W 160.00 E13 N 62°38'30" E 128.44 E14 S 00°08'24" W 160.00 E15 N 89°39'03" W 307.27 E16 N 00°07'26" E 46.43 E17 N 45°16'44" E 47.58 E18 S 44°35'45" E 85.12 E19 S 89°40'51" E 205.29 E20 N 45°22'52" E 117.72 E21 N 00°09'22" W 139.34 E22 S 89°29'49" W 20.75 E23 S 00°08'24" W 147.35 E24 S 45°17'39" W 134.36  T1 S 00°08'24" W 60.42 T2 N 89°39'03" W 95.27

EASEMENT (1) AMAFCA 100-YEAR FLOODPLAIN EASEMENT GRANTED BY PLAT

C24-199 (2) 7' PUBLIC UTILITY EASEMENT GRANTED BY PLAT C24-199 3 PUBLIC DRAINAGE EASEMENT GRANTED BY DOCUMENT FILED 11-02-1993, BOOK 93-31, PAGES 745-749

(4) 10' PNM AND MST&T UNDERGROUND EASEMENT GRANTED BY DOCUMENT EXECUTED 01-02-1985 (5) APPROXIMATE LOCATION PNM (ELECTRIC) UNDERGROUND EASEMENT GRANTED BY DOCUMENT FILED 11-21-2008, DOC# 2008124541

(6) 5' PRIVATE DRAINAGE EASEMENT GRANTED BY PLAT 92C-62  $\langle \overline{7} \rangle$  10' PUBLIC UTILITY EASEMENT GRANTED BY PLAT 92C-62 (8) 5' PRIVATE DRAINAGE EASEMENT GRANTED BY PLAT 93C-229 (9) 10' PUBLIC UTILITY EASEMENT GRANTED BY PLAT 93C-229

EASEMENTS - OFFSITE (10) 20' PUBLIC DRAINAGE RIGHT-OF-WAY GRANTED BY PLAT 93C-229 PROJECT BENCHMARK

AN ACS 3 1/4" ALUMINUM DISK STAMPED "7-C19 1995", SET IN THE TOP OF CURB. THE STATION IS LOCATED IN NNW CURB RETURN OF THE INTERSECTION OF BARSTOW STREET NE AND SIGNAL AVENUE NE. ELEVATION = 5485.72 FEET (NAVD 1988)

TEMPORARY BENCHMARK #1 (T.B.M.) A MAG NAIL SET IN ASPHALT, AS SHOWN THIS ELEVATION = 5427.91 FEET (NAVD 1988) TEMPORARY BENCHMARK #2 (T.B.M.)

A #5 REBAR W/CAP STAMPED "HMCG CONTROL NMPS 11184" SET JUST WEST OF NORTHERN ENTRANCE TO PARKING LOT, AS SHOWN THIS SHEET. ELEVATION = 5441.14 FEET (NAVD 1988) TEMPORARY BENCHMARK #3 (T.B.M.)

A #5 REBAR W/CAP STAMPED "HMCG CONTROL NMPS 11184" SET SOUTH OF THE PARKING LOT, AS SHOWN THIS SHEET. ELEVATION = 5458.32 FEET (NAVD 1988) TEMPORARY BENCHMARK #4 (T.B.M.) A MAG NAIL SET IN SOUTHERN ASPHALT PARKING LOT, AS SHOWN THIS SHEET. ELEVATION = 5458.66 FEET (NAVD 1988)

**RENOVATIONS & ADDITIONS** 

WEIGHT ROOM -

APS LA CUEVA ISP &

7801 WILSHIRE AVE NE ALBUQUERQUE, NM 87122

CIVIL SITE PLAN

PROJECT APS

100% CONSTRUCTION DOCUMENTS


> SHEET NUMBER CS-101


J.Y.R./S.C.C./R.J.C. 05-23-2016

DATE JUNE 6TH, 2016

GRAEME MEANS

RMKM ARCHITECTURE, P.C. 2014.017.1 copyright © 2013

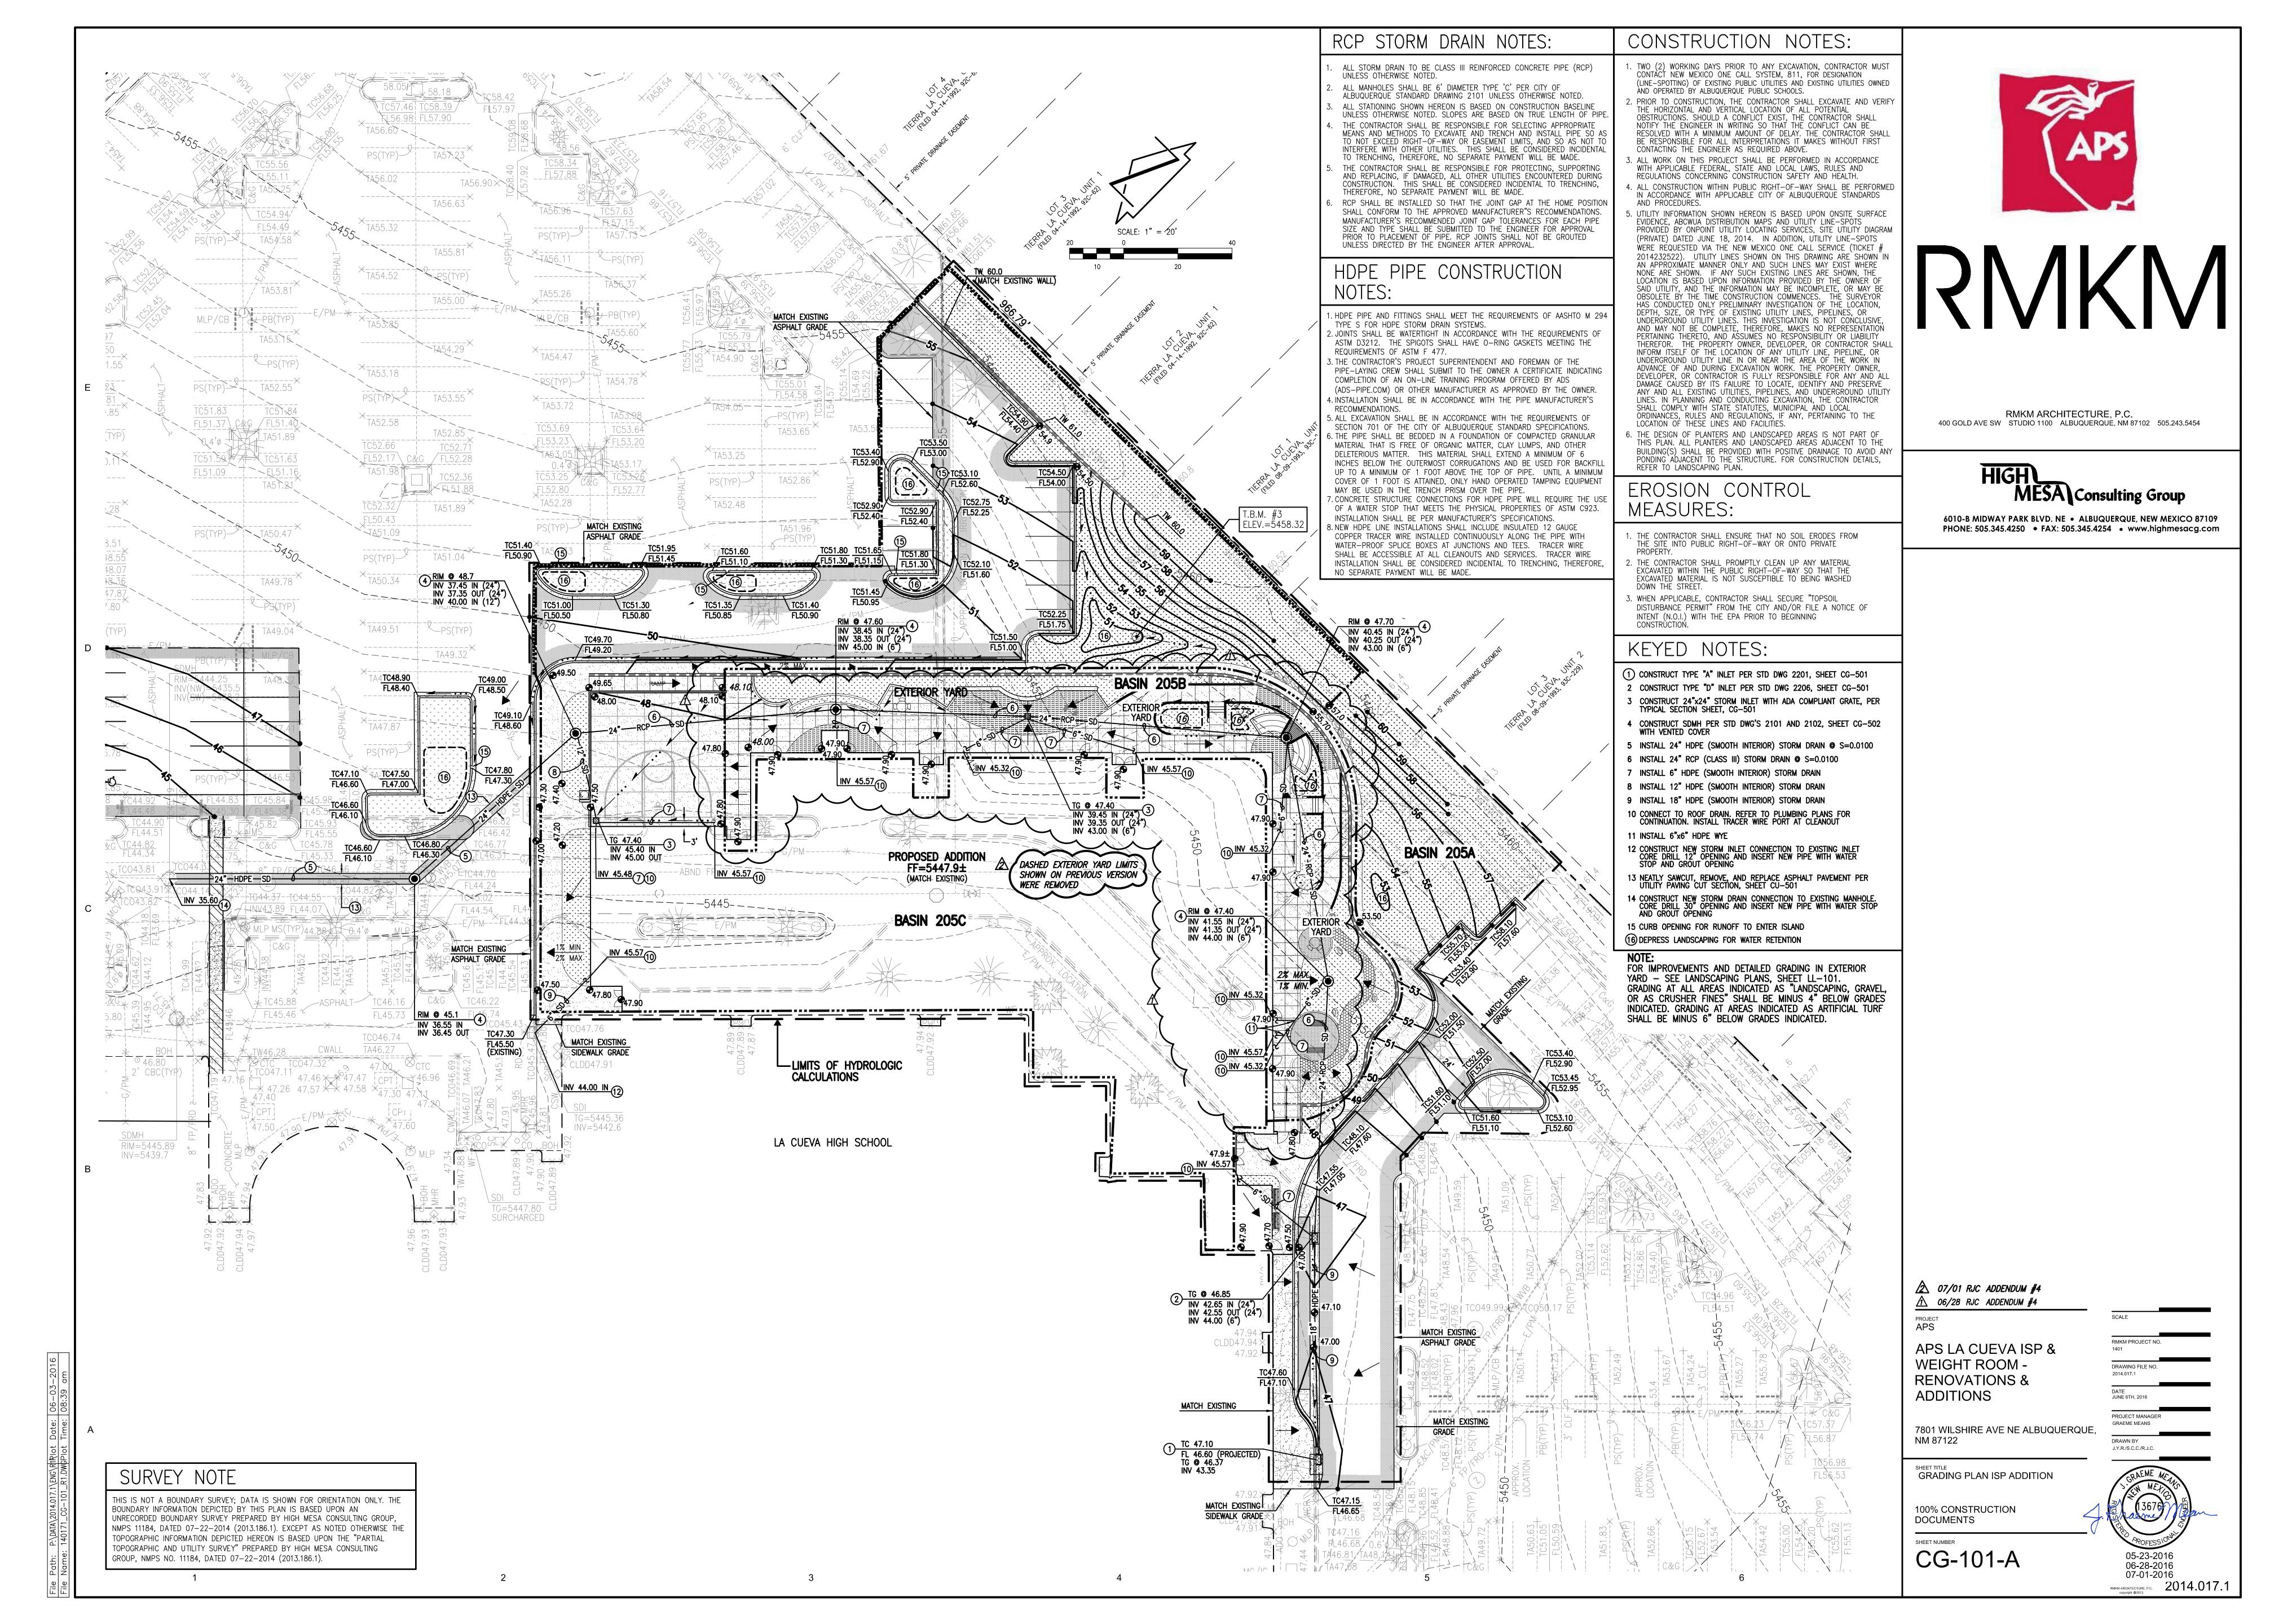

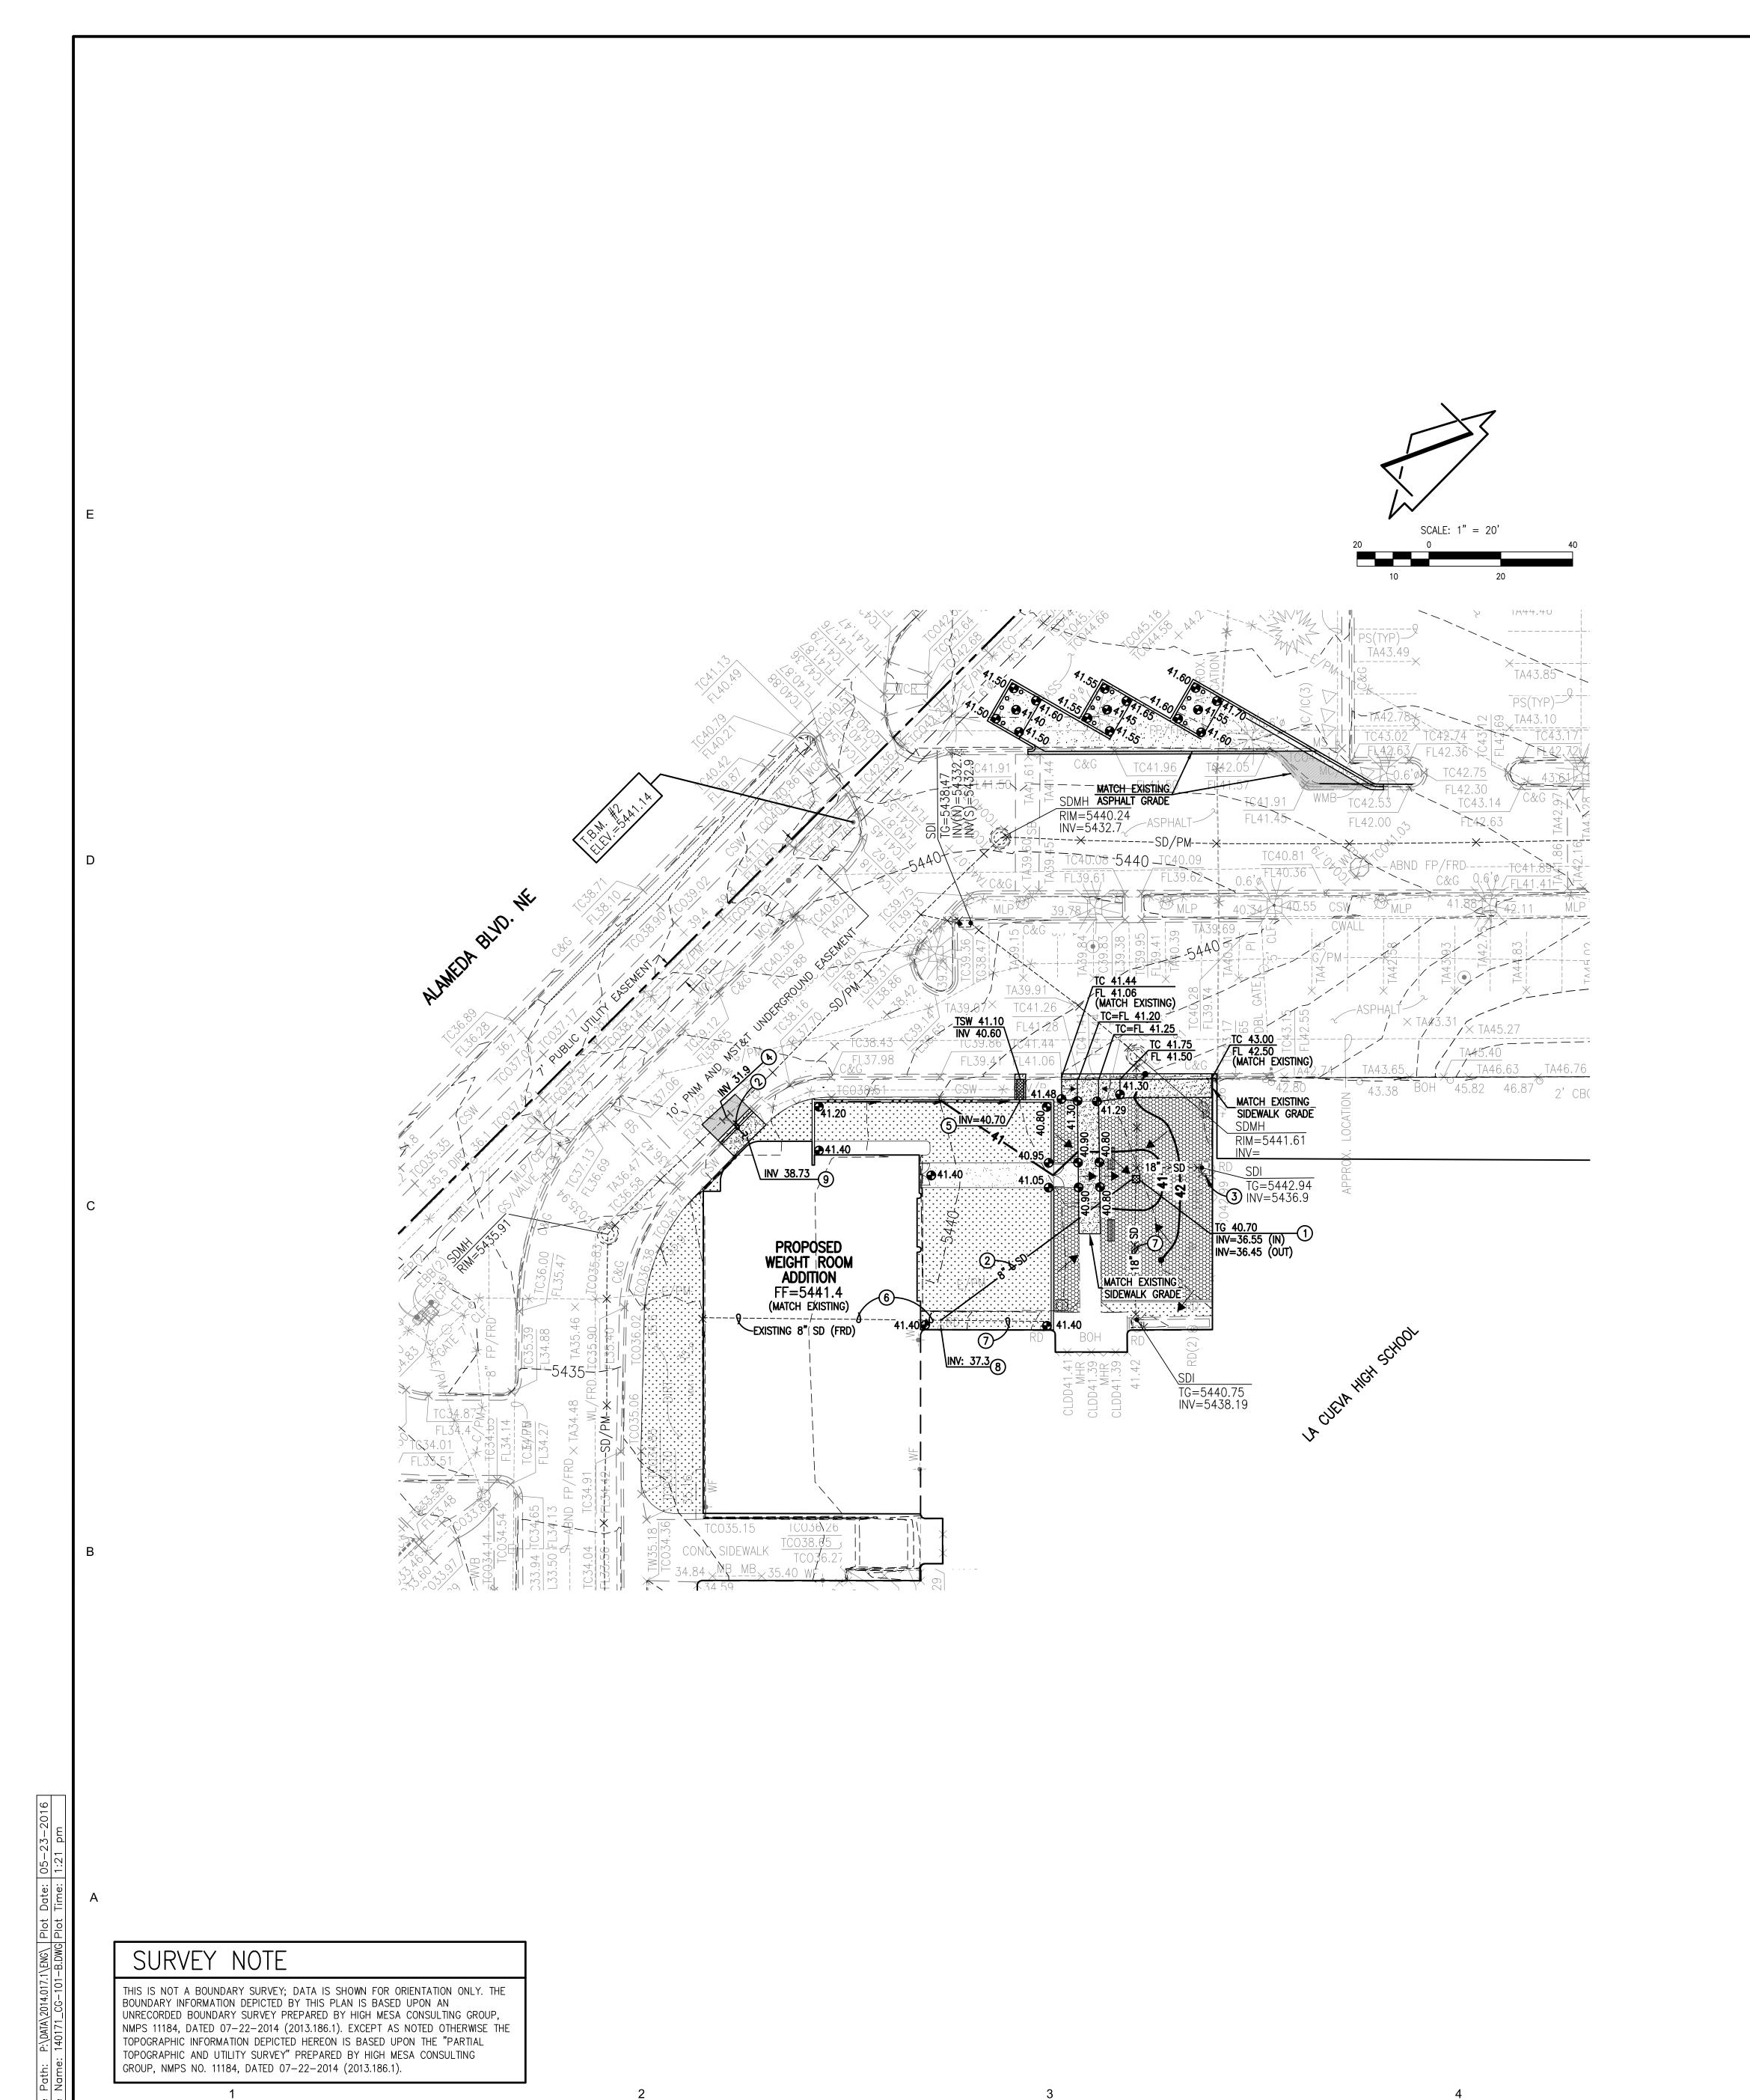

# HDPE PIPE CONSTRUCTION NOTES:

HDPE PIPE AND FITTINGS SHALL MEET THE REQUIREMENTS OF AASHTO M 294 TYPE S FOR HDPE STORM DRAIN SYSTEMS.
 JOINTS SHALL BE WATERTIGHT IN ACCORDANCE WITH THE REQUIREMENTS OF ASTM D3212. THE SPIGOTS SHALL HAVE O-RING GASKETS MEETING THE REQUIREMENTS OF ASTM F 477.
 THE CONTRACTOR'S PROJECT SUPERINTENDENT AND FOREMAN OF THE PIPE-LAYING CREW SHALL SUBMIT TO THE OWNER A CERTIFICATE INDICATING COMPLETION OF AN ON-LINE TRAINING PROGRAM OFFERED BY ADS (ADS-PIPE.COM) OR OTHER MANUFACTURER AS APPROVED BY THE OWNER.
 INSTALLATION SHALL BE IN ACCORDANCE WITH THE PIPE

MANUFACTURER'S RECOMMENDATIONS.

5. ALL EXCAVATION SHALL BE IN ACCORDANCE WITH THE REQUIREMENTS OF SECTION 701 OF THE CITY OF ALBUQUERQUE

STANDARD SPECIFICATIONS. 6. THE PIPE SHALL BE BEDDED IN A FOUNDATION OF COMPACTED GRANULAR MATERIAL THAT IS FREE OF ORGANIC MATTER, CLAY LUMPS, AND OTHER DELETERIOUS MATTER. THIS MATERIAL SHALL EXTEND A MINIMUM OF 6 INCHES BELOW THE OUTERMOST CORRUGATIONS AND BE USED FOR BACKFILL UP TO A MINIMUM OF 1 FOOT ABOVE THE TOP OF PIPE. UNTIL A MINIMUM COVER OF 1 FOOT IS ATTAINED, ONLY HAND OPERATED TAMPING EQUIPMENT MAY BE USED IN THE TRENCH PRISM OVER THE PIPE. 7. CONCRETE STRUCTURE CONNECTIONS FOR HDPE PIPE WILL REQUIRE THE USE OF A WATER STOP THAT MEETS THE PHYSICAL PROPERTIES OF ASTM C923. INSTALLATION SHALL BE PER MANUFACTURER'S SPECIFICATIONS. 8. NEW HDPE LINE INSTALLATIONS SHALL INCLUDE INSULATED 12 GAUGE COPPER TRACER WIRE INSTALLED CONTINUOUSLY ALONG THE PIPE WITH WATER-PROOF SPLICE BOXES AT JUNCTIONS AND TEES. TRACER WIRE SHALL BE ACCESSIBLE AT ALL CLEANOUTS

AND SERVICES. TRACER WIRE INSTALLATION SHALL BE

PAYMENT WILL BE MADE.

CONSIDERED INCIDENTAL TO TRENCHING, THEREFORE, NO SEPARATE

### CONSTRUCTION NOTES:

TWO (2) WORKING DAYS PRIOR TO ANY EXCAVATION, CONTRACTOR MUST CONTACT NEW MEXICO ONE CALL SYSTEM, 811, FOR DESIGNATION (LINE—SPOTTING) OF EXISTING PUBLIC UTILITIES AND EXISTING UTILITIES OWNED AND OPERATED BY ALBUQUERQUE PUBLIC SCHOOLS.
 PRIOR TO CONSTRUCTION, THE CONTRACTOR SHALL EXCAVATE AND VERIFY THE HORIZONTAL AND VERTICAL LOCATION OF ALL POTENTIAL OBSTRUCTIONS. SHOULD A CONFLICT EXIST, THE CONTRACTOR SHALL NOTIFY THE ENGINEER IN WRITING SO THAT THE CONFLICT CAN BE RESOLVED WITH A MINIMUM AMOUNT OF DELAY. THE CONTRACTOR SHALL BE RESPONSIBLE FOR ALL INTERPRETATIONS IT MAKES WITHOUT FIRST CONTACTING THE ENGINEER AS REQUIRED ABOVE.

3. ALL WORK ON THIS PROJECT SHALL BE PERFORMED IN ACCORDANCE WITH APPLICABLE FEDERAL, STATE AND LOCAL LAWS, RULES AND REGULATIONS CONCERNING CONSTRUCTION SAFETY AND HEALTH.

4. ALL CONSTRUCTION WITHIN PUBLIC RIGHT—OF—WAY SHALL BE PERFORMED

IN ACCORDANCE WITH APPLICABLE CITY OF ALBUQUERQUE STANDARDS AND PROCEDURES. UTILITY INFORMATION SHOWN HEREON IS BASED UPON ONSITE SURFACE EVIDENCE, ABCWUA DISTRIBUTION MAPS AND UTILITY LINE—SPOTS PROVIDED BY ONPOINT UTILITY LOCATING SERVICES, SITE UTILITY DIAGRAM (PRIVATE) DATED JUNE 18, 2014. IN ADDITION, UTILITY LINE-SPOTS WERE REQUESTED VIA THE NEW MEXICO ONE CALL SERVICE (TICKET # 2014232522). UTILITY LINES SHOWN ON THIS DRAWING ARE SHOWN IN AN APPROXIMATE MANNER ONLY AND SUCH LINES MAY EXIST WHERE NONE ARE SHOWN. IF ANY SUCH EXISTING LINES ARE SHOWN. TH LOCATION IS BASED UPON INFORMATION PROVIDED BY THE OWNER O SAID UTILITY, AND THE INFORMATION MAY BE INCOMPLETE, OR MAY B OBSOLETE BY THE TIME CONSTRUCTION COMMENCES. THE SURVEYOR HAS CONDUCTED ONLY PRELIMINARY INVESTIGATION OF THE LOCATION, DEPTH, SIZE, OR TYPE OF EXISTING UTILITY LINES, PIPELINES, OR UNDERGROUND UTILITY LINES. THIS INVESTIGATION IS NOT CONCLUSIVE, AND MAY NOT BE COMPLETE, THEREFORE, MAKES IN THE STANDING THE PROPERTY OF THE PRO PERTAINING THERETO, AND ASSUMES NO RESPONSIBILITY OR LIABILITY THEREFOR. THE PROPERTY OWNER, DEVELOPER, OR CONTRACTOR SHALL INFORM ITSELF OF THE LOCATION OF ANY UTILITY LINE, PIPELINE, OR UNDERGROUND UTILITY LINE IN OR NEAR THE AREA OF THE WORK IN ADVANCE OF AND DURING EXCAVATION WORK. THE PROPERTY OWNER, DEVELOPER, OR CONTRACTOR IS FULLY RESPONSIBLE FOR ANY AND ALL DAMAGE CAUSED BY ITS FAILURE TO LOCATE, IDENTIFY AND PRESERVE ANY AND ALL EXISTING UTILITIES, PIPELINES, AND UNDERGROUND UTILITY LINES. IN PLANNING AND CONDUCTING EXCAVATION, THE CONTRACTOR SHALL COMPLY WITH STATE STATUTES, MUNICIPAL AND LOCAL

ORDINANCES, RULES AND REGULATIONS, IF ANY, PERTAINING TO THE LOCATION OF THESE LINES AND FACILITIES.

THE DESIGN OF PLANTERS AND LANDSCAPED AREAS IS NOT PART OF THIS PLAN. ALL PLANTERS AND LANDSCAPED AREAS ADJACENT TO THE BUILDING(S) SHALL BE PROVIDED WITH POSITIVE DRAINAGE TO AVOID ANY PONDING ADJACENT TO THE STRUCTURE. FOR CONSTRUCTION DETAILS, REFER TO LANDSCAPING PLAN.

# EROSION CONTROL MEASURES:

THE CONTRACTOR SHALL ENSURE THAT NO SOIL ERODES FROM THE SITE INTO PUBLIC RIGHT-OF-WAY OR ONTO PRIVATE

THE CONTRACTOR SHALL PROMPTLY CLEAN UP ANY MATERIAL EXCAVATED WITHIN THE PUBLIC RIGHT-OF-WAY SO THAT THE EXCAVATED MATERIAL IS NOT SUSCEPTIBLE TO BEING WASHED

3. WHEN APPLICABLE, CONTRACTOR SHALL SECURE "TOPSOIL DISTURBANCE PERMIT" FROM THE CITY AND/OR FILE A NOTICE OF INTENT (N.O.I.) WITH THE EPA PRIOR TO BEGINNING CONSTRUCTION.

### KFYFD NOTFS:

1) CONSTRUCT 24"x24" STORM INLET WITH (ADA) COMPLIANT GRATE PER TYPICAL SECTION SHEET, CG-501

2 INSTALL 8" HDPE (SMOOTH INTERIOR) STORM DRAIN

3 EXISTING INLET TO REMAIN. 4 INSTALL 18"x18"x8" HDPE TEE

5 CORE DRILL 6" WALL OPENING. ALIGN OPENING WITH PROPOSED SIDEWALK CULVERT

6 REMOVE AND DISPOSE OF EXISTING STORM DRAIN
7 EXISTING STORM DRAIN TO REMAIN

8 CONNECT NEW 8" STORM DRAIN TO EXISTING 8" ROOF DRAIN

9 CONNECT TO BUILDING ROOF DRAIN. REFER TO PLUMBING PLANS FOR CONTINUATION

### NOTE:

GRADING AT ALL AREAS INDICATED AS "LANDSCAPING, GRAVEL, OR AS CRUSHER FINES" SHALL BE MINUS 4" BELOW GRADES INDICATED. GRADING AT AREAS INDICATED AS ARTIFICIAL TURF SHALL BE MINUS 6" BELOW GRADES INDICATED.



RMKM ARCHITECTURE, P.C. 400 GOLD AVE SW STUDIO 1100 ALBUQUERQUE, NM 87102 505.243.5454



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APS


APS LA CUEVA ISP & WEIGHT ROOM - RENOVATIONS & ADDITIONS

7801 WILSHIRE AVE NE ALBUQUERQUE, NM 87122

SHEET TITLE
GRADING PLAN
WEIGHT ROOM ADDITION


100% CONSTRUCTION DOCUMENTS


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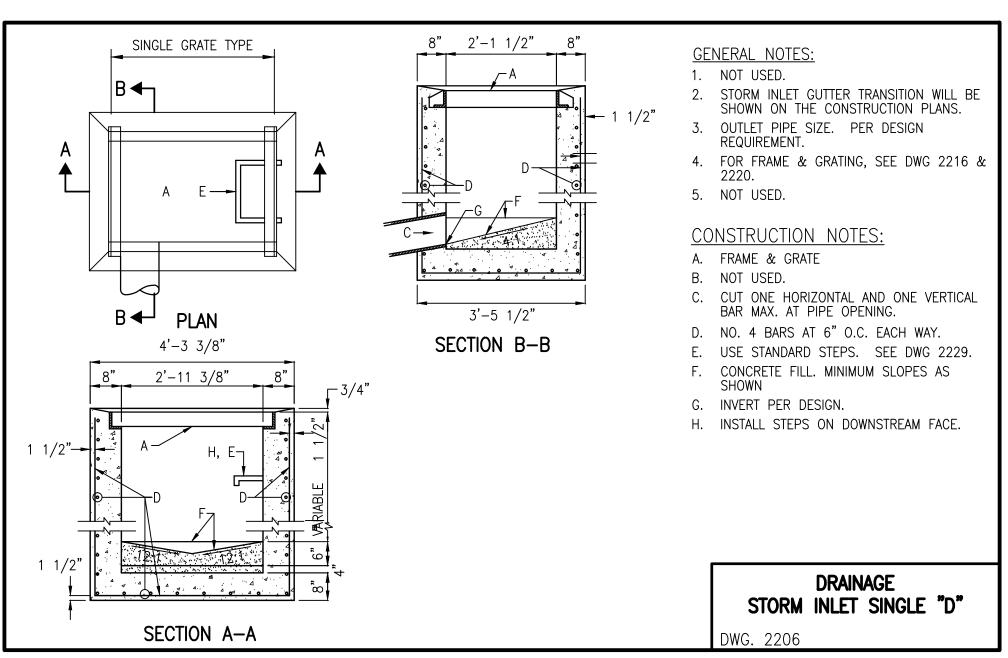


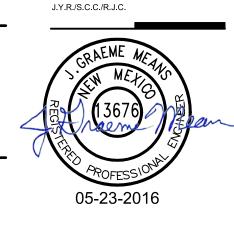
DATE JUNE 6TH, 2016


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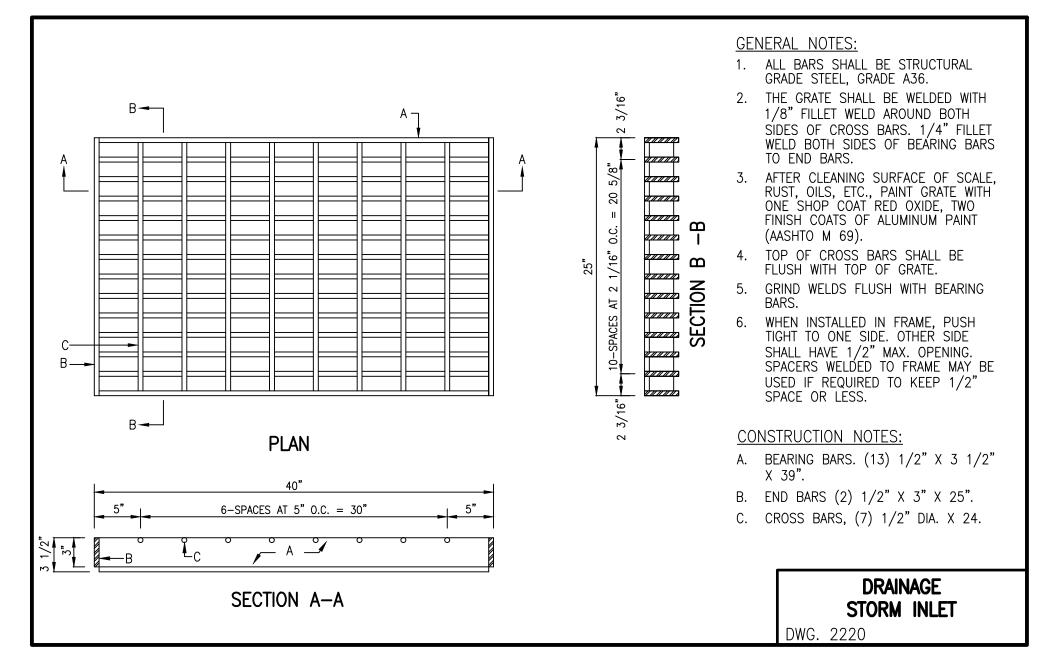





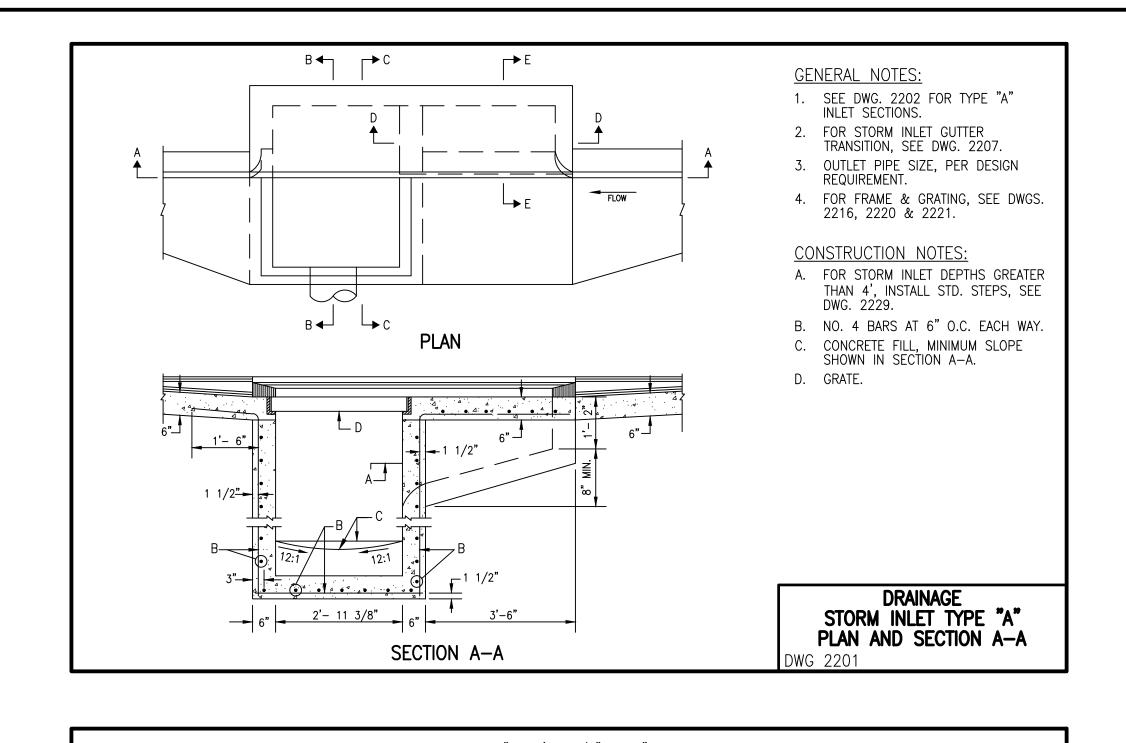

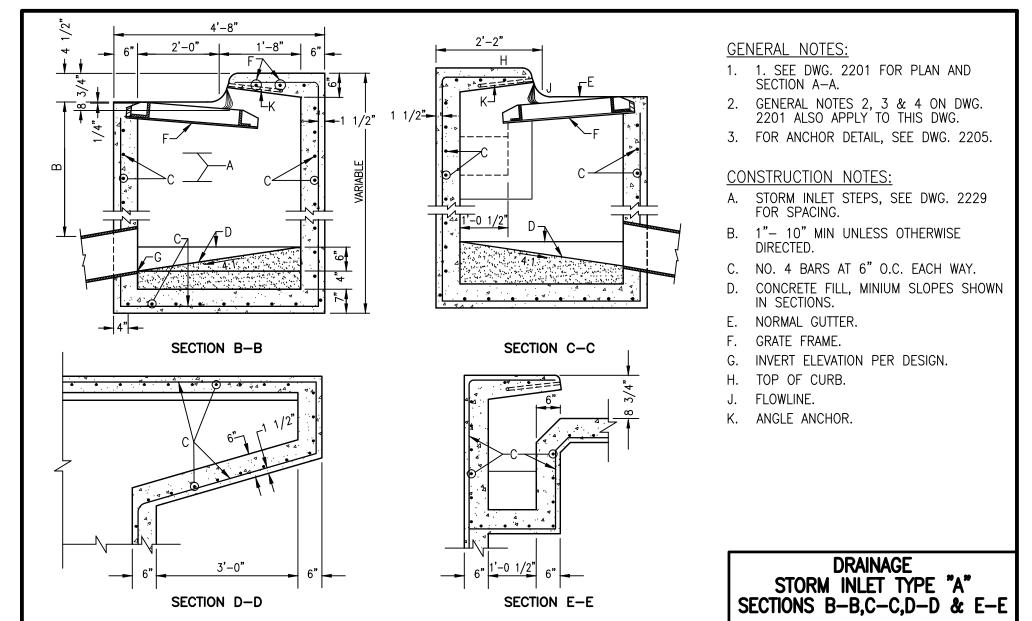

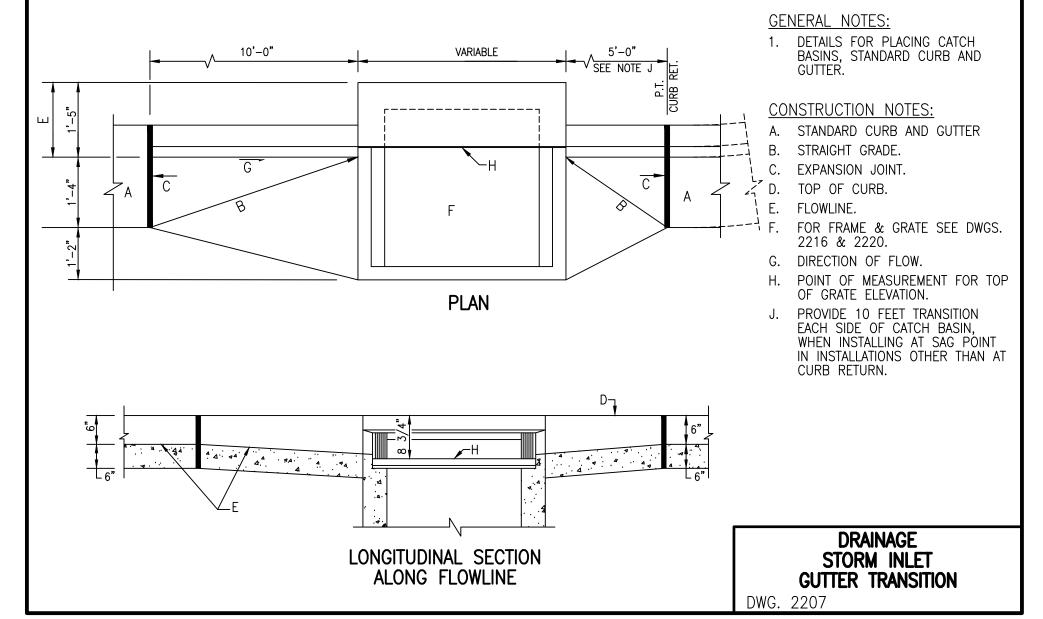

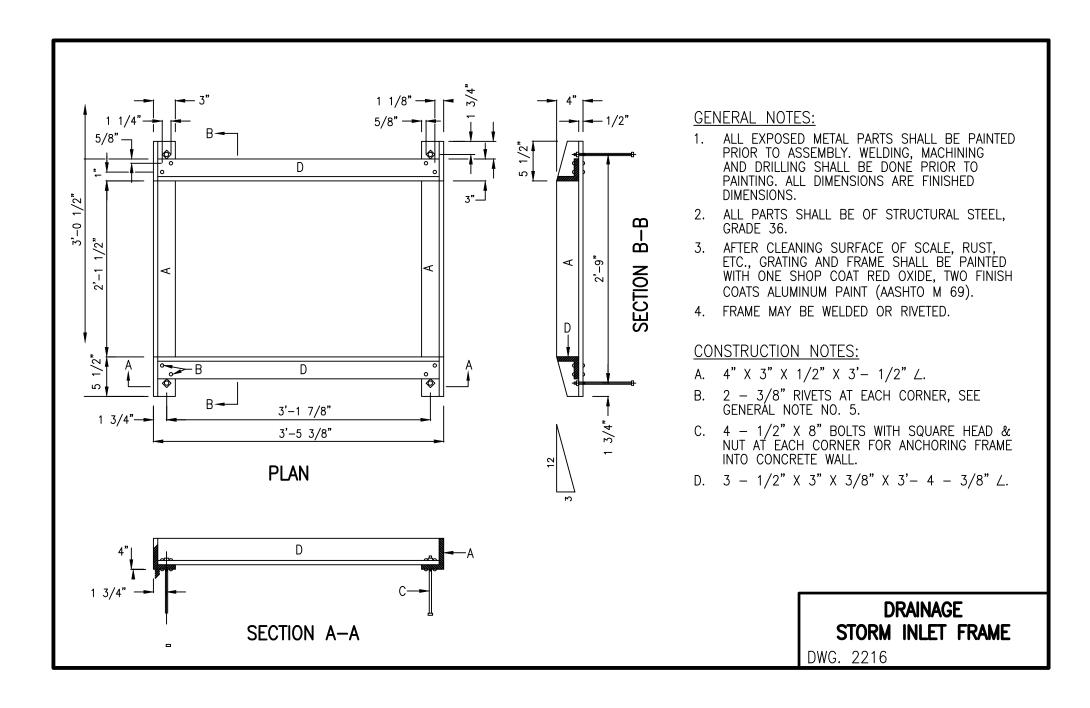

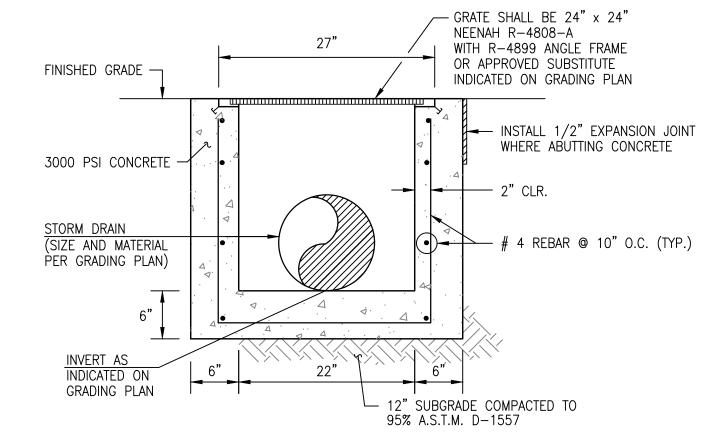

TYPICAL 24"X24" STORM INLET SECTION

APS

APS LA CUEVA ISP & WEIGHT ROOM -**RENOVATIONS & ADDITIONS** 

7801 WILSHIRE AVE NE ALBUQUERQUE, NM 87122

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PHONE: 505.345.4250 • FAX: 505.345.4254 • www.highmesacg.com

HIGH

SHEET TITLE
GRADING AND DRAINAGE SECTIONS AND DETAILS


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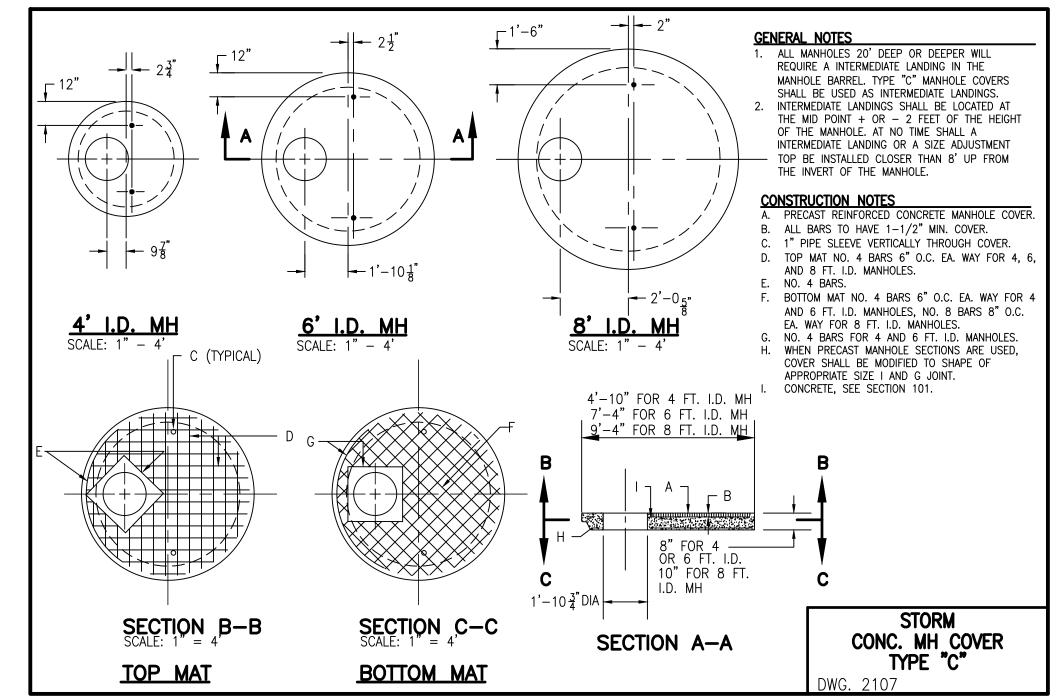
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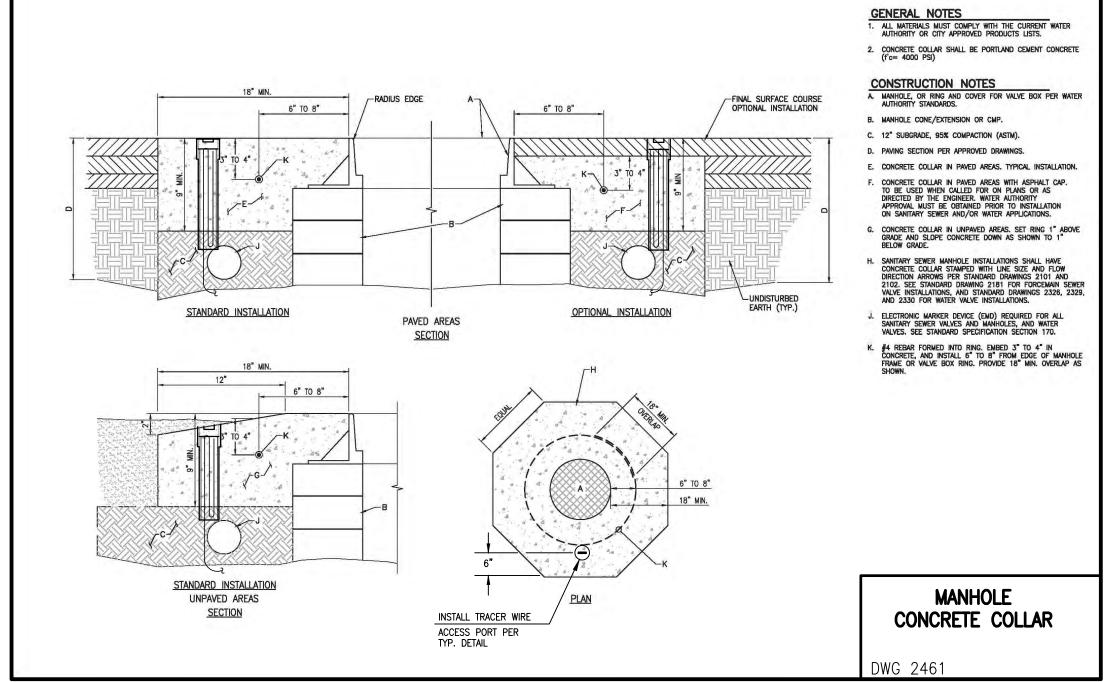
RMKM PROJECT NO.

DATE JUNE 6TH, 2016

CG-501





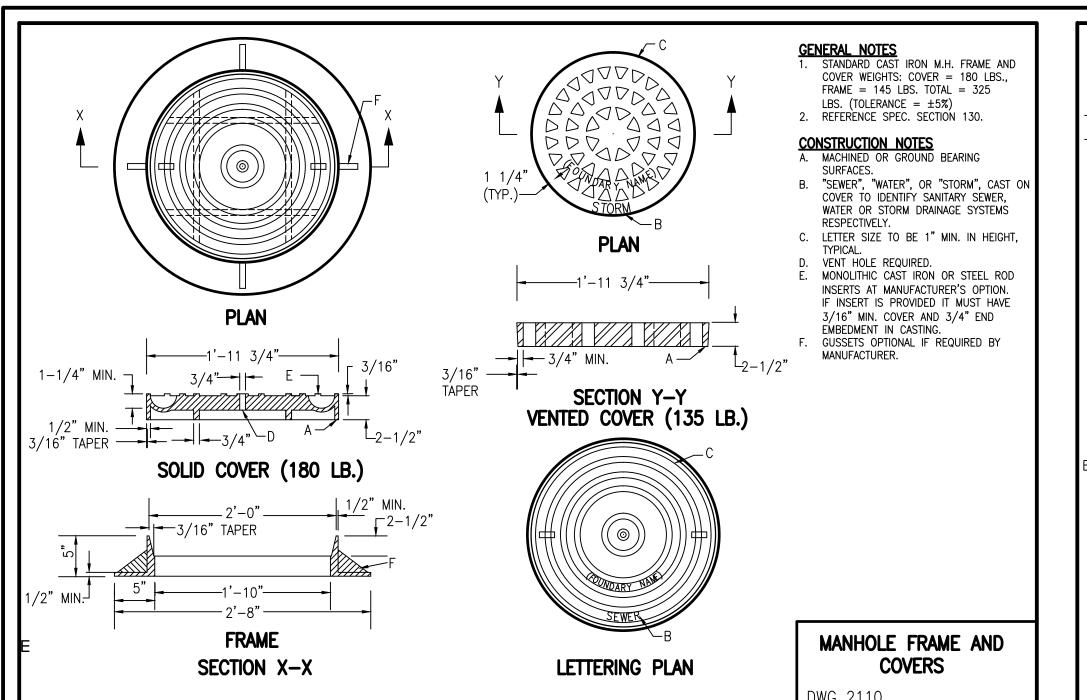






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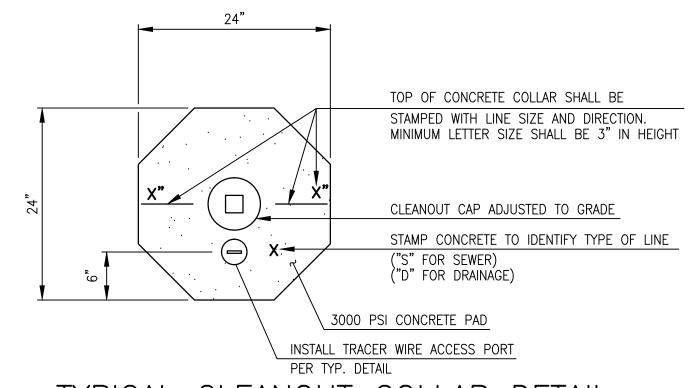
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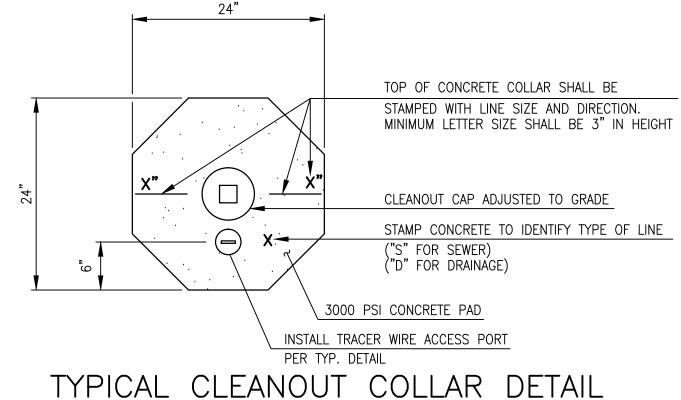




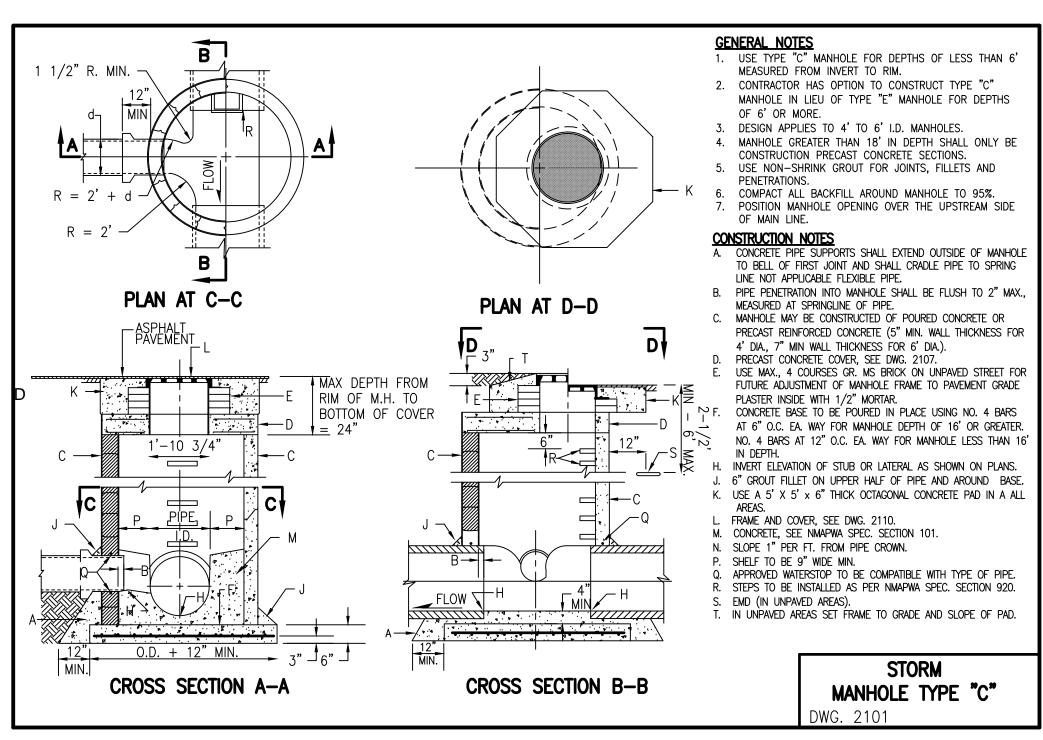


TYPICAL TRACER WIRE ACCESS PORT NOT TO SCALE

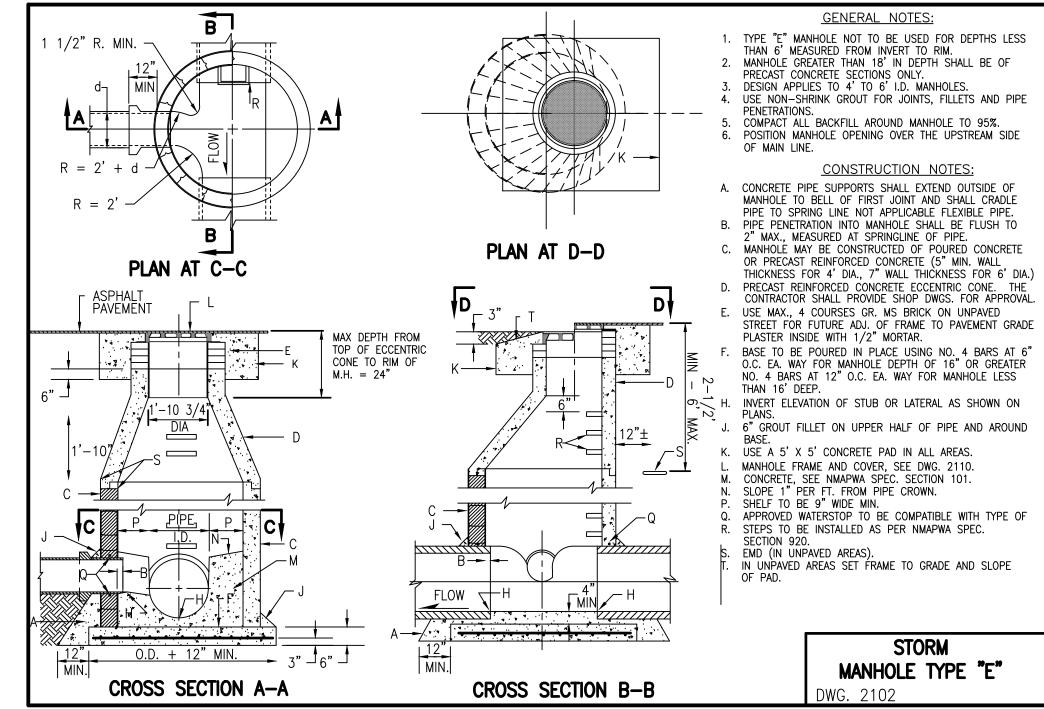

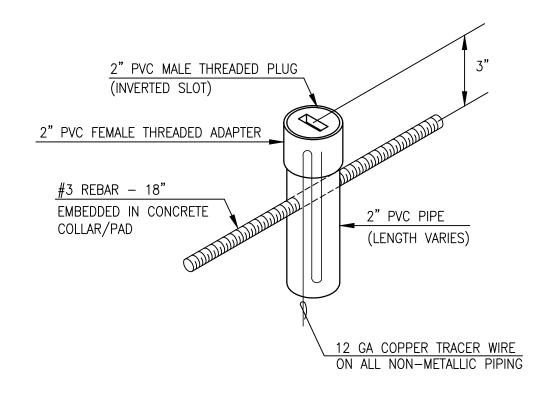

SCALE: 1" = 1'-0"

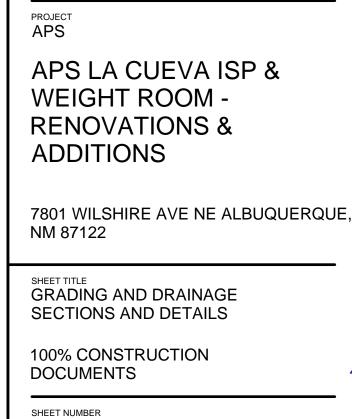



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EXISTING TRAFFIC FLOW

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 CURVE
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 DELTA

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⚠ 06/28 RJC ADDENDUM #4

PROJECT APS

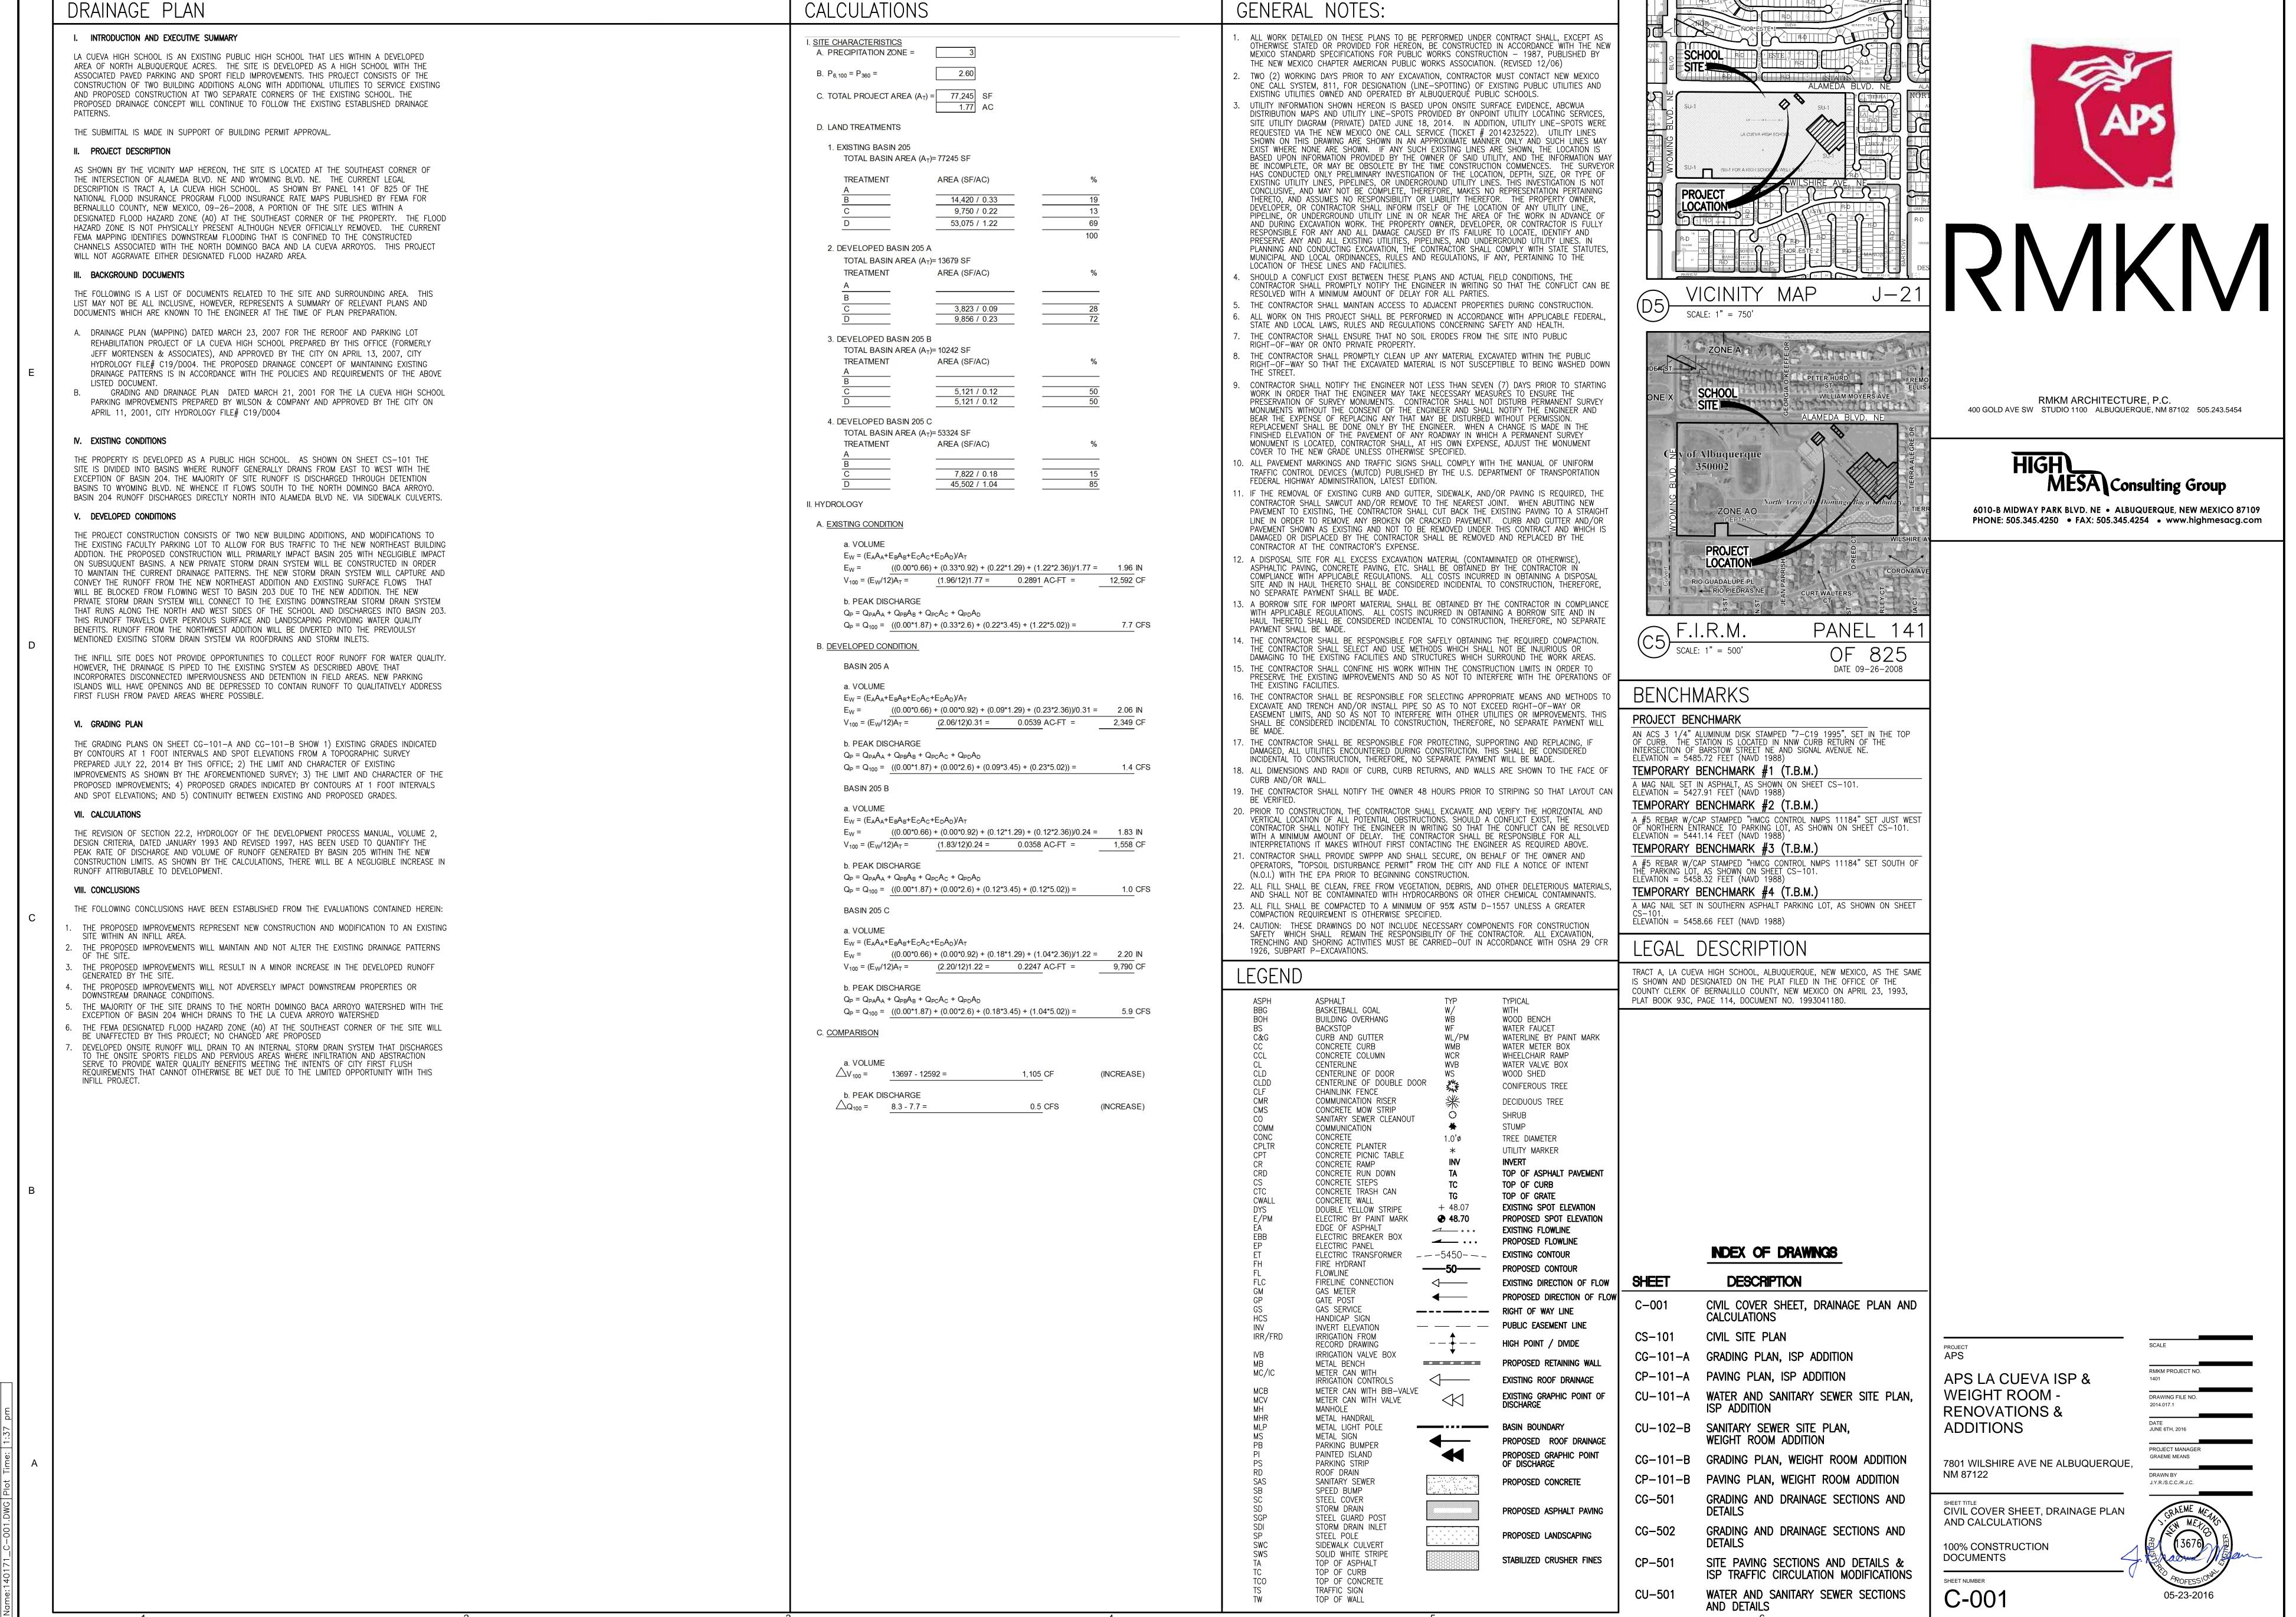APS LA CUEVA ISP & WEIGHT ROOM -**RENOVATIONS & ADDITIONS** 
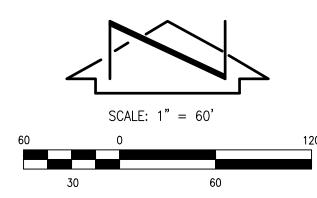
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CIVIL SITE PLAN

100% CONSTRUCTION **DOCUMENTS** 

SHEET NUMBER CS-101

J.Y.R./S.C.C./R.J.C. 05-23-2016 06-28-2016 RMKM ARCHITECTURE, P.C. 2014.017.1

DRAWING FILE NO.

PROJECT MANAGER

GRAEME MEANS

2014.017.1

DATE JUNE 6TH, 2016

SURVEY NOTE

THIS IS NOT A BOUNDARY SURVEY; DATA IS SHOWN FOR ORIENTATION ONLY. THE BOUNDARY INFORMATION DEPICTED BY THIS PLAN IS BASED UPON AN UNRECORDED BOUNDARY SURVEY PREPARED BY HIGH MESA CONSULTING GROUP, NMPS 11184, DATED 07-22-2014 (2013.186.1). EXCEPT AS NOTED OTHERWISE THE TOPOGRAPHIC INFORMATION DEPICTED HEREON IS BASED UPON THE "PARTIAL TOPOGRAPHIC AND UTILITY SURVEY" PREPARED BY HIGH MESA CONSULTING

GROUP, NMPS NO. 11184, DATED 07-22-2014 (2013.186.1).

E3 S 75°21'00" W 87.00' E4 S 62°21'00" W 138.00'

E5 N 89°39'03" W 670.00'

E9 N 71°50'00" E 328.00'

E10 S 89°39'03" E 65.00' E11 S 67°39'00" E 111.00'

E12 S 89°39'03" E 46.46'

 E6
 N 85°20'00" E
 240.00'
 E18
 S 44°35'45" E
 85.12'

 E7
 S 89°39'03" E
 238.00'
 E19
 S 89°40'51" E
 205.29'

 E8
 N 50°21'00" E
 120.00'
 E20
 N 45°22'52" E
 117.72'

LINE DIRECTION DISTANCE E13 N 62°38'30" E 128.44'

E15 N 89°39'03" W 307.27'
E16 N 00°07'26" E 46.43'
E17 N 45°16'44" E 47.58'

E18 S 44°35'45" E 85.12


E20 N 45°22'52" E 117.72'

E21 N 00°09'22" W 139.34'

E22 S 89°29'49" W 20.75' E23 S 00°08'24" W 147.35'

E24 S 45°17'39" W 134.36'

T1 S 00°08'24" W 60.42' T2 N 89°39'03" W 95.27'

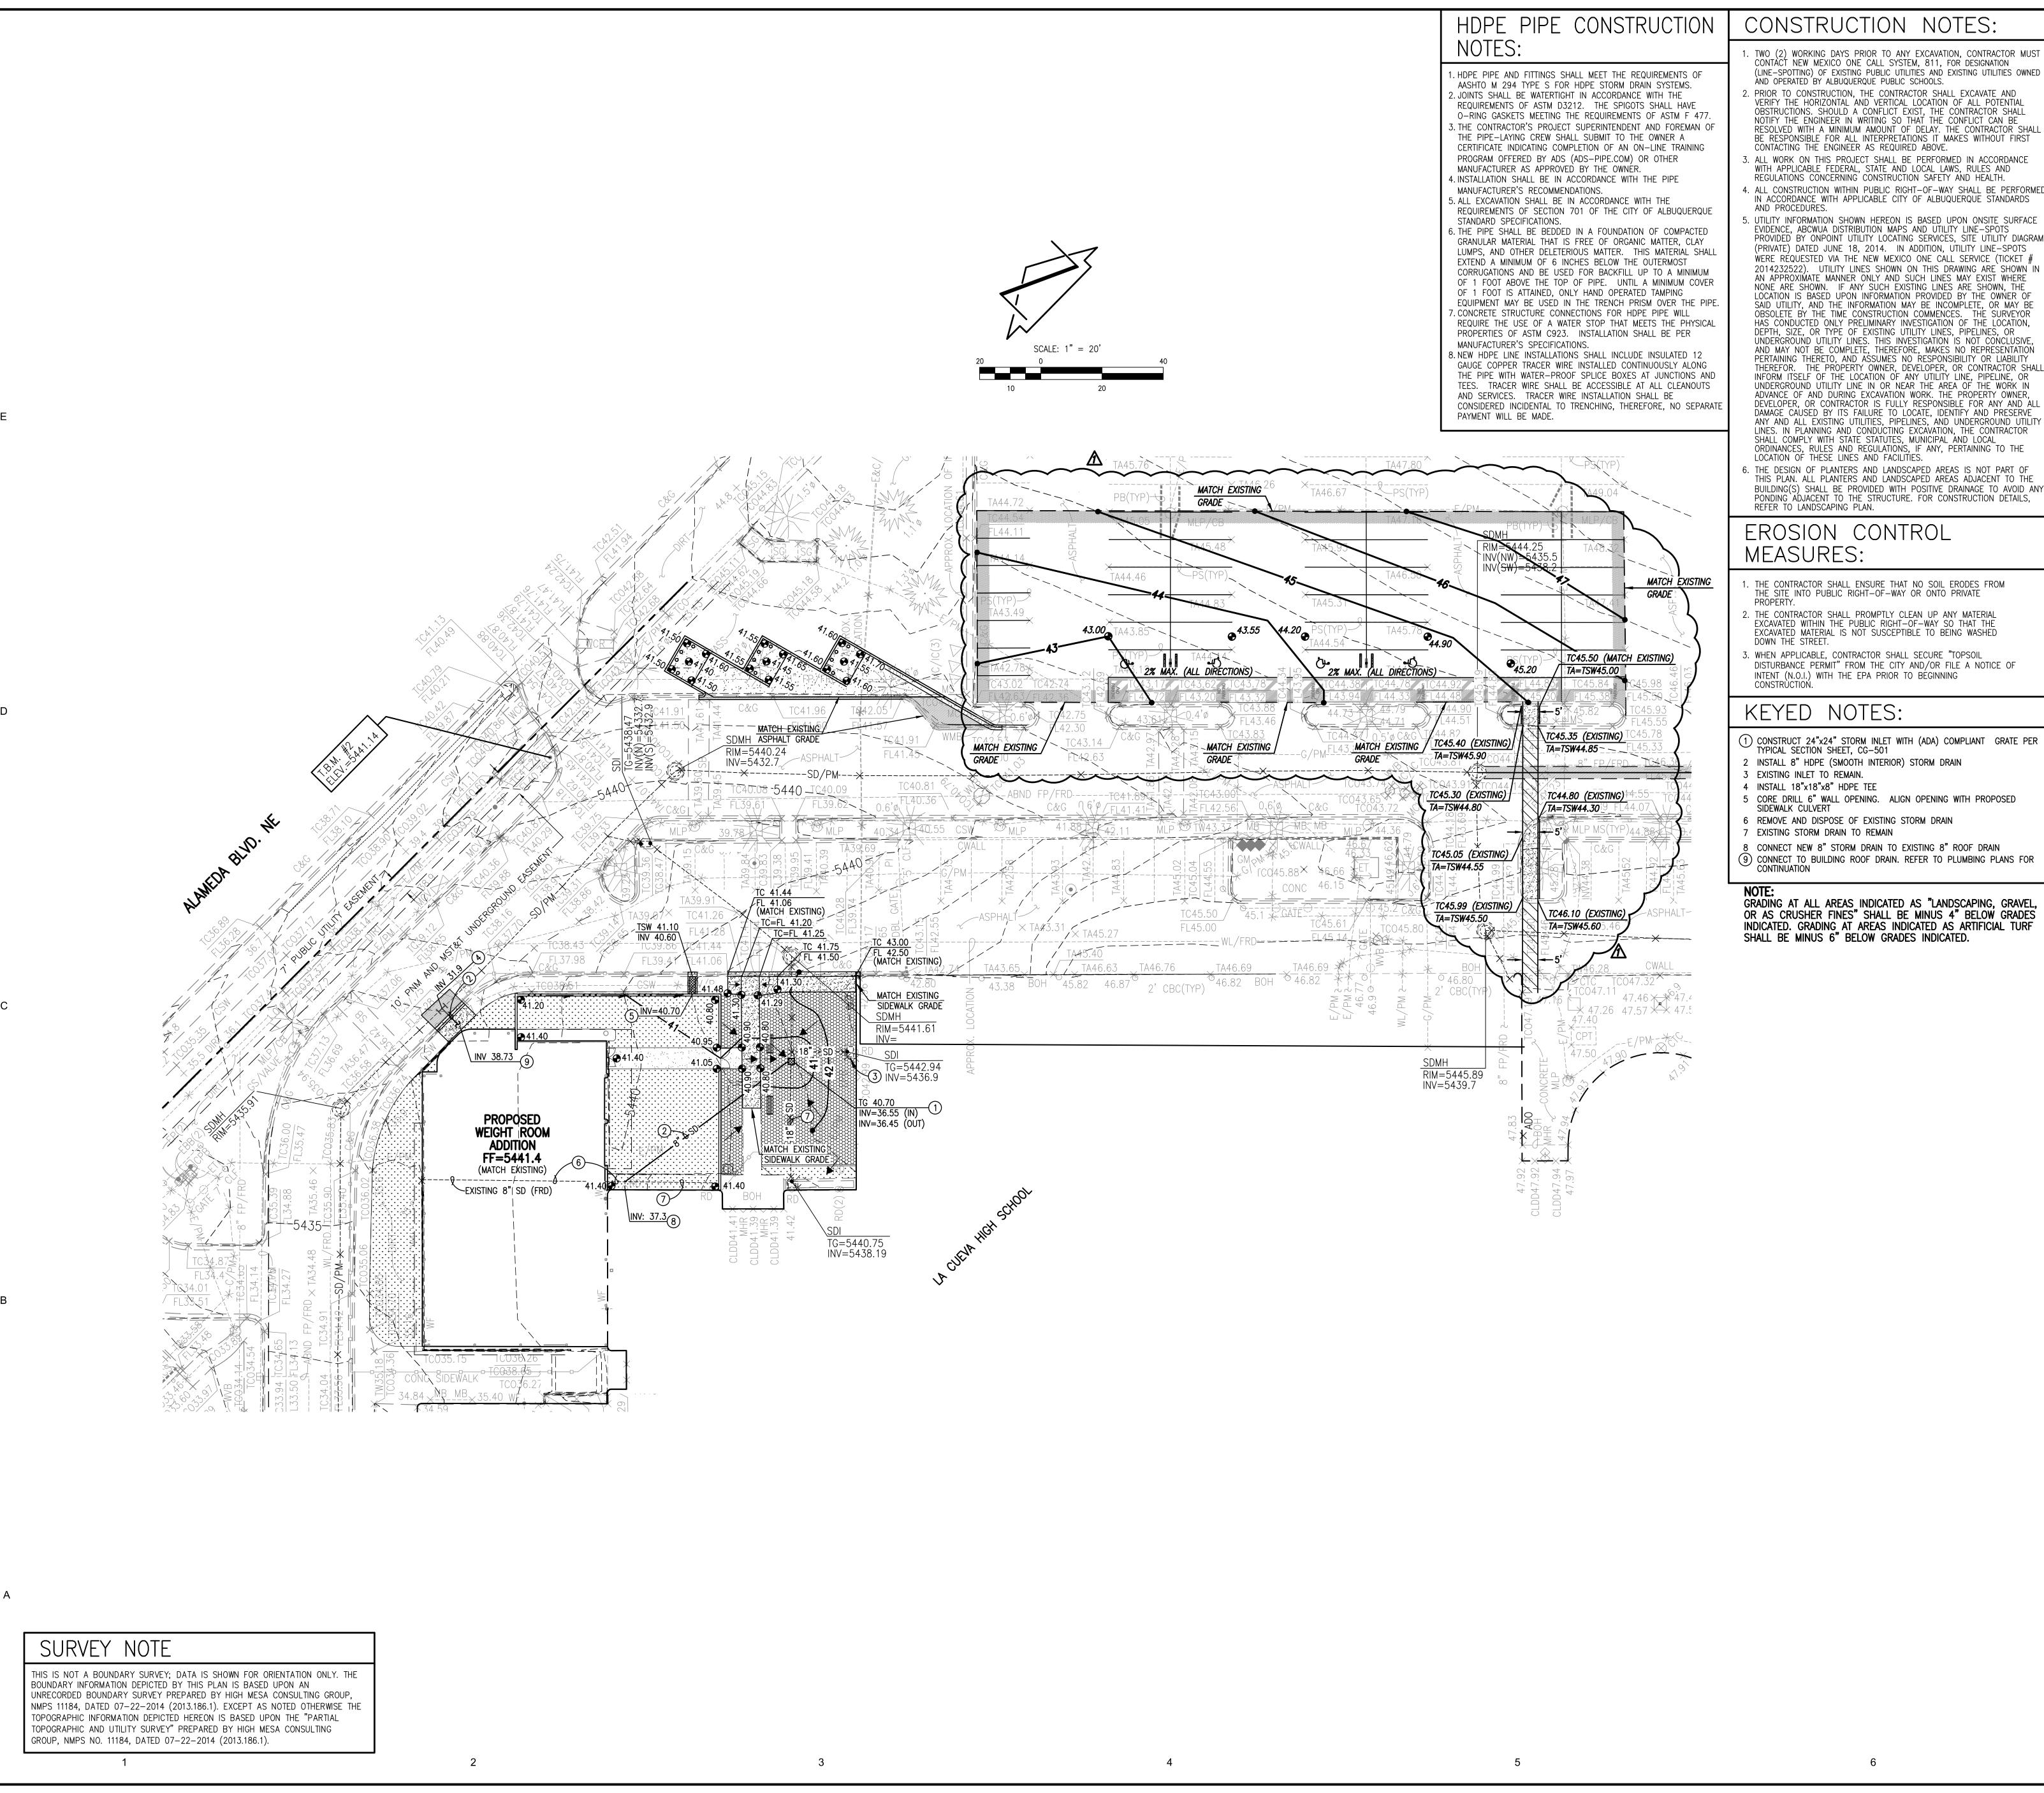

### CONSTRUCTION NOTES:

- TWO (2) WORKING DAYS PRIOR TO ANY EXCAVATION, CONTRACTOR MUST CONTACT NEW MEXICO ONE CALL SYSTEM, 811, FOR DESIGNATION (LINE-SPOTTING) OF EXISTING PUBLIC UTILITIES AND EXISTING UTILITIES OWNED ÀND OPERATED BY ALBUQUERQUE PUBLIC SCHOOLS. PRIOR TO CONSTRUCTION, THE CONTRACTOR SHALL EXCAVATE AND VERIFY THE HORIZONTAL AND VERTICAL LOCATION OF ALL POTENTIAL OBSTRUCTIONS. SHOULD A CONFLICT EXIST, THE CONTRACTOR SHALL NOTIFY THE ENGINEER IN WRITING SO THAT THE CONFLICT CAN BE RESOLVED WITH A MINIMUM AMOUNT OF DELAY. THE CONTRACTOR SHALL BE RESPONSIBLE FOR ALL INTERPRETATIONS IT MAKES WITHOUT FIRST CONTACTING THE ENGINEER AS REQUIRED ABOVE.
- ALL WORK ON THIS PROJECT SHALL BE PERFORMED IN ACCORDANCE WITH APPLICABLE FEDERAL, STATE AND LOCAL LAWS, RULES AND REGULATIONS CONCERNING CONSTRUCTION SAFETY AND HEALTH. . ALL CONSTRUCTION WITHIN PUBLIC RIGHT-OF-WAY SHALL BE PERFORMED IN ACCORDANCE WITH APPLICABLE CITY OF ALBUQUERQUE STANDARDS
- UTILITY INFORMATION SHOWN HEREON IS BASED UPON ONSITE SURFACE EVIDENCE, ABCWUA DISTRIBUTION MAPS AND UTILITY LINE—SPOTS PROVIDED BY ONPOINT UTILITY LOCATING SERVICES, SITE UTILITY DIAGRAM (PRIVATE) DATED JUNE 18, 2014. IN ADDITION, UTILITY LINE-SPOTS WERE REQUESTED VIA THE NEW MEXICO ONE CALL SERVICE (TICKET # 2014232522). UTILITY LINES SHOWN ON THIS DRAWING ARE SHOWN II AN APPROXIMATE MANNER ONLY AND SUCH LINES MAY EXIST WHERE NONE ARE SHOWN. IF ANY SUCH EXISTING LINES ARE SHOWN, TH LOCATION IS BASED UPON INFORMATION PROVIDED BY THE OWNER O SAID UTILITY, AND THE INFORMATION MAY BE INCOMPLETE, OR MAY B OBSOLETE BY THE TIME CONSTRUCTION COMMENCES. THE SURVEYOR HAS CONDUCTED ONLY PRELIMINARY INVESTIGATION OF THE LOCATION, DEPTH, SIZE, OR TYPE OF EXISTING UTILITY LINES, PIPELINES, OR UNDERGROUND UTILITY LINES. THIS INVESTIGATION IS NOT CONCLUSIVE, AND MAY NOT BE COMPLETE, THEREFORE, MAKES NO REPRESENTATION DEPTAMBLE THE PROPERTY OF THE PROPERT PERTAINING THERETO, AND ASSUMES NO RESPONSIBILITY OR LIABILITY THEREFOR. THE PROPERTY OWNER, DEVELOPER, OR CONTRACTOR SHALL INFORM ITSELF OF THE LOCATION OF ANY UTILITY LINE, PIPELINE, OR UNDERGROUND UTILITY LINE IN OR NEAR THE AREA OF THE WORK IN ADVANCE OF AND DURING EXCAVATION WORK. THE PROPERTY OWNER, DEVELOPER, OR CONTRACTOR IS FULLY RESPONSIBLE FOR ANY AND ALL
- LINES. IN PLANNING AND CONDUCTING EXCAVATION, THE CONTRACTOR SHALL COMPLY WITH STATE STATUTES, MUNICIPAL AND LOCAL ORDINANCES, RULES AND REGULATIONS, IF ANY, PERTAINING TO THE LOCATION OF THESE LINES AND FACILITIES. THE DESIGN OF PLANTERS AND LANDSCAPED AREAS IS NOT PART OF THIS PLAN. ALL PLANTERS AND LANDSCAPED AREAS ADJACENT TO THE BUILDING(S) SHALL BE PROVIDED WITH POSITIVE DRAINAGE TO AVOID ANY PONDING ADJACENT TO THE STRUCTURE. FOR CONSTRUCTION DETAILS,

## EROSION CONTROL

- THE CONTRACTOR SHALL ENSURE THAT NO SOIL ERODES FROM THE SITE INTO PUBLIC RIGHT-OF-WAY OR ONTO PRIVATE
- THE CONTRACTOR SHALL PROMPTLY CLEAN UP ANY MATERIAL EXCAVATED WITHIN THE PUBLIC RIGHT-OF-WAY SO THAT THE EXCAVATED MATERIAL IS NOT SUSCEPTIBLE TO BEING WASHED
- . WHEN APPLICABLE, CONTRACTOR SHALL SECURE "TOPSOIL DISTURBANCE PERMIT" FROM THE CITY AND/OR FILE A NOTICE OF INTENT (N.O.I.) WITH THE EPA PRIOR TO BEGINNING

- 1) CONSTRUCT 24"x24" STORM INLET WITH (ADA) COMPLIANT GRATE PER TYPICAL SECTION SHEET, CG-501 INSTALL 8" HDPE (SMOOTH INTERIOR) STORM DRAIN
- INSTALL 18"x18"x8" HDPE TEE CORE DRILL 6" WALL OPENING. ALIGN OPENING WITH PROPOSED SIDEWALK CULVERT
- REMOVE AND DISPOSE OF EXISTING STORM DRAIN 7 EXISTING STORM DRAIN TO REMAIN
- CONNECT NEW 8" STORM DRAIN TO EXISTING 8" ROOF DRAIN CONNECT TO BUILDING ROOF DRAIN. REFER TO PLUMBING PLANS FOR CONTINUATION

### GRADING AT ALL AREAS INDICATED AS "LANDSCAPING, GRAVEL, OR AS CRUSHER FINES" SHALL BE MINUS 4" BELOW GRADES INDICATED. GRADING AT AREAS INDICATED AS ARTIFICIAL TURF



RMKM ARCHITECTURE, P.C. 400 GOLD AVE SW STUDIO 1100 ALBUQUERQUE, NM 87102 505.243.5454



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⚠ 06/28 RJC ADDENDUM #4

APS LA CUEVA ISP & WEIGHT ROOM -

**RENOVATIONS &** 

**ADDITIONS** 

7801 WILSHIRE AVE NE ALBUQUERQUE, NM 87122

GRADING PLAN WEIGHT ROOM ADDITION

DOCUMENTS SHEET NUMBER

100% CONSTRUCTION

CG-101-B

05-23-2016 06-28-2016

DATE JUNE 6TH, 2016

J.Y.R./S.C.C./R.J.C.

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