
CITY OF ALBUQUERQUE

Planning Department Alan Varela, Director

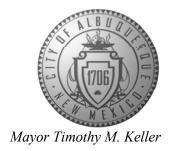

January 24, 2023

Åsa Nilsson-Weber, P.E. Isaacson & Arfman, P.A. 128 Monroe St. N.E Albuquerque, NM 87108

RE: 8701 Signal Ave. NE

Grading & Drainage Plan

Engineer's Stamp Date: 01/16/23

Hydrology File: C20D064B

Dear Ms. Nilsson-Weber:

PO Box 1293

Based upon the information provided in your submittal received 01/17/2023, the Grading and Drainage Plan is approved for Building Permit and Grading Permit. Since this project has already been mass graded, a pad certification is not needed for this project. Please attach a copy of this approved plan in the construction sets for Building Permit processing along with a copy of this letter.

Albuquerque

PRIOR TO CERTIFICATE OF OCCUPANCY:

NM 87103

1. Engineer's Certification, per the DPM Part 6-14 (F): Engineer's Certification Checklist For Non-Subdivision is required.

www.cabq.gov

If you have any questions, please contact me at 924-3995 or rbrissette@cabq.gov.

Sincerely,

Renée C. Brissette, P.E. CFM Senior Engineer, Hydrology

Renée C. Brissette

Planning Department




City of Albuquerque

Planning Department

Development & Building Services Division

DRAINAGE AND TRANSPORTATION INFORMATION SHEET

Project Title: Lot 7, Hope Plaza	Building Permit #	Hydrology File # <u>C20-D0</u> 64A	
DRB#	EPC#		
Legal Description: Lot 7 - Plat of Lots 7 and	d 8 and City Addre	ess OR Parcel UPC# 10200641213212022	
Tract B-1-A1 Hope Plaz			
Applicant/Agent: Isaacson & Arfman, Ir	IC. Contact: /	Åsa Nilsson-Weber	
Address: 128 Monroe St., NE	Phone:	505-268-8828	
Email: asaw@iacivil.com			
Applicant/Owner: Las Ventanas NM, Ir	1C. Contact:	T. Scott Ashcraft	
Address: 8330 Washington Pl., NE, Abq.	NM 87113 Phone:	505-362-6824	
Email: tscott@lasventanasnm.com			
TYPE OF DEVELOPMENT:PLAT (#of l	ots) X RESIDENCE	DRB SITE ADMIN SITE:	
RE-SUBMITTAL: YES X NO	· —		
DEPARTMENT: TRANSPORTATION	ON X HYDROLOG	Y/DRAINAGE	
Check all that apply:			
TYPE OF SUBMITTAL:		VAL/ACCEPTANCE SOUGHT:	
ENGINEER/ARCHITECT CERTIFICATION		IG PERMIT APPROVAL	
PAD CERTIFICATION		CATE OF OCCUPANCY	
CONCEPTUAL G&D PLAN		TUAL TCL DRB APPROVAL	
X GRADING PLAN		NARY PLAT APPROVAL	
DRAINAGE REPORT	SITE PLA	SITE PLAN FOR SUB'D APPROVAL	
DRAINAGE MASTER PLAN	SITE PLA	SITE PLAN FOR BLDG PERMIT APPROVAL	
FLOOD PLAN DEVELOPMENT PERMIT A	.PPFINAL P	LAT APPROVAL	
ELEVATION CERTIFICATE	SIA/REL	EASE OF FINANCIAL GUARANTEE	
CLOMR/LOMR	FOUNDA	ATION PERMIT APPROVAL	
TRAFFIC CIRCULATION LAYOUT (TCL)	GRADIN	GRADING PERMIT APPROVAL	
ADMINISTRATIVE	SO-19 AF	PPROVAL	
TRAFFIC CIRCULATION LAYOUT FOR D	RBPAVING	PERMIT APPROVAL	
APPROVAL	GRADIN	G PAD CERTIFICATION	
TRAFFIC IMPACT STUDY (TIS)	WORK C	RDER APPROVAL	
STREET LIGHT LAYOUT	CLOMR/		
OTHER (SPECIFY)		PLAN DEVELOPMENT PERMIT	
PRE-DESIGN MEETING?	OTHER (SPECIFY)	
DATE SUBMITTED: 01/16/2023			

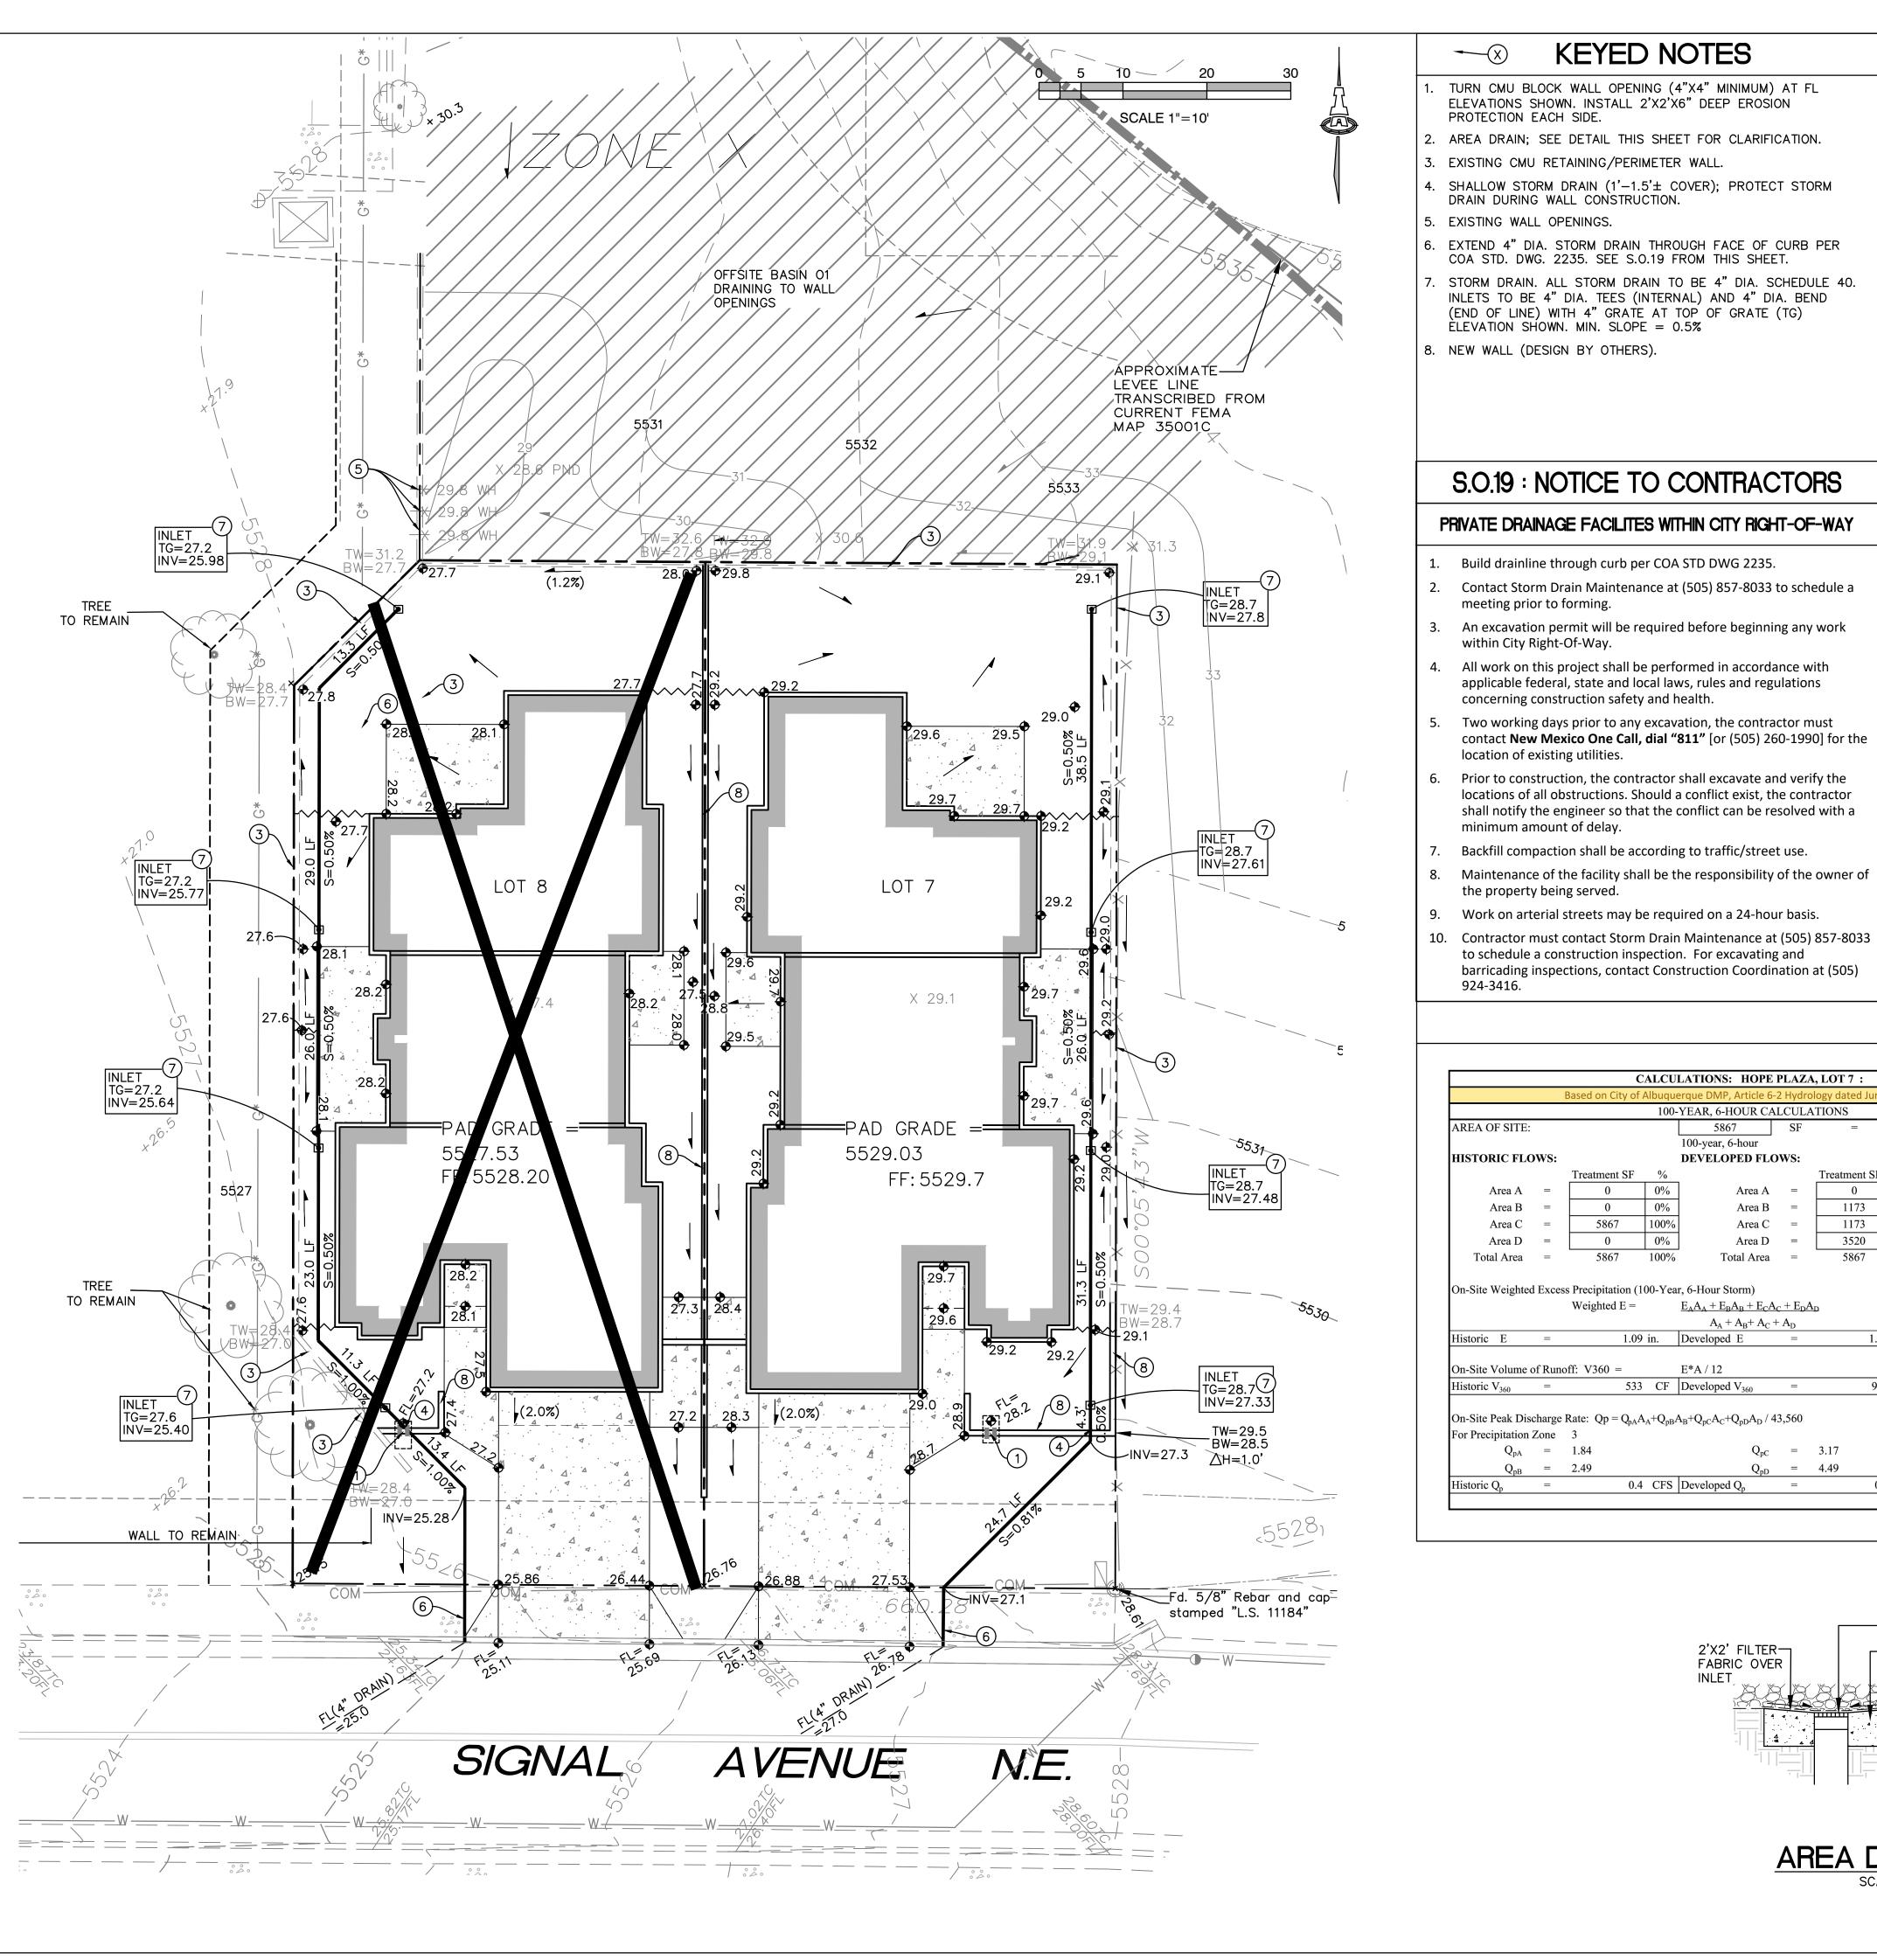

KEYED NOTES

- TURN CMU BLOCK WALL OPENING (4"X4" MINIMUM) AT FL ELEVATIONS SHOWN. INSTALL 2'X2'X6" DEEP EROSION PROTECTION EACH SIDE.
- 2. AREA DRAIN; SEE DETAIL THIS SHEET FOR CLARIFICATION.
- 3. EXISTING CMU RETAINING/PERIMETER WALL. 4. SHALLOW STORM DRAIN (1'-1.5'± COVER); PROTECT STORM
- 5. EXISTING WALL OPENINGS.
- 6. EXTEND 4" DIA. STORM DRAIN THROUGH FACE OF CURB PER
- STORM DRAIN. ALL STORM DRAIN TO BE 4" DIA. SCHEDULE 40. INLETS TO BE 4" DIA. TEES (INTERNAL) AND 4" DIA. BEND (END OF LINE) WITH 4" GRATE AT TOP OF GRATE (TG) ÈLEVATION SHOWN. MIN. SLOPE = 0.5%
- 8. NEW WALL (DESIGN BY OTHERS).

PROJECT INFORMATION

PROPERTY: THE SITE IS AN UNDEVELOPED RESIDENTIAL PROPERTY LOCATED WITHIN C.O.A. VICINITY MAP C-20. THE SITE IS BOUND TO THE EAST AND NORTH BY UNDEVELOPED PROPERTY, TO THE WEST BY HOPE IN THE DESERT EPISCOPAL CHURCH., AND TO THE SOUTH BY SIGNAL AVE. NE.

PROPOSED IMPROVEMENTS: A RESIDENTIAL PROPERTY.

LEGAL: LOT 7, HOPE PLAZA, CITY OF ALBUQUERQUE, BERNALILLO COUNTY, NEW MEXICO

BENCHMARK: VERTICAL DATUM IS BASED UPON THE ALBUQUERQUE CONTROL SURVEY MONUMENT "7-C19", ELEVATION = 5485.723 FEET (NAVD 1988).

OFF-SITE: A MINOR BASIN (Q100=0.4 CFS) HAS BEEN ROUTED THROUGH THE CHURCH PROPERTY ON THE NORTH SIDE OF THE

FLOOD HAZARD: PER BERNALILLO COUNTY FIRM MAP #C5001, THE SITE IS LOCATED WITHIN FLOODZONE 'X' DESIGNATED AS AREAS DETERMINED TO BE OUTSIDE 500-YEAR FLOODPLAIN.

DRAINAGE PLAN CONCEPT: STORM DRAIN AND SURFACE FLOW TO DISCHARGE FREELY ONTO SIGNAL AVENUE PER THE APPROVED CONCEPTUAL PLAN.

THIS PROPERTY WAS LAST ADDRESSED AS PART OF THE 2014 APPROVED, AMENDED PRELIMINARY GRADING PLAN (REV.2).

100 (139 -SITE 1"=750'±_ ILE SCHOOL C-20-Z

VICINITY MAP

A. FINAL GRADES SHOWN REPRESENT TOP OF FINISH MATERIAL (I.E. TOP OF CONCRETE, TOP OF CONCRETE BUILDING PAD. TOP OF PAVEMENT MATERIAL, TOP OF LANDSCAPING MATERIAL, ETC.). CONTRACTOR SHALL GRADE, COMPACT SUBGRADE AND DETERMINE EARTHWORK ESTIMATES BASED ON

ELEVATIONS SHOWN MINUS FINISH MATERIAL THICKNESSES.

GENERAL NOTES

- B. CONTRACTOR SHALL CONTACT NM-811 FOR UTILITY LINE SPOTS TWO WORKING DAYS PRIOR TO CONDUCTING SITE FIELD WORK. CONTRACTOR SHALL FIELD VERIFY AND LOCATE ALL UTILITIES PRIOR TO COMMENCEMENT OF ANY CONSTRUCTION.
- C. THE ENVIRONMENTAL PROTECTION AGENCY (EPA) AND BERNALILLO COUNTY MAY REQUIRE AN EROSION AND SEDIMENT CONTROL (ESC) PERMIT FOR PROJECTS WHERE CONSTRUCTION ACTIVITIES MEET THE EPA THRESHOLD. IF REQUIRED, CONTRACTOR SHALL OBTAIN AND PROVIDE.
- D. ALL COBBLE EROSION PROTECTION TO BE 3" AVG. DIA. (2"-4") ANGULAR FACED ROCK PLACED OVER GEOTEX C501 NON-WOVEN GEOTEXTILE (O.E.).
- E. ENGINEER RECOMMENDS THAT OWNER MAINTAIN EROSION PROTECTION ELEMENTS. ENGINEER RECOMMENDS THAT OWNER INSPECT SITE YEARLY AND AFTER EACH RAINFALL TO IDENTIFY NEW AREAS OF EROSION AND INSTALL ADDITIONAL EROSION PROTECTION AS NEEDED BASED ON ACTUAL OCCURRENCES.

LEGEND

- — PROPERTY LINE EXISTING SPOT ELEVATION -5531 EXISTING CONTOUR ♦29.0 PROPOSED SPOT ELEVATION

INVERT

- TOP OF GRATE
- INV.=

SURFACE FLOW DIRECTION EROSION CONTROL ===== EXST PERIMETER WALL PROPOSED CONCRETE PAD

Engineer


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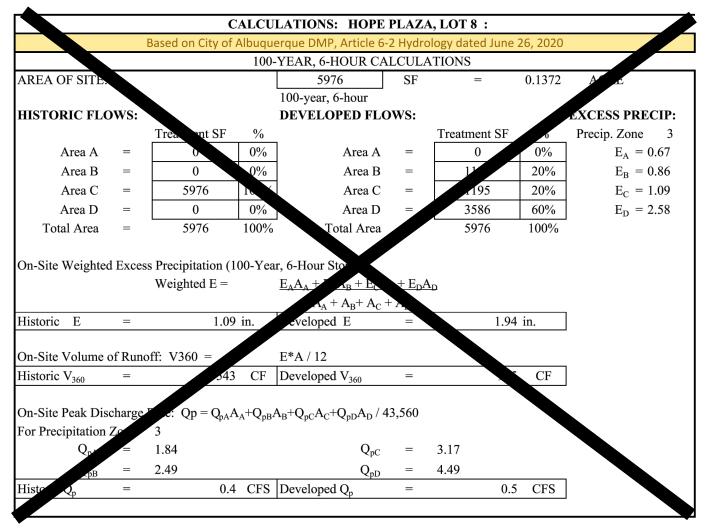
OPE


LOT 7

STORM SEWER DESIGN **INFORMATION**

CALCULATIONS



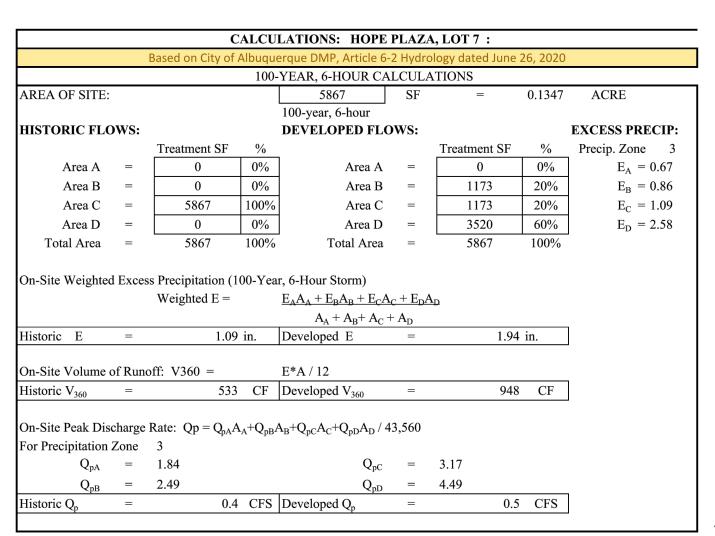

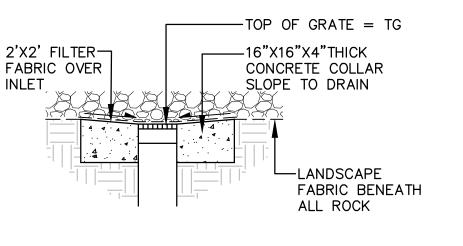

AREA DRAIN SCALE: 1"=5'

HYDROLOGY SECTION **APPROVED**

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SHEET TITLE

GRADING & DRAINAGE PLAN

SHEET NUMBER

C-101