CITY OF ALBUQUERQUE

Planning Department Brennon Williams, Acting Director



Mayor Timothy M. Keller

July 10, 2019

Mark Goodwin, P.E. Mark Goodwin & Associates PO Box 90606 Albuquerque, NM 87199

RE: Swim Labs 8110 Holly Ave NE Grading Plan Stamp Date: 6/24/19 Hydrology File: C20D082

Dear Mr. Goodwin:

| PO Box 1293 | | used on the submittal received on 6/25/19, the grading and drainage plan cannot be approved til the following are corrected: |
|---------------|----|---|
| A llauguagene | 1. | Provide proposed contours and proposed spot elevation in sufficient density to ascertain the proposed drainage pattern of the site. |
| Albuquerque | 2. | A waterblock is likely required near the north driveway to ensure flows are routed to the tract B pond. |
| NM 87103 | 3. | Subbasins need to be delineated and modeled in AHYMO or with the 40-acres-or-less method and must include all onsite drainage and upstream offsite flows. |
| www.cabq.gov | 4. | The drainage plan must address all onsite drainage and upstream offsite drainage, not just the parking lot and building. |
| | 5. | Remove the temporary markings from the tract B stormwater quality pond; these features are permanent and will need to be protected with a drainage covenant, signed by the underlying property owner. |
| | 6. | Provide written and signed permission from the owner of Tract B for the grading, paving and pond construction on their property. |
| | 7. | Provide project datum. |
| | 8. | The complete AHYMO input and output files need to be provided, not just the summary. If you provide these separately, they must be bound and stamped by the engineer. |
| | | |

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- 9. With AHYMO S4, be sure to use NOAA Atlas 14 precipitation depths in conjunction with the NOAA Atlas 14 distribution. Include the location map and tables obtained from the NOAA website. Using the NOAA Atlas 2 Precipitation depths (Found in the DPM), with the NOAA Atlas 14 Distributions results in an over-prediction of peak runoff (Q_{100}). See <u>AHYMO AppNote-01</u>, and the Hydrology website for more information regarding this.
- 10. The outfall for pond B is unclear. The AHYMO run seems to indicate a continuous outflow, but the obvious outfall is the drive entrance that has a crest elevation at 54.12'. The City does not accept infiltration as an outfall or credit it in pond sizing as pond bottoms generally silt-in and reduce the infiltration rate to nearly nothing.
- 11. The site must demonstrate adequate downstream capacity per § 14-5-2-12(G) of the Albuquerque Code of Ordinances.
- 12. Provide the Furrs Paseo del Norte drainage report and Hydrology approval letter. This report is missing in our database and needs to be recovered if it is to be used as the basis for this development.

PO Box 1293


- 13. Provide a cross lot drainage easement (paper or Plat) between the two tracts.
- Albuquerque
 14. As a reminder, if the project total area of disturbance (including the staging area and any work within the adjacent Right-of-Way) is 1 acre or more, then an Erosion and Sediment Control (ESC) Plan and Owner's certified Notice of Intent (NOI) is required to be submitted to the Stormwater Quality Engineer (Curtis Cherne, PE, ccherne@cabq.gov, 924-3420) 14 days prior to any earth disturbance.

If you have any questions, you can contact me at 924-3695 or dpeterson@cabq.gov.


www.cabq.gov

Sincerely,

Dana Peterson, P.E. Senior Engineer, Planning Dept. Development Review Services

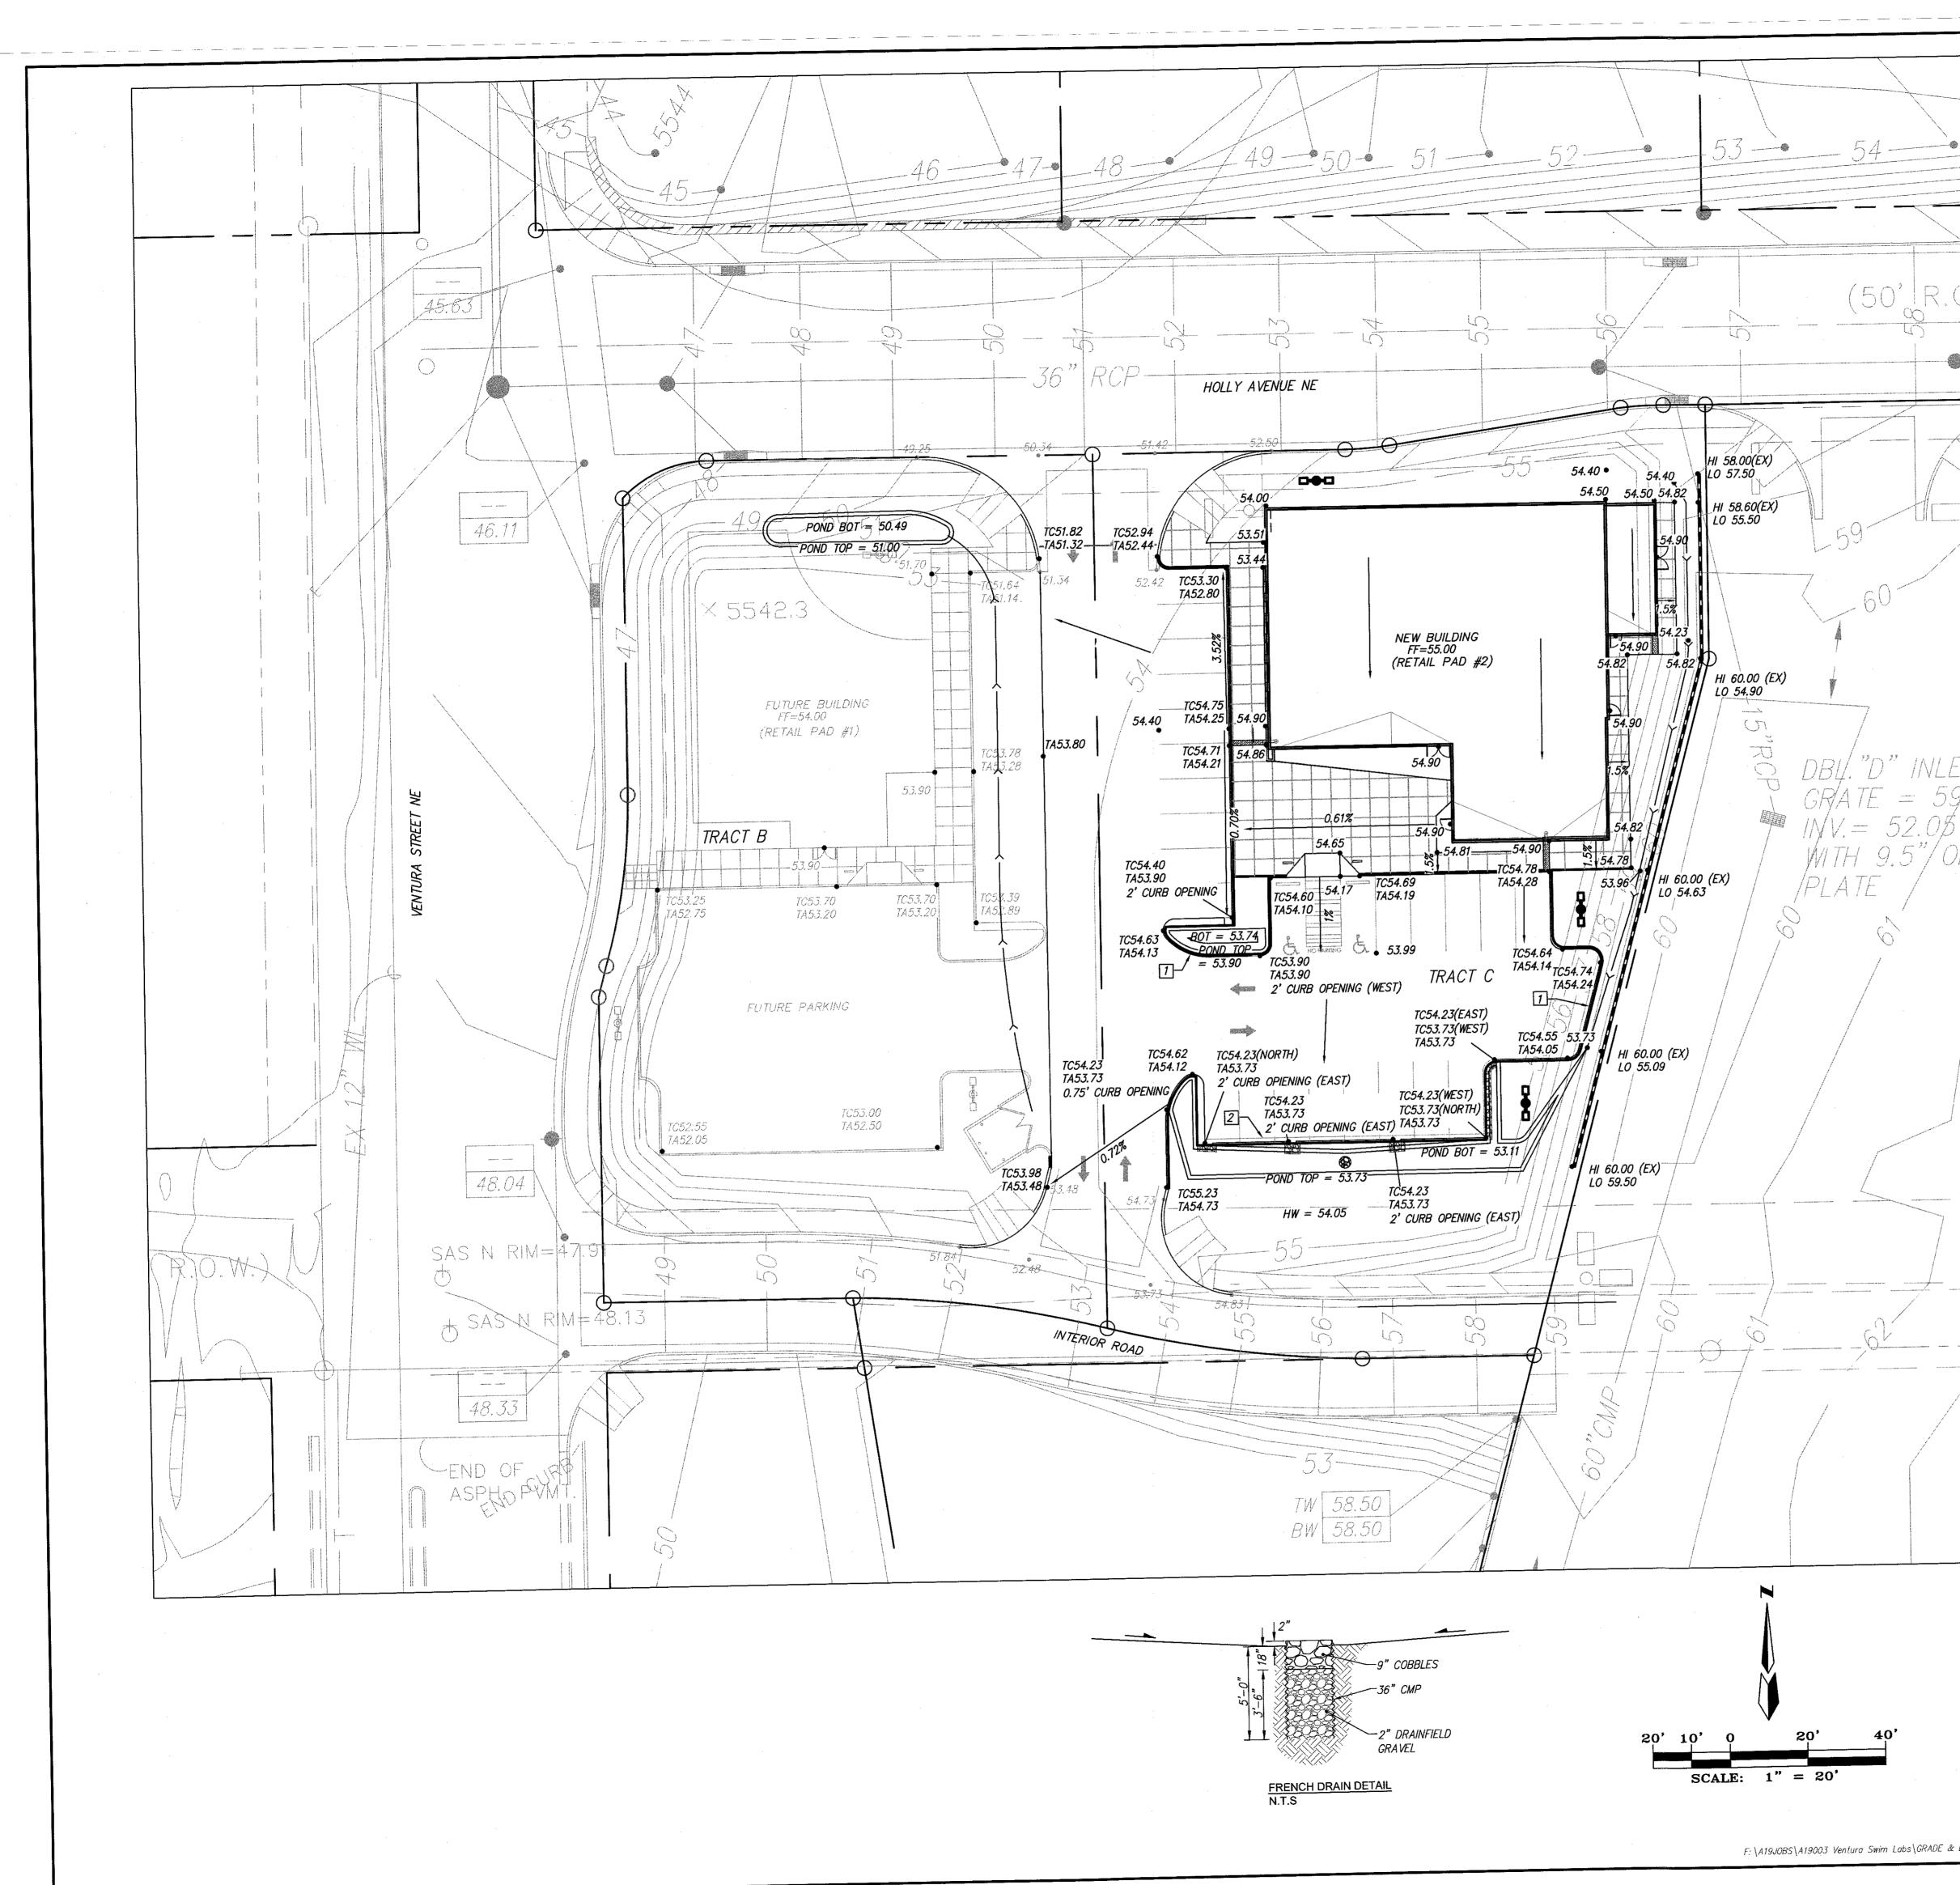

| | LEGAL DESCRIPTION |
|---|---|
| | TRACT C BLOCK 19 NORTH ALBUQUERQUE ACRES TRACT 3, UNIT 3 CITY OF ALBUQUERQUE |
| | BERNALILLO COUNTY, NEW MEXICO |
| | ACS BENCHMARK THE STATION MARK IS A STANDARD ACS BRASS TABLET STAMPED "-C21A-1978" |
| | THE STATION MARK IS A STANDARD HOS DIRIGO DROUD. TO REACH THE STATION SET IN TOP OF A CONCRETE POST FLUSH WITH GROUND. TO REACH THE STATION FROM THE INTERCHANGE AT I-25 AND SAN MATEO BLVD. N.E., GO NORTH ON THE EAST FRONTAGE ROAD FOR 1.5 MILES TO PASEO DEL NORTE. TURN RIGHT, GO EAST ON PASEO DEL NORTE 2.8 MILES TO THE STATION ON THE LEFT. X=415,503.35 Y=1,518,787.29 Z=5634.65 |
| \bigcirc . | GENERAL NOTES |
| | 1. CONTRACTOR MUST OBTAIN A TOPSOIL DISTURBANCE PERMIT FROM THE ENVIRONMENTAL HEALTH DIVISION PRIOR TO CONSTRUCTION. |
| | 2. CITY OF ALBUQUERQUE STANDARD SPECIFICATIONS FOR PUBLIC WORKS CONSTRUCTION, LATEST EDITION SHALL GOVERN ALL WORK. |
| | 3. THE CONTRACTOR SHALL CONFORM TO ALL CITY, COUNTY, STATE AND FEDERAL DUST CONTROL MEASURE'S AND REQUIREMENTS AND WILL BE RESPONSIBLE FOR PREPARING AND OBTAINING ALL NECESSARY APPLICATIONS AND APPROVALS. |
| | 4. THE CONTRACTOR SHALL ENSURE THAT NO SOIL ERODES FROM THE LOTS INTO PUBLIC RIGHT—OF—WAY. THIS CAN BE ACHIEVED BY CONSTRUCTING TEMPORARY BERMS AND WETTING THE SOIL TO KEEP IT FROM BLOWING |
| | 5. THE EARTHWORK CONTRACTOR SHALL STOCKPILE ENOUGH MATERIAL ADJACENT TO RETAINING WALL LOCATIONS TO BE UTILIZED FOR WALL BACKFILL. |
| | 6. NO WORK ALLOWED IN THE PUBLIC RIGHT OF WAY WITHOUT AN APPROVED WORK ORDER. |
| | |
| | LEGEND |
| | RETAINING WALL |
| | <i>DRAINAGE SWALE</i> |
| RIA | 54.90 SPOT ELEVATION HIGH SIDE, LOW SIDE OF |
| | HI 61.00 (EX) LO 53.60 TOP OF CURB, TOP OF |
| | TC54.78 ASPHALT SPOT TA54.28 |
| | FRENCH DRAIN -SEE DETAIL |
| | APPENDENTE MINUS CLEAN GRAVEL 12" SIDEWALK CULVERT PER COA STD DWG 2236 |
| | PER COA SID Ding 2200 |
| | |
| | 1. HEADER CURB PER COA STD DWG 2415B |
| | 2. MEDIAN CURB & GUTTER PER COA STD DWG 2415B |
| | |
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| | |
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| | |
| | NARK GOODING |
| | F 89487 |
| | 1 1 19 19 |
| | |
| | SWIM LABS |
| UNDERGROUND UTILITIES CAUTION: | GRADING & DRAINAGE |
| NOTE THAT ALL EXISTING UTILITIES MAY NOT BE SHOWN, ALL EXISTING SERVICE CONNECTIONS ARE | PLAN |
| NOT SHOWN. ANY EXISTING UTILITIES THAT ARE SHOWN ARE APPROXIMATE LOCATION ONLY. IT SHALL BE THE SOLE RESPONSIBILTY OF THE | MARK GOODWIN & ASSOCIATES, P.A. |
| CONTRACTOR TO CONTACT ALL THE UTILITY OWNERS AND TO CONDUCT ALL NECESSARY FIELD INVESTIGATIONS PRIOR TO ANY EXCAVATIONS | P.O. BOX 90606 |
| TO DETERMINE THE ACTUAL LOCATION OF UTILITIES AND OTHER IMPROVEMENTS. | ALBUQUERQUE, NEW MEXICO 87199 (505)828-2200, FAX (505)797-9539 |
| | Designed: CP/DMG Drawn: CP Checked: DMG Sheet CI |
| DRAIN\19003_G&D.dwg, Last saved by: Cory | Scale: 1" = 20' Date: 6/21/2019 Job: A19003 |

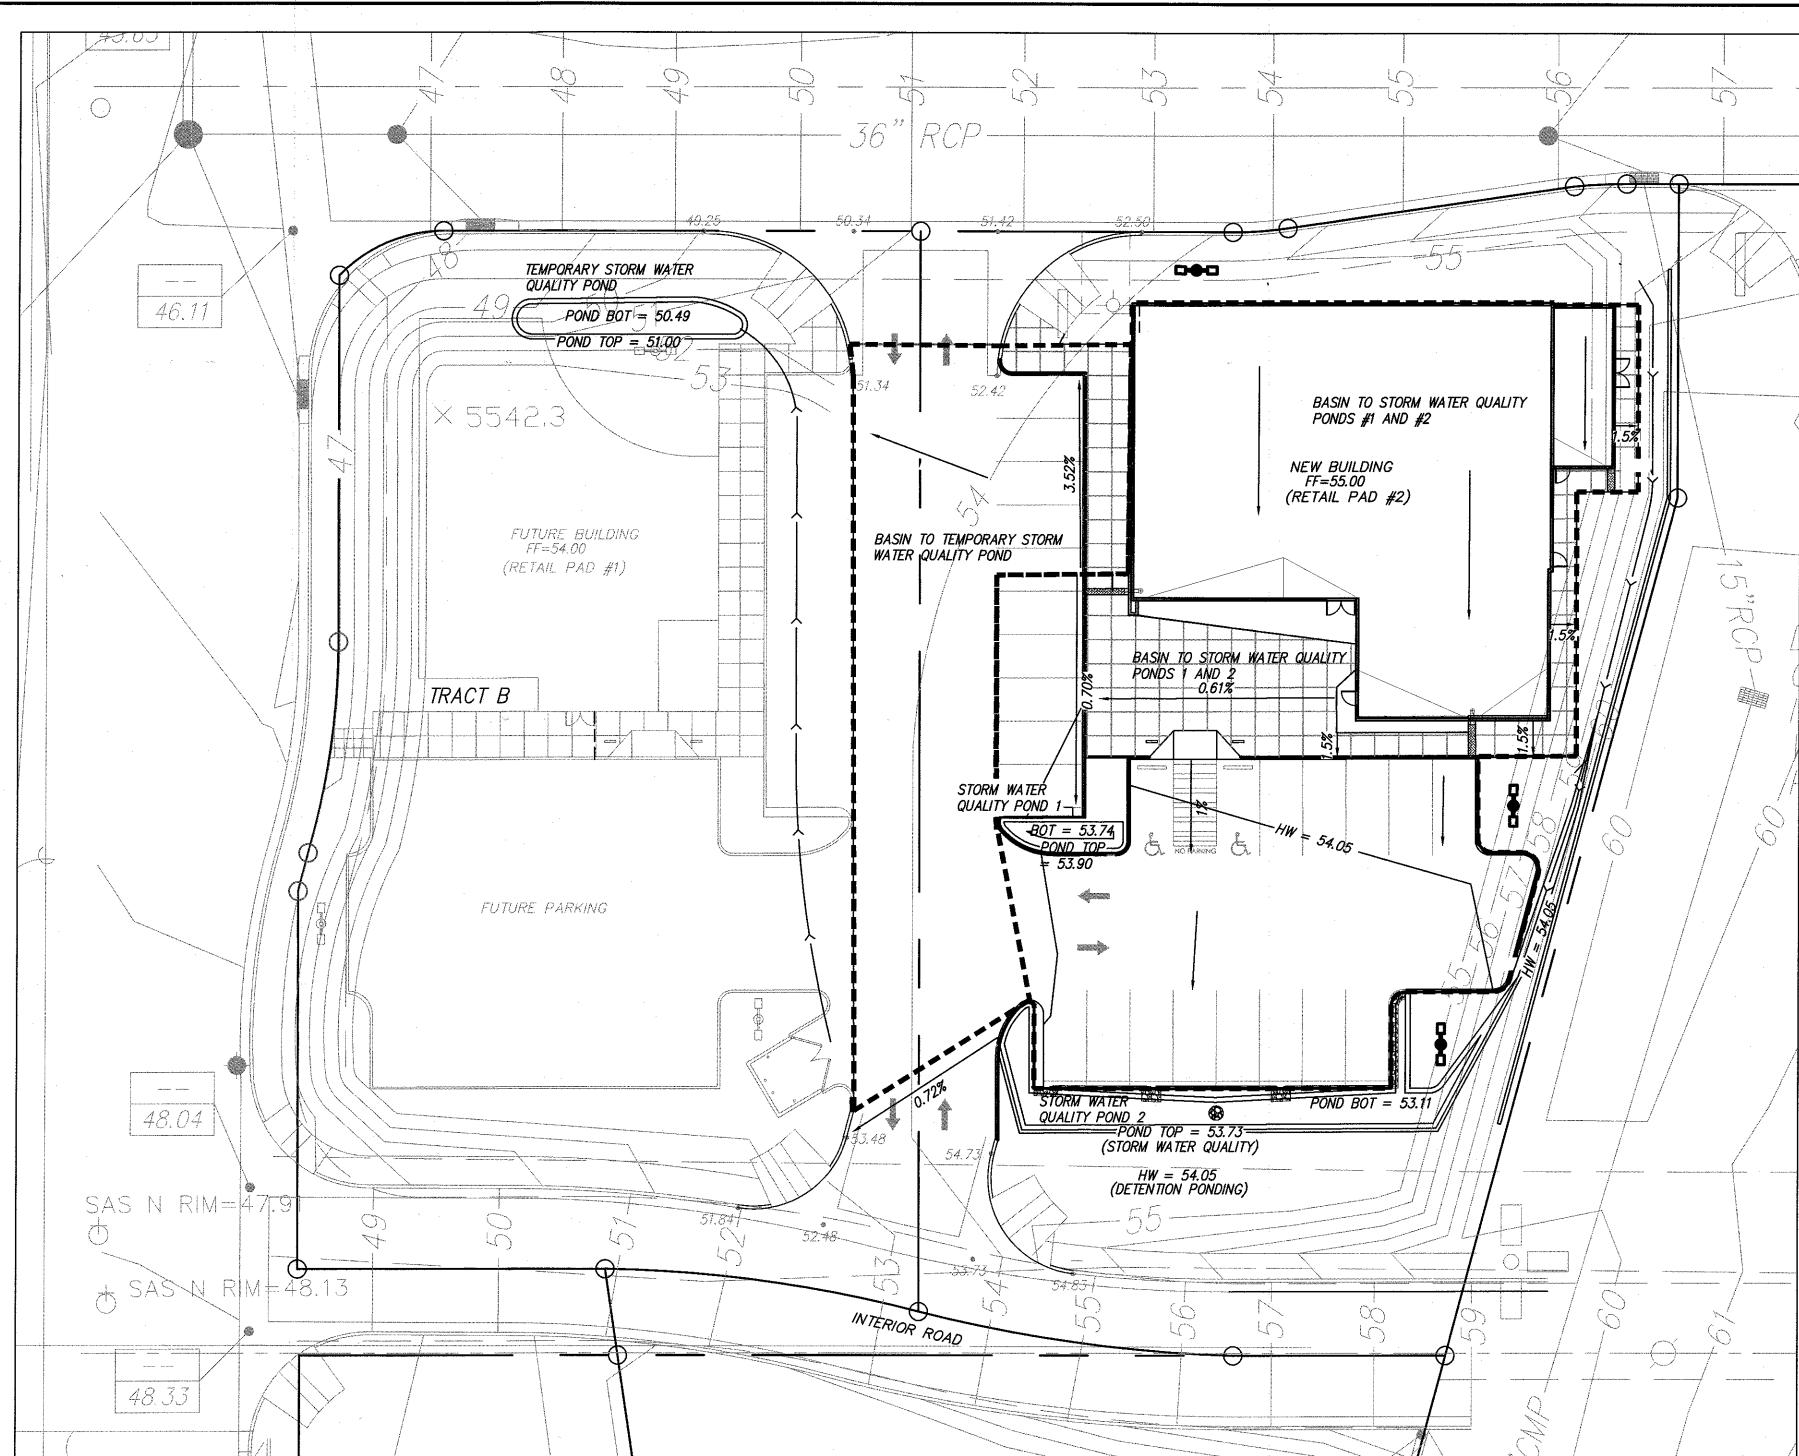

TRACT B:

TEMPORARY STORM WATER QUALITY POND

| Proposed Impervious Area (SF) | 6074 |
|---|------|
| Storm Water Quality | |
| retention depth (inches): | 0.34 |
| Required Storm Water Quality Volume (CF): | 172 |

Proposed Storm Water Quality Retention Capacity:

| Temporary Retention Pond | |
|--------------------------|------|
| Depth (FT): | 0.51 |
| Bottom (SF) | 291 |
| Top (SF) | 394 |
| Volume (CF) | 175 |

STORM WATER QUALITY:

RECENT STORM WATER QUALITY REQUIREMENTS OF THE CITY OF ALBUQUERQUE RESULT IN CAPTURE OF 0.34 INCHES OF RAINFALL OVER IMPERVIOUS SURFACES.

THE REQUIRED STORM WATER QUALITY VOLUME IS FULLY CAPTURED WITHIN THE TEMPORARY TRACT B STORM WATER QUALITY POND AND THE TWO TRACT C STORM WATER QUALITY PONDS. ON TRACT C, WATER SHED FLOWS TO STORM WATER QUALITY POND #1 AND OVERFLOWS TO THE SIGNIFICANTLY LARGER STORM WATER QUALITY POND #2.

THE FRENCH DRAIN IS A FEATURE OF THE DESIGN TO HASTEN INFILTRATION WITHIN STORM WATER QUALITY POND #2 WHEN RUNOFF IS CAPTURED FROM STORM EVENTS.

TRACT C STORM WATER QUALITY PONDS ARE TO BE PERMANENT WITH THIS DEVELOPMENT AND TRACT B STORM WATER QUALITY POND IS TEMPORARY. THE CONTRIBUTING BASIN OF IMPERVIOUS AREA TO TRACT B TEMPORARY STORM WATER QUALITY POND OCCUPIES PORTIONS OF BOTH TRACT B AND TRACT C.

TRACT C: PONDS 1 AN

Proposed Impervi Storm Water Qua retention depth Required Storm V

POND 1 Depth (FT): Bottom (SF) Top (SF) Volume (CF)

POND 2 Depth (FT): Bottom (SF) Top (SF) Volume (CF)

| N | D | 2 | |
|---|---|---|--|
| | | | |

| vious Area (SF) | 17101 |
|----------------------------|-------|
| ality | |
| (inches): | 0.34 |
| Water Quality Volume (CF): | 485 |
| | : |
| | |
| | 0.16 |
| | 24 |
| | 121 |
| | 12 |
| | |
| | 0.62 |
| | 619 |
| | 926 |
| | 479 |
| | |

DRAINAGE REPORT

THE SITE IS WITHIN THE FURRS PASED DEL NORTE PROJECT (ADDENDUM STAMP DATE 11/27/00, GREGORY JAMES KRENIK, D. MARK GOODWIN & ASSOCIATES). THE FURRS PASEO DEL NORTE PROJECT HAS FOUR BASINS. BASIN IX INCLUDES RETAIL PAD #1 RETAIL PAD #2. THIS PROJECT (SWIM LABS) IS RETAIL PAD #2.

THE 2000 ADDENDUM ALLOCATES 0.93 CFS FOR PAD #2 AND 0.93 CFS FOR PAD #1 (WEST OF PAD #2) OF ALLOWABLE DISCHARGE. BOTH PROPERTIES (RETAIL PAD #1 AND #2) INCLUDE A PORTION C THE INTERIOR ROAD WHICH IS INCLUDED IN BASIN II AND IS NOT INCLUDED IN THE ALLOWABLE DISCHARGE OF EACH PAD.

THE PROPOSED DESIGN FOR RETAIL PAD #2 INCLUDES CAPTURE OF 0.34" ON IMPERVIOUS AREAS TO MEET STORM WATER QUALITY REQUIREMENTS. AS SUCH THE POND ON THE SOUTH PORTION OF THE SITE RETAINS THIS VOLUME REQUIREMENT FROM ELEVATION 53 TO 53.73'. FROM ELEVATION 53.73' TO 54.05' THE POND FUNCTION AS A DETENTION POND DURING THE 100YR, 6HR STORM WITH A PL DISCHARGE OF 0.70 CFS. DISCHARGE BEGINS AFTER STORM WATER QUALITY CAPTURE AT ELEVATION 53.73' THROUGH A 9" WIDE CURE OPENING AT THE WEST END OF POND #2.

AS A PORTION OF RETAIL PAD #2 DRAINS TO RETAIL PAD #1 (BAS TO TEMPORARY TRACT B STORM WATER QUALITY POND), THE DIFFERENCE IN ALLOWABLE DISHARGE IS RE-ALLOCATED TO PAD #1 YIELDING APPROXIMATELY 1.16 CFS TOTAL (0.93+0.93-0.70).

RAINFALL WAS TAKEN FROM NOAA RAINFALL DATA AT THE LOCATIO OF THE SITE. THE RAINFALL WAS MITIGATED BY 0.34" (STORM WAT QUALITY CAPTURE) FOR INPUT INTO AHYMO. THE DISCHARGE TABL WAS MODELED BASED ON A .75' WIDE WEIR WITH WEIR COEFFICIENT OF 2.6:

| <u>ahymo_SwimLabs_Pac</u> START | 0.0 HOUI | RS PC=0 | PL=-1 | |
|------------------------------------|----------|------------|----------------|---------|
| LOCATION | ALBU | JQUERQUE | | |
| *S SWIM LABS 19003 | | | | |
| *S ONSITE PAD 2 | | | | |
| *S By Cory Pierce | | | | |
| RAINFALL | TYPE | =1 0.0 1.4 | 18 2.11 2.52 | |
| DT=0.01 | | | | |
| SEDIMENT BULK | COD | E=1 BULK | FACTOR = 1.0 | 6 |
| COMPUTE NM HYD | ID= | =3 HYD=202 | ? AREA=0.0008 | 36 SQ M |
| | AB | CD 30 0 0 | 70 | |
| | TP= | 0.13333 MA | SSRAIN=-1 | |
| PRINT HYD | ID=3 | 3 CODE=1 | | |
| ROUTE RESERVOIR | ID=S | 5 HYD NO=I | POND.OT INFL | 0W=3 |
| CODE=24 | | | | |
| | OUTFLOW | V (CFS) | STORAGE(AF) | |
| ELEV(FT) | | . , | . , | |
| | | | 0.01 | |
| 0.0001 | 55 | 553.73 | | |
| | 0.07 | .0028 | <i>5553.80</i> | |
| | 0.16 | 0.0063 | 5553. | 85 |
| | 0.30 | 0.0116 | 5553. | 91 |
| | 0.49 | 0.0194 | <i>5553</i> . | 98 |
| | 0.77 | 0.0312 | 5554. | 07 |
| | 0.99 | 0.0402 | 5554. | 13 |
| | 1.38 | 0.0484 | 5554. | 23 |
| PRINT HYD | ID=5 (| CODE 1 | | |
| FINISH | | | | |
| | | | | |

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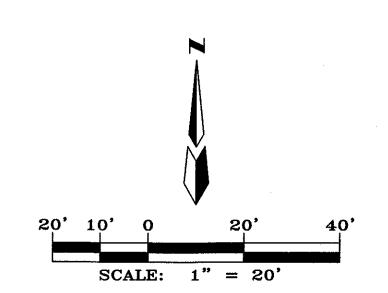
AHYMO PROGRAM SUMMARY TABLE (AHYMO-S4)

RUN DATE (MON/DAY/YR) =06/24/2019

| | | | FROM | ΤΟ | |
|---------|-----------|----------------|------|--------|---------|
| time to | ĊFS | PAGE = 1 | | | |
| | | HYDROGRAPH | ID | ID | AREA |
| RUNOFF | | PER | | | |
| COMM | IAND | IDENTIFICATION | NO. | NO. | (SQ MI) |
| (HOURS) | ACRE | ΝΟΤΑΤΙΟΝ | | | |
| STAR | Т | | | | |
| TIME= | 0.00 | | | | |
| LOCA | TION | | ALBL | JQUERQ | UE |
| *S SI | MM LABS . | 19003 | | | |
| *S 01 | ISITE PAD | 2 | | | |
| *S By | Cory Pier | ce | | | |
| RAINF | ALL TYPE | = 1 NOAA 14 | | | |
| RAIN6= | | | | | |
| SEDIM | ENT BULK | | | | |
| | ENT BULK | | | | |
| 0040 | UTE NM H | YD 202.00 | | 3 | 0.0008 |

1.530 3.079 PER IMP= 70.00 ROUTE RESERVOIR POND.OT 3 5 0.00086 1.740 1.276 AC-FT= 0.028 FINISH

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| · · · · · · · · · · · · · · · · · · · | LEGAL DESCRIPTION |
|---|--|
| | TRACT C BLOCK 19 NORTH ALBUQUERQUE ACRES TRACT 3, UNIT 3 CITY OF ALBUQUERQUE DEEDNAULU O COUNTY, NEW MEXICO |
| AND | BERNALILLO COUNTY, NEW MEXICO ACS BENCHMARK |
| 93 | THE STATION MARK IS A STANDARD ACS BRASS TABLET STAMPED "C21A-1978" SET IN TOP OF A CONCRETE POST FLUSH WITH GROUND. TO REACH THE STATION |
| I OF | FROM THE INTERCHANGE AT I-25 AND SAN MATEO BLVD. N.E., GO NORTH ON THE EAST FRONTAGE ROAD FOR 1.5 MILES TO PASEO DEL NORTE. TURN RIGHT, GO EAST ON PASEO DEL NORTE 2.8 MILES TO THE STATION ON THE LEFT. X=415,503.35 Y=1,518,787.29 Z=5634.65 |
| OF | |
| DF 53.11' TONS | VICINITY MAP (ZONE ATLAS C-20-Z) |
| PEAK ER IRB | |
| ASIN | |
| #1 | |
| TTON WATER IBLE | |
| ΝΤ | |
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| | |
| MI | |
| | |
| | DEL NORTE |
| | |
| | |
| | |
| – Ver. S4.01a, Rel: 01a | |
| mo_SwimLabs_Pad2_TOPDETEN-B_IN.txt | |
| PEAK RUNOFF | |
| DISCHARGE VOLUME (CFS) (ACFT) (INCHES) | |
| | |
| | |
| | |
| 1.69 0.069 1.51448 | |
| 0.70 0.097 2.12559 | |
| | |
| | |
| | NARK 6000 Minute |
| | |
| | 1/19 Manual Start SSIONAL SSIO |
| | SWIM LABS |
| | GRADING & DRAINAGE PLAN |
| | |
| | MARK GOODWIN & ASSOCIATES, P.A. CONSULTING ENGINEERS |
| | P.O. BOX 90606 ALBUQUERQUE, NEW MEXICO 87199 (505)828-2200, FAX (505)797-9539 |
| RAIN\19003_G&D.dwg, Last saved by: Cory | Designed: CP/DMG Drawn: CP Checked: DMG Sheet C2 |
| | Scale: 1" = 20' Date: 5/21/2019 Job: A19003 |



City of Albuquerque

Planning Department Development & Building Services Division DRAINAGE AND TRANSPORTATION INFORMATION SHEET (REV 6/2018)

| Project Title: Swim Labs | Building Permit # | t:Hydrology File #: |
|--|----------------------------|---|
| DRB#: | EPC#: | Work Order#: |
| Legal Description: Tract C Block 19 | Plat of Tracts A, B, C, D, | E and F, Block 19 Tract 3 Unit 3 North Albuquerque |
| Acres Cont7576 AC | | City |
| Address: 8110 Holly Ave, Albuquerque, | NM 87122 | |
| Applicant: Mullen Heller Architecture | | Contact: Doug Heller |
| Address: 1718 Central Avenue | | |
| Phone#: 505-268-4144 | Fax# | E-mail: doug@mullenheller.com |
| Other Contact: Mark Goodwin & Assoc | ciates, PA | Contact: Cory Pierce |
| Address: PO BOX 90606, Albuquerque, N | IM 87199 | |
| Phone#: <u>828.2200</u> | Fax#: | E-mail: <u>cory@goodwinengineers.com</u> |
| TYPE OF DEVELOPMENT:P | LAT (# of lots)l | RESIDENCEDRB SITE X ADMIN SITE |
| IS THIS A RESUBMITTAL?Y | es X No | |
| | | |
| DEPARTMENTTRANSPORTATIO | N <u>X</u> HYDROLO | GY/DRAINAGE |
| Check all that Apply: TYPE OF SUBMITTAL: ENGINEER/ARCHITECT CERTIFICA PAD CERTIFICATION CONCEPTUAL G & D PLAN X GRADING PLAN DRAINAGE REPORT DRAINAGE MASTER PLAN FLOODPLAIN DEVELOPMENT PERN ELEVATION CERTIFICATE CLOMR/LOMR TRAFFIC CIRCULATION LAYOUT (TRAFFIC IMPACT STUDY (TIS) STREET LIGHT LAYOUT OTHER (SPECIFY) PRE-DESIGN MEETING? | TION /IT APPLIC TCL) | TYPE OF APPROVAL/ACCEPTANCE SOUGHT: BUILDING PERMIT APPROVAL |
| DATE SUBMITTED: June 25, 2019 | By: Cory Pierc | e |

| COA STAFF: | EL |
|------------|----|

ELECTRONIC SUBMITTAL RECEIVED

FEE PAID:_____