

# CITY OF ALBUQUERQUE

Planning Department  
Brennon Williams, Acting Director



Mayor Timothy M. Keller

July 10, 2019

Mark Goodwin, P.E.  
Mark Goodwin & Associates  
PO Box 90606  
Albuquerque, NM 87199

RE: **Swim Labs**  
**8110 Holly Ave NE**  
**Grading Plan Stamp Date: 6/24/19**  
**Hydrology File: C20D082**

Dear Mr. Goodwin:

Based on the submittal received on 6/25/19, the grading and drainage plan cannot be approved until the following are corrected:

1. Provide proposed contours and proposed spot elevation in sufficient density to ascertain the proposed drainage pattern of the site.
2. A waterblock is likely required near the north driveway to ensure flows are routed to the tract B pond.
3. Subbasins need to be delineated and modeled in AHYMO or with the 40-acres-or-less method and must include all onsite drainage and upstream offsite flows.
4. The drainage plan must address all onsite drainage and upstream offsite drainage, not just the parking lot and building.
5. Remove the temporary markings from the tract B stormwater quality pond; these features are permanent and will need to be protected with a drainage covenant, signed by the underlying property owner.
6. Provide written and signed permission from the owner of Tract B for the grading, paving and pond construction on their property.
7. Provide project datum.
8. The complete AHYMO input and output files need to be provided, not just the summary. If you provide these separately, they must be bound and stamped by the engineer.

PO Box 1293

Albuquerque

NM 87103

[www.cabq.gov](http://www.cabq.gov)

# CITY OF ALBUQUERQUE

Planning Department  
Brennon Williams, Acting Director



Mayor Timothy M. Keller


9. With AHYMO S4, be sure to use NOAA Atlas 14 precipitation depths in conjunction with the NOAA Atlas 14 distribution. Include the location map and tables obtained from the NOAA website. Using the NOAA Atlas 2 Precipitation depths (Found in the DPM), with the NOAA Atlas 14 Distributions results in an over-prediction of peak runoff ( $Q_{100}$ ). See [AHYMO AppNote-01](#), and the Hydrology website for more information regarding this.
10. The outfall for pond B is unclear. The AHYMO run seems to indicate a continuous outflow, but the obvious outfall is the drive entrance that has a crest elevation at 54.12'. The City does not accept infiltration as an outfall or credit it in pond sizing as pond bottoms generally silt-in and reduce the infiltration rate to nearly nothing.
11. The site must demonstrate adequate downstream capacity per § 14-5-2-12(G) of the Albuquerque Code of Ordinances.
12. Provide the Furr's Paseo del Norte drainage report and Hydrology approval letter. This report is missing in our database and needs to be recovered if it is to be used as the basis for this development.
13. Provide a cross lot drainage easement (paper or Plat) between the two tracts.
14. As a reminder, if the project total area of disturbance (including the staging area and any work within the adjacent Right-of-Way) is 1 acre or more, then an Erosion and Sediment Control (ESC) Plan and Owner's certified Notice of Intent (NOI) is required to be submitted to the Stormwater Quality Engineer (Curtis Cherne, PE, [ccherne@cabq.gov](mailto:ccherne@cabq.gov), 924-3420) 14 days prior to any earth disturbance.

If you have any questions, you can contact me at 924-3695 or [dpeterson@cabq.gov](mailto:dpeterson@cabq.gov).

Sincerely,

Dana Peterson, P.E.  
Senior Engineer, Planning Dept.  
Development Review Services

PO Box 1293  
Albuquerque  
NM 87103  
[www.cabq.gov](http://www.cabq.gov)

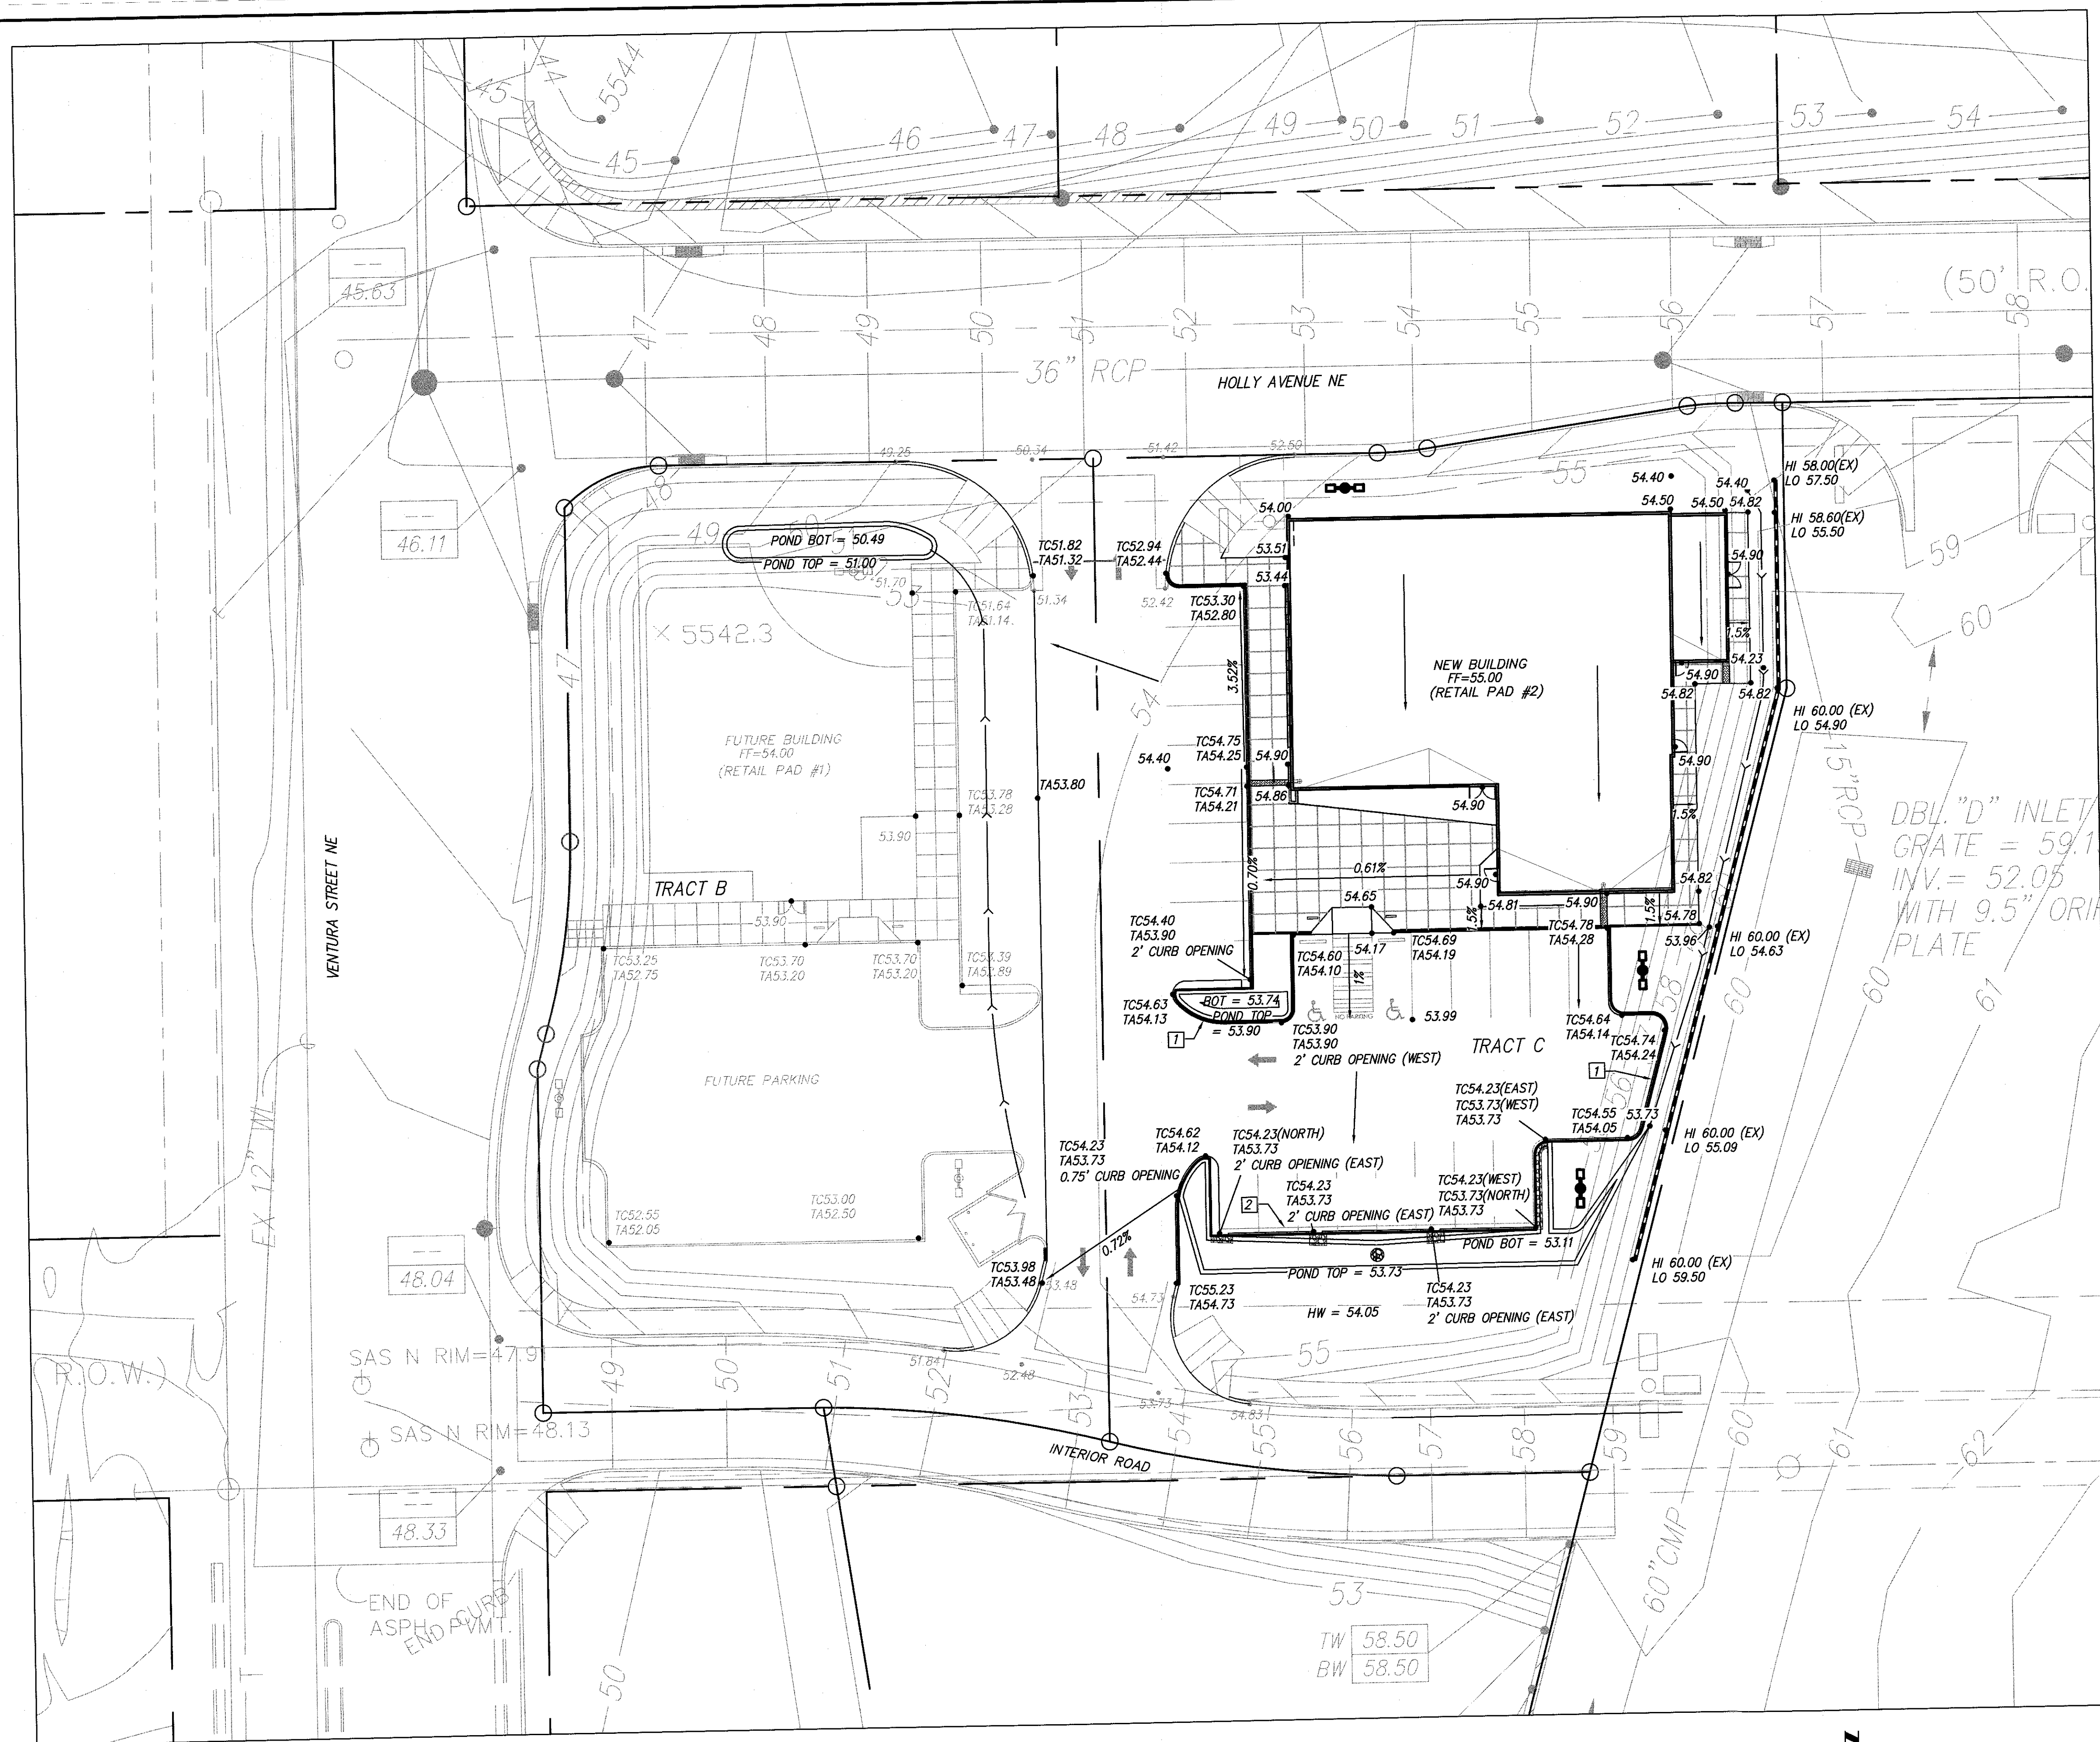

# LEGAL DESCRIPTION

TRACT C BLOCK 19 NORTH ALBUQUERQUE ACRES  
TRACT 3, UNIT 3  
CITY OF ALBUQUERQUE  
BERNALILLO COUNTY, NEW MEXICO

## ACS BENCHMARK

THE STATION MARK IS A STANDARD ACS BRASS TABLET STAMPED "C21A-1978" SET IN TOP OF A CONCRETE POST FLUSH WITH GROUND. TO REACH THE STATION FROM THE INTERCHANGE AT I-25 AND SAN MATEO BLVD. N.E., GO NORTH ON THE EAST FRONTAGE ROAD FOR 1.5 MILES TO PASEO DEL NORTE. TURN RIGHT, GO EAST ON PASEO DEL NORTE 2.8 MILES TO THE STATION ON THE LEFT.  
X=415,503.35 Y=1,518,787.29 Z=5634.65

## GENERAL NOTES

1. CONTRACTOR MUST OBTAIN A TOPSOIL DISTURBANCE PERMIT FROM THE ENVIRONMENTAL HEALTH DIVISION PRIOR TO CONSTRUCTION.
2. CITY OF ALBUQUERQUE STANDARD SPECIFICATIONS FOR PUBLIC WORKS CONSTRUCTION, LATEST EDITION SHALL GOVERN ALL WORK.
3. THE CONTRACTOR SHALL CONFORM TO ALL CITY, COUNTY, STATE AND FEDERAL DUST CONTROL MEASURES AND REQUIREMENTS AND WILL BE RESPONSIBLE FOR PREPARING AND OBTAINING ALL NECESSARY APPLICATIONS AND APPROVALS.
4. THE CONTRACTOR SHALL ENSURE THAT NO SOIL ERODES FROM THE LOTS INTO PUBLIC RIGHT-OF-WAY. THIS CAN BE ACHIEVED BY CONSTRUCTING TEMPORARY BERMS AND WETTING THE SOIL TO KEEP IT FROM BLOWING.
5. THE EARTHWORK CONTRACTOR SHALL STOCKPILE ENOUGH MATERIAL ADJACENT TO RETAINING WALL LOCATIONS TO BE UTILIZED FOR WALL BACKFILL.
6. NO WORK ALLOWED IN THE PUBLIC RIGHT OF WAY WITHOUT AN APPROVED WORK ORDER.

## LEGEND

	RETAINING WALL
	DRAINAGE SWALE
	SPOT ELEVATION
	HIGH SIDE, LOW SIDE OF RETAINING WALL SPOT
	TOP OF CURB, TOP OF ASPHALT SPOT
	FRENCH DRAIN - SEE DETAIL
	4" MINUS CLEAN GRAVEL
	12" SIDEWALK CULVERT PER COA STD DWG 2236

## KEY NOTES

1. HEADER CURB PER COA STD DWG 2415B
2. MEDIAN CURB & GUTTER PER COA STD DWG 2415B

## SWIM LABS


## GRADING & DRAINAGE PLAN

**dmg** MARK GOODWIN & ASSOCIATES, P.A.  
CONSULTING ENGINEERS  
P.O. BOX 90606  
ALBUQUERQUE, NEW MEXICO 87199  
(505)828-2200, FAX (505)797-9539


Designed: CP/DMG Drawn: CP Checked: DMG Sheet: C1  
Scale: 1" = 20' Date: 6/21/2019 Job: A19003

**UNDERGROUND UTILITIES CAUTION:**  
NOTE THAT ALL EXISTING UTILITIES MAY NOT BE SHOWN. ALL EXISTING SERVICE CONNECTIONS ARE NOT SHOWN. ANY EXISTING UTILITIES THAT ARE SHOWN ARE APPROXIMATE LOCATION ONLY. IT SHALL BE THE SOLE RESPONSIBILITY OF THE CONTRACTOR TO CONTACT ALL THE UTILITY OWNERS AND TO CONDUCT ALL NECESSARY FIELD INVESTIGATIONS PRIOR TO ANY EXCAVATIONS TO DETERMINE THE ACTUAL LOCATION OF UTILITIES AND OTHER IMPROVEMENTS.

FRENCH DRAIN DETAIL  
N.T.S.

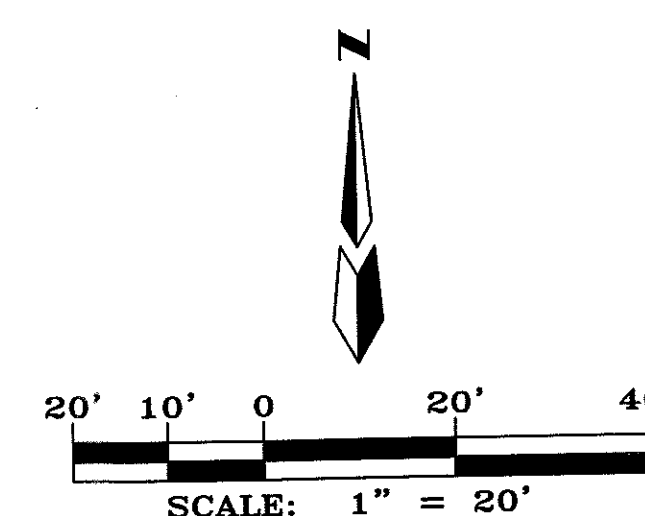



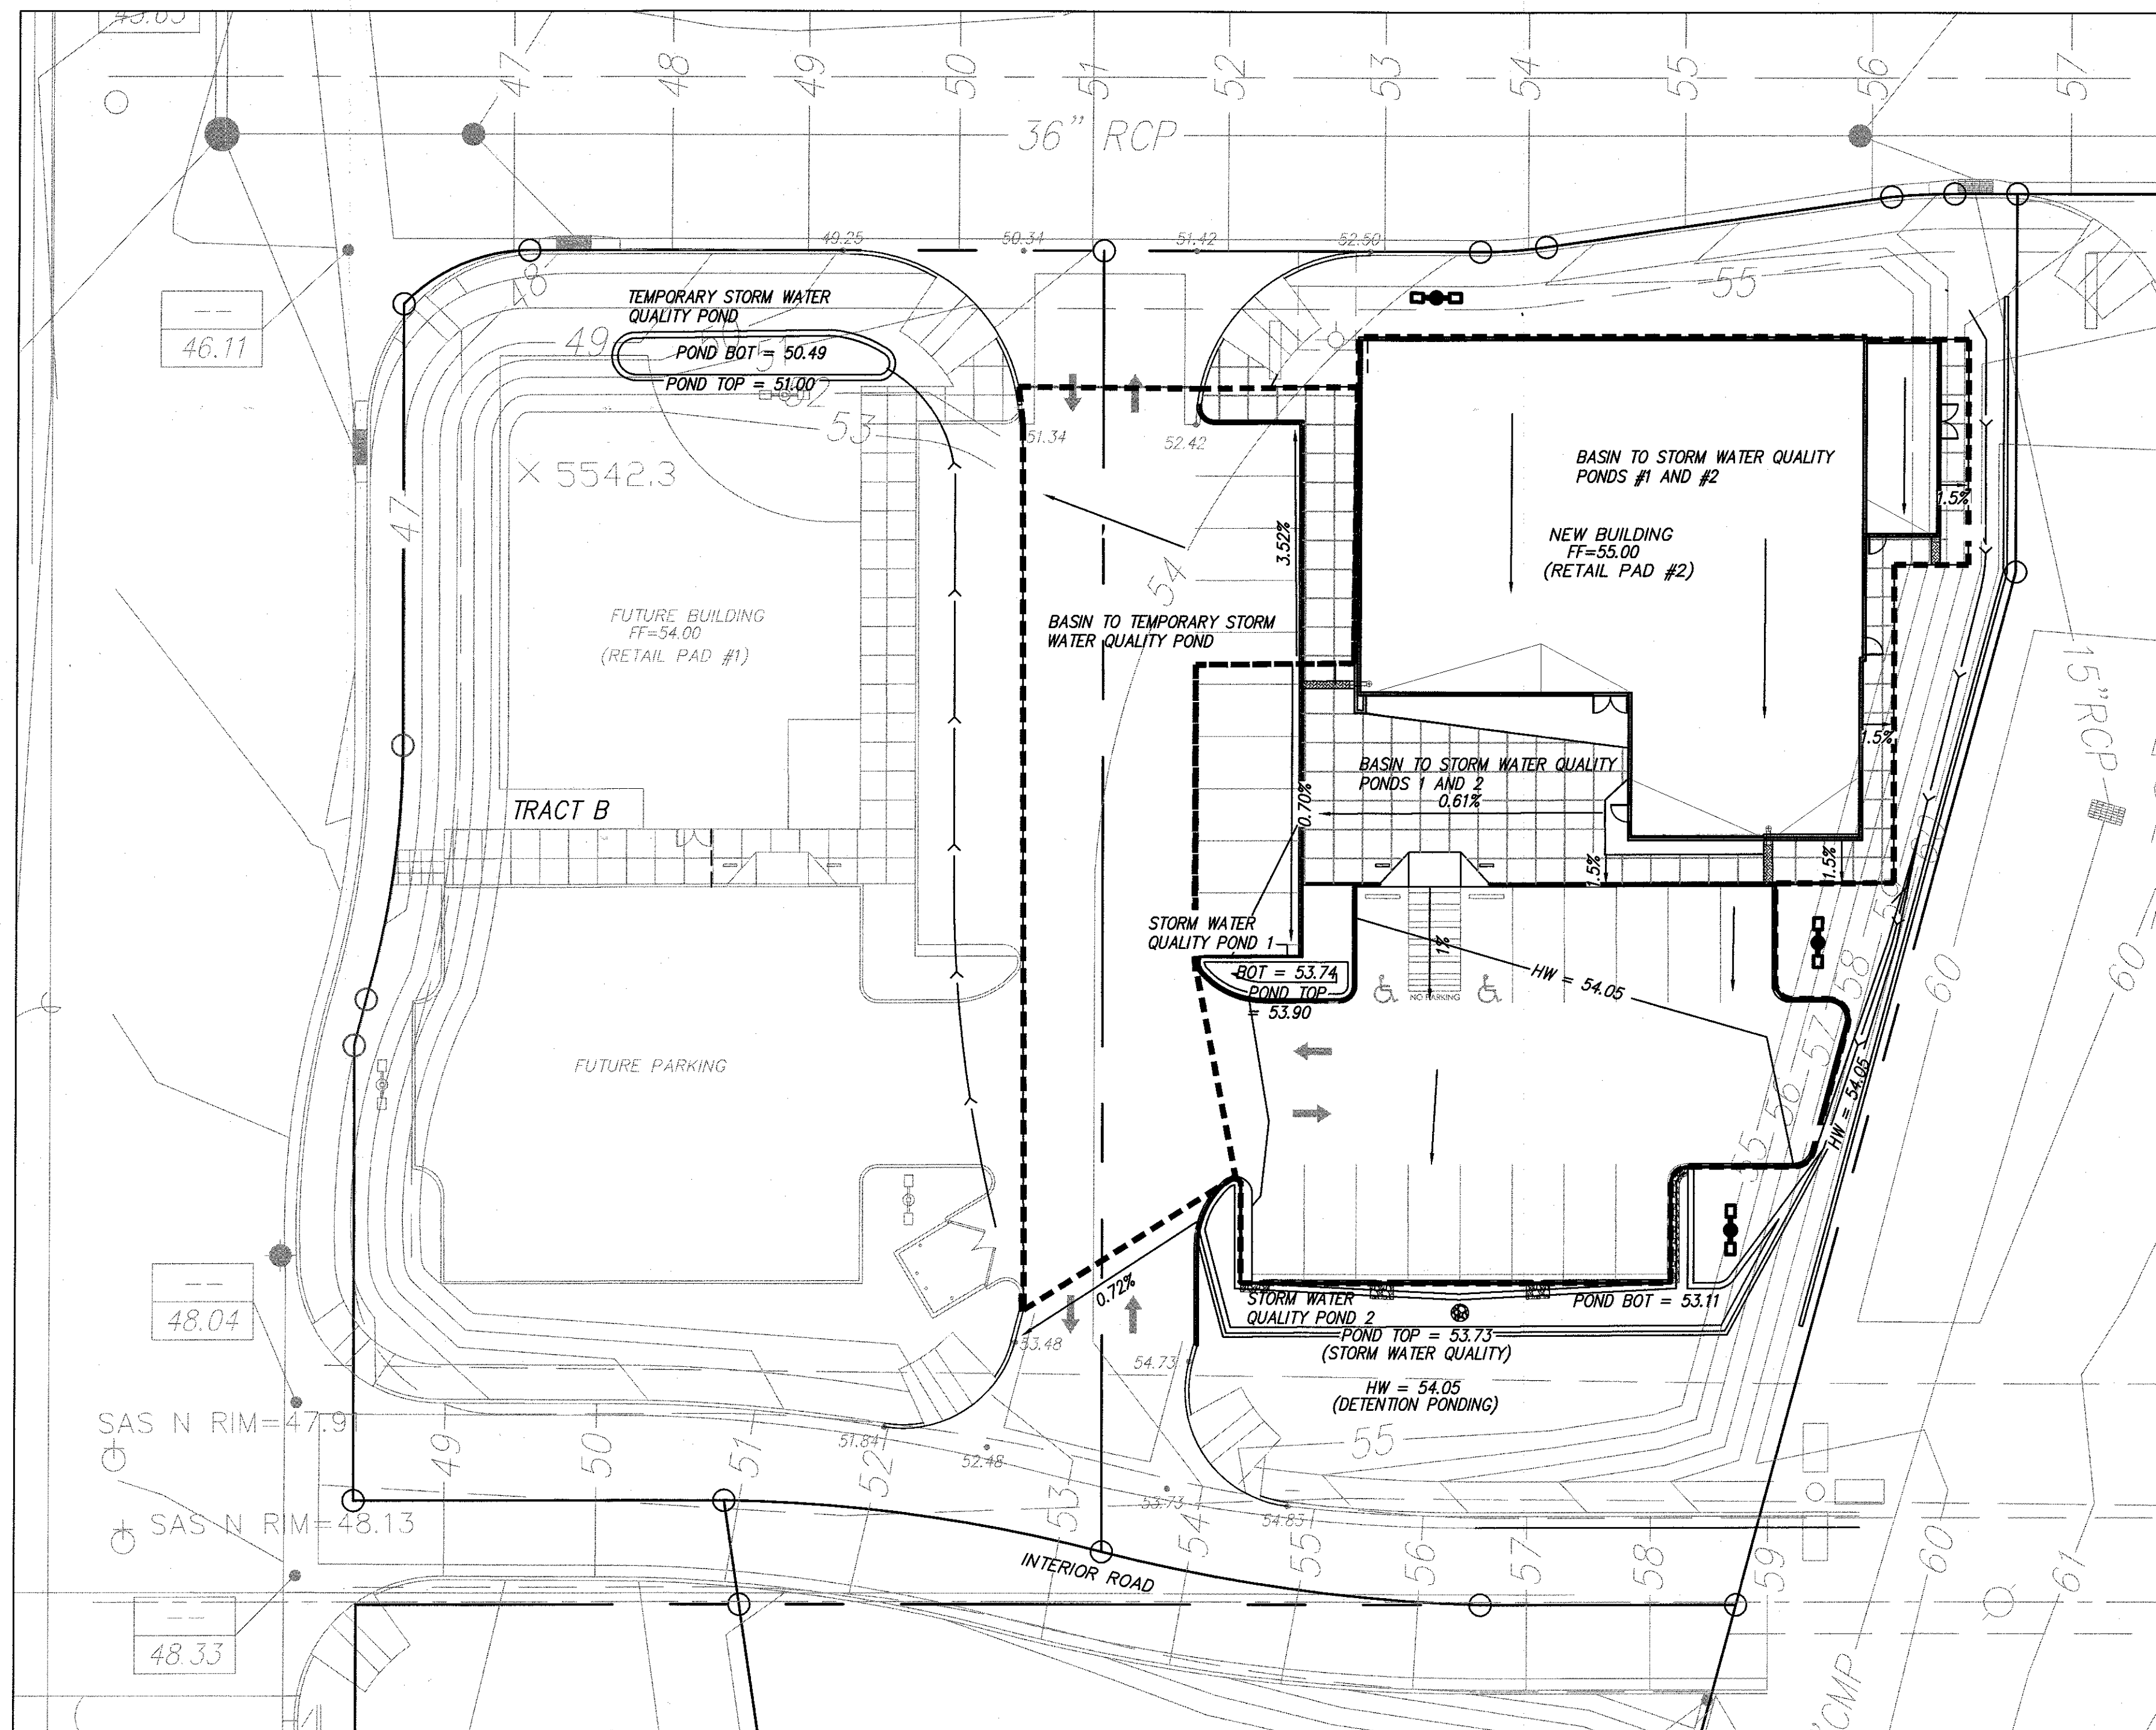

**TRACT B:**  
**TEMPORARY STORM WATER QUALITY POND**

Proposed Impervious Area (SF)	6074
Storm Water Quality retention depth (inches):	0.34
Required Storm Water Quality Volume (CF):	172

Proposed Storm Water Quality Retention Capacity:	
Temporary Retention Pond	
Depth (FT):	0.51
Bottom (SF)	291
Top (SF)	394
Volume (CF)	175

**STORM WATER QUALITY:**

RECENT STORM WATER QUALITY REQUIREMENTS OF THE CITY OF ALBUQUERQUE RESULT IN CAPTURE OF 0.34 INCHES OF RAINFALL OVER IMPERVIOUS SURFACES.

THE REQUIRED STORM WATER QUALITY VOLUME IS FULLY CAPTURED WITHIN THE TEMPORARY TRACT B STORM WATER QUALITY POND AND THE TWO TRACT C STORM WATER QUALITY PONDS. ON TRACT C, WATER SHED FLOWS TO STORM WATER QUALITY POND #1 AND OVERFLOWS TO THE SIGNIFICANTLY LARGER STORM WATER QUALITY POND #2.

THE FRENCH DRAIN IS A FEATURE OF THE DESIGN TO HASTEN INFILTRATION WITHIN STORM WATER QUALITY POND #2 WHEN RUNOFF IS CAPTURED FROM STORM EVENTS.

TRACT C STORM WATER QUALITY PONDS ARE TO BE PERMANENT WITH THIS DEVELOPMENT AND TRACT B STORM WATER QUALITY POND IS TEMPORARY. THE CONTRIBUTING BASIN OF IMPERVIOUS AREA TO TRACT B TEMPORARY STORM WATER QUALITY POND OCCUPIES PORTIONS OF BOTH TRACT B AND TRACT C.

**TRACT C:**  
**PONDS 1 AND 2**

Proposed Impervious Area (SF)	17101
Storm Water Quality retention depth (inches):	0.34
Required Storm Water Quality Volume (CF):	485

POND 1	
Depth (FT):	0.16
Bottom (SF)	24
Top (SF)	121
Volume (CF)	12

POND 2	
Depth (FT):	0.62
Bottom (SF)	619
Top (SF)	926
Volume (CF)	479

**DRAINAGE REPORT**

THE SITE IS WITHIN THE FURRS PASEO DEL NORTE PROJECT (ADDENDUM STAMP DATE 11/27/00, GREGORY JAMES KRENK, D. MARK GOODWIN & ASSOCIATES). THE FURRS PASEO DEL NORTE PROJECT HAS FOUR BASINS. BASIN IX INCLUDES RETAIL PAD #1 AND RETAIL PAD #2. THIS PROJECT (SWM LABS) IS RETAIL PAD #2.

THE 2000 ADDENDUM ALLOCATES 0.93 CFS FOR PAD #2 AND 0.93 CFS FOR PAD #1 (WEST OF PAD #2) OF ALLOWABLE DISCHARGE. BOTH PROPERTIES (RETAIL PAD #1 AND #2) INCLUDE A PORTION OF THE INTERIOR ROAD WHICH IS INCLUDED IN BASIN II AND IS NOT INCLUDED IN THE ALLOWABLE DISCHARGE OF EACH PAD.

THE PROPOSED DESIGN FOR RETAIL PAD #2 INCLUDES CAPTURE OF 0.34" ON IMPERVIOUS AREAS TO MEET STORM WATER QUALITY REQUIREMENTS. AS SUCH THE POND ON THE SOUTH PORTION OF THE SITE RETAINS THIS VOLUME REQUIREMENT FROM ELEVATION 53.11' TO 53.73'. FROM ELEVATION 53.73' TO 54.05' THE POND FUNCTIONS AS A DETENTION POND DURING THE 100YR, 6HR STORM WITH A PEAK DISCHARGE OF 0.70 CFS. DISCHARGE BEGINS AFTER STORM WATER QUALITY CAPTURE AT ELEVATION 53.73' THROUGH A 9" WIDE CURB OPENING AT THE WEST END OF POND #2.

AS A PORTION OF RETAIL PAD #2 DRAINS TO RETAIL PAD #1 (BASIN TO TEMPORARY TRACT B STORM WATER QUALITY POND), THE DIFFERENCE IN ALLOWABLE DISCHARGE IS RE-ALLOCATED TO PAD #1 YIELDING APPROXIMATELY 1.16 CFS TOTAL (0.93+0.93-0.70).

RAINFALL WAS TAKEN FROM NOAA RAINFALL DATA AT THE LOCATION OF THE SITE. THE RAINFALL WAS MITIGATED BY 0.34" (STORM WATER QUALITY CAPTURE) FOR INPUT INTO AHYMO. THE DISCHARGE TABLE WAS MODELED BASED ON A .75" WIDE WEIR WITH WEIR COEFFICIENT OF 2.6:

```
ahymo_SwimLabs_Pad2_TOPDETEN-B_IN
START          0.0 HOURS   PC=0   PL=-1
LOCATION        ALBUQUERQUE
*S SWIM LABS 19003
*S ONSITE PAD 2
*S By Cory Pierce
RAINFALL      TYPE=1  0.0  1.48  2.11  2.52
DT=0.01
SEDIMENT BULK CODE=1  BULK FACTOR = 1.06
COMPUTE NM HYD ID=3  HYD=202 AREA=0.00086 SQ MI
                  A B C D 30 0 0 70
                  TP=0.13333  MASSRAIN=-1
PRINT HYD      ID=3  CODE=1
ROUTE RESERVOIR ID=5  HYD NO=POND.OT  INFLOW=3
CODE=24
OUTFLOW (CFS) STORAGE(AF)
ELEV(FT)
0.0001          5553.73
0.07             .0028  5553.80
0.16             0.0063  5553.85
0.30             0.0116  5553.91
0.49             0.0194  5553.98
0.77             0.0312  5554.07
0.99             0.0402  5554.13
1.38             0.0484  5554.23
PRINT HYD      ID=5  CODE 1
FINISH
```

(S16.66H  
AHYMO PROGRAM SUMMARY TABLE (AHYMO-S4) - Ver. S4.01a, Rel: 01a  
RUN DATE (MON/DAY/YR) = 06/24/2019  
INPUT FILE = 19\A19003 - Ventura Swim Labs\Drainage\ahymo\_SwimLabs\_Pad2\_TOPDETEN-B\_IN.txt  
USER NO. = M-Goodwin\MSiteA90075759

TIME TO	CFS	PAGE = 1	FROM	TO	PEAK	RUNOFF								
RUNOFF	PEAK	HYDROGRAPH	ID	ID	AREA	DISCHARGE	VOLUME							
COMMAND	IDENTIFICATION	PER	NO.	NO.	(SQ MI)	(CFS)	(AC-FT)							
(HOURS)	ACRE	NOTATION					(INCHES)							
START														
TIME=	0.00	ALBUQUERQUE												
LOCATION														
*S SWMM LABS 19003														
*S ONSITE PAD 2														
*S By Cory Pierce														
RAINFALL	TYPE= 1 NOAA 14													
RAINF=	2.110													
SEDIMENT BULK														
PK BF =	1.06													
COMPUTE NM HYD	202.00	-	3	0.00086	1.69	0.069	1.51448							
1.530	3.079 PER IMP=	70.00												
ROUTE RESERVOIR	POND.OT	3	5	0.00086	0.70	0.097	2.12559							
1.740	1.276 AC-FT=	0.028												
FINISH														
(S10H														


**LEGAL DESCRIPTION**

TRACT C BLOCK 19 NORTH ALBUQUERQUE ACRES  
TRACT 3, UNIT 3  
CITY OF ALBUQUERQUE  
BERNALILLO COUNTY, NEW MEXICO

**ACS BENCHMARK**

THE STATION MARK IS A STANDARD ACS BRASS TABLET STAMPED "-C21A-1978"  
SET IN TOP OF A CONCRETE POST FLUSH WITH GROUND. TO REACH THE STATION  
FROM THE INTERCHANGE AT I-25 AND SAN MATEO BLVD. N.E., GO NORTH ON  
THE EAST FRONTAGE ROAD FOR 1.5 MILES TO PASEO DEL NORTE. TURN RIGHT,  
GO EAST ON PASEO DEL NORTE 2.8 MILES TO THE STATION ON THE LEFT.  
X=415,503.35 Y=1,518,787.29 Z=5634.65

**VICINITY MAP (ZONE ATLAS C-20-Z)**

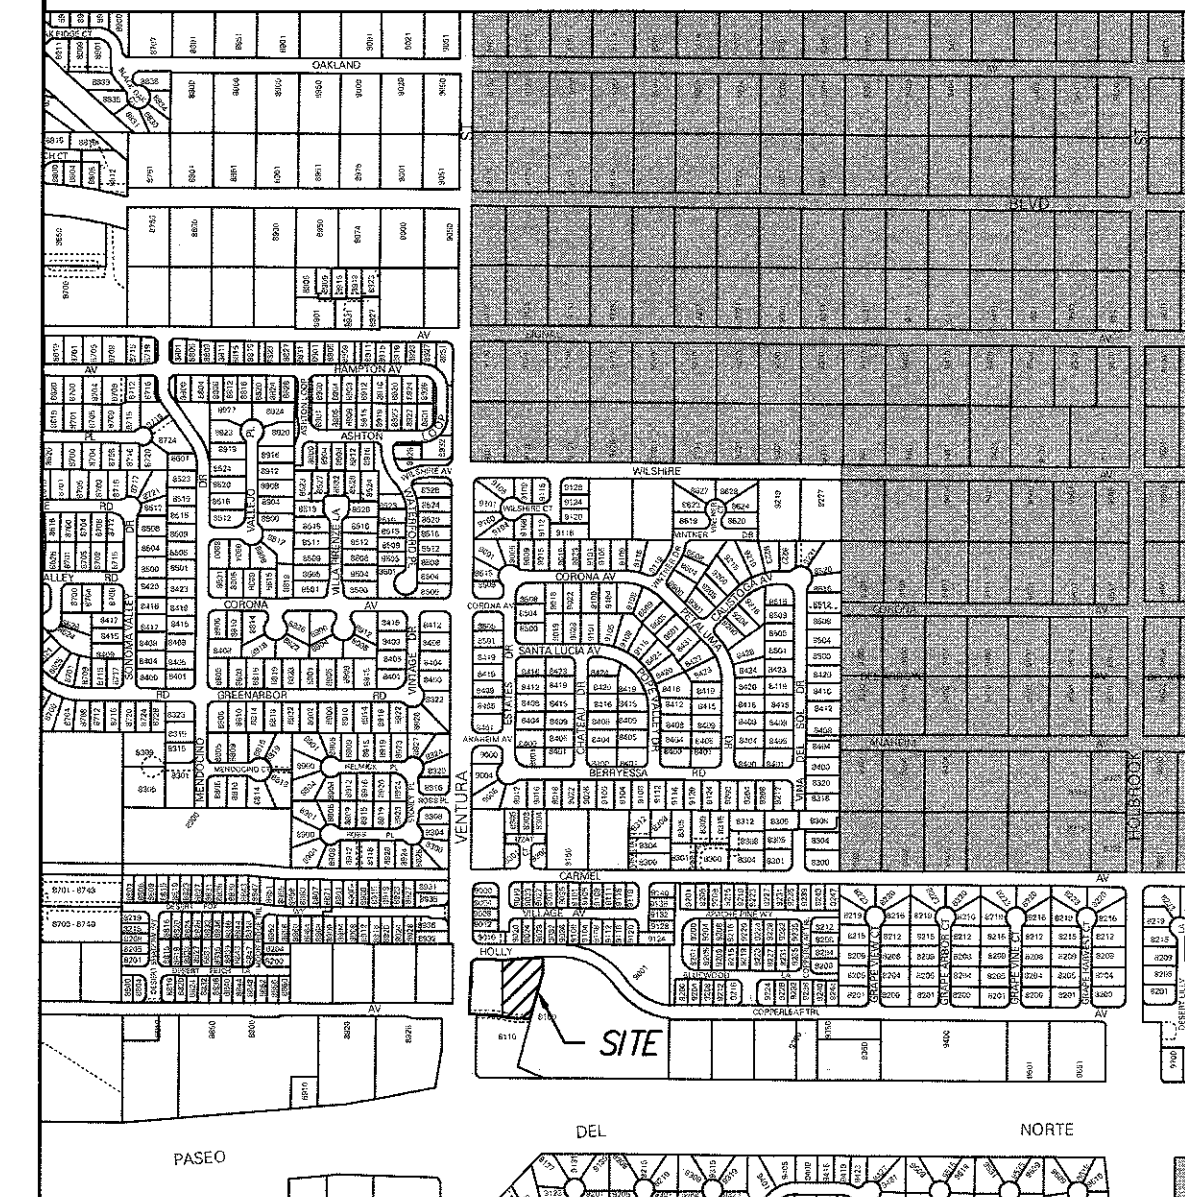

**SWIM LABS**  
**GRADING & DRAINAGE PLAN**

**dmg** MARK GOODWIN & ASSOCIATES, P.A.  
CONSULTING ENGINEERS  
P.O. BOX 90608  
ALBUQUERQUE, NEW MEXICO 87199  
(505)828-2200, FAX (505)797-9539

Designed: CP/DMG Drawn: CP Checked: DMG Sheet **C2**  
Scale: 1" = 20' Date: 5/21/2019 Job: A19003



# City of Albuquerque

Planning Department  
Development & Building Services Division

## DRAINAGE AND TRANSPORTATION INFORMATION SHEET (REV 6/2018)

Project Title: Swim Labs Building Permit #: \_\_\_\_\_ Hydrology File #: \_\_\_\_\_

DRB#: \_\_\_\_\_ EPC#: \_\_\_\_\_ Work Order#: \_\_\_\_\_

Legal Description: Tract C Block 19 Plat of Tracts A,B,C,D,E and F, Block 19 Tract 3 Unit 3 North Albuquerque  
Acres Cont. .7576 AC City

Address: 8110 Holly Ave, Albuquerque, NM 87122

Applicant: Mullen Heller Architecture

Contact: Doug Heller

Address: 1718 Central Avenue

Phone#: 505-268-4144

Fax# \_\_\_\_\_

E-mail: doug@mullenheller.com

Other Contact: Mark Goodwin & Associates, PA

Contact: Cory Pierce

Address: PO BOX 90606, Albuquerque, NM 87199

Phone#: 828.2200

Fax#: \_\_\_\_\_

E-mail: cory@goodwinengineers.com

TYPE OF DEVELOPMENT: \_\_\_\_\_ PLAT (# of lots) \_\_\_\_\_ RESIDENCE \_\_\_\_\_ DRB SITE X ADMIN SITE

IS THIS A RESUBMITTAL? \_\_\_\_\_ Yes X No

DEPARTMENT \_\_\_\_\_ TRANSPORTATION X HYDROLOGY/DRAINAGE

Check all that Apply:

### TYPE OF SUBMITTAL:

- ☐ ENGINEER/ARCHITECT CERTIFICATION
- ☐ PAD CERTIFICATION
- ☐ CONCEPTUAL G & D PLAN
- ☒ GRADING PLAN
- ☐ DRAINAGE REPORT
- ☐ DRAINAGE MASTER PLAN
- ☐ FLOODPLAIN DEVELOPMENT PERMIT APPLIC
- ☐ ELEVATION CERTIFICATE
- ☐ CLOMR/LOMR
- ☐ TRAFFIC CIRCULATION LAYOUT (TCL)
- ☐ TRAFFIC IMPACT STUDY (TIS)
- ☐ STREET LIGHT LAYOUT
- ☐ OTHER (SPECIFY) \_\_\_\_\_
- ☐ PRE-DESIGN MEETING?

### TYPE OF APPROVAL/ACCEPTANCE SOUGHT:

- ☐ BUILDING PERMIT APPROVAL
- ☐ CERTIFICATE OF OCCUPANCY
- ☐ PRELIMINARY PLAT APPROVAL
- ☐ SITE PLAN FOR SUB'D APPROVAL
- ☒ SITE PLAN FOR BLDG. PERMIT APPROVAL
- ☐ FINAL PLAT APPROVAL
- ☐ SIA/ RELEASE OF FINANCIAL GUARANTEE
- ☐ FOUNDATION PERMIT APPROVAL
- ☒ GRADING PERMIT APPROVAL
- ☐ SO-19 APPROVAL
- ☒ PAVING PERMIT APPROVAL
- ☐ GRADING/ PAD CERTIFICATION
- ☐ WORK ORDER APPROVAL
- ☐ CLOMR/LOMR
- ☐ FLOODPLAIN DEVELOPMENT PERMIT
- ☐ OTHER (SPECIFY) \_\_\_\_\_

DATE SUBMITTED: June 25, 2019

By: Cory Pierce

COA STAFF:

ELECTRONIC SUBMITTAL RECEIVED: \_\_\_\_\_

FEE PAID: \_\_\_\_\_