

- ALL DISTURBED AREAS NOT COVERED BY LANDSCAPING OR PERMANET STRUCUTURE WILL BE COVERED AS DESCRIBED ON SITE PLAN.
- SEE DRAINAGE PLAN FOR DETAILED FLOW PATHS.

# **BMP MAP LEGEND**

# ||||||||| LIMITS OF DISTURBANCE

# **PERIMETER BMP (SILT FENCE)**

## FLOW DIRECTION



# WASTE CONTAINER



# **OPERATOR: MESQUITE PRODUCTIONS, INC.**

**TOTAL SITE AREA: 7 ACRES**  
**TOTAL DISTURBED AREA: 7 ACRES**

# **RECEIVING WATERS: ON-SITE RETENTION POND**


**REFER TO THE ESC BMP DETAILS (ESC-2) FOR INSTALLATION, INSPECTION AND MAINTENANCE REQUIREMENTS.**

# **\*\*GRADING PLAN BY OTHERS\*\***

**WYCARO 339**

# **TEMPORARY EROSION AND SEDIMENT CONTROL PLAN**

**Drawn By:**  
**M. VALLEJOS, CPESC, CISEC**      **08/29/23**

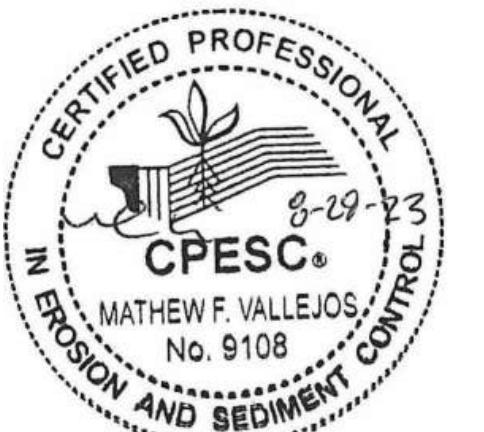

ESC-1

#### Non-woven Silt Fence


A silt fence is a temporary sediment barrier consisting of a geotextile attached to supporting posts and trenched into the ground. Intended to retain sediment that has been dislodged by stormwater.

Use silt fence as a perimeter control particularly at lower or down slope edge of a disturbed area. Leave space for maintenance between slope and silt fence or roll. Trench in the silt fence on the uphill side (6 in deep by 6 in wide). Install stakes on the downhill side of the fence. Curve silt fence up-gradient to help it contain runoff.

To maintain remove sediment when it reaches one-third of the height of the fence. Replace the silt fence where it is worn, torn, or otherwise damaged. Retrench or replace any silt fence that is not properly anchored to the ground. If the silt fence cannot be toed in properly due to existing hard surface, place mulch filter sock at base to prevent sediment from leaving site.

8' max wood stake spacing and 10' max spacing for steel T-post.

#### Silt Fence Installation

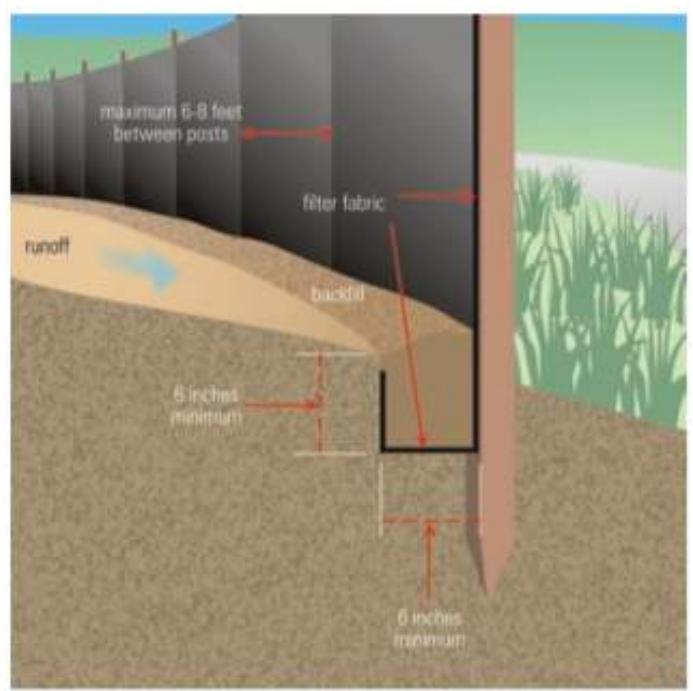

Source: USEPA Guide for Construction Site

#### TYPICAL CONCRETE WASHOUT-BELOW GRADE



- Install appropriate signage to inform concrete equipment operators of the proper washout location.
- An appropriate stabilized entrance shall be installed where applicable. The length and width of the stabilized entrance may vary based on size and location of the washout.
- Washout facilities must be sized to contain washout water and solids.
- Typical dimensions are 10 feet long by 10 feet wide but may vary upon site limitations.
- Pit shall be delineated with Orange Filter Sock and A-Framed staked.
- The pit shall be lined with 10mil (minimum) polyethylene impermeable liner on the bottom and sides overlapping the top edges completing a leak-proof container.

#### ESC Plan Standard Notes (2023-06-16)

1. All Erosion and Sediment Control (ESC) work on these plans, except as otherwise stated or provided hereon shall be permitted, constructed, inspected, and maintained in accordance with:
  - a. The City Ordinance § 14-5-2-11, the ESC Ordinance,
  - b. The EPA's 2022 Construction General Permit (CGP), and
  - c. The City Of Albuquerque Construction BMP Manual.
2. All BMP's must be installed prior to beginning any earth moving activities except as specified hereon in the Phasing Plan. Construction of earthen BMP's such as sediment traps, sediment basins, and diversion berms shall be completed and inspected prior to any other construction or earthwork. Self-inspection is required after installation of the BMPs and prior to beginning construction.
3. Self-inspections - In accordance with City Ordinance § 14-5-2-11(C)(1), "at a minimum a routine self-inspection is required to review the project for compliance with the Construction General Permit once every 14 days and after any precipitation event of 1/4 inch or greater until the site construction has been completed and the site determined as stabilized by the city. Reports of these inspections shall be kept by the person or entity authorized to direct the construction activities on the site and made available upon request.
4. Corrective action reports must be kept by the person or entity authorized to direct the construction activities on the site and made available upon request.
5. Final Stabilization and Notice of Termination (NOT) - In accordance with City Ordinance § 14-5-2-11(C)(1), self-inspections must continue until the site is "determined as stabilized by the city." The property owner/operator is responsible for determining when the "Conditions for Terminating CGP Coverage" per CGP Part 8.2 are satisfied and then for filing their Notice of Termination (NOT) with the EPA. Each operator may terminate CGP coverage only if one or more of the conditions in Part 8.2.1, 8.2.2, or 8.2.3 has occurred. After filing the NOT with the EPA, the property owner is responsible for requesting a Determination of Stabilization from the City.
6. When doing work in the City right-of-way (e.g. sidewalk, drive pads, utilities, etc.) prevent dirt from getting into the street. If dirt is present in the street, the street should be swept daily or prior to a rain event or contractor induced water event (e.g. curb cut or water test).
7. When installing utilities behind the curb, the excavated dirt should not be placed in the street.
8. When cutting the street for utilities the dirt shall be placed on the uphill side of the street cut and the area swept after the work is complete. A wattle or mulch sock may be placed at the toe of the excavated dirt pile if site constraints do not allow placing the excavated dirt on the uphill side of the street cut.
9. ESC Plans must show longitudinal street slope and street names. On streets where the longitudinal slope is steeper than 2.5%, wattles/mulch socks or j-hood silt fence shall be shown in the front yard swale or on the side of the street.



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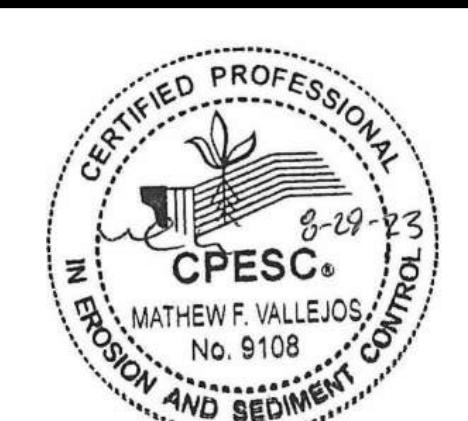
**WYCARO 339**

**TEMPORARY EROSION AND SEDIMENT CONTROL PLAN**

**Drawn By:**

M. VALLEJOS, CPESC, CISEC

08/29/23



**ESC-2**

**Nature of Construction Activity:**  
 This project consists of land development and vertical construction for film industry back lot. This project covers approximately 7.0 acres of the Wycaro 339 project. Mesquite Productions, Inc. is responsible for all construction activities including earthwork, infrastructure, utilities, flatwork, asphalt paving and vertical construction. The activities to occur on-site are consistent with land development and

Project/Site Name: Wycaro 339

Project Street/Location: Rainbow Blvd. and Scenic Dr. NW

City: Albuquerque

State: NM

Zip Code: 87120

County: Bernalillo

Project Latitude: 35.16580 Longitude: -106.73913

Determination of Latitude/Longitude:

USGS topographic map (scale: \_\_\_\_\_)

EPA Web Site  NM OpenEnviroMap  GPS

Other (please specify): \_\_\_\_\_

Function of Construction Activity:

Residential  Commercial  Industrial  Linear (roadway)

Linear (Utility)  Development  Other (specify): Film Industry Back Lot

Is your project/site located on Federal or Native American Lands Yes  No

Description: \_\_\_\_\_

ROLE	COMPANY	REPRESENTATVIE NAME	PHONE	EMAIL
OPERATOR	MESQUITE PRODUCTIONS, INC.	JULIE HARTLEY	612-940-0954	<a href="mailto:JULIEHARTLEY@GMAIL.COM">JULIEHARTLEY@GMAIL.COM</a>
OWNER (TRACT 1 & 12)	JOSEPH ARCHBOLD	JOSEPH ARCHBOLD	505-328-1331	<a href="mailto:ARCHBOLD@FLASH.NET">ARCHBOLD@FLASH.NET</a>
OWNER (TRACT 11)	LIDIA MORALES	LIDIA MORALES	505-473-2131	<a href="mailto:LIDIAMORALES1986@GMAIL.COM">LIDIAMORALES1986@GMAIL.COM</a>
BMP MAINTENANCE	SUPERIOR STORMWATER SERVICES, LLC	TIM SLATUNAS	505-353-2558	<a href="mailto:TIM@SUPERIORSTORMWATER.COM">TIM@SUPERIORSTORMWATER.COM</a>
SWPPP INSPECTIONS	GREEN GLOBE ENVIRONMENTAL, LLC	TIM SLATUNAS	505-353-2558	<a href="mailto:TIM@GREENGLOBENM.COM">TIM@GREENGLOBENM.COM</a>

Start Date-Finish Date (dates to be marked on site plan by operator)	Construction Activity, BMPs, and location
Initial Phase	Pre-Site Grading 1. Install perimeter BMPs (silt fence, erosion control logs, downstream inlet protection, etc.) 2. Construct VTC. 3. Set up construction trailer, construction barrier, and material storage areas, etc. 4. Install sanitary facilities and dumpster 5. Implement stabilization procedures where work is complete or ceases (per section 2.2.14 of the 2022 EPA CGP)
Interim Phase	Site Grading/ Building Construction 1. Mass grade site 2. Construct utilities, infrastructure 3. Building, pavement construction 4. Implement stabilization procedures where work is complete or ceases (per section 2.2.14 of the 2022 EPA CGP)
Final Phase	Final Stabilization 1. Implement stabilization procedures where work is complete or ceases (per section 2.2.14 of the 2022 EPA CGP) 2. Prepare final seeding and landscaping 3. Monitor stabilized areas until final stabilization is reached 4. Remove temporary control BMPs and stabilize any areas disturbed by theremoval



Tables - K Factor, Whole Soil - Summary By Map Unit			
Summary by Map Unit - Bernalillo County and Parts of Sandoval and Valencia Counties, New Mexico (NM600)			
Summary by Map Unit - Bernalillo County and Parts of Sandoval and Valencia Counties, New Mexico (NM600)			
Map unit symbol	Map unit name	Rating	Acres in AOI
AkC	Akela-Rock outcrop complex, 1 to 9 percent slopes	.10	4.6
Amb	Almedo sandy loam, 0 to 5 percent slopes	.24	5.9
<b>Totals for Area of Interest</b>		<b>10.5</b>	<b>100.0%</b>

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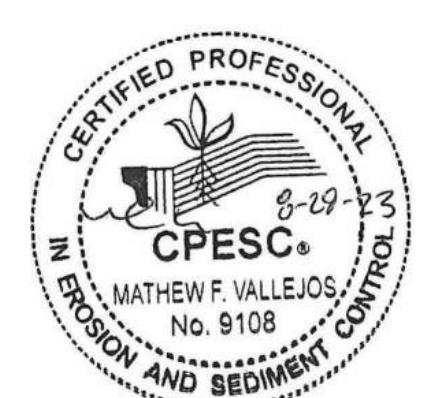
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WYCARO 339

TEMPORARY EROSION AND SEDIMENT CONTROL PLAN

Drawn By:  
M. VALLEJOS, CPESC, CISEC      08/29/23



ESC-3



1

2

3

4

5

D

C


B

A

A1

PROPERTY BOUNDARIES AND LAND USES

SCALE: 1" = 100'-0"

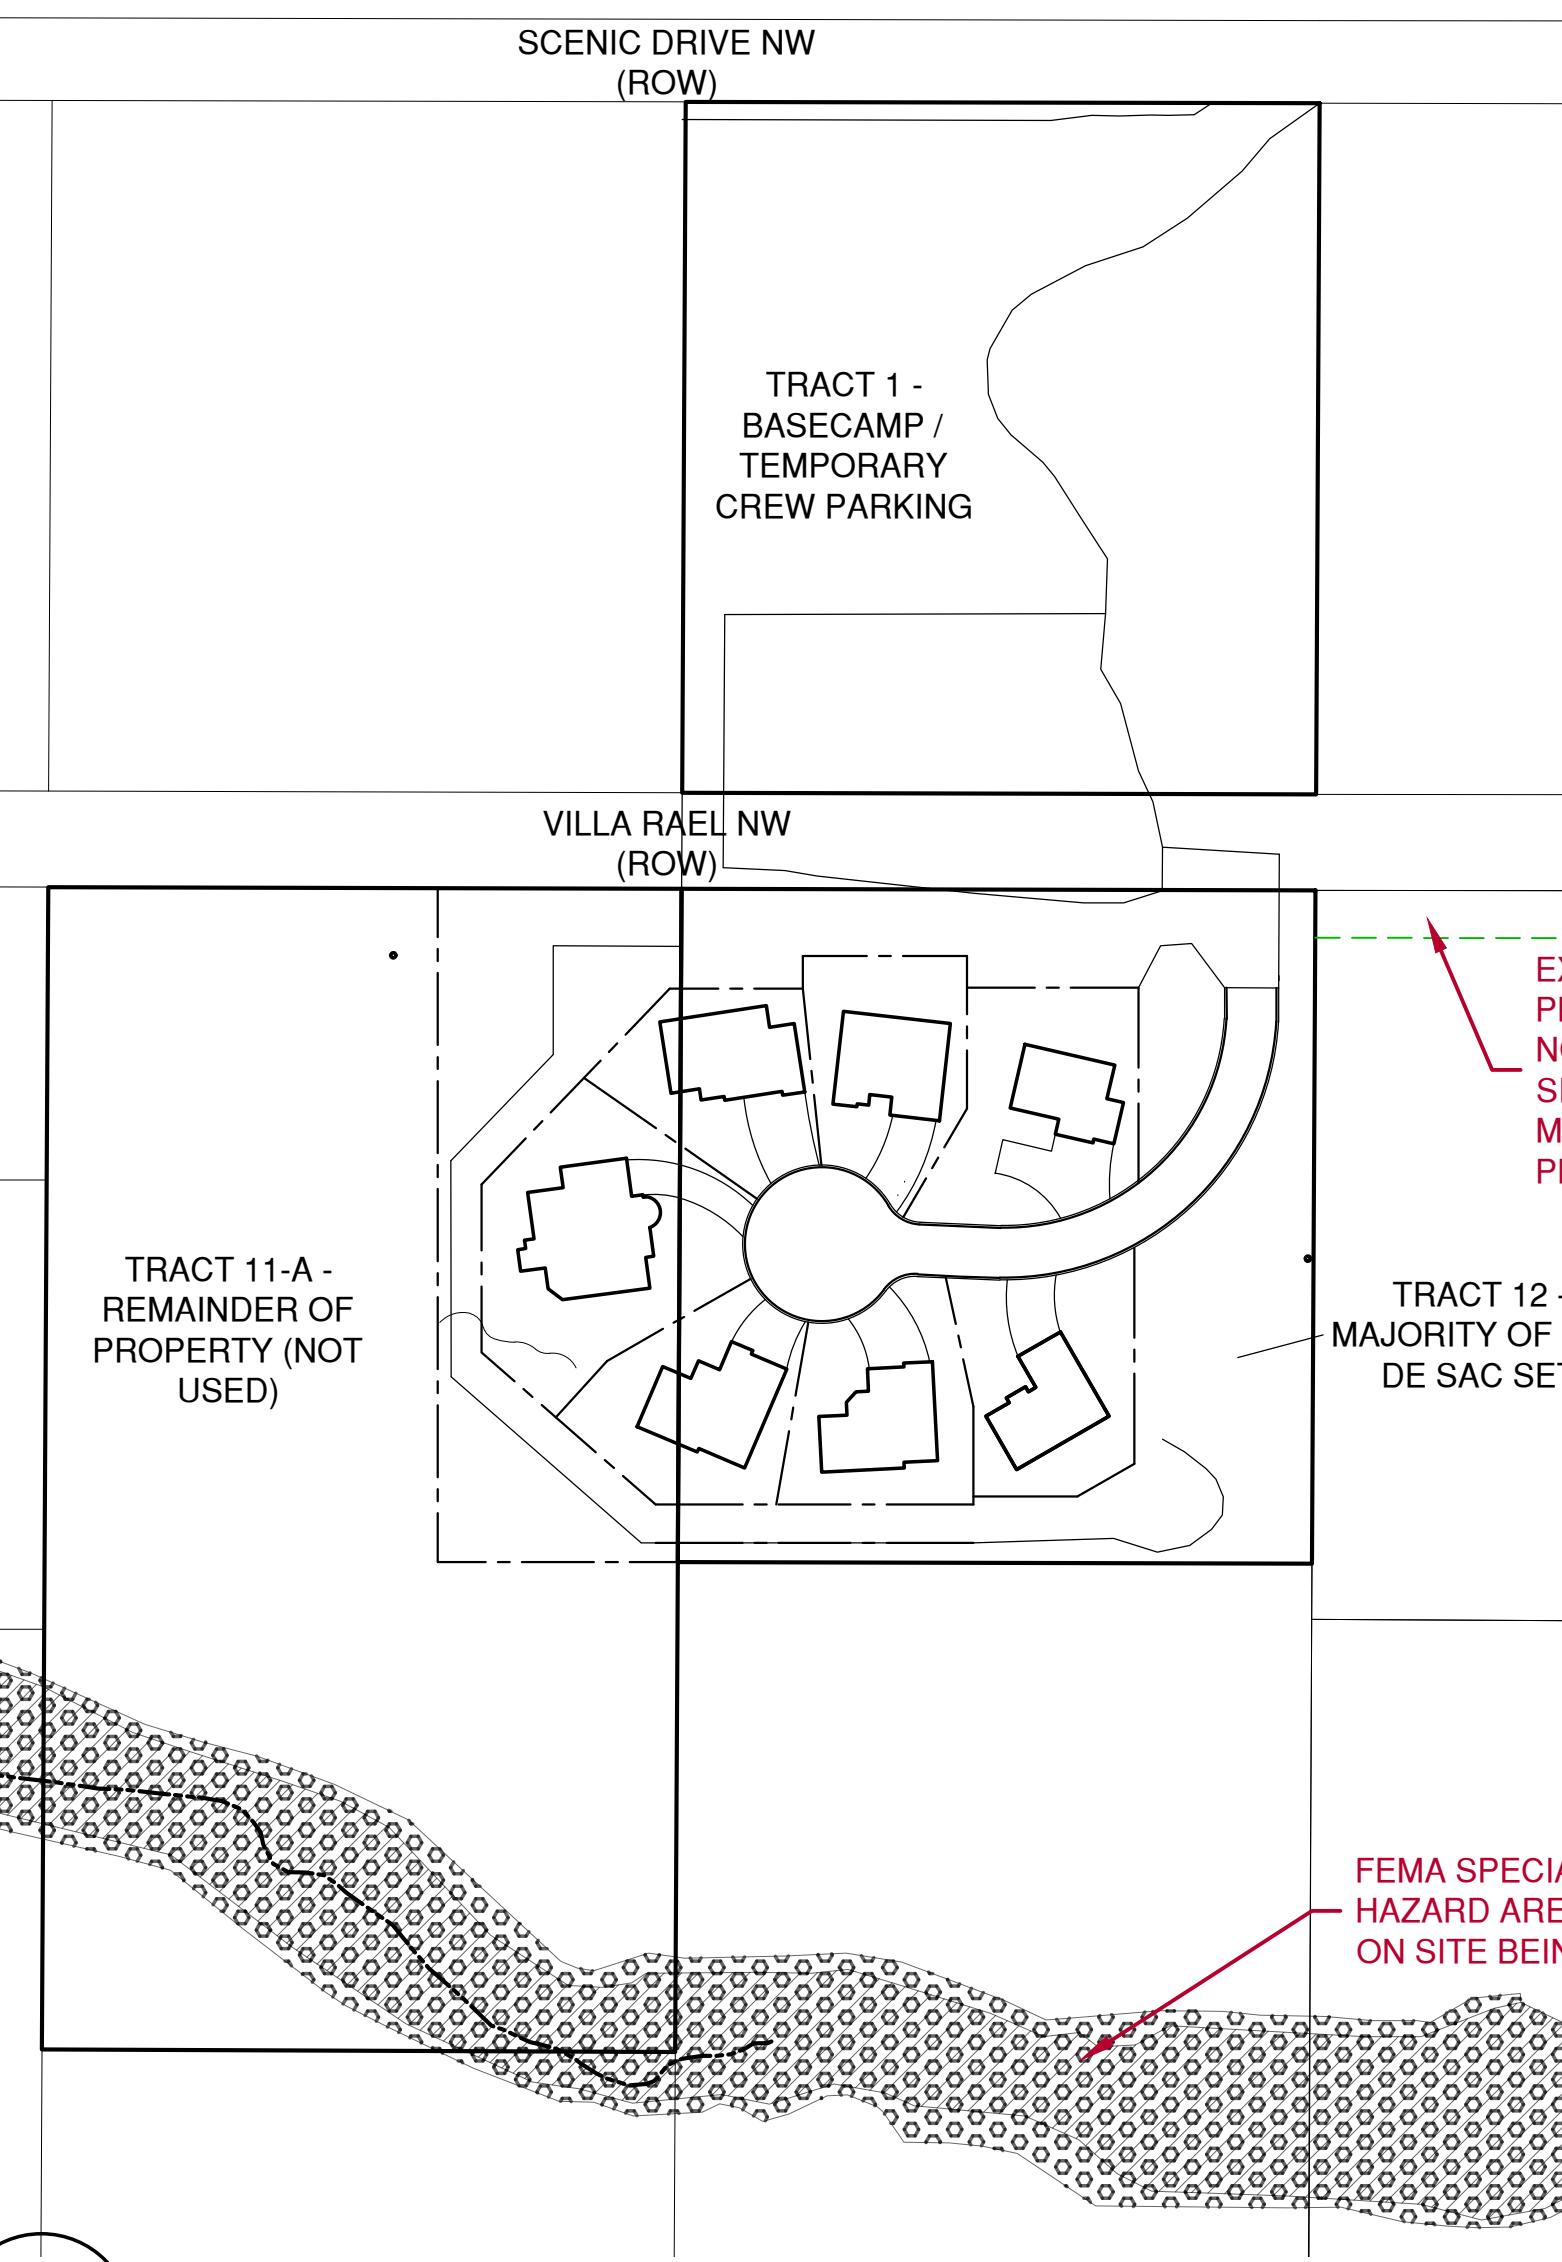

A2 SITE PLAN

SCALE: 1" = 40'-0"



PROJECT ADDRESS:  
WESTSIDE ALBUQUERQUE  
90909 VILLA REAL RD LOT 12  
ALBUQUERQUE, NM 87114

PROJECT:  
EXT CUL-DE-SAC - BACKLOT/SCENERY  
SITE PLAN - SURFACE TREATMENT

PROJECT  
SITE PLAN  
SHEET #  
A001a