## CITY OF ALBUQUERQUE

Planning Department Alan Varela, Director



May 31, 2024

David Soule, P.E. Rio Grande Engineering P.O. Box 93924 Albuquerque, NM 87199

**RE:** Quivira Subdivision

Revised Grading & Drainage Plans Engineer's Stamp Date: 05/20/24 Hydrology File: D09D006

Dear Mr. Soule:

Based upon the information provided in your submittal received 05/21/2024, the Revised Grading & Drainage Plans are approved for Grading Permit and Work Order.

PO Box 1293 Grading & Drainage Plans are approved for Grading Permit and Work Order.

As a reminder, if the project total area of disturbance (including the staging area and any work within the adjacent Right-of-Way) is 1 acre or more, then an Erosion and Sediment Control (ESC) Plan and Owner's certified Notice of Intent (NOI) is required to be submitted to the Stormwater Quality Engineer (Doug Hughes, PE, jhughes@cabq.gov, 924-3420) 14 days prior to

any earth disturbance.

Sincerely,

If you have any questions, please contact me at 924-3995 or rbrissette@cabq.gov.

www.cabq.gov

Albuquerque

NM 87103

Renée C. Brissette, P.E. CFM Senior Engineer, Hydrology

Renée C. Brissette

Planning Department




# **City of Albuquerque**

Planning Department
Development & Building Services Division

#### DRAINAGE AND TRANSPORTATION INFORMATION SHEET (DTIS)

Project Title:		Hydrology File #	
Legal Description:			
City Address, UPC, OR Parcel	:		
Applicant/Agent:Address:		Contact:	
		Phone:	
Email:			
Applicant/Owner:		Contact:	
Address:		Phone:	
Email:			
(Please note that a DFT SITE is or	ne that needs Site Plan A	pproval & ADMIN SITE is one that does not need it.)	
TYPE OF DEVELOPMENT:	PLAT (#of lots)	RESIDENCE	
	DFT SITE	ADMIN SITE	
RE-SUBMITTAL: YES	NO		
DED A DEMENT. TO A NI	SDODT A TION	HVDDOLOGV/DD A DIA CE	
<b>DEPARTMENT:</b> TRANS	SPORTATION	HYDROLOGY/DRAINAGE	
Check all that apply under Both	the Type of Submittal	and the Type of Approval Sought:	
TYPE OF SUBMITTAL:		TYPE OF APPROVAL SOUGHT:	
ENGINEER/ARCHITECT CERTIFICATION		BUILDING PERMIT APPROVAL	
PAD CERTIFICATION		CERTIFICATE OF OCCUPANCY	
CONCEPTUAL G&D PLAN		CONCEPTUAL TCL DFT APPROVAL	
GRADING & DRAINAGE PLAN		PRELIMINARY PLAT APPROVAL	
DRAINAGE REPORT		FINAL PLAT APPROVAL	
DRAINAGE MASTER PLAN		SITE PLAN FOR BLDG PERMIT DFT	
CLOMR/LOMR		APPROVAL	
TRAFFIC CIRCULATION LAYOUT (TCL) ADMINISTRATIVE		SIA/RELEASE OF FINANCIAL GUARANTEE	
		FOUNDATION PERMIT APPROVAL	
TRAFFIC CIRCULATION LAYOUT FOR DFT APPROVAL		GRADING PERMIT APPROVAL	
TRAFFIC IMPACT STUDY (TIS) STREET LIGHT LAYOUT		SO-19 APPROVAL	
		PAVING PERMIT APPROVAL	
OTHER (SPECIFY)		GRADING PAD CERTIFICATION	
		WORK ORDER APPROVAL	
		CLOMR/LOMR	
		OTHER (SPECIFY)	
DATE SUBMITTED:			

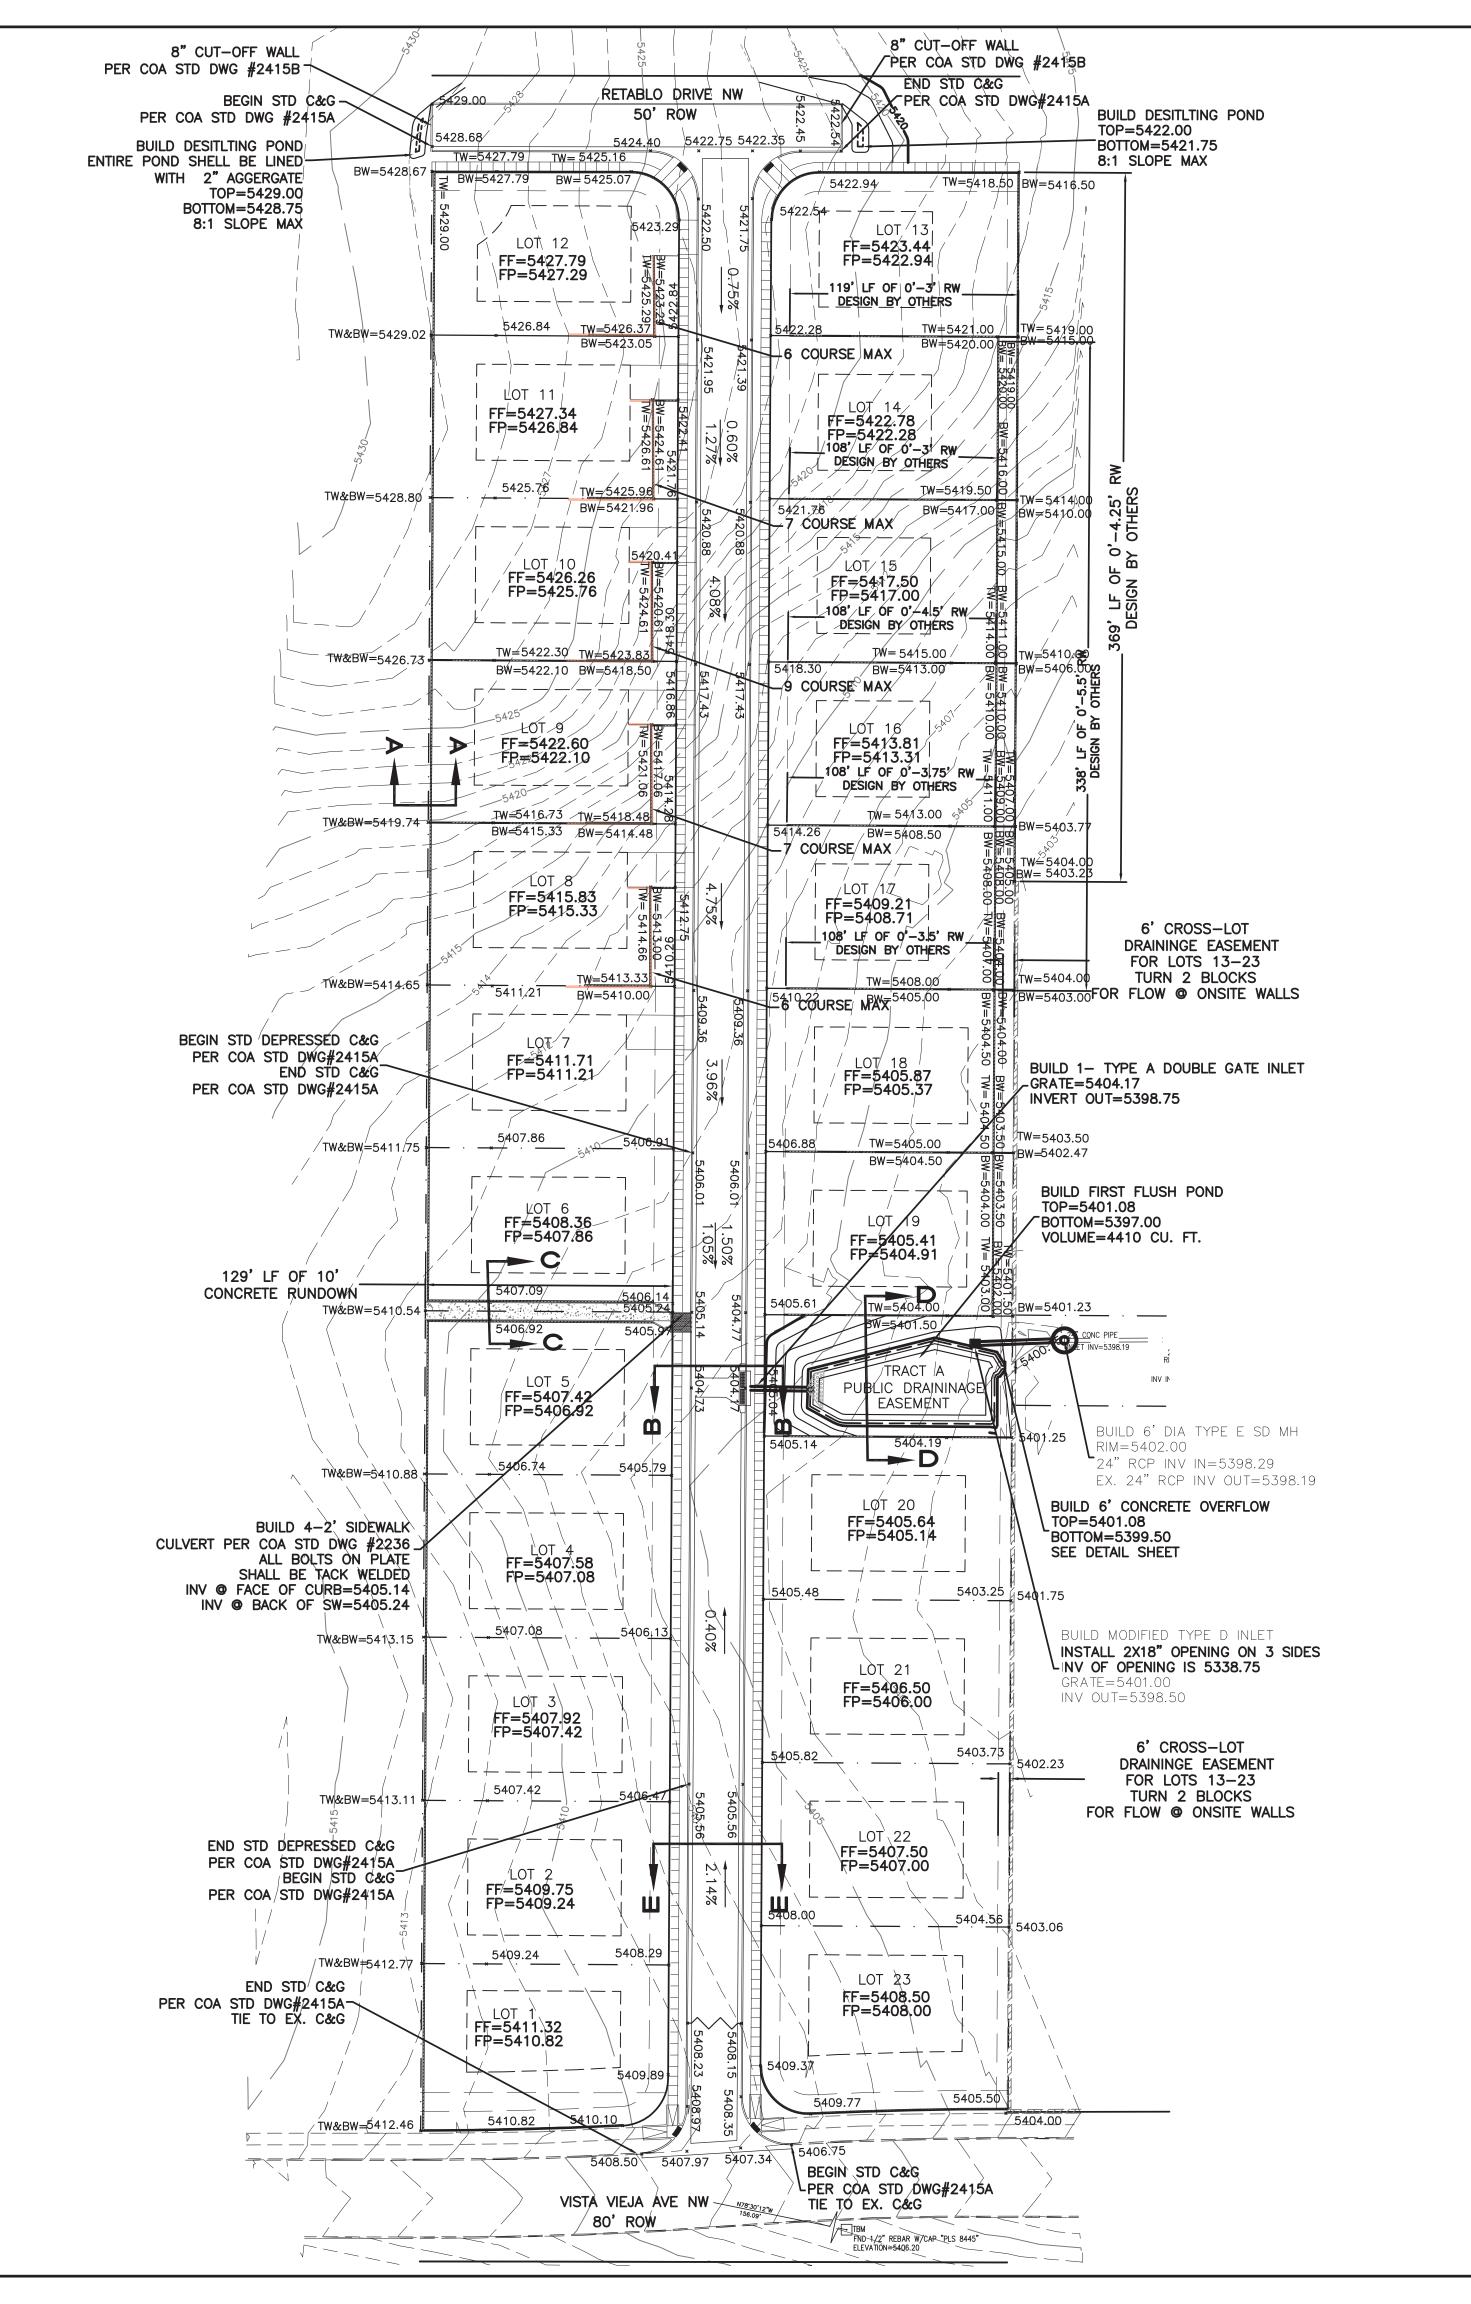

CAUTION:

IMPROVEMENTS.

EXISTING UTILITIES ARE NOT SHOWN.

IT SHALL BE THE SOLE RESPONSIBILITY

OF THE CONTRACTOR TO CONDUCT ALL

NECESSARY FIELD INVESTIGATIONS PRIOR

TO ANY EXCAVATION TO DETERMINE THE

ACTUAL LOCATION OF UTILITIES & OTHER

### EROSION CONTROL NOTES:

1. CONTRACTOR IS RESPONSIBLE FOR OBTAINING A TOPSOIL DISTURBANCE PERMIT PRIOR TO BEGINNING WORK.

2. CONTRACTOR IS RESPONSIBLE FOR MAINTAINING RUN-OFF ON SITE DURING CONSTRUCTION.


3. CONTRACTOR IS RESPONSIBLE FOR CLEANING ALL SEDIMENT THAT GETS INTO EXISTING RIGHT-OF-WAY.

4. REPAIR OF DAMAGED FACILITIES AND CLEANUP OF SEDIMENT ACCUMULATIONS ON ADJACENT PROPERTIES AND IN PUBLIC FACILITIES IS THE

RESPONSIBILITY OF THE CONTRACTOR. NO DISTURBANCE IS PERMITTED TO THE ADJACENT MPOS AND THE CONTRACTOR MUST PREVENT SEDIMENT, EROSION, DEBRIS, AND ANY OTHER DAMAGE FROM OCCURRING

5. ALL EXPOSED EARTH SURFACES MUST BE PROTECTED FROM WIND AND WATER EROSION PRIOR TO FINAL ACCEPTANCE OF ANY PROJECT.

> **Development Review Services** HYDROLOGY SECTION **APPROVED** HydroTrans # \_\_\_\_\_

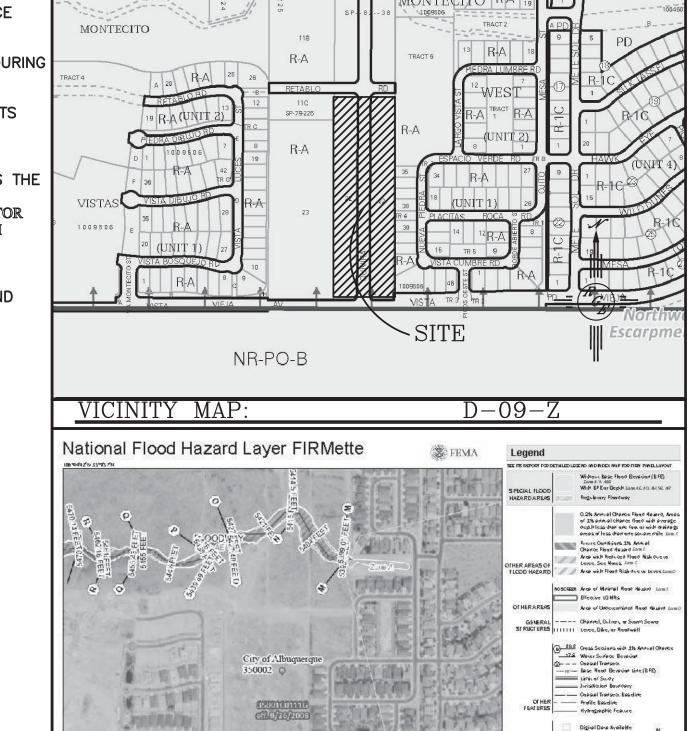

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### LEGAL DESCRIPTION:

FIRM MAP:

LOTS 1-23, AND TRACT A, QUIVIRA ESTATES

1. ALL SPOT ELEVATIONS REPRESENT FLOWLINE ELEVATION UNLESS OTHERWISE


2. ALL CURB AND GUTTER TO 6" HEADER UNLESS OTHERWISE


3. ALL RETAINING WALL DESIGN SHALL BE BY OTHERS.

4. ALL NEW PAVING SHALL BE 4" FLEXIBLE AC PAVING OVER 6" ABS OVER 12" SUBGRADE PREPARATION IN CONFORMANCE TO ACI 330R-08. UNLESS OTHERWISE


5. ANY CURBS OR PAVEMENT NEGATIVELY IMPACTED BY CONSTRUCTION ACTIVITY SHALL BE REPLACED TO MATCH EXISTING CONDITIONS.

6. ALL SITE WORK SHALL CONFORM TO CITY OF ALBUQUERQUE STANDARDS FOR PUBLIC WORKS CONSTRUCTION EDITION 9 LEGEND

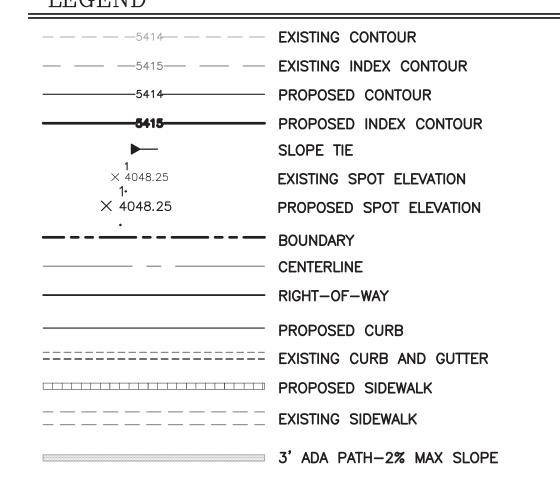


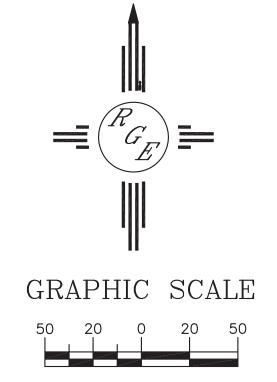


SCALE: 1"=50'

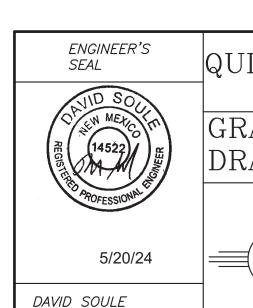


P.E. #14522

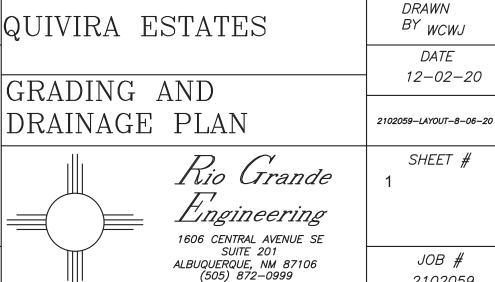


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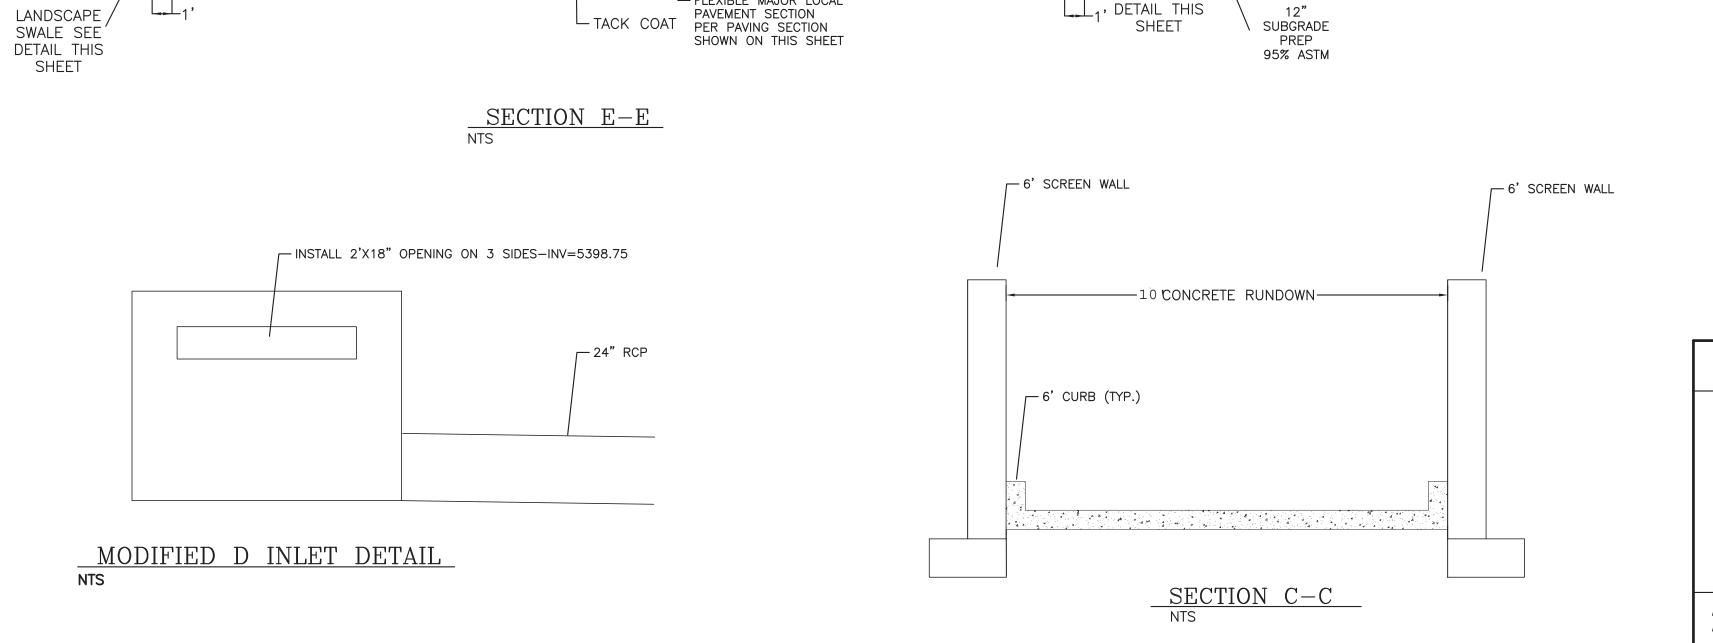


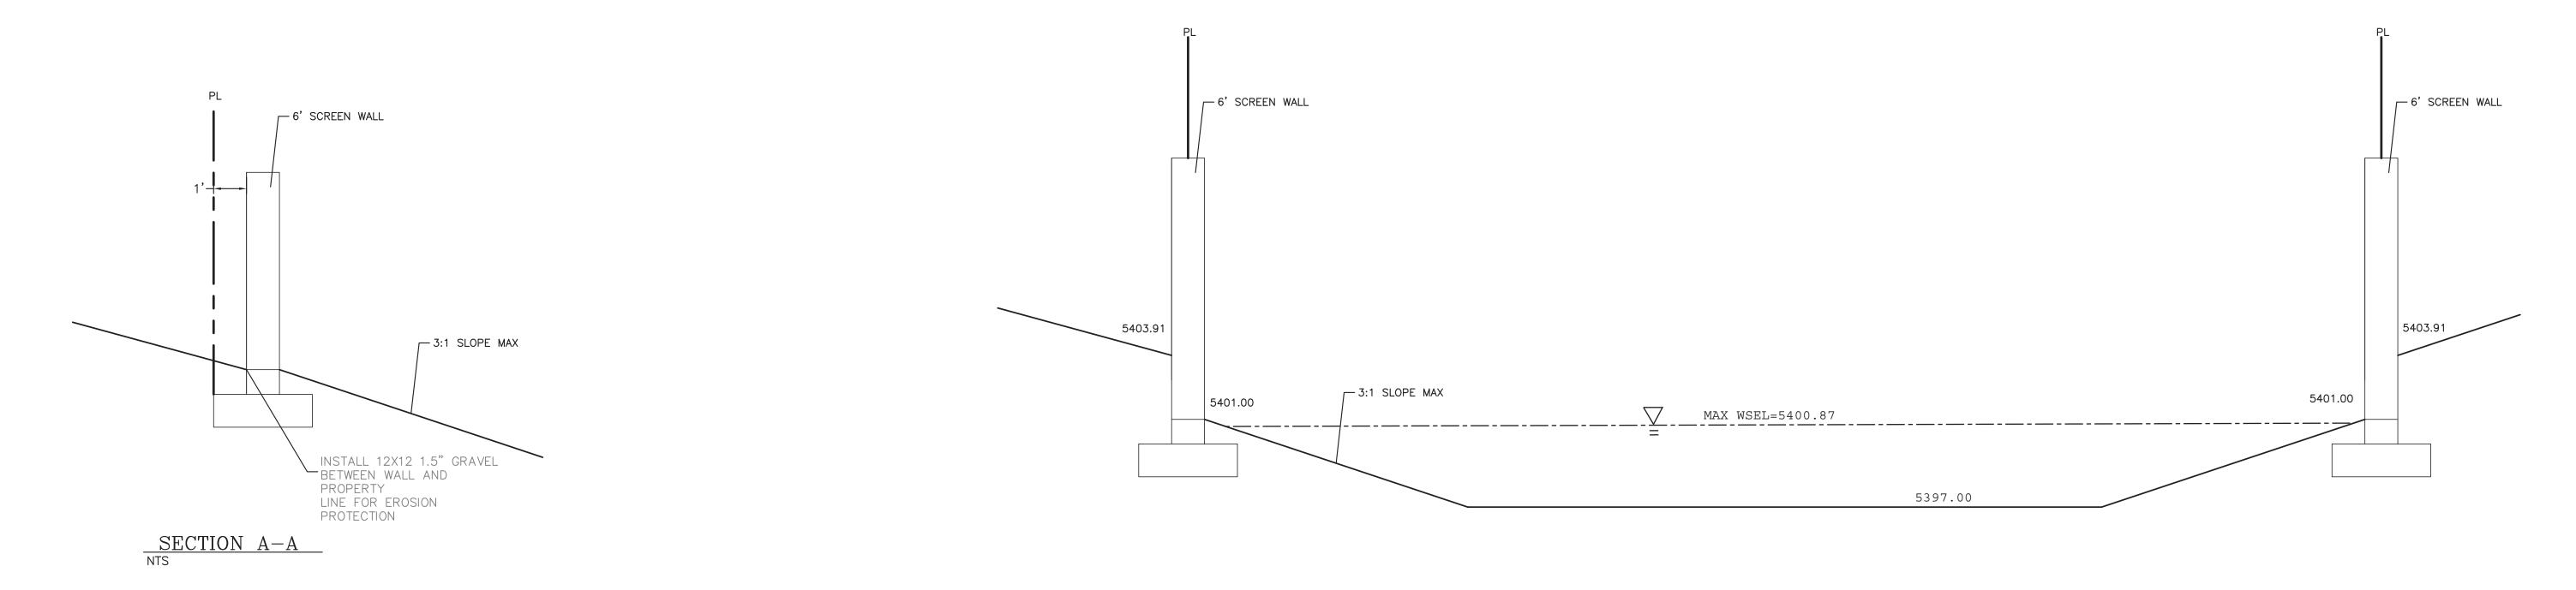
# SECTION D-D



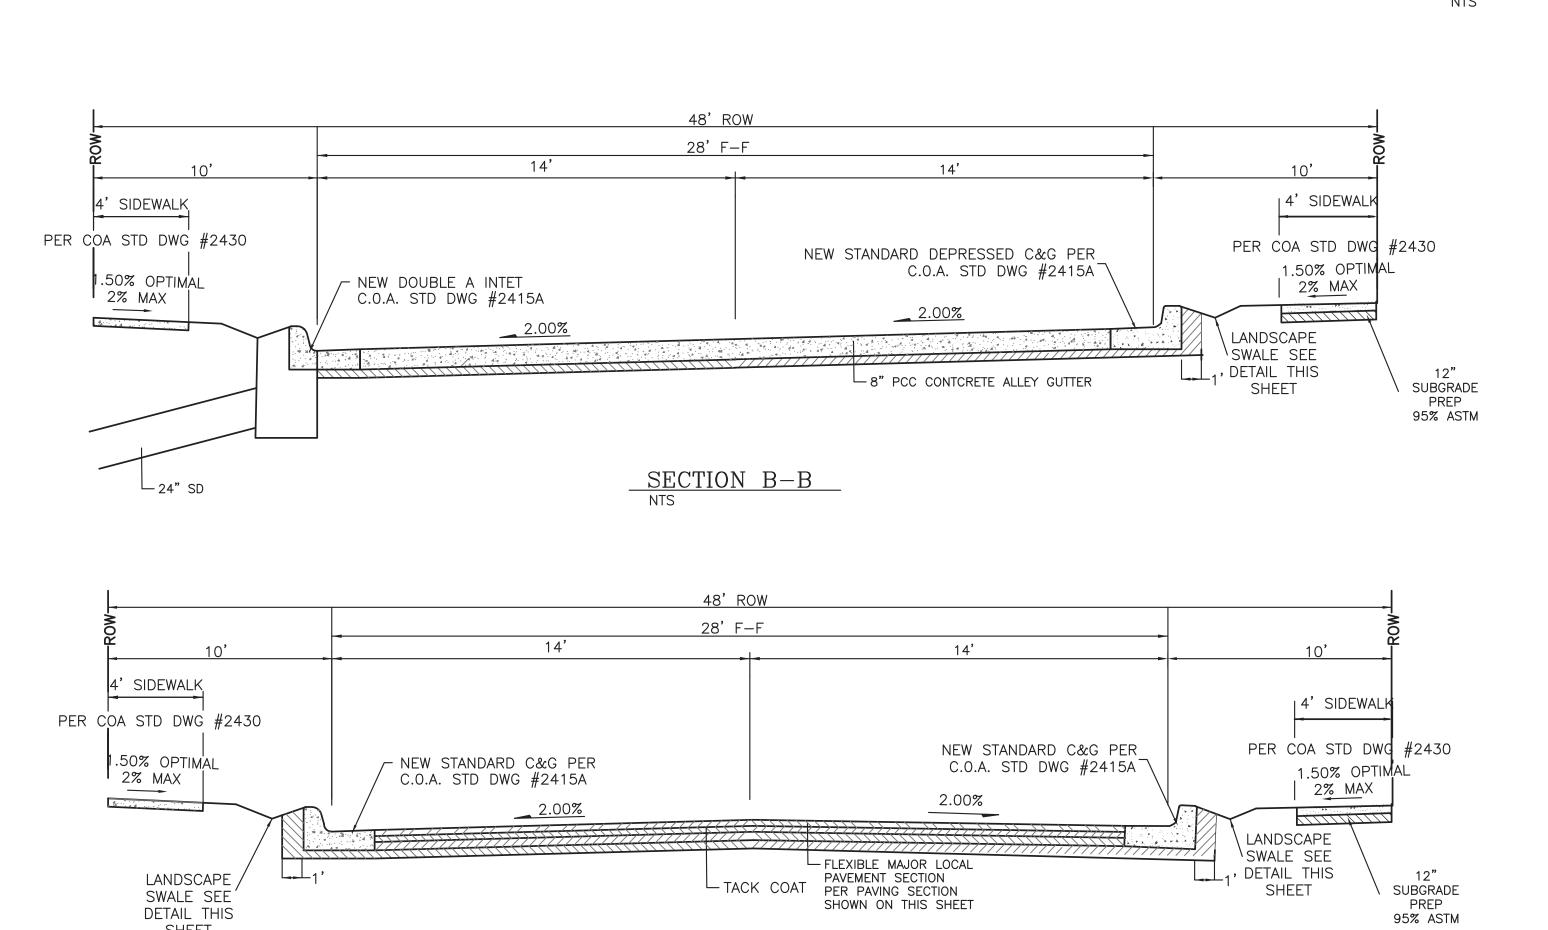

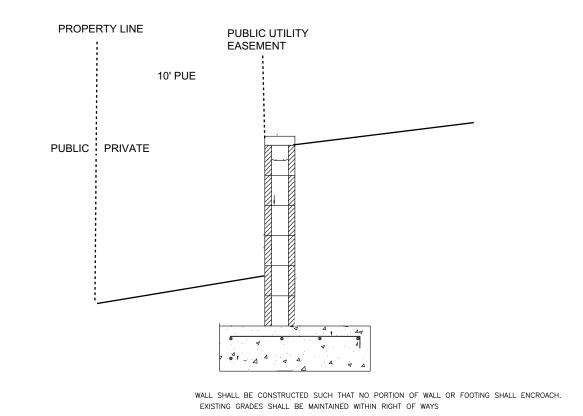WALL DETAIL FOR FRONT WALLS
PRIVATE SIDEWALLS MAY BE BUILT ON COMMON PROPERTY LINE



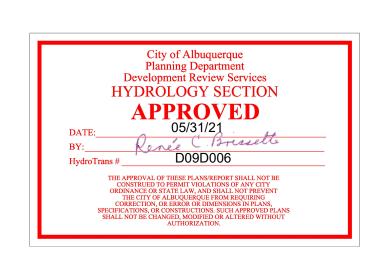

ENGINEER'S SEAL	QUIVIRA ESTATES	DRAWN BY WCWJ
DIND SOUTH	GRADING AND	DATE 12-02-20
PROFESSIONAL BY		2102059-LAYOUT-8-06-20
5/2/24		SHEET #
1/3/21	Engineering 1606 CENTRAL AVENUE SE	
DAVID SOULE P.E. #14522	SUITE 201 ALBUQUERQUE, NM 87106 (505) 872-0999	JOB # 2102059