
# CITY OF ALBUQUERQUE

Planning Department
Suzanne Lubar, Director

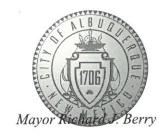

February 23, 2018

David Soule, P.E. Rio Grande Engineering PO Box 93924 Albuquerque, New Mexico 87199

RE: Lot 26 Block 6 Unit 22 Volcano Cliffs SAD 228 6209 Papagayo NW Grading and Drainage Plan Engineers Stamp Date 2/22/18 (D10D003B14)

Dear Mr. Soule,

PO Box 1293

Based upon the information provided in your submittal received 9/26/17, this plan cannot be approved for Grading Permit until the following comments are addressed.

Albuquerque

- Building Pad level too high.
- Show how runoff will make it to the pond.

NM 87103

If you have any questions, please contact me at 924-3986 or Rudy Rael at 924-3977.

www.cabq.gov

Sincerely,

James D Hughes, P.E.

Principal Engineer, Hydrology

Planning Department

RR/JDH C: File



## City of Albuquerque

#### Planning Department


#### Development & Building Services Division

#### DRAINAGE AND TRANSPORTATION INFORMATION SHEET (REV 09/2015)

Project Title:	Building Permit #: City Drainage #:
DRB#: EPC#:	
Legal Description:	
City Address:	
Engineering Firm:	Contact:
Address:	
Phone#: Fax#:	E-mail:
Owner:	Contact:
Address:	
Phone#: Fax#:	E-mail:
Architect:	Contact:
Address:	
Phone#: Fax#:	E-mail:
Other Contact:	Contact:
Address:	
Phone#: Fax#:	E-mail:
Check all that Apply:  DEPARTMENT:  HYDROLOGY/ DRAINAGE TRAFFIC/ TRANSPORTATION MS4/ EROSION & SEDIMENT CONTROL	CHECK TYPE OF APPROVAL/ACCEPTANCE SOUGHT:BUILDING PERMIT APPROVALCERTIFICATE OF OCCUPANCY
TYPE OF SUBMITTAL:	PRELIMINARY PLAT APPROVAL
X ENGINEER/ ARCHITECT CERTIFICATION ***	SITE PLAN FOR SUB'D APPROVAL
	SITE PLAN FOR BLDG. PERMIT APPROVAL
CONCEPTUAL G & D PLAN	FINAL PLAT APPROVAL
GRADING PLAN	SIA/ RELEASE OF FINANCIAL GUARANTEE
DRAINAGE MASTER PLAN	FOUNDATION PERMIT APPROVAL
DRAINAGE REPORT	GRADING PERMIT APPROVAL
CLOMR/LOMR	SO-19 APPROVAL
TRAFFIC CIRCULATION LAYOUT (TCL)	PAVING PERMIT APPROVAL
TRAFFIC IMPACT STUDY (TIS)	GRADING/ PAD CERTIFICATION  WORK ORDER APPROVAL
EROSION & SEDIMENT CONTROL PLAN (ESC)	CLOMR/LOMR
	CEOWIN EOWIN
OTHER (SPECIFY)	PRE-DESIGN MEETING
	OTHER (SPECIFY)
IS THIS A RESUBMITTAL?: Yes No	
	_By:

AND A PAD CERT FOR NEW PLAN

### Weighted E Method 100-Year, 6-hr. Area Area Treatment A Treatment B Treatment C Treatment DWeighted Volume Flow (acres) % (acres) % (acres) % (acres) % (acres) (ac-ft) | 25861.00 | 0.594 | 0% | 0 | 10% | 0.059 | 40% | 0.2375 | 50% | 0.297 | 1.448 | 0.072 | 13730.00 | 0.315 | 0% | 0 | 10% | 0.032 | 40% | 0.1261 | 50% | 0.158 | 1.448 | 0.038 | 13730.00 | 0.315 | 0% | 0 | 30% | 0.095 | 42% | 0.1324 | 28% | 0.088 | 1.168 | 0.031 | ALLOWED PROPOSED **Equations:** Weighted E = Ea\*Aa + Eb\*Ab + Ec\*Ac + Ed\*Ad / (Total Area) Volume = Weighted D \* Total Area Flow = Qa \* Aa + Qb \* Ab + Qc \* Ac + Qd \* Ad Where for 100-year, 6-hour storm-zone 1 Qa= 1.29 Ea= 0.44 Eb= 0.67 Qb= 2.03 Ec= 0.99 Qc= 2.87 Ed= 1.97 Qd= 4.37 **ONSITE Conditions** FIRST FLUSH WATER QUALITY VOLUME REQUIRED PROVIDED (CF) 1556 WATER QUALITY Narrative This site is within the SAD 228 Master Drainage plan boundaries. The site is designed to drain the front portion to the streat and there rear port to the national monument. The drainage divide is in accordance to the master drainage plan basin lines. The site is impacted by the upland flo the amount of 2.1 cfs. The site will pond in excess of the first flush volume required. This plan is in conformance to the master drainage plan

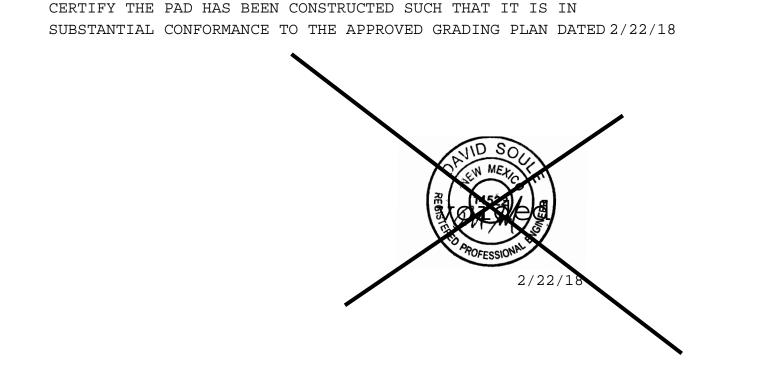

BUILD FIRST FLUSH POND

TOP=5305.71


I, DAVID SOULE HAVE PERSONALLY INPECTED THE SITE. I HEREBY


R=277.09

L=102.30

## EROSION CONTROL NOTES:

- 1. CONTRACTOR IS RESPONSIBLE FOR OBTAINING A TOPSOIL DISTURBANCE PERMIT PRIOR TO BEGINNING WORK.
- 2. CONTRACTOR IS RESPONSIBLE FOR MAINTAINING RUN-OFF ON SITE DURING CONSTRUCTION.
- 3. CONTRACTOR IS RESPONSIBLE FOR CLEANING ALL SEDIMENT THAT GETS INTO EXISTING RIGHT-OF-WAY.
- 4. REPAIR OF DAMAGED FACILITIES AND CLEANUP OF SEDIMENT ACCUMULATIONS ON ADJACENT PROPERTIES AND IN PUBLIC FACILITIES IS THE RESPONSIBILITY OF THE CONTRACTOR.
- 5. ALL EXPOSED EARTH SURFACES MUST BE PROTECTED FROM WIND AND WATER EROSION PRIOR TO FINAL ACCEPTANCE OF ANY PROJECT.

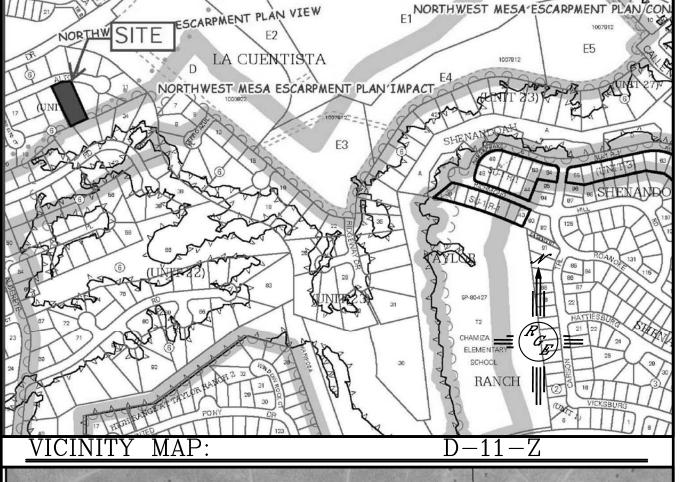

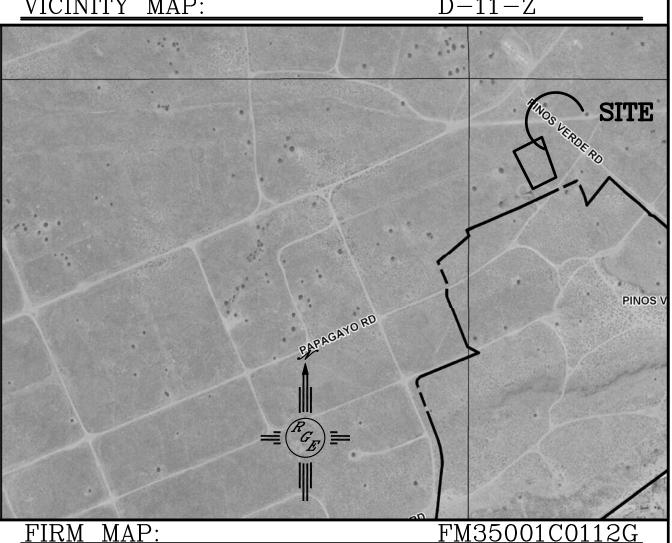

LEGAL DESCRIPTION:

Lot 14, Block 6, Volcano Cliffs Unit 22

### NOTES:


- 1. ALL SPOT ELEVATIONS REPRESENT FLOWLINE ELEVATION UNLESS OTHERWISE
- 2. ALL SLOPES SHALL BE 3:1 MAX. AND GRAVEL OR NATIVE SEEDING
- 3. A PAD CERTIFICATION IS REQUIRED PRIOR TO RELEASE OF BUILDING
- 4. ANY PERIMETER WALLS SHALL BE CONSTRUCTED UNDER A SEPARATE BUILDING PERMIT AND MUST CONFORM TO THE APPROVED GRADING PLAN ALLOWING CROSS LOT DRAINAGE
- 5. FINISHED PAD ELEVATION PROVIDED BY CONTRACTOR AT OWNERS REQUEST. ANY POTENTIAL TOTAL BUILDING HEIGHT LIMITATIONS ARE OUTSIDE OF THE SCOPE OF THIS GRADING PLAN

## LEGEND

SCALE: 1"=20'

	EXISTING CONTOUR
	EXISTING INDEX CONTOUR
XXXX	PROPOSED CONTOUR
<del></del>	PROPOSED INDEX CONTOUR
<b>-</b>	SLOPE TIE
× XXXX	EXISTING SPOT ELEVATION
* XXXX	PROPOSED SPOT ELEVATION
	BOUNDARY
	CENTERLINE
	RIGHT-OF-WAY
=========	EXISTING CURB AND GUTTER
***************************************	PROPOSED CMU SCREEN WALL

ENGINEER'S SEAL	6212 CAMINO ALTO CT NW WALTON RESIDENCE		DRAWN BY WCWJ
AUD SOU	WALION RESI	DENCE	DATE 2–22–18
PECSONNE PROFESSIONING	GRADING AND DRAINAGE PLAN		21844-LAYOUT-1-0
POFESSIONAL		Rio Grande	SHEET #
2/22/18		Ingineering  1606 CENTRAL AVENUE SE	_
DAVID SOULE P.E. #14522		SUITE 201 ALBUQUERQUE, NM 87106	JOB #
		(505) 872–0999	21844

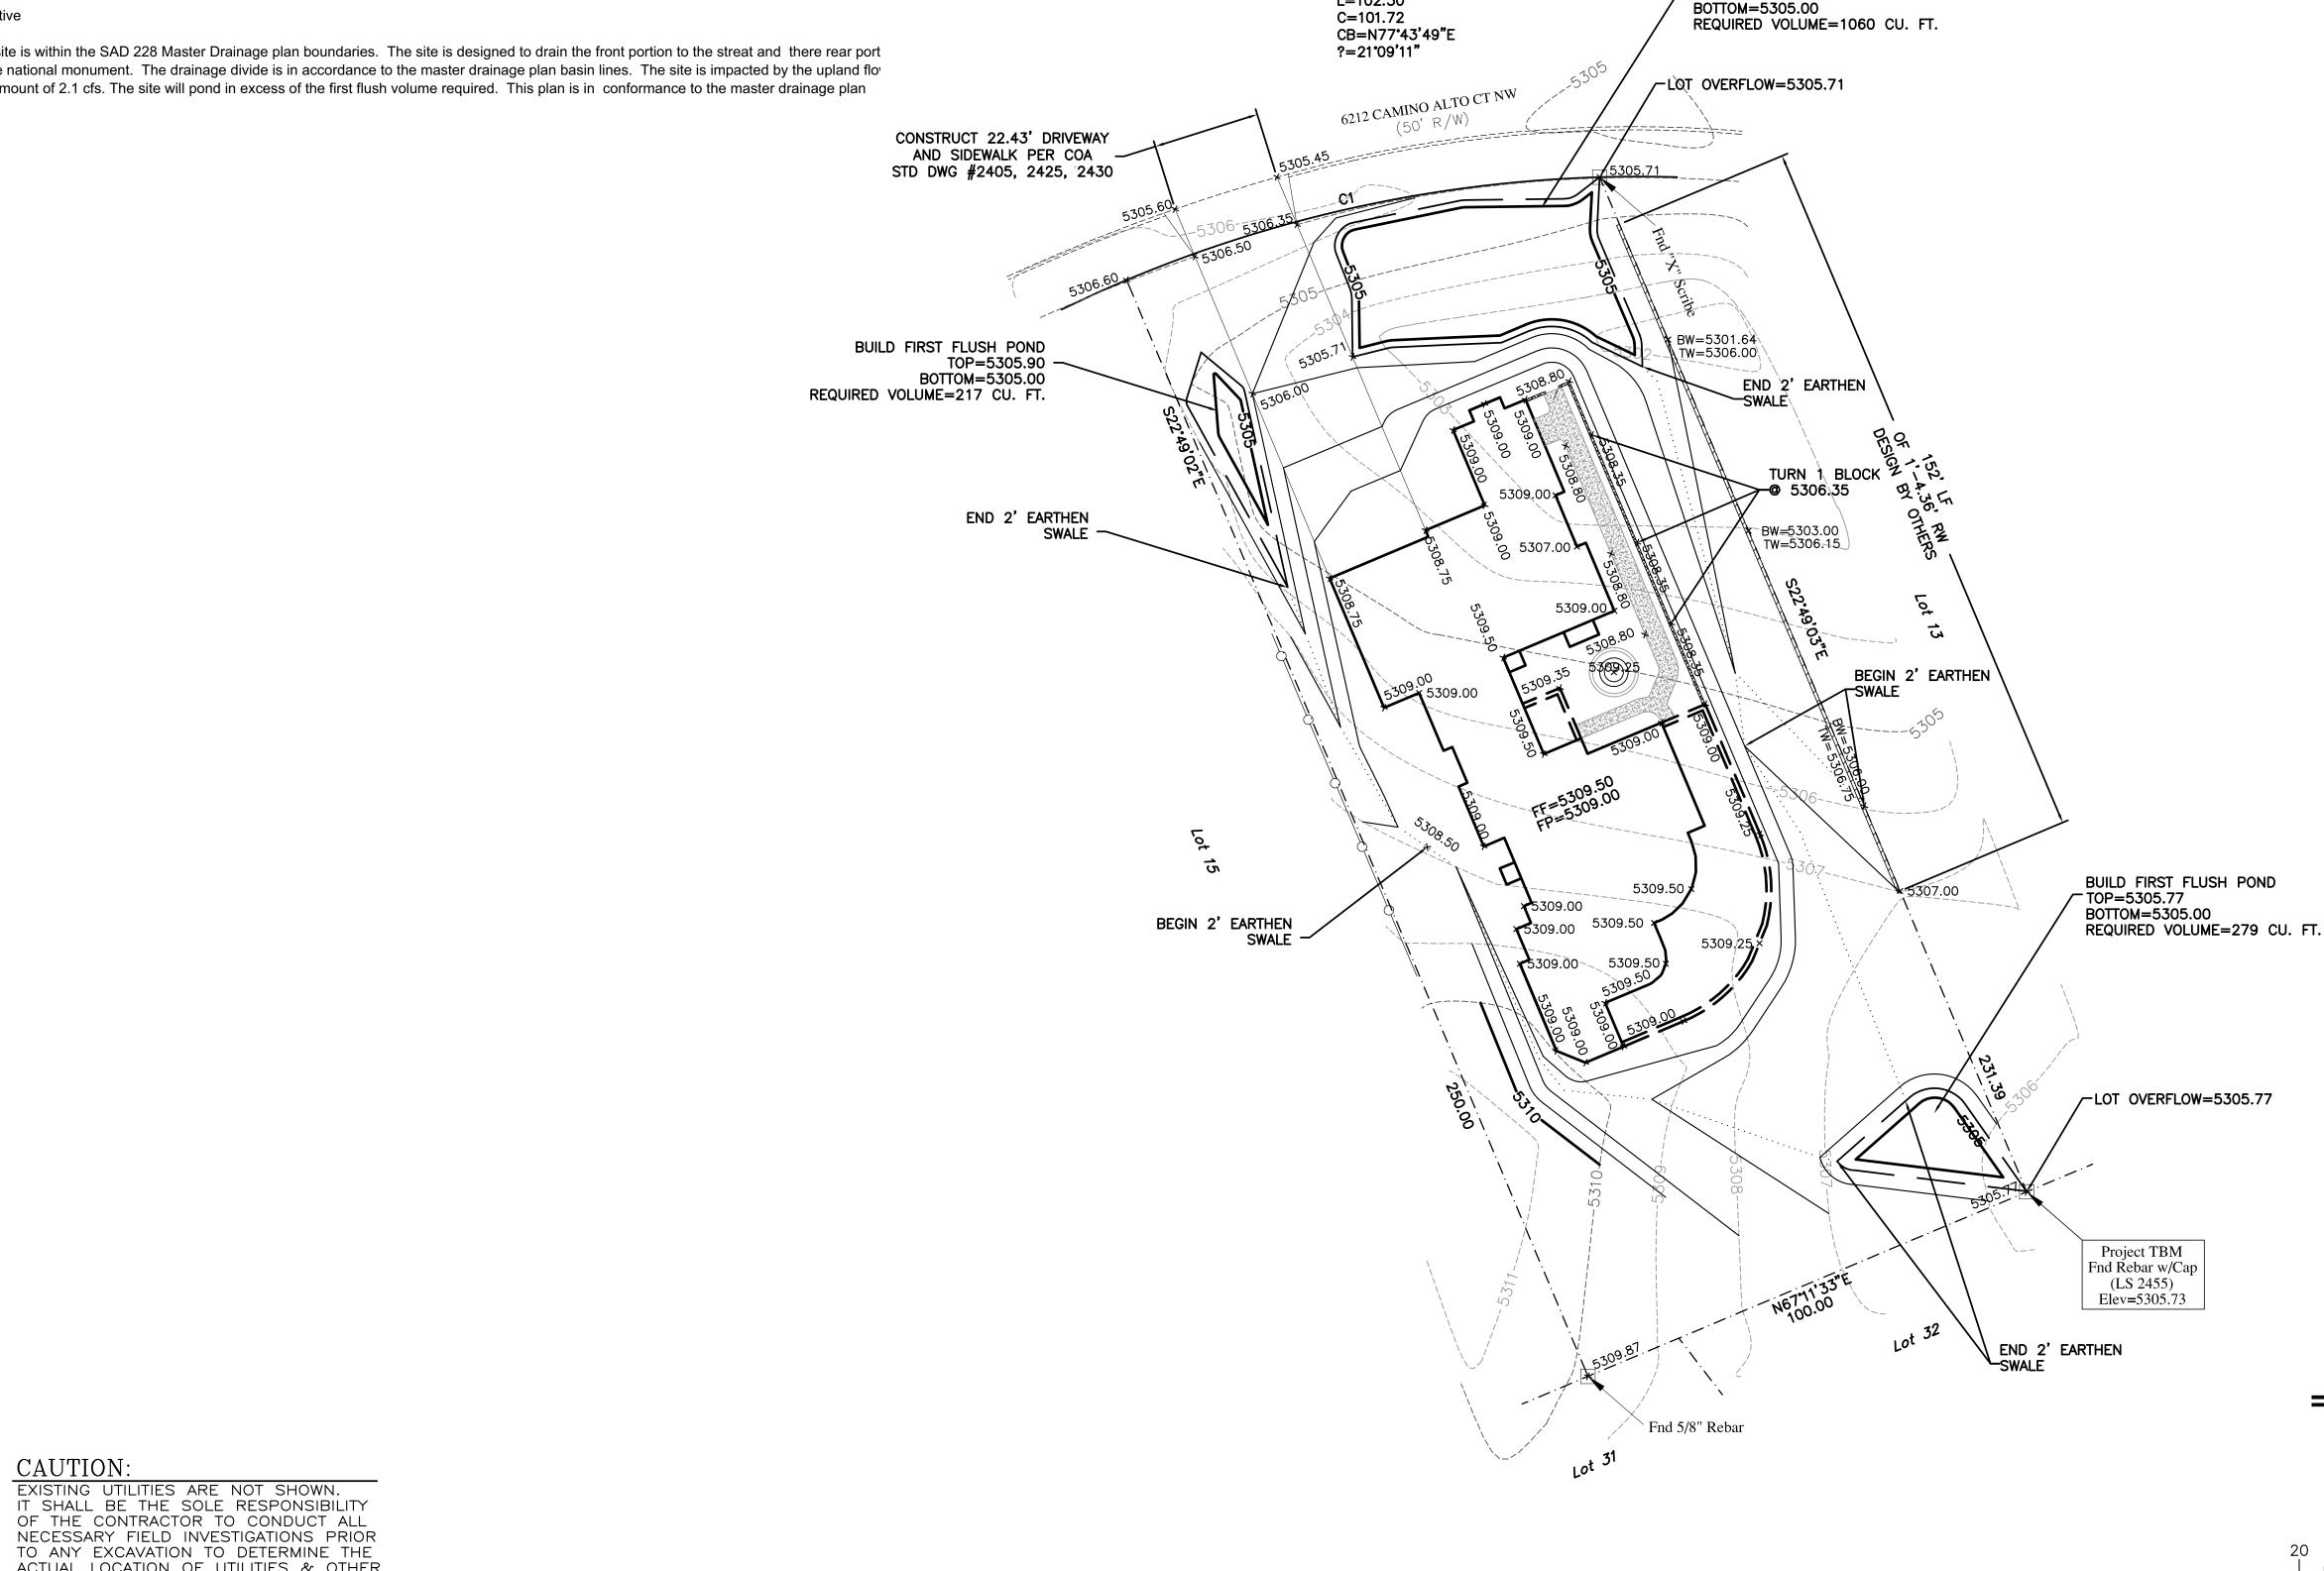

ACTUAL LOCATION OF UTILITIES & OTHER IMPROVEMENTS.