

Mayor Timothy M. Keller

March 30, 2022

David Soule, PE Rio Grande Engineering 1606 Central SE Suite 201 Albuquerque, NM 87106

RE: Lot 14 Block 2 Unit 22 SAD 228

6311 Camino Alto NW Volcano Cliffs Subdivision Grading and Drainage Plan

Engineers Stamp Date 8/20/2020 (D10D003C14)

Pad Cert. Date: 8/20/2020

PO Box 1293 **CO Certification Date: 3/7/2022**

Mr. Soule,

Albuquerque Based on the Certification received on 3/29/2022, the site is acceptable for release of

Certificate of Occupancy by Hydrology.

NM 87103

If you have any questions, you can contact me at 924-3986 or Rudy Rael at 924-3977.

www.cabq.gov

Sincerely,

Ernest Armijo, P.E.

Principal Engineer, Planning Dept. Development Review Services



City of Albuquerque

Planning Department

Development & Building Services Division

DRAINAGE AND TRANSPORTATION INFORMATION SHEET (REV 6/2018)

Project Title: 6311 CAMINO ALTO N	W Building Permit #:	Hydrology	File #:						
		· · · · · · · · · · · · · · · · · · ·							
DRB#: Legal Description: LOT 14 BLOCK	2VOLCANO CLIFFS	UNIT 22							
City Address: 6311 CAMINO ALTO	NW								
Applicant:		Contact:							
Address:									
Phone#:									
Other Contact: RIO GRANDE ENGIN									
Address: PO BOX 93924 ALB NM			··						
Phone#: 505.321.9099		E-mail: david	d@riograndeengineering.com						
TYPE OF DEVELOPMENT: PLAT									
Check all that Apply:									
DEPARTMENT:	ТҮРЕ (OF APPROVAL/ACCEPTA	NCE SOUGHT:						
X HYDROLOGY/ DRAINAGE TRAFFIC/ TRANSPORTATION	X BI	JILDING PERMIT APPROVA	AL						
TRAFFIC/ TRANSFORTATION	CI	ERTIFICATE OF OCCUPANO	F OCCUPANCY						
TYPE OF SUBMITTAL:									
ENGINEER/ARCHITECT CERTIFICATIO	N PF	PRELIMINARY PLAT APPROVAL							
PAD CERTIFICATION	SI	SITE PLAN FOR SUB'D APPROVAL SITE PLAN FOR BLDG. PERMIT APPROVAL FINAL PLAT APPROVAL							
CONCEPTUAL G & D PLAN	SI								
XX GRADING PLAN	FI								
DRAINAGE REPORT									
DRAINAGE MASTER PLAN	SI	A/ RELEASE OF FINANCIA	L GUARANTEE						
FLOODPLAIN DEVELOPMENT PERMIT	APPLICFC	FOUNDATION PERMIT APPROVAL							
ELEVATION CERTIFICATE	GI	GRADING PERMIT APPROVAL							
CLOMR/LOMR	SC	0-19 APPROVAL							
TRAFFIC CIRCULATION LAYOUT (TCI	PA	VING PERMIT APPROVAI							
TRAFFIC IMPACT STUDY (TIS)	I	RADING/PAD CERTIFICAT	ΓΙΟΝ						
STREET LIGHT LAYOUT	W	ORK ORDER APPROVAL							
OTHER (SPECIFY)	CI	OMR/LOMR							
PRE-DESIGN MEETING?	FI	FLOODPLAIN DEVELOPMENT PERMIT							
IS THIS A RESUBMITTAL?: YesXX _	O7	THER (SPECIFY)							
DATE SUBMITTED:	*	* *************************************							
COA STAFF:	ELECTRONIC SUBMITTAL F	ECEIVED:							

Weighted E Method

									100-Year, 6-hr.			24 hour		
Basin	Area	Area	Treat	ment A	Treat	ment B	Treati	ment C	Treat	ment D	Weighted E	Volume	Flow	Volume
	(sf)	(acres)	%	(acres)	%	(acres)	%	(acres)	%	(acres)	(ac-ft)	(ac-ft)	cfs	(ac-ft)
ALLOWED	16247.00	0.373	0%	0	20%	0.075	46%	0.1716	34%	0.127	1.259	0.039	1.20	0.044
PROPOSED	16247.00	0.373	0%	0	20%	0.075	54%	0.2014	26%	0.097	1.181	0.037	1.15	0.040
COMPARISON							-	2	· 2			-0.002		-0.004

Weighted E = Ea*Aa + Eb*Ab + Ec*Ac + Ed*Ad / (Total Area)

Volume = Weighted D * Total Area

Flow = Qa * Aa + Qb * Ab + Qc * Ac + Qd * Ad

Where for 100-year, 6-hour storm-zone 1

Qa= 1.29 Eb= 0.67 Qb= 2.03 Ec= 0.99 Qc= 2.87 Ed= 1.97 Qd= 4.37

ONSITE Conditions

FIRST FLUSH WATER QUALITY VOLUME

PROVIDED (CF) 844

WATER QUALITY FLOOD CONTROL

Narrative

This site is within the SAD 228 Master Drainage plan boundaries. The site is to maintain existing patterns and drain to the adjacent roadway to the south per the master drainage plan. The site does not exceed the SAD 228 developed conditions assumptions,

Due to existing grades being lower in the roadways retention pond is proposed. We are ponding the water harvest volume generated by the site.

This plan is in conformance to the master drainage plan

I, DAVID SOULE HAVE PERSONALLY INPECTED THE SITE. I HEREBY CERTIFY THE PAD HAS BEEN CONSTRUCTED SUCH THAT IT IS IN SUBSTANTIAL CONFORMANCE TO THE APPROVED GRADING PLAN DATED 8/20/20 BASED UPON APPROVAL FROM DESIGN ENGINEER THE PAD HAS BEEN CONSTRUCTED 5" HIGHER THE DRAINAGE CONCEPT HAS NOT CHANGED. I CERTIFY THE PAD IS AT A GRADE THAT CONFORMS TO THE APPROVED PLAN AND ACCEPTABLE FOR RELEASE OF BUILDING PERMIT



EROSION CONTROL NOTES:


1. CONTRACTOR IS RESPONSIBLE FOR OBTAINING A TOPSOIL DISTURBANCE PERMIT PRIOR TO BEGINNING WORK.

2. CONTRACTOR IS RESPONSIBLE FOR MAINTAINING RUN-OFF ON SITE DURING CONSTRUCTION.


3. CONTRACTOR IS RESPONSIBLE FOR CLEANING ALL SEDIMENT THAT GETS INTO EXISTING RIGHT-OF-WAY.

4. REPAIR OF DAMAGED FACILITIES AND CLEANUP OF SEDIMENT ACCUMULATIONS ON ADJACENT PROPERTIES AND IN PUBLIC FACILITIES IS THE RESPONSIBILITY OF THE CONTRACTOR.

5. ALL EXPOSED EARTH SURFACES MUST BE PROTECTED FROM WIND AND WATER EROSION PRIOR TO FINAL ACCEPTANCE OF ANY PROJECT.

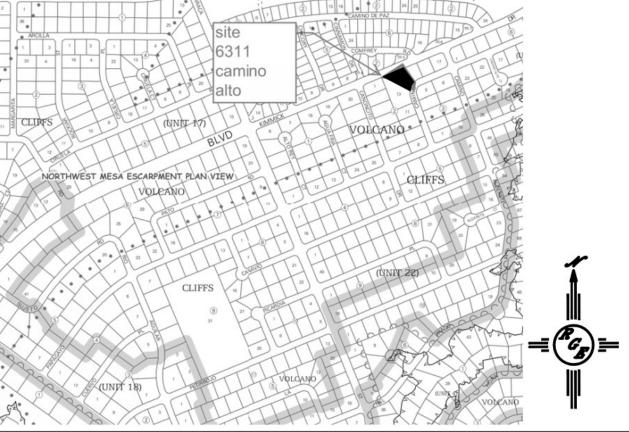

VICINITY MAP: D-10-Z

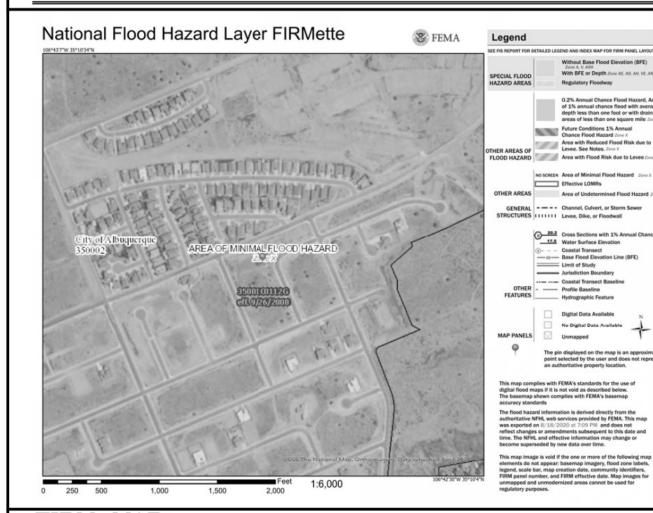

FIRM MAP:

LEGAL DESCRIPTION:

LOT 14, BLOCK 2 UNIT 22 VOLCANO CLIFFS CITY OF ALBUQUERQUE, BERNALILLO COUNTY, NEW MEXICO

1. ALL SPOT ELEVATIONS REPRESENT FLOWLINE ELEVATION UNLESS OTHERWISE NOTED


2. ALL SLOPES SHALL BE 3:1 MAX. AND GRAVEL OR NATIVE SEEDING PRIOR TO CO.

3. ANY PERIMETER WALLS MUST BE PERMITED SEPARATELY. ALL RETAINING WALL DESIGN SHALL BE BY OTHERS.

4. SURVEY INFORMATION PROVIDED BY COMMUNITY SCIENCES CORPORATION USING NAVD

5. A PAD ELEVATION CERTIFICATION SHALL BE REQUIRED PRIOR TO RELEASE OF BUILDING

LEGEND

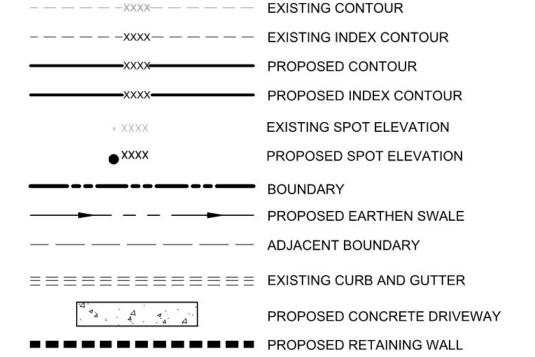

SCALE: 1"=20'

SEAL

GRADING AND

DRAINAGE PLAN LOT 14, BLK 2 UN 22 VC.DWG SHEET# Nio Grande Lingineering 8/20/20 1606 CENTRAL AVENUE SE JOB# ALBUQUERQUE, NM 87106 DAVID SOULE P.E. #14522

LOT 14 BLK 2 U 22 VC

6311 CAMINO ALTO NW

DRAWN BY DEM


DATE

8-19-20

I <u>David Soule</u>, NMPE 14522, of the firm <u>Rio Grande Engineering</u>, hereby certify that this project has been graded and will drain in substantial compliance with and in accordance with the design intend of the approved plan dated 8/20/20 . The record information edited on the original design document has performed by me or under my direct supervision and is true and correct to the best of my knowledge and belief. The asbuilt survey was provided by LORENZO DOMINGUEZ NMPLS 10461 submitted in support of a request for <u>PERMANENT CERTIFICATE OF OCCUPANCY</u>. The record information presented heron is not necessarily complete and intended only to verify substantial compliance of the grading and drainage aspects of this project. Those relying on this record document are advised to obtain independent verification of its accuracy before using it for any other purpose



3/7/22

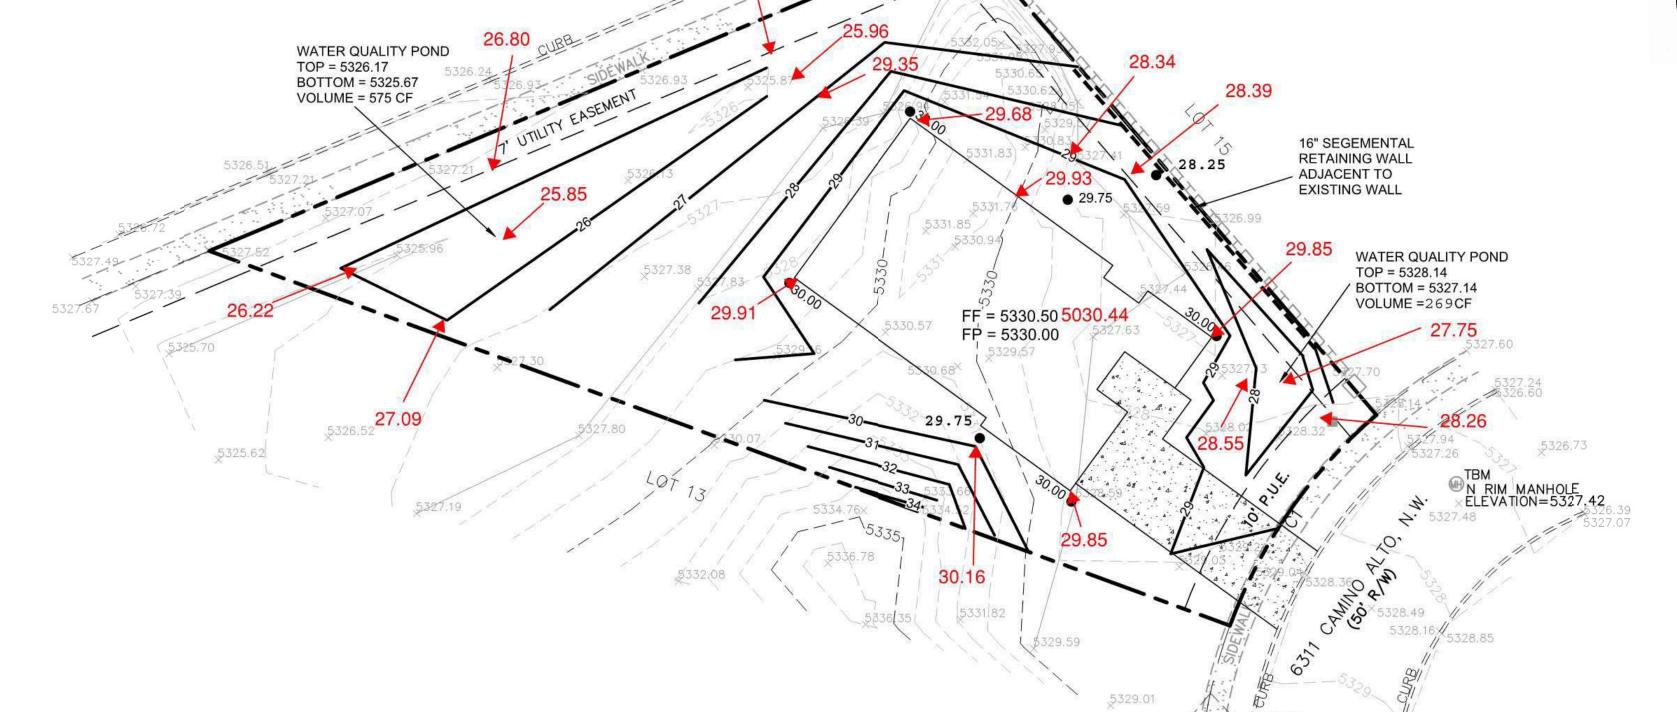

TURN 1 BLOCK

CAUTION:

EXISTING UTILITIES ARE NOT SHOWN. IT SHALL BE THE SOLE RESPONSIBILITY OF THE CONTRACTOR TO CONDUCT ALL **NECESSARY FIELD INVESTIGATIONS PRIOR** TO ANY EXCAVATION TO DETERMINE THE **ACTUAL LOCATION OF UTILITIES & OTHER** IMPROVEMENTS.

