CITY OF ALBUQUERQUE

Planning Department Suzanne Lubar, Director



February 15, 2017

David Soule, P.E. Rio Grande Engineering PO Box 93924 Albuquerque, New Mexico 87199

RE: Lot 2 Block 2 Unit 22 Volcano Cliffs SAD 228

8020 Canoncito Dr. NW Grading and Drainage Plan Engineers Stamp Date 2/13/17 (D10D003C2)

Dear Mr. Soule,

Based upon the information provided in your submittal received 2/13/17, this plan is approved for Grading Permit. Prior to building permit approval, a pad certification will be required. A hold on the property will be placed until this certification has been approved.

PO Box 1293 Please inform the builder/owner to attach a copy of this approved plan to the construction

sets in the permitting process prior to sign-off by Hydrology. Reiterate to the

Owner/Contractor that a separate permit for a garden wall must be obtained, with the

approved G&D plan dated 2/13/17.

Prior to Certificate of Occupancy release, Engineer Certification per the DPM checklist of

this plan will be required.

New Mexico 87103

If you have any questions, please contact me at 924-3999 or Rudy Rael at 924-3977.

www.cabq.gov

Albuquerque

Sincerely,

Shahab Biazar, P.E.

City Engineer, Albuquerque

Planning Department

RR/SB C: File



City of Albuquerque

Planning Department

Development & Building Services Division

DRAINAGE AND TRANSPORTATION INFORMATION SHEET (REV 09/2015)

roject Title:		Building Permit #:	City Drainage #:				
P.P.P. "			k Order#:				
Legal Description:							
City Address:							
Engineering Firm:		Cont	act:				
Address:							
Phone#:	Fax#:	E-ma	ail:				
Owner:		Cont	act:				
Address:							
Phone#:	Fax#:	E-ma	ail:				
Architect:		Cont	act:				
Address:							
Phone#:	Fax#:	E-ma	ail:				
Other Contact:		Cont	act:				
Address:							
Phone#:	Fax#:	E-ma	ail:				
Check all that Apply: DEPARTMENT: HYDROLOGY/ DRAINAGE			ROVAL/ACCEPTANCE SOUGHT:				
TRAFFIC/ TRANSPORTATION		BUILDING PERMI					
MS4/ EROSION & SEDIMENT CO	NTROL	CERTIFICATE OF	OCCUPANCY				
TYPE OF SUBMITTAL:		PRELIMINARY PI	AT APPROVAL				
ENGINEER/ ARCHITECT CERTIFICATION			SITE PLAN FOR SUB'D APPROVAL				
		SITE PLAN FOR B	SITE PLAN FOR BLDG. PERMIT APPROVAL				
CONCEPTUAL G & D PLAN		FINAL PLAT APP	ROVAL				
GRADING PLAN		SIA/ RELEASE OF	FINANCIAL GUARANTEE				
DRAINAGE MASTER PLAN		FOUNDATION PE	RMIT APPROVAL				
DRAINAGE REPORT		GRADING PERMI	GRADING PERMIT APPROVAL				
CLOMR/LOMR		SO-19 APPROVAL	SO-19 APPROVAL				
		PAVING PERMIT					
TRAFFIC CIRCULATION LAYOU	Γ (TCL)		APPROVAL				
TRAFFIC CIRCULATION LAYOUT TRAFFIC IMPACT STUDY (TIS)	Γ (TCL)	PAVING PERMIT	APPROVAL ERTIFICATION				
		PAVING PERMIT GRADING/ PAD C	APPROVAL ERTIFICATION				
TRAFFIC IMPACT STUDY (TIS)	L PLAN (ESC)	PAVING PERMIT GRADING/ PAD C WORK ORDER APP	APPROVAL ERTIFICATION ROVAL				
TRAFFIC IMPACT STUDY (TIS) EROSION & SEDIMENT CONTRO	L PLAN (ESC)	PAVING PERMIT GRADING/ PAD C WORK ORDER APP CLOMR/LOMR PRE-DESIGN MEET	APPROVAL ERTIFICATION ROVAL ING				
TRAFFIC IMPACT STUDY (TIS) EROSION & SEDIMENT CONTRO	L PLAN (ESC)	PAVING PERMIT GRADING/ PAD C WORK ORDER APP CLOMR/LOMR PRE-DESIGN MEET	APPROVAL ERTIFICATION ROVAL				
TRAFFIC IMPACT STUDY (TIS) EROSION & SEDIMENT CONTRO OTHER (SPECIFY)	L PLAN (ESC)	PAVING PERMIT GRADING/ PAD C WORK ORDER APP CLOMR/LOMR PRE-DESIGN MEET OTHER (SPECIFY	APPROVAL ERTIFICATION ROVAL ING				

COA STAFF: ELECTRONIC SUBMITTAL RECEIVED: ____

Rudy Rael Hydrology Section City of Albuquerque 600 2nd street NW Albuquerque, NM 87102

RE: Grading plan resubmittal (D10D0003C2) 8020 Canoncito NW

Dear Mr. Real:

Rio Grande Engineering has revised the enclosed grading plan to address written comments from Shahab Biazar dated 2/7/17. The following is summary of the comment and an explanation as to how it was addressed

1. Place turned blocks within the rear 10' PUE

We have moved the blocks.

2. Show 10' PUE and place swale 1' away from wall

The existing grades do not lend themselves to place swale at the requested location.

We have forced the entry and exit point to that location but to place swale will required too much

- fill. The water will enter and leave at the prescribed locations
- 3. Place elevation at turned blocks

We have added

4. Provide statement regarding pad certification

This has been added as note #4

5. Provide statement regarding block wall construction.

This was described in note #3

Should you have any questions regarding this matter, please do not hesitate to call me.

Sincerely,

David Soule, PE RIO GRANDE ENGINEERING PO Box 93924 ALBUQUERQUE, NM 87199 321-9099

Enclosures

Weighted E Method

												100-Year, 6	-nr.
Basin	Area	Area	Treat	ment A	Treat	ment B	Treat	ment C	Treatm	nent D	Weighted E	Volume	Flow
	(sf)	(acres)	%	(acres)	%	(acres)	%	(acres)	%	(acres)	(ac-ft)	(ac-ft)	cfs
NATIVE	14396.00	0.330	80%	0.2644	10%	0.033	10%	0.03305	0%	0.000	0.518	0.014	0.50
ALLOWED	14396.00	0.330	0%	0	10%	0.033	40%	0.13219	50%	0.165	1.448	0.040	1.17
PROPOSED	14396.00	0.330	0%	0	9%	0.030	33%	0.10906	39%	0.129	1.155	0.032	0.94
UPLAND	15998.00	0.367	0%	0	10%	0.037	40%	0.14691	50%	0.184	0.887	0.027	1.30
total													

Equations:

Weighted E = Ea*Aa + Eb*Ab + Ec*Ac + Ed*Ad / (Total Area)

Volume = Weighted D * Total Area

Flow = Qa * Aa + Qb * Ab + Qc * Ac + Qd * Ad

Where for 100-year, 6-hour storm- zone 1

Qa= 1.29 Qb= 2.03 Eb= 0.67 Ec= 0.99 Qc= 2.87 Ed= 1.97


ONSITE Conditions

FIRST FLUSH WATER QUALITY VOLUME

PROVIDED REQUIRED (CF) WATER QUALITY 800

Narrative

This site is within the SAD 228 Master Drainage plan boundaries. The site is to maintain existing drainage patterns Due to the existing elevations, discharge to the street is not practical. The draina plan will maintain existing patters we are allowing the minor upland flow to pass thru the site. This plan has a shallow water harvest pond per the drainage regulati This plan is in conformance to the masterplan

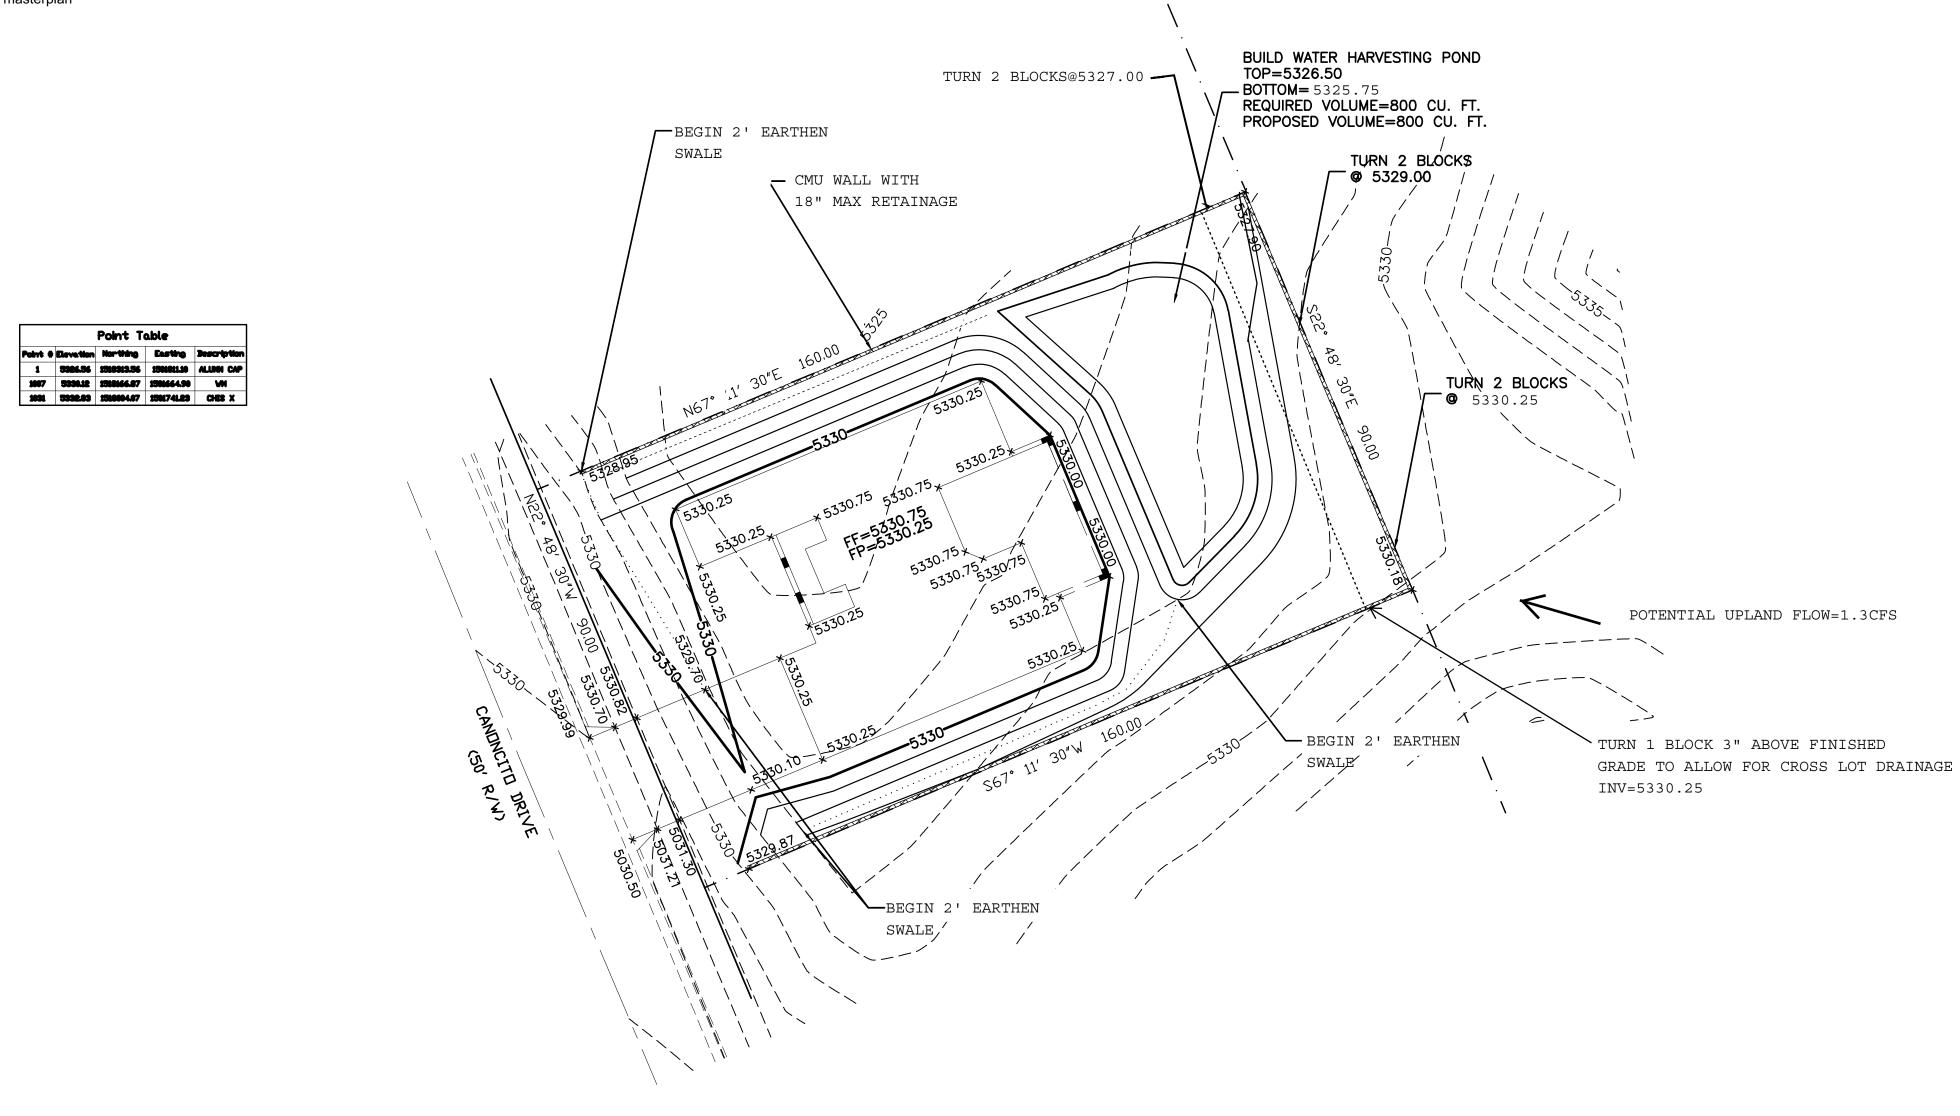


CAUTION: EXISTING UTILITIES ARE NOT SHOWN. IT SHALL BE THE SOLE RESPONSIBILITY
OF THE CONTRACTOR TO CONDUCT ALL
NECESSARY FIELD INVESTIGATIONS PRIOR
TO ANY EXCAVATION TO DETERMINE THE ACTUAL LOCATION OF UTILITIES & OTHER IMPROVEMENTS.

EROSION CONTROL NOTES:

1. CONTRACTOR IS RESPONSIBLE FOR OBTAINING A TOPSOIL DISTURBANCE PERMIT PRIOR TO BEGINNING WORK.

- 2. CONTRACTOR IS RESPONSIBLE FOR MAINTAINING RUN-OFF ON SITE DURING CONSTRUCTION.
- 3. CONTRACTOR IS RESPONSIBLE FOR CLEANING ALL SEDIMENT THAT GETS INTO EXISTING RIGHT-OF-WAY.
- 4. REPAIR OF DAMAGED FACILITIES AND CLEANUP OF SEDIMENT ACCUMULATIONS ON ADJACENT PROPERTIES AND IN PUBLIC FACILITIES IS THE RESPONSIBILITY OF THE CONTRACTOR.
- 5. ALL EXPOSED EARTH SURFACES MUST BE PROTECTED FROM WIND AND WATER EROSION PRIOR TO FINAL ACCEPTANCE OF ANY PROJECT.

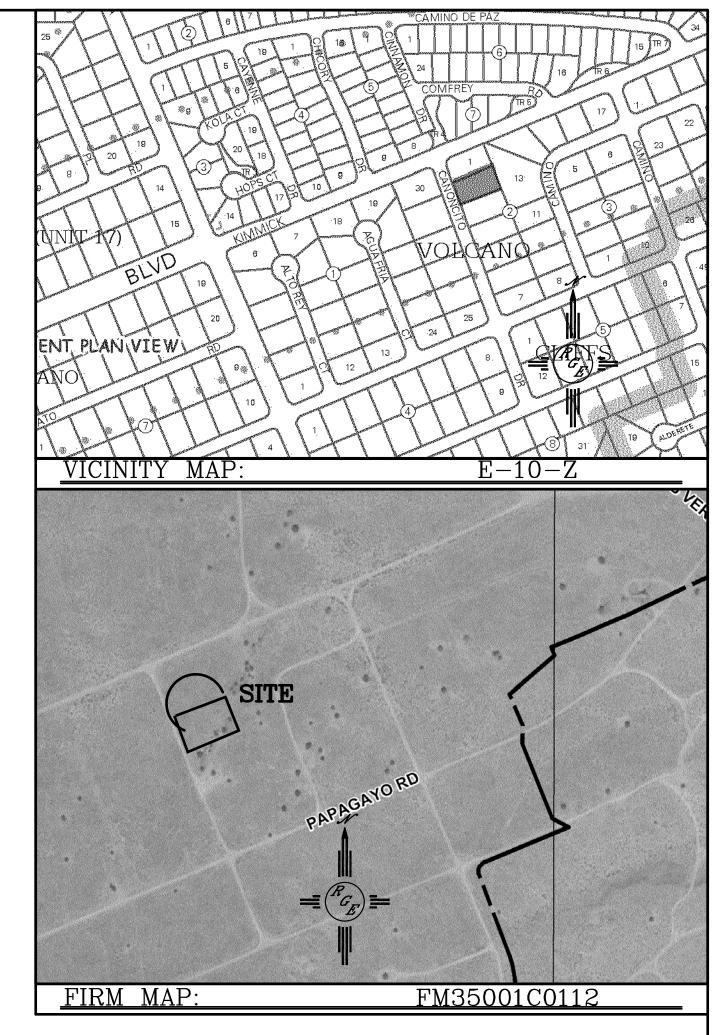

LEGAL DESCRIPTION:
LOT 2 BLOCK 2, UNIT 22 VOLCANO CLIFFS

NOTES:

1. ALL SPOT ELEVATIONS REPRESENT FLOWLINE ELEVATION UNLESS OTHERWISE


2. ALL SLOPES SHALL BE 3:1 MAX. AND GRAVEL OR NATIVE SEEDING

3.ANY AND ALL WALLS SHALL BE PERMIT UNDER SEPERATE PERMIT PRIOR TO CONSTRUCTION. ALL WALLS MUST ALLOW FOR CROSS LOT DRAINAGE

4. PAD GRADING MUST BE CERTIFIED PRIOR TO RELEASE OF BUILDING PERMIT

LEGEND

---- EXISTING CONTOUR ---- EXISTING INDEX CONTOUR PROPOSED INDEX CONTOUR SLOPE TIE EXISTING SPOT ELEVATION × XXXX × XXXX PROPOSED SPOT ELEVATION BOUNDARY CENTERLINE — RIGHT-OF-WAY PROPOSED CMU SCREEN WALL

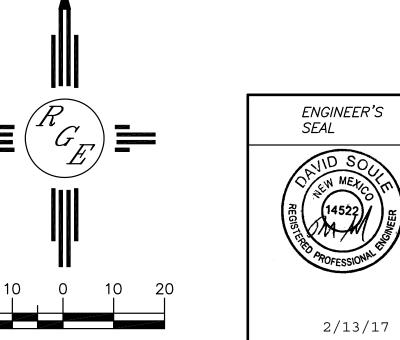

SCALE: 1"=20'

ENGINEER'S SEAL]
REGISTAN MEXICO REGISTANT AROFESSIONAL REGIST	[]

DAVID SOULE P.E. #14522

LOZOYA RESIDENCE
8020 CANONCITO DR NW
8020 CANONCITO DR NW
GRADING AND



DRAWN BY WCWJ

DATE 2-02-17

JOB #

21706

SUITE 201 ALBUQUERQUE, NM 87106 (505) 872—0999