CITY OF ALBUQUERQUE

Planning Department



July 8, 2019

David Soule, P.E. Rio Grande Engineering PO Box 93924 Albuquerque, New Mexico 87199

RE: Lot 8 Block 8 Volcano Cliffs Unit 18 SAD 228 6400 Canavio Rd. NW Grading and Drainage Plan Engineers Stamp Date 3/11/19 (D10D003E8) Pad Certification Date 7/2/19

Dear Mr. Soule,

PO Box 1293

Albuquerque

NM 87103

www.cabq.gov

Based upon the information provided in your submittal received 7/2/19, this plan is approved for Building Permit.

Please inform the builder/owner to attach a copy of this approved plan and this letter to the construction sets in the permitting process prior to sign-off by Hydrology.

Reiterate to the Owner/Contractor that a separate permit for a garden/retaining wall must be obtained, with the approved G&D plan dated 3/11/19 and Pad Certification Date 7/2/19.

Prior to Certificate of Occupancy release, Engineer Certification per the DPM checklist of this plan will be required.

If you have any questions, please contact me at 924-3986 or Rudy Rael at 924-3977.

Sincerely,

James D. Hughes, P.E.

Principal Engineer, Hydrology

Planning Department

RR/JDH

C: File D10D003E8



City of Albuquerque

Planning Department

Development & Building Services Division

DRAINAGE AND TRANSPORTATION INFORMATION SHEET (REV 6/2018)

Project Title: 6320 CANAVIO	Building Permit #:	Hydrology File #:
DRB#:	EPC#:	Work Order#:
Legal Description: LOT 10, BLOCK	8 VOLCANO CLIFFS	Work Order#:
City Address:		
Applicant: SILVERTON HOMES		Contact:
Address: 6320 CANAVIO	· · · ·	
	Fax#:	E-mail:
Other Contact: RIO GRANDE ENGIN	IEERING	Contact: DAVID SOULE
Address: PO BOX 93924 ALB NM		
		E-mail: david@riograndeengineering.
TYPE OF DEVELOPMENT: PLAT		
Check all that Apply:		
DEPARTMENT: X HYDROLOGY/ DRAINAGE TRAFFIC/ TRANSPORTATION TYPE OF SUBMITTAL: ENGINEER/ARCHITECT CERTIFICATION PAD CERTIFICATION CONCEPTUAL G & D PLAN X GRADING PLAN DRAINAGE REPORT DRAINAGE MASTER PLAN FLOODPLAIN DEVELOPMENT PERMIT ELEVATION CERTIFICATE CLOMR/LOMR TRAFFIC CIRCULATION LAYOUT (TOI TRAFFIC IMPACT STUDY (TIS) STREET LIGHT LAYOUT OTHER (SPECIFY) PRE-DESIGN MEETING? IS THIS A RESUBMITTAL?: YesX I	X BU CEI	OF APPROVAL/ACCEPTANCE SOUGHT: UILDING PERMIT APPROVAL ERTIFICATE OF OCCUPANCY ELIMINARY PLAT APPROVAL TE PLAN FOR SUB'D APPROVAL TE PLAN FOR BLDG. PERMIT APPROVAL NAL PLAT APPROVAL A/ RELEASE OF FINANCIAL GUARANTEE TUNDATION PERMIT APPROVAL TADING PERMIT APPROVAL TO
DATE SUBMITTED:	•	
COA STAFF:	ELECTRONIC SUBMITTAL RE	ECEIVED:

FEE PAID:_____



City of Albuquerque

Planning Department

Development & Building Services Division

DRAINAGE AND TRANSPORTATION INFORMATION SHEET (REV 6/2018)

Project Title: 6320 CANAVIO	Building Permit #:	Hydrology File #:
DRB#:	EPC#:	Work Order#:
Legal Description: LOT 10, BLOCK	8 VOLCANO CLIFFS	Work Order#:
City Address:		
Applicant: SILVERTON HOMES		Contact:
Address: 6320 CANAVIO	· · · ·	
	Fax#:	E-mail:
Other Contact: RIO GRANDE ENGIN	IEERING	Contact: DAVID SOULE
Address: PO BOX 93924 ALB NM		
		E-mail: david@riograndeengineering.
TYPE OF DEVELOPMENT: PLAT		
Check all that Apply:		
DEPARTMENT: X HYDROLOGY/ DRAINAGE TRAFFIC/ TRANSPORTATION TYPE OF SUBMITTAL: ENGINEER/ARCHITECT CERTIFICATION PAD CERTIFICATION CONCEPTUAL G & D PLAN X GRADING PLAN DRAINAGE REPORT DRAINAGE MASTER PLAN FLOODPLAIN DEVELOPMENT PERMIT ELEVATION CERTIFICATE CLOMR/LOMR TRAFFIC CIRCULATION LAYOUT (TOI TRAFFIC IMPACT STUDY (TIS) STREET LIGHT LAYOUT OTHER (SPECIFY) PRE-DESIGN MEETING? IS THIS A RESUBMITTAL?: YesX I	X BU CEI	OF APPROVAL/ACCEPTANCE SOUGHT: UILDING PERMIT APPROVAL ERTIFICATE OF OCCUPANCY ELIMINARY PLAT APPROVAL TE PLAN FOR SUB'D APPROVAL TE PLAN FOR BLDG. PERMIT APPROVAL NAL PLAT APPROVAL A/ RELEASE OF FINANCIAL GUARANTEE TUNDATION PERMIT APPROVAL TADING PERMIT APPROVAL TO
DATE SUBMITTED:	•	
COA STAFF:	ELECTRONIC SUBMITTAL RE	ECEIVED:

FEE PAID:_____

100-Year, 6-hr. Area Area Treatment A Treatment B Treatment C Treatment D Weighted E Volume (acres) % (acres) % (acres) % (acres) % (acres) (ac-ft) 12050.00 | 0.277 | 0% | 0 | 20% | 0.055 | 46% | 0.1272 | 34% | 0.094 | 1.259 | 0.029 PROPOSED 12050.00 0.277 0% 0 20% 0.055 34% 0.0941 46% 0.127 1.377 0.032 COMPARISON

Weighted E Method

I, DAVID SOULE HAVE PERSONALLY INPECTED THE SITE. I HEREBY CERTIFY THE PAD HAS BEEN CONSTRUCTED SUCH THAT IT IS IN SUBSTANTIAL CONFORMANCE TO THE APPROVED GRADING PLAN DATED 3/11/19

Equations:

Weighted E = Ea*Aa + Eb*Ab + Ec*Ac + Ed*Ad / (Total Area)

Volume = Weighted D * Total Area

Flow = Qa * Aa + Qb * Ab + Qc * Ac + Qd * Ad

Where for 100-year, 6-hour storm-zone 1 Qa= 1.29 Qb= 2.03 Eb= 0.67 Qc= 2.87 Ec= 0.99

ONSITE Conditions

FIRST FLUSH WATER QUALITY VOLUME

PROVIDED REQUIRED (CF) 157 (**CF**) 232 WATER QUALITY 232 FLOOD CONTROL 118

Ed= 1.97

Narrative


This site is within the SAD 226 Master Drainage plan boundaries. The site is to maintain existing patterns and

Qd= 4.37

drain to the the adjacent roadway to the south per the master drainage plan. We are ponding the water harvest volume generated by the site


there is not measurable upland flow. This plan does not exceed the allowed impervious area therefore we are notrrequried to retain.

This plan is in conformance to the master drainage plan

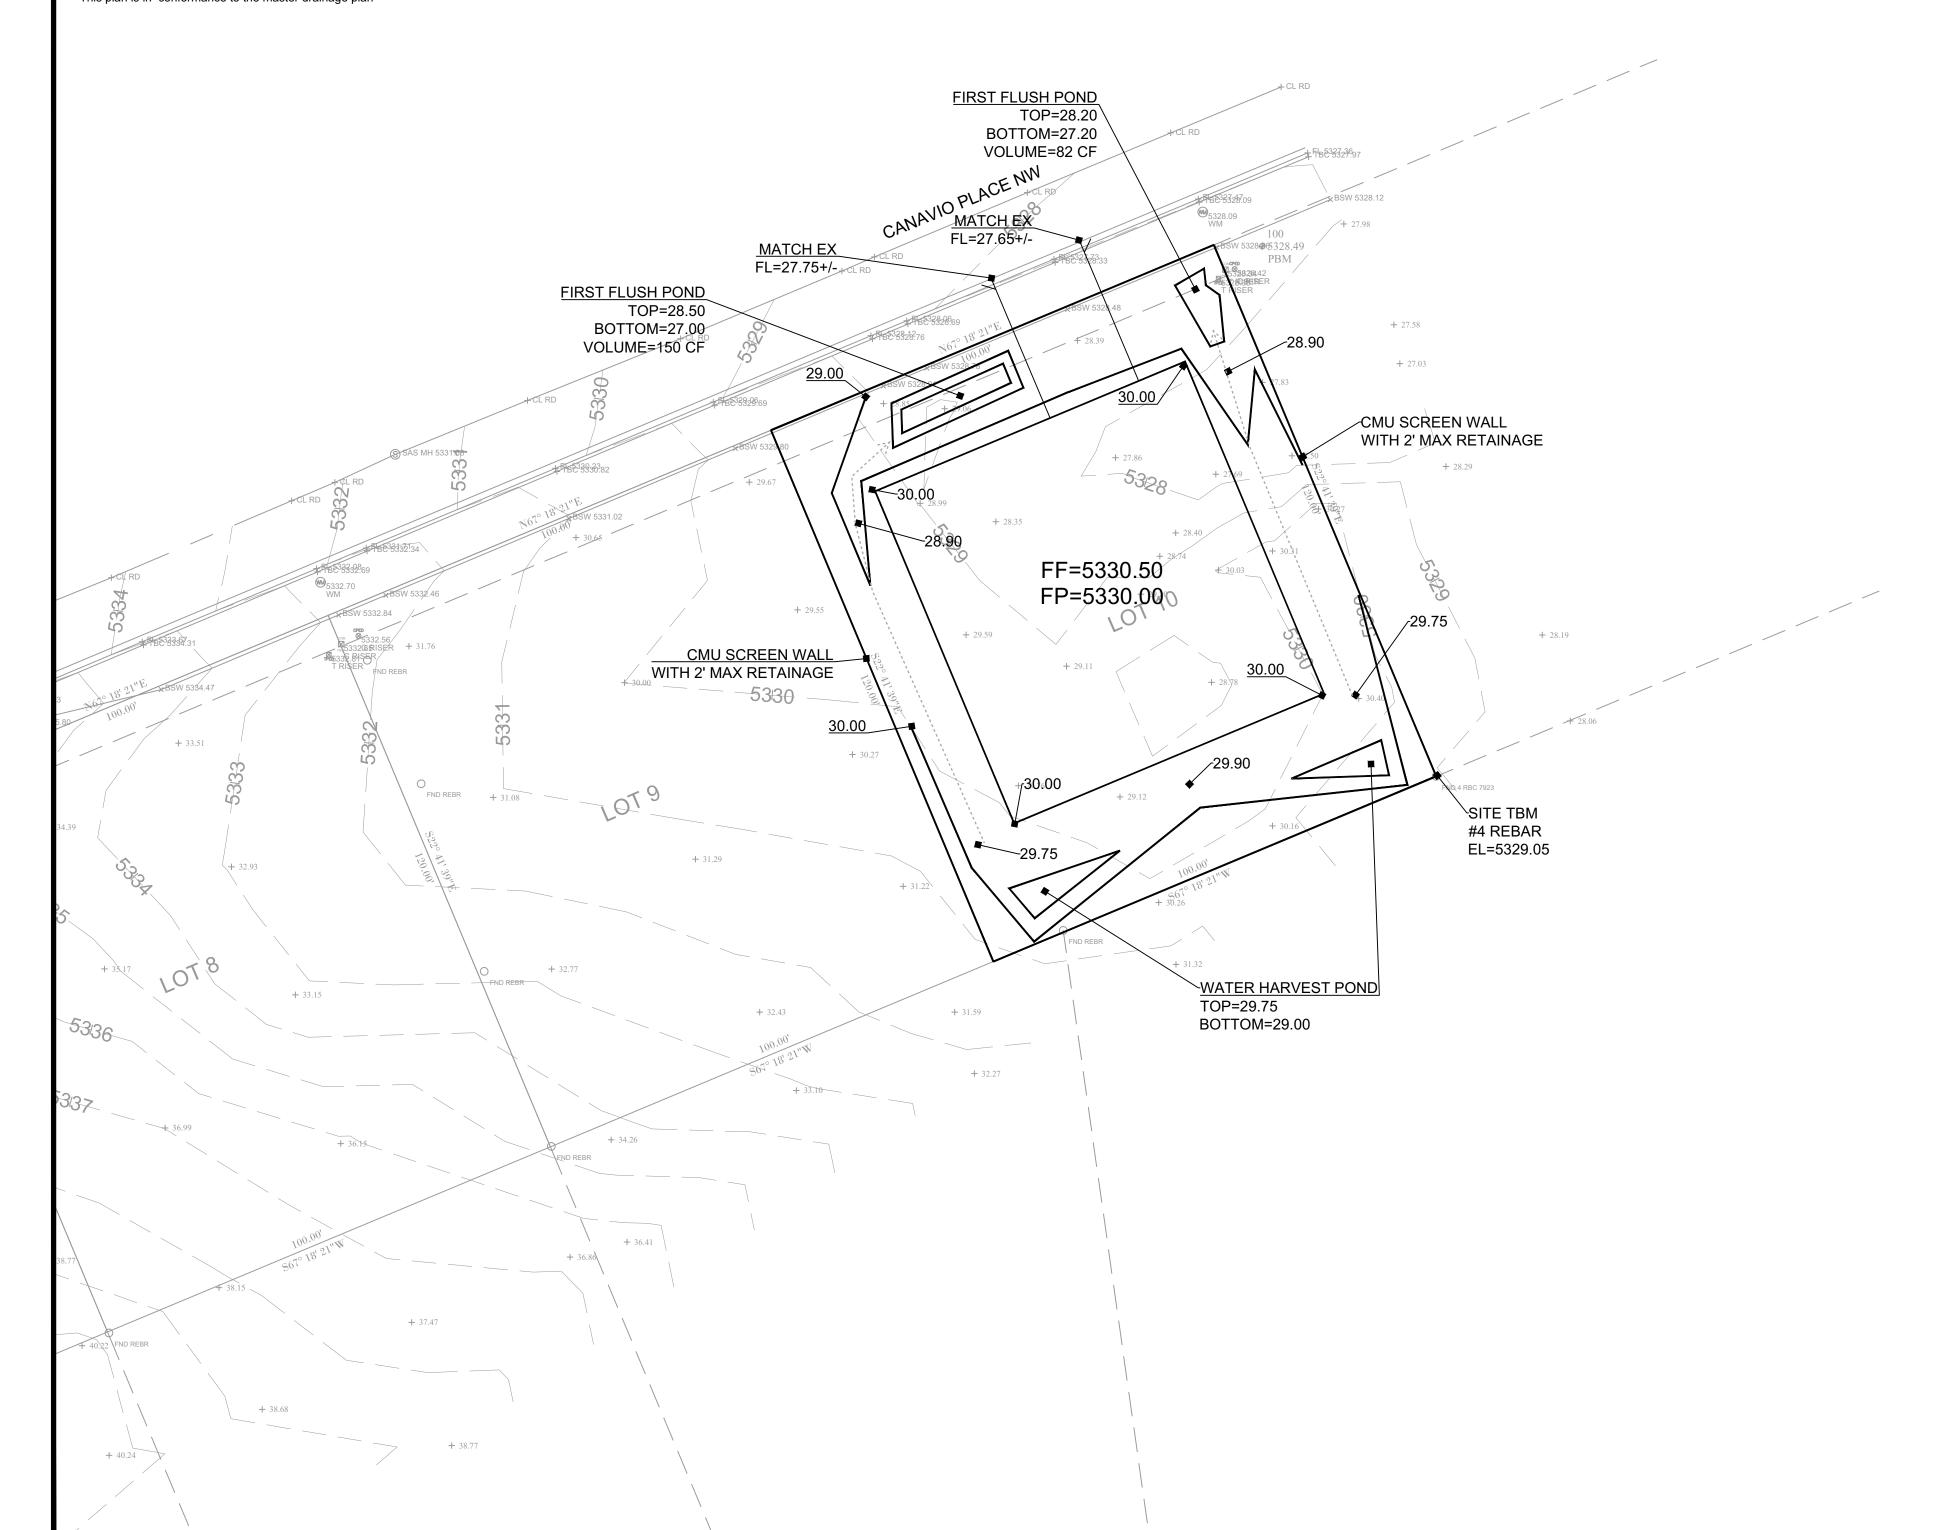

EROSION CONTROL NOTES:

- 1. CONTRACTOR IS RESPONSIBLE FOR OBTAINING A TOPSOIL DISTURBANCE PERMIT PRIOR TO BEGINNING WORK.
- 2. CONTRACTOR IS RESPONSIBLE FOR MAINTAINING RUN-OFF ON SITE DURING CONSTRUCTION.
- 3. CONTRACTOR IS RESPONSIBLE FOR CLEANING ALL SEDIMENT THAT GETS INTO EXISTING RIGHT-OF-WAY.
- 4. REPAIR OF DAMAGED FACILITIES AND CLEANUP OF SEDIMENT ACCUMULATIONS ON ADJACENT PROPERTIES AND IN PUBLIC FACILITIES IS THE RESPONSIBILITY OF THE CONTRACTOR.
- 5. ALL EXPOSED EARTH SURFACES MUST BE PROTECTED FROM WIND AND WATER EROSION PRIOR TO FINAL (CITY) ACCEPTANCE OF ANY PROJECT.

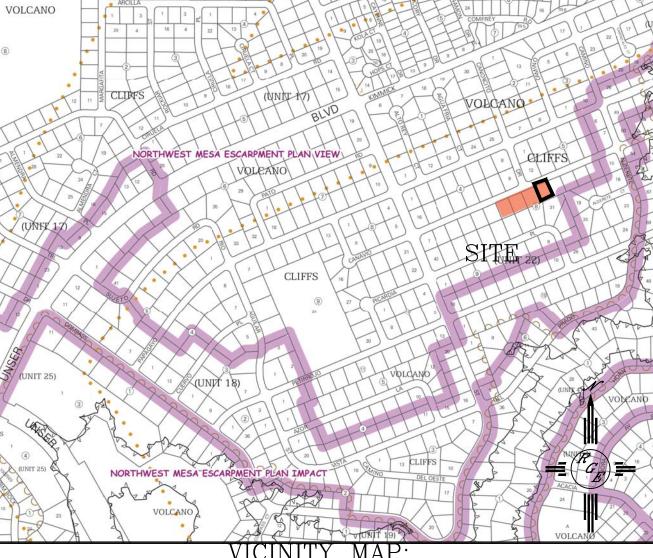

City of Albuquerqu AREA OF MINIMAL FLOOD HAZARD FIRM MAP:

LEGAL DESCRIPTION:

LOT 10, BLOCK 8, UNIT 22, VOLCANO CLIFFS SUBDIVISION

NOTES:

- 1. ALL SPOT ELEVATIONS REPRESENT FLOWLINE ELEVATION UNLESS OTHERWISE
- 2. TOPOGRAPHIC SURVEY INFORMATION SHOWN ON THIS PLAN WAS OBTAINED BY CSTI DATED MARCH 2019
- 3.. ALL DISTURBED AREAS MUST BE RESEED OR LANDSCAPED PRIOR TO FINAL C.O.. ALL AREAS OUTSIDE THE BUILDING ENVELOPE MUST BE RESEED WITH NATIVE MIX 4. DUE TO EXISTING TOPOGRAPHY AND UNDEVELOPED NATURE OF THE DOWN STEAM
- AREA, PERIODIC MAINTENANCE OF PONDS AND SWALES ARE REQUIRED. 5. ALL WALLS SHALL BE PERMITTED SEPARATELY AND MUST CONFORM TO THIS
- 6. PAD ELEVATION CERTIFICATION REQUIRED PRIOR TO PERMIT


LEGEND

---- EXISTING CONTOUR — — —5410— — EXISTING INDEX CONTOUR ----5411 PROPOSED CONTOUR —5410———— PROPOSED INDEX CONTOUR PROPOSED FLOWLINE ELEVATIONS PROPERTY LINE

DRAINAGE FLOW LINE



SCALE: 1"=30'

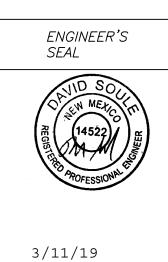

DAVID SOULE

P.E. #14522

LOT 10, BLOCK 8, UNIT 1	DRAWN BY _{JDG}
VOLCANO CLIFFS	DATE
GRADING AND	03-09-2019
DRAINAGE PLAN	
Rio Grande	SHEET #
Engineering 1000 STATUL MENUS ST	1 OF 1
1606 CENTRAL AVENUE SE SUITE 201 ALBUQUERQUE, NM 87106 (505) 872-0999	JOB #