

Mayor Timothy M. Keller

March 25, 2022

David Soule, P.E. Rio Grande Engineering PO Box 93924 Albuquerque, New Mexico 87199

RE: RE: Lot 11 Block 8 Volcano Cliffs Unit 22 SAD 228 6316 Canavio Rd. NW Grading and Drainage Plan Engineers Stamp Date 1/20/2022 (D10D003E11) Pad Certification Date 3/21/2022

Mr. Soule,

Based upon the information provided in your submittal received 3/25/2022, this plan is approved for Building Permit.

PO Box 1293 Please inform the builder/owner to attach a copy of this approved plan and this letter to the construction sets in the permitting process prior to sign-off by Hydrology.

AlbuquerqueReiterate to the Owner/Contractor that a separate permit for a garden/retaining wall must
be obtained, with the approved G&D plan and Pad Certification. Also, let the
owner/contractor know that if a pool is to be added in the future the G&D plan will need to
be modified showing the location of the pool and the land treatment differences. Also
advise the owner & Contractor that dirt is not allowed in the public right of way to climb
the curb. Crusher fines or lumber is allowed. If dirt is used this will delay going forward
with the construction of the home.

www.cabq.gov

Prior to Certificate of Occupancy release, Engineer Certification per the DPM checklist of this plan will be required.

If you have any questions, please contact me at 924-3986 or Rudy Rael at 924-3977.

Sincerely,

Ernest Armijo, P.E. Principal Engineer, Planning Dept. Development Review Services



Sun Valley Building Enterprises, LLC PO Box 1070 Corrales, NM 87048 Office: 505-331-5669 Wade Wingfield: 505-321-0769 www.sunvalleycustomhomes.com

Feb 2, 2022

David Soule,

As the General Contractor for the construction of the new home located at 6316 Canavio, Albuquerque NM, I will enforce the use of either lumber or crusher fines as a ramp to gain access to the site while building the pad. I understand that the intent is to minimize the runoff of solid material into the storm drainage system.

Sincerely,

C

Wade Wingfield Owner – Sun Valley Building Enterprises

Weighted E Method															
												100-Year	r, 6-hr.	2	24 hour
Basin	Area	Area	Treat	ment A	Treat	ment B	Treatr	ment C	Treatr	nent D	Weighted E	Volume	Flow	١	Volume
	(sf)	(acres)	%	(acres)	%	(acres)	%	(acres)	%	(acres)	(ac-ft)	(ac-ft)	cfs		(ac-ft)
ALLOWED	12023.00	0.276	0%	0	24%	0.066	40%	0.1104	36%	0.099	1.362	0.031	0.8	37	0.038
PROPOSED	12023.00	0.276	0%	0	24%	0.066	26%	0.0718	50%	0.138	1.542	0.035	0.9	92	0.045
COMPARISON												0.004			0.007

Equations:

Weighted E = Ea*Aa + Eb*Ab + Ec*Ac + Ed*Ad / (Total Area)


Volume = Weighted D * Total Area

Flow = Qa * Aa + Qb * Ab + Qc * Ac + Qd * Ad

Where for 100-year, 6-hour s	torm- zone 1	
-	Ea= 0.55	Qa= 1.54
	Eb= 0.73	Qb= 2.16
	Ec= 0.95	Qc= 2.87
	Ed= 2.24	Qd= 4.12
ONSITE Conditons FIRST FLUSH WATER QUA	LITY VOLUME	
	REQUIRED	PROVIDED
	(CF)	(CF)
WATER QUALITY	0	301
FLOOD CONTROL	293	301


Narrative

This site is within the SAD 228 Master Drainage plan boundaries. The site is to maintain existing patterns and drain to the adjacent roadway per the master drainage plan. The site does exceed the SAD 228 developed conditions assumptions, therefore ponding of 293 cf is required. No upland flow impact the site. We are ponding the water harvest volume generated by the site. This plan is in conformance to the master drainage plan

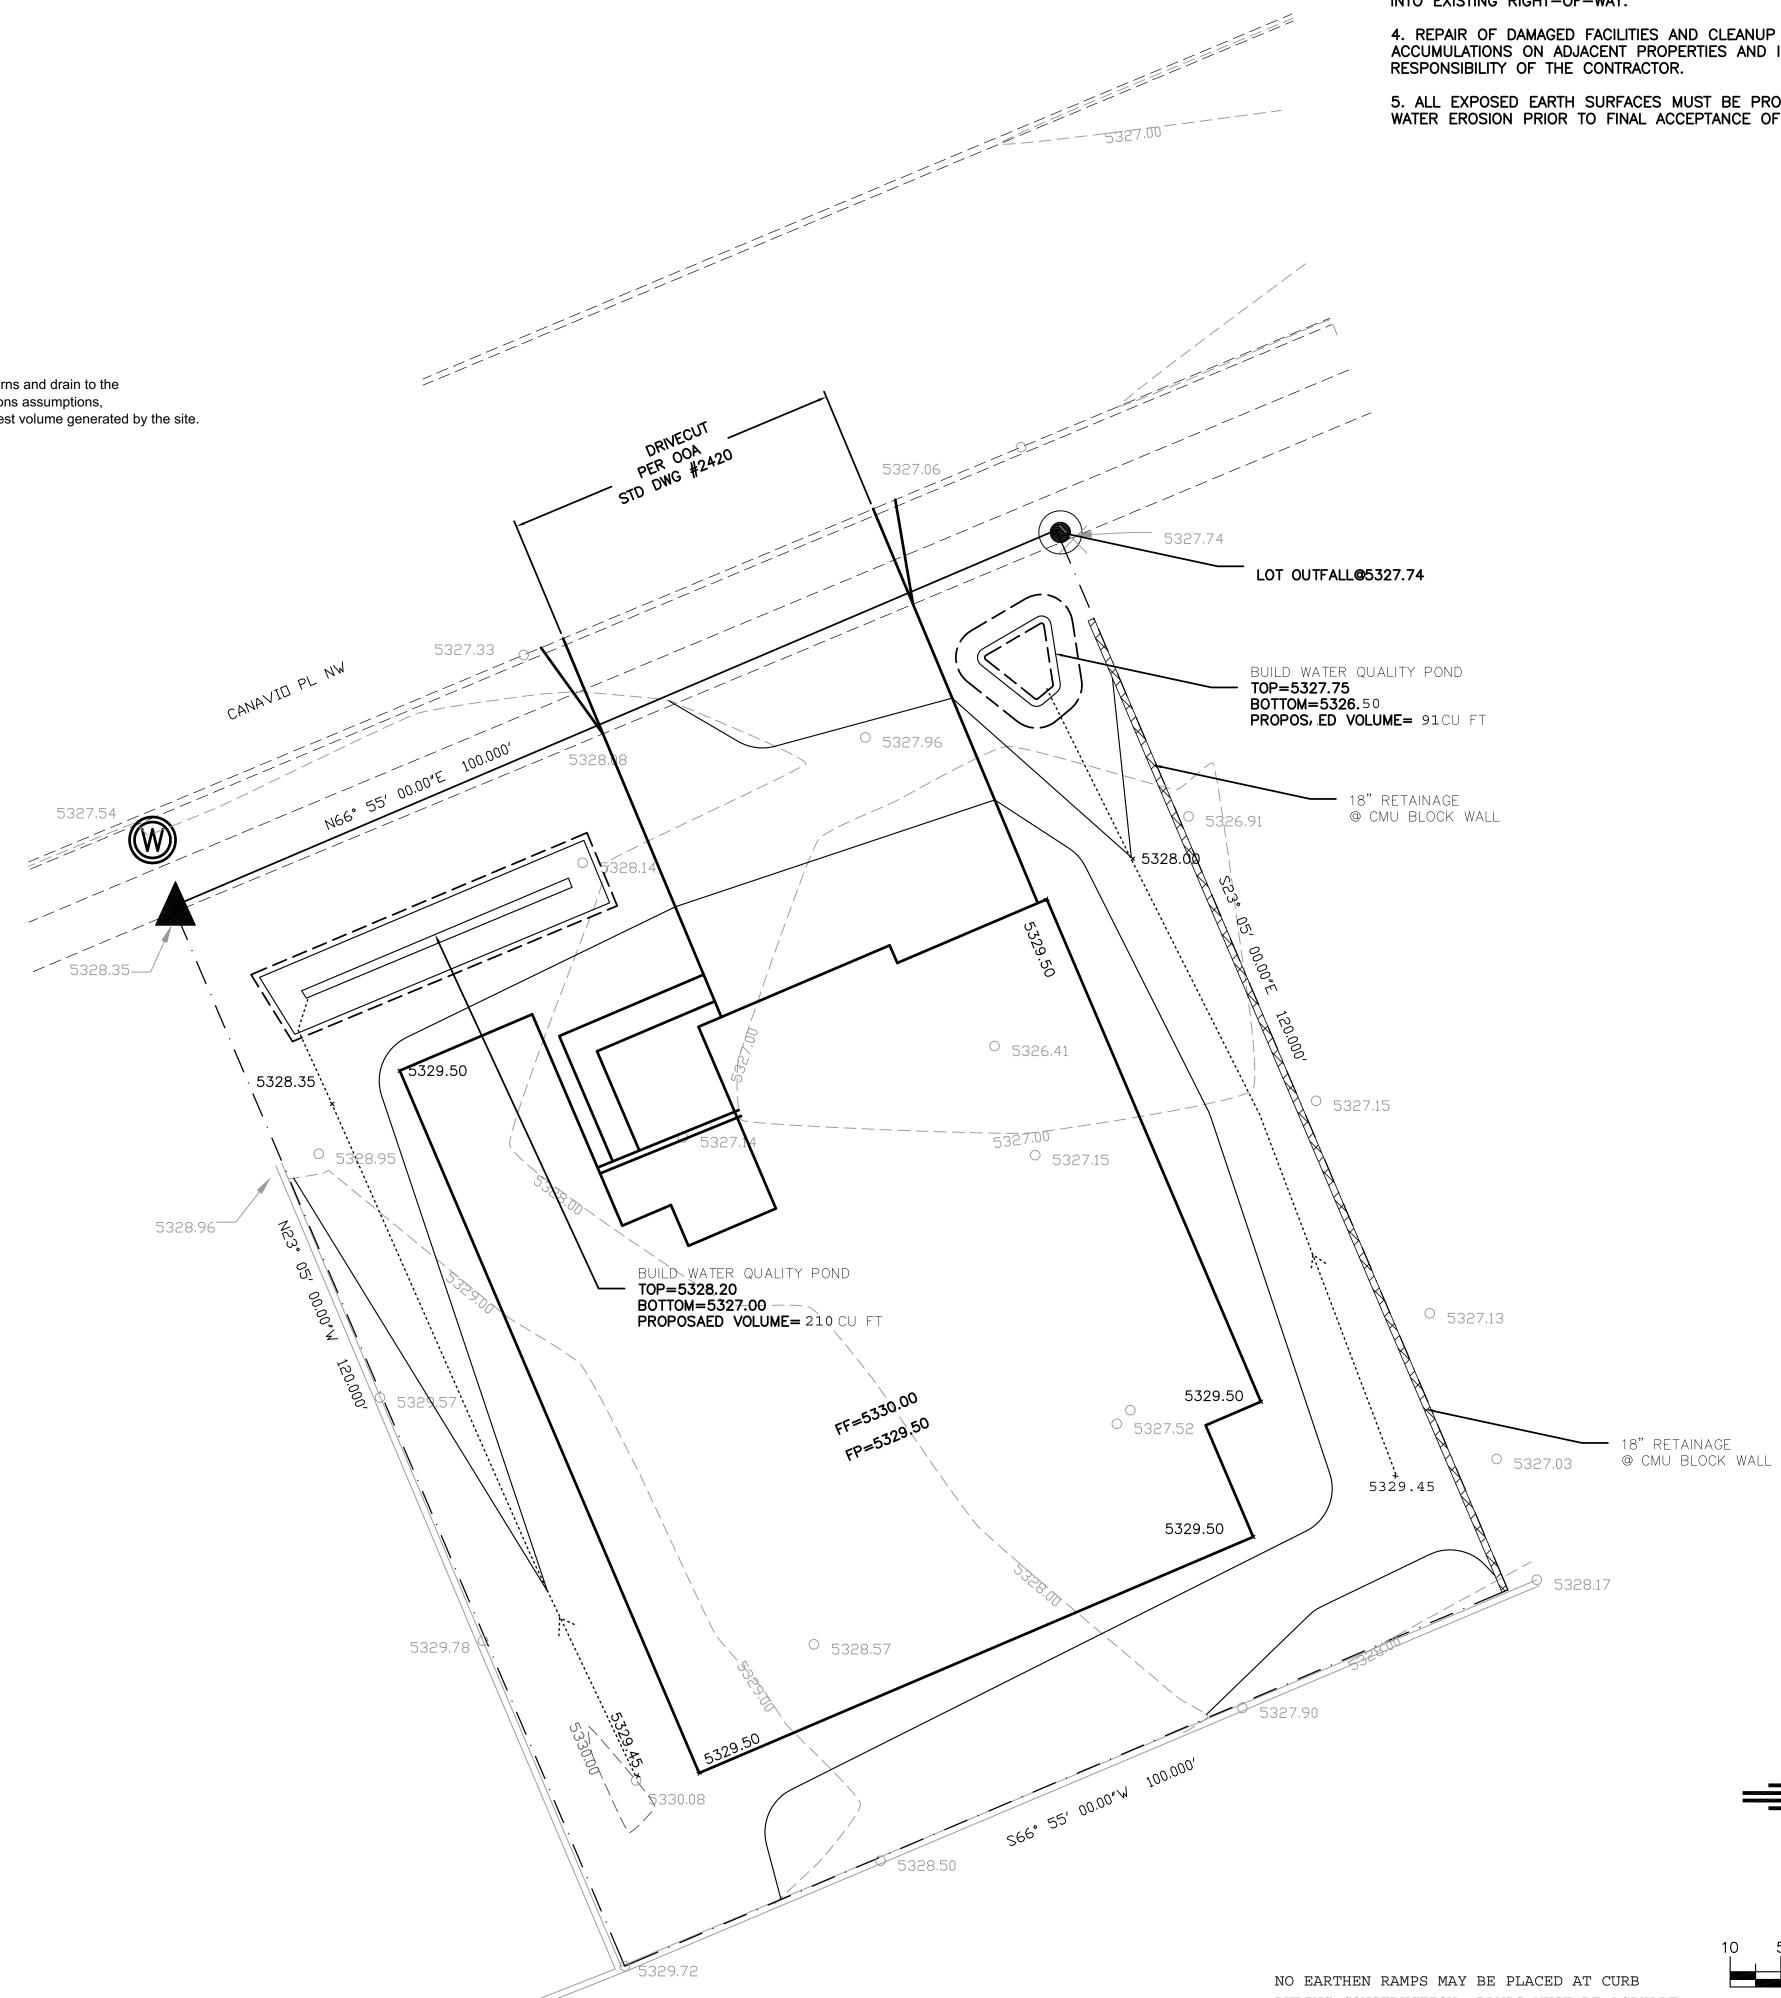

CAUTION:

EXISTING UTILITIES ARE NOT SHOWN. IT SHALL BE THE SOLE RESPONSIBILITY OF THE CONTRACTOR TO CONDUCT ALL NECESSARY FIELD INVESTIGATIONS PRIOR TO ANY EXCAVATION TO DETERMINE THE ACTUAL LOCATION OF UTILITIES & OTHER IMPROVEMENTS.

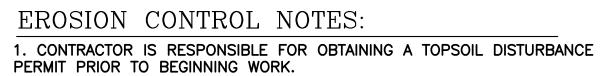


2. CONTRACTOR IS RESPONSIBLE FOR MAINTAINING RUN-OFF ON SITE DURING CONSTRUCTION.

3. CONTRACTOR IS RESPONSIBLE FOR CLEANING ALL SEDIMENT THAT GETS INTO EXISTING RIGHT-OF-WAY.

4. REPAIR OF DAMAGED FACILITIES AND CLEANUP OF SEDIMENT ACCUMULATIONS ON ADJACENT PROPERTIES AND IN PUBLIC FACILITIES IS THE

5. ALL EXPOSED EARTH SURFACES MUST BE PROTECTED FROM WIND AND WATER EROSION PRIOR TO FINAL ACCEPTANCE OF ANY PROJECT.

DURING CONSTRUCTION. RAMPS MUST BE ASPHALT MILLINGS OR WOOD

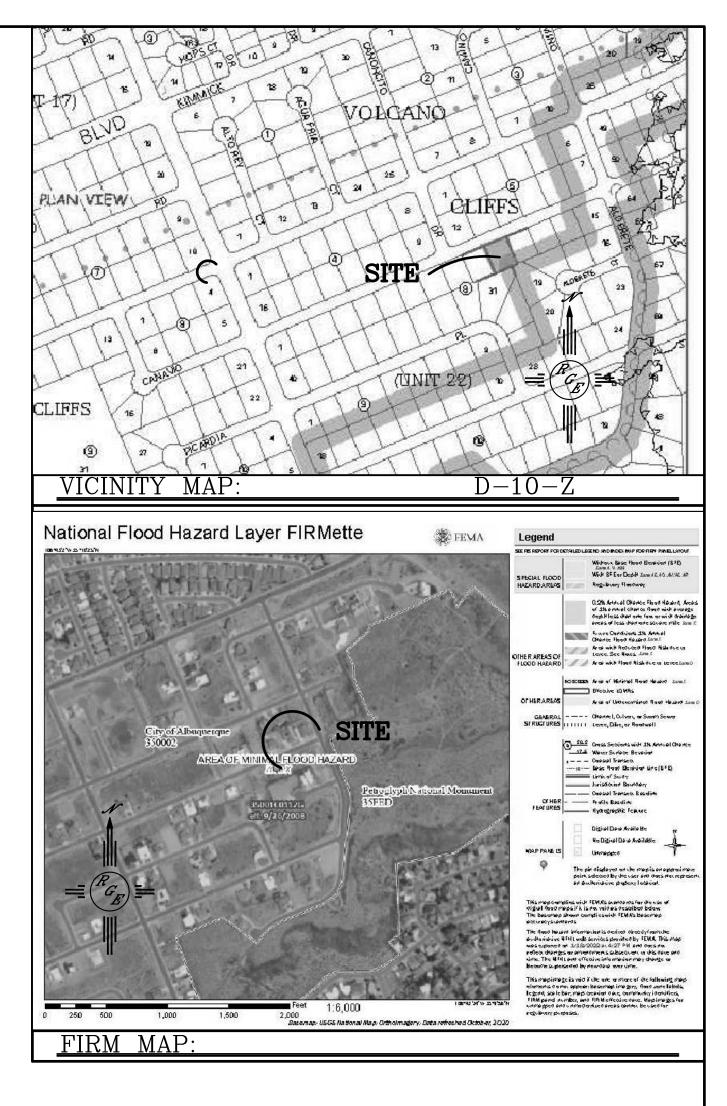

LEGAL DESCRIPTION:

LOT 11, BLOCK 8 VOLCANO CLIFFS UNIT 22

NOTES:

1. ALL SPOT ELEVATIONS REPRESENT FLOWLINE ELEVATION UNLESS OTHERWISE NOTED.

2. ALL SLOPES SHALL BE 3:1 MAX. AND GRAVEL OR NATIVE SEEDING PRIOR TO CO.

3. NO PONDING WITHIN 10' OF STRUCTURE.

4. SURVEY INFORMATION PROVIDED BY CONSTRUCTION SURVEY TECHNOLOGY UTILIZING NAVD 1988 DATUM

LEGEND

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_	- — — — — — — — — — — — — — — — — — — —	- EXISTING CONTOUR	
-	- — — — — — — — — — — — — — — — — — — —	EXISTING INDEX CONTOUR	
-	XXXX	PROPOSED CONTOUR	
-		- PROPOSED INDEX CONTOUR	
	►	SLOPE TIE	
	× XXXX	EXISTING SPOT ELEVATION	
	× XXXX	PROPOSED SPOT ELEVATION	
-		LOT LINE	
-		CENTERLINE	
_		RIGHT-OF-WAY	
-		- PROPOSED PVC SD (SEE PLAN FOR SIZE)	
-		GRAVEL LINED SWALE	
Ξ	============	\equiv EXISTING CURB AND GUTTER	
=		PROPOSED CMU SCREEN WALL-DESIGN BY 18" MAX RETAINGE @ PERIMETER WALL	OTHERS
	ENGINEER'S SEAL	6316 CANAVIO	DRAWN BY _{WCWJ} DATE
	AVID SOLL		1-18-22
	RECON MEXICO ITI HEAL	GRADING AND DRAINAGE PLAN	2022003-LAYOUT-1-18-22
	RO AROFESSIONAL	Rio Grande	SHEET #
	1/20/22	Engineering 1606 CENTRAL AVENUE SE	_
	DAVID SOULE	SUITE 201 ALBUQUERQUE, NM 87106	JOB #
	P.E. #14522		2022003

SCALE: 1"=10'

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