CITY OF ALBUQUERQUE

Planning Department



July 8, 2019

David Soule, P.E. Rio Grande Engineering PO Box 93924 Albuquerque, New Mexico 87199

RE: Lot 7 Block 8 Volcano Cliffs Unit 18 SAD 228 6404 Canavio Rd. NW Grading and Drainage Plan Engineers Stamp Date 3/11/19 (D10D003E7) Pad Certification Date 7/2/19

Dear Mr. Soule,

PO Box 1293

Albuquerque

NM 87103

www.cabq.gov

Based upon the information provided in your submittal received 7/2/19, this plan is approved for Building Permit.

Please inform the builder/owner to attach a copy of this approved plan and this letter to the construction sets in the permitting process prior to sign-off by Hydrology.

Reiterate to the Owner/Contractor that a separate permit for a garden/retaining wall must be obtained, with the approved G&D plan dated 3/11/19 and Pad Certification Date 7/2/19.

Prior to Certificate of Occupancy release, Engineer Certification per the DPM checklist of this plan will be required.

If you have any questions, please contact me at 924-3986 or Rudy Rael at 924-3977.

Sincerely,

James D. Hughes, P.E. Principal Engineer, Hydrology

Filincipal Engineer, Hydrology

Planning Department

RR/JDH

C: File D10D003E7



City of Albuquerque


Planning Department

Development & Building Services Division

DRAINAGE AND TRANSPORTATION INFORMATION SHEET (REV 6/2018)

Project Title: 6404 CANAVIO	Building Permit #:	Hydrology File #:		
DRB#:	EPC#:	Work	Order#:	
Legal Description: LOT 7 , BLOCK	8 VOLCANO CLIFF	S UNIT 22		
City Address:				
			··	
Address: 6404 CANAVIO				
Phone#:	Fax#·			
Other Contact: RIO GRANDE ENGIN	LEKING	Contact:	DAVID SOULE	
Address: PO BOX 93924 ALB NM				
Phone#: 505.321.9099	_ Fax#:	E-mail: d	lavid@riograndeengineering.com 	
TYPE OF DEVELOPMENT: PLAT	X RESIDENCE	DRB SITE	ADMIN SITE	
Check all that Apply:		_		
DEPARTMENT:	ТУРЕ	OF APPROVAL/ACCE	PTANCE SOUGHT:	
X HYDROLOGY/ DRAINAGE	_ HYDROLOGY/ DRAINAGE			
TRAFFIC/ TRANSPORTATION		ERTIFICATE OF OCCUI		
TYPE OF SUBMITTAL:				
ENGINEER/ARCHITECT CERTIFICATIO	N P	RELIMINARY PLAT AP	PROVAL	
X PAD CERTIFICATION	AD CERTIFICATION SITE		E PLAN FOR SUB'D APPROVAL	
CONCEPTUAL G & D PLAN	S	ITE PLAN FOR BLDG. I	LAN FOR BLDG. PERMIT APPROVAL	
-		AL PLAT APPROVAL		
DRAINAGE REPORT				
DRAINAGE MASTER PLAN	SI	IA/ RELEASE OF FINAN	NCIAL GUARANTEE	
		OUNDATION PERMIT A	NDATION PERMIT APPROVAL	
		RADING PERMIT APPROVAL		
		O-19 APPROVAL	19 APPROVAL	
TRAFFIC CIRCULATION LAYOUT (TCL) PAVING PERMIT APPROVAL		OVAL		
		RADING/ PAD CERTIF	ICATION	
STREET LIGHT LAYOUT	W	WORK ORDER APPROVAL		
		LOMR/LOMR		
PRE-DESIGN MEETING?	F	FLOODPLAIN DEVELOPMENT PERMIT		
IS THIS A RESUBMITTAL?: Yes X_N	O	THER (SPECIFY)		
DATE SUBMITTED:	By:		NA AND COMMEN	
COA STAFF:	ELECTRONIC SUBMITTAL	RECEIVED:	-	


FEE PAID:_____

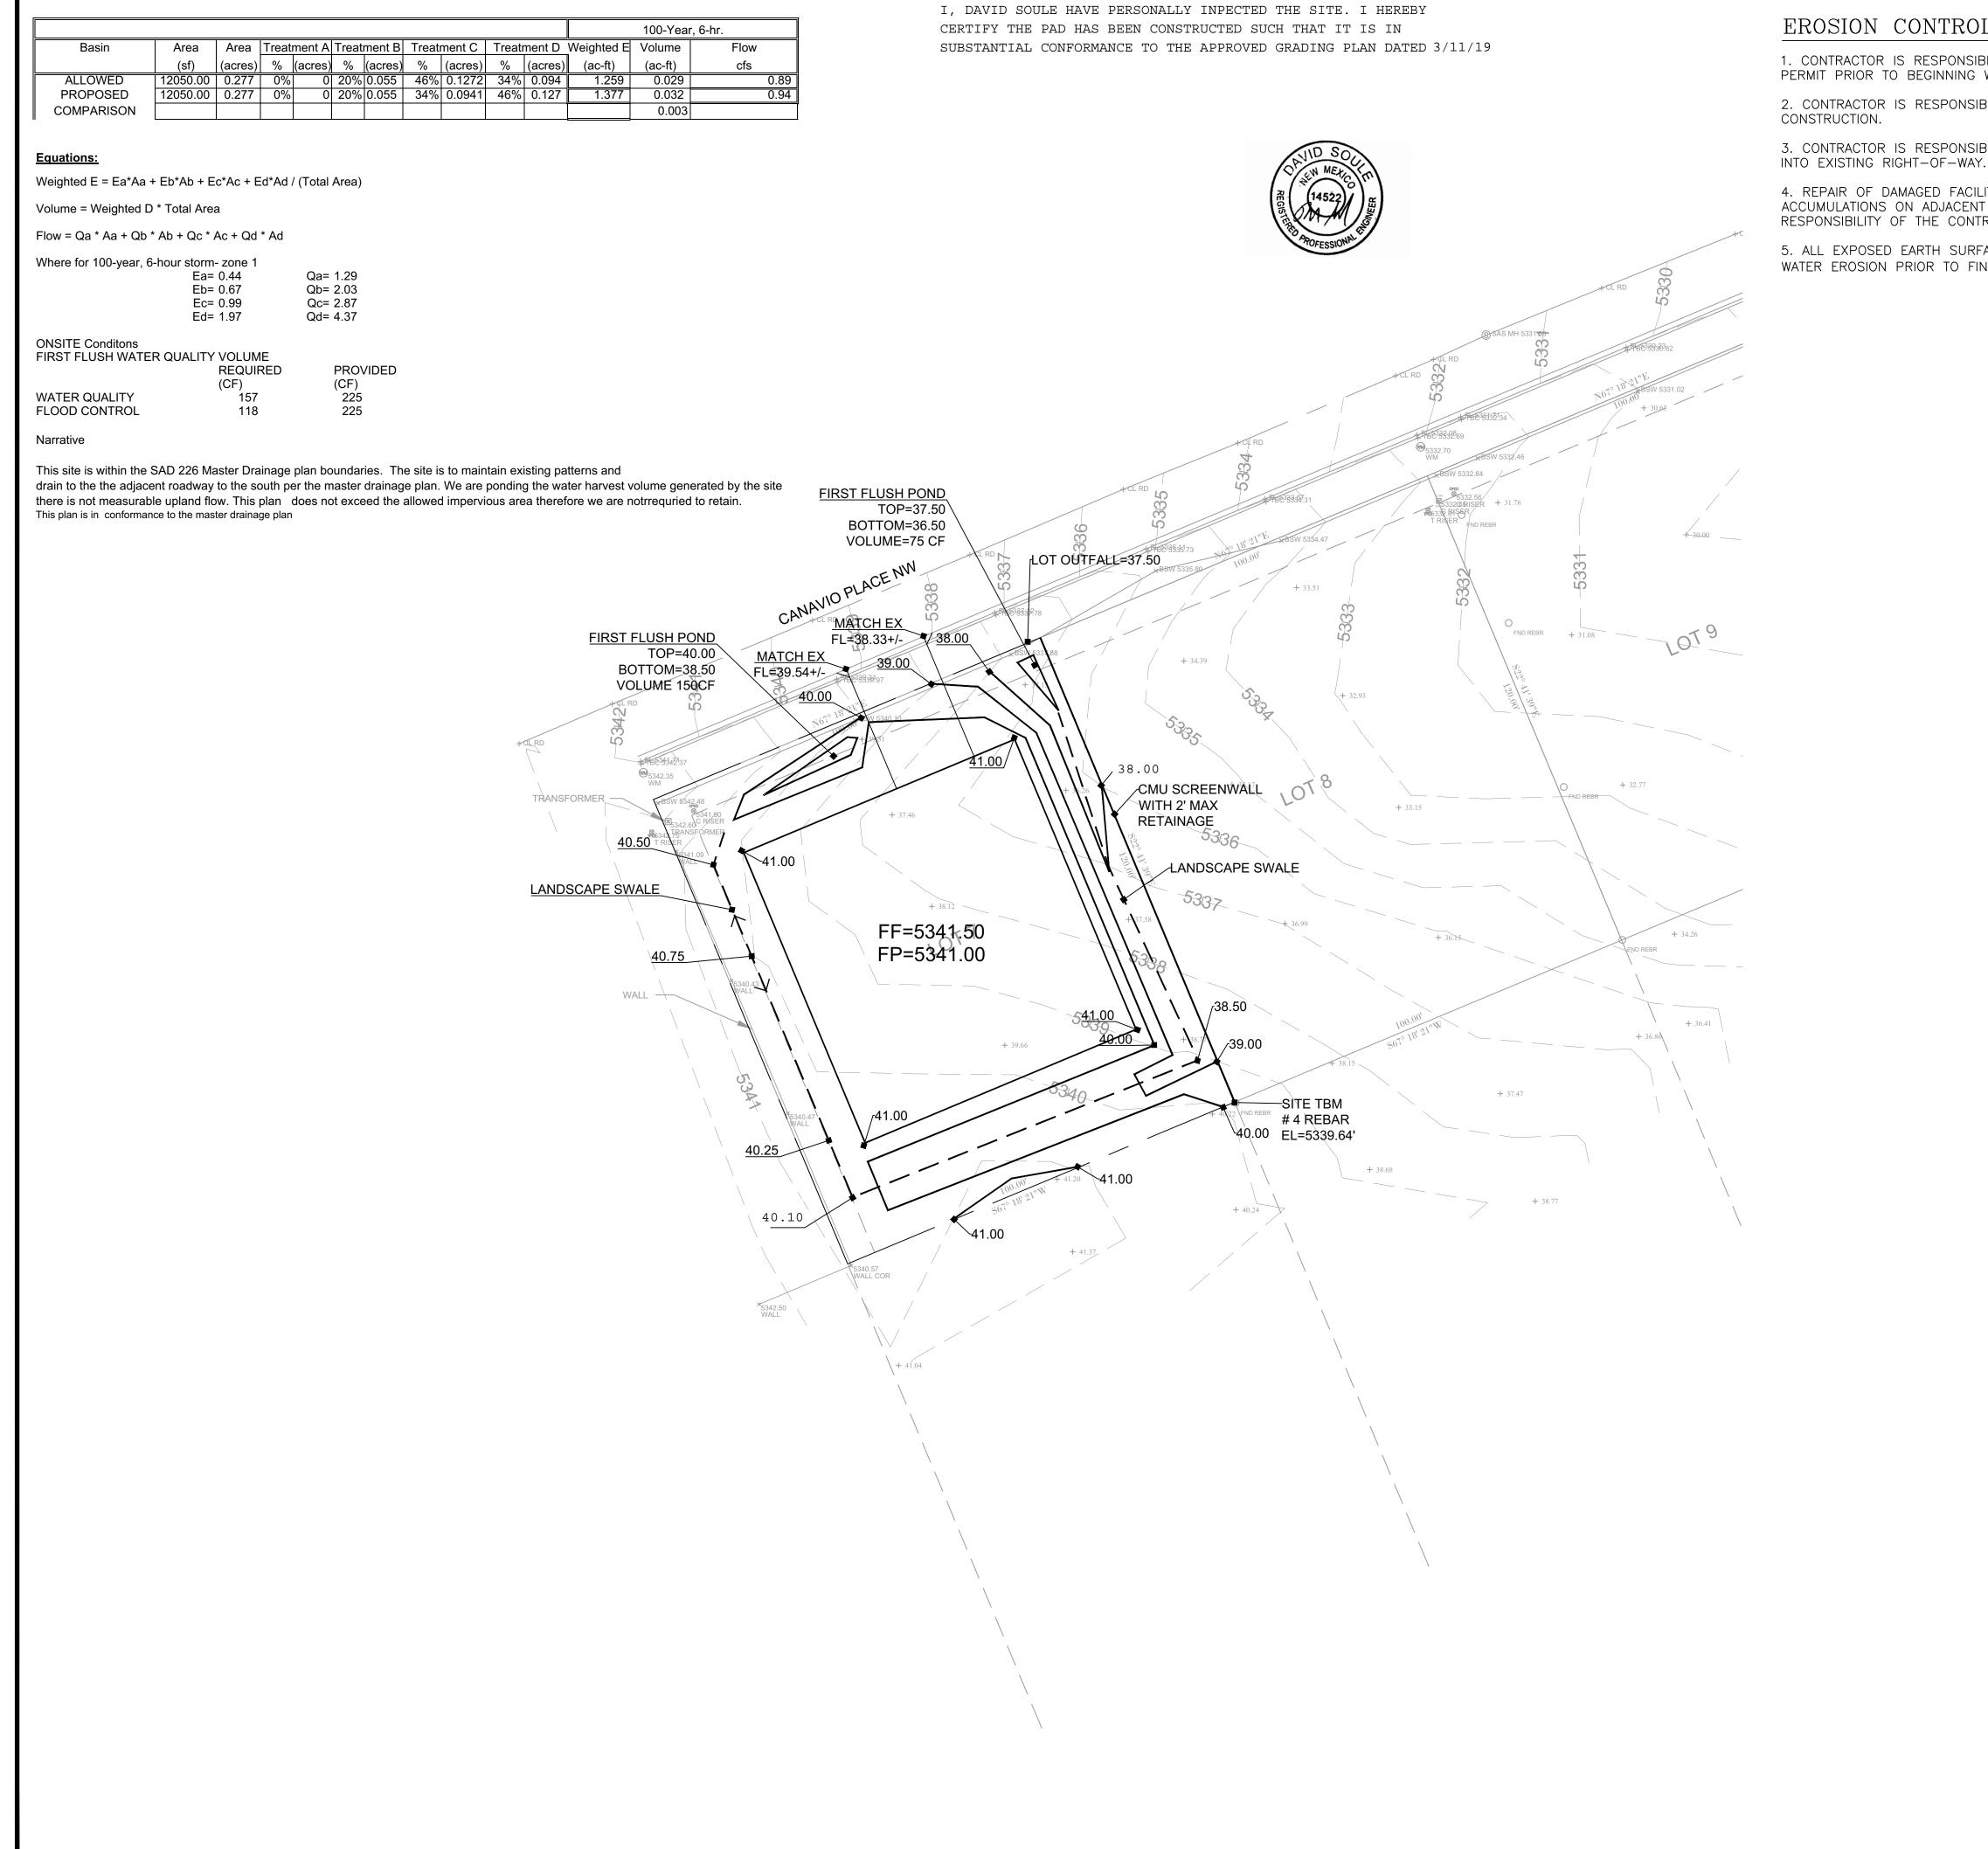


Weighted E Method

EROSION CONTROL NOTES:

- 1. CONTRACTOR IS RESPONSIBLE FOR OBTAINING A TOPSOIL DISTURBANCE PERMIT PRIOR TO BEGINNING WORK.
- 2. CONTRACTOR IS RESPONSIBLE FOR MAINTAINING RUN-OFF ON SITE DURING CONSTRUCTION.
- 3. CONTRACTOR IS RESPONSIBLE FOR CLEANING ALL SEDIMENT THAT GETS
- 4. REPAIR OF DAMAGED FACILITIES AND CLEANUP OF SEDIMENT ACCUMULATIONS ON ADJACENT PROPERTIES AND IN PUBLIC FACILITIES IS THE RESPONSIBILITY OF THE CONTRACTOR.
- 5. ALL EXPOSED EARTH SURFACES MUST BE PROTECTED FROM WIND AND WATER EROSION PRIOR TO FINAL (CITY) ACCEPTANCE OF ANY PROJECT.

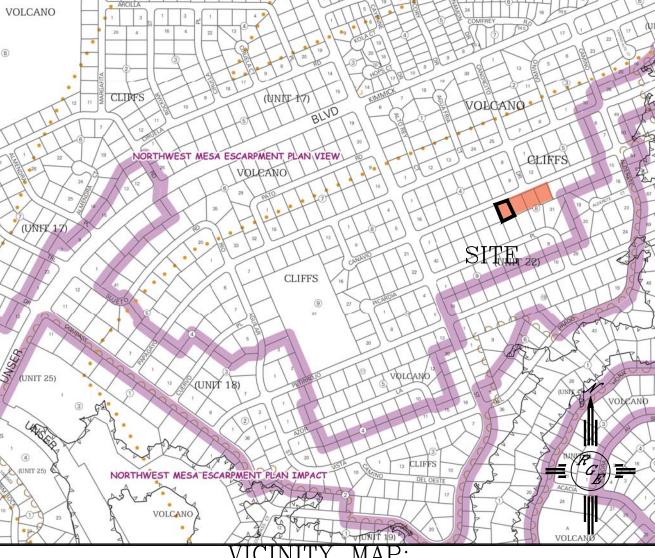

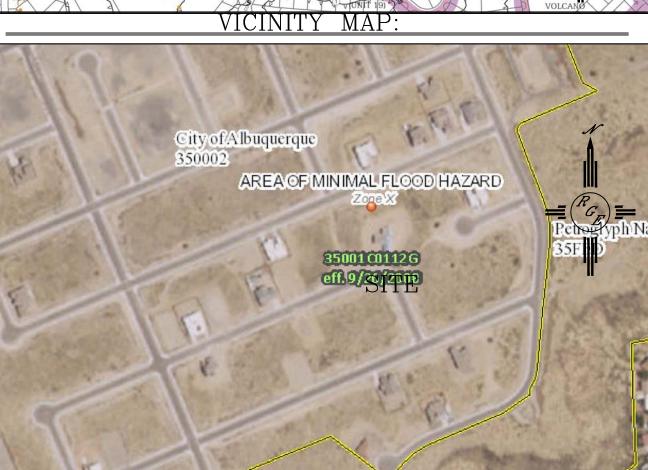

LEGAL DESCRIPTION:

FIRM MAP:


LOT 7, BLOCK 8, UNIT 22, VOLCANO CLIFFS SUBDIVISION

NOTES:


- 1. ALL SPOT ELEVATIONS REPRESENT FLOWLINE ELEVATION UNLESS OTHERWISE
- 2. TOPOGRAPHIC SURVEY INFORMATION SHOWN ON THIS PLAN WAS OBTAINED BY CSTI DATED MARCH 2019
- 3. ALL DISTURBED AREAS MUST BE RESEED OR LANDSCAPED PRIOR TO FINAL C.O.. ALL AREAS OUTSIDE THE BUILDING ENVELOPE MUST BE RESEED WITH NATIVE MIX 4. DUE TO EXISTING TOPOGRAPHY AND UNDEVELOPED NATURE OF THE DOWN STEAM
- AREA, PERIODIC MAINTENANCE OF PONDS AND SWALES ARE REQUIRED. 5. ALL WALLS SHALL BE PERMITTED SEPARATELY AND MUST CONFORM TO THIS
- 6. PAD ELEVATION CERTIFICATION REQUIRED PRIOR TO PERMIT

LEGEND

---- EXISTING CONTOUR — — 5410— — EXISTING INDEX CONTOUR ———5410————— PROPOSED INDEX CONTOUR ■ 100.00 PROPOSED FLOWLINE ELEVATIONS PROPERTY LINE

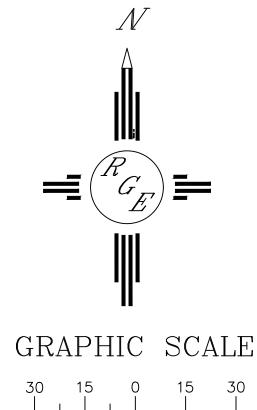

SCALE: 1"=30'

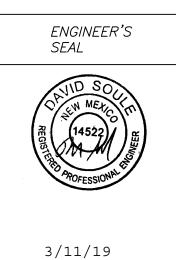

DAVID SOULE P.E. #14522

LOT 7, BLOCK 8, UNIT 11	DRAWN BY _{JDG}
VOLCANO CLIFFS	DATE
GRADING AND DRAINAGE PLAN	03-09-2019
Rio Grande Ingineering 1606 CENTRAL AVENUE SE	SHEET # 1 OF 1

ALBUQUERQUE, NM 87106 (505) 872-0999

JOB #